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Greystone Village – Phase 5

295 - 355 Deschâtelets Avenue

Urban Design Brief

October 2024

Revised: November 2024



Prepared for: eQ Homes Inc.

Greystone Village – Phase 5 Forecourt Blocks 295 - 355 Deschâtelets Avenue Ottawa, Ontario

Urban Design Brief
in support of
Minor Zoning By-law Amendment
and Site Plan Control Applications

Prepared For:

eQ Homes Inc.

Prepared By:

NOVATECH

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October / 17 / 2024 **Revised:** November / 29 / 2024

> Novatech File: 114025-5 Ref: R-2024-099



November 29, 2024

City of Ottawa Planning, Real Estate and Economic Development Department 110 Laurier Avenue West, 4th Floor Ottawa, ON, K1P 1J1

Attention: Jack Smith, Planner II, Development Review, Central

Ann O'Connor, Planner III, Development Review, Central

Reference: Minor Zoning By-law Amendment and Site Plan Control Applications

Greystone Village – 295 and 355 Deschâtelets Avenue

Our File No.: 114025-5

The following Urban Design Brief has been prepared in support of Minor Zoning By-law Amendment and Site Plan Control applications to facilitate the development of the property at 295-355 Deschâtelets Avenue (the "Subject Property").

This Urban Design Brief examines the location and context of the Subject Property, the applicable planning policy and regulatory framework and provides justification in support of the proposed building design. The Urban Design Brief concludes with recommendations for the site-specific Zoning By-law Amendment required to facilitate the proposed development on the Subject Property.

Should you have any questions regarding any aspect of these applications please feel free to contact me at your earliest convenience.

Yours truly,

NOVATECH

Jeffrey Kelly, MCIP RPP

Project Manager | Planning & Development

Table of Contents

1.0	SECT	TON 1	1
1.1	App	olication Submission	1
-	'.1.1 '.1.2	IntroductionProject Description (Design Intent)	1 1
1.2	Res	sponse to City Documents	2
1	.2.1	Scope	2
1.3 1.4		sponses to Comments from Pre-Application Consultationsntext Plan	
2.0	SECT	TION 2	.10
2.1 2.2 2.3 2.4 2.5 2.6	Gra Stre Rel Pla	ws adingeetscape (Public Realm) ationship to Public Realm ns and Elevations (Building Design).	.11 .12 .12 .13
3.0	MINO	PR REZONING	.17
Appe	ndix A	– Site Plan and Building Elevations	
Anne	ndix R	a → Architectural Renders	

1.0 SECTION 1

1.1 Application Submission

1.1.1 Introduction

This Design Brief has been prepared in support of Minor Zoning By-law Amendment and Site Plan Control applications to permit development of semi-detached and townhouse dwellings on the property municipally known as 295-355 Deschâtelets Avenue (the "Subject Property"). The proposed development comprises a total of 30 principal dwelling units on the Subject Property on two separate blocks (Block 28 and Block 29). Block 28 will contain a total of 8 semi-detached and 8 townhouse dwelling units. Block 29 will contain a total of 10 semi-detached and 4 townhouse dwelling units. Motor vehicle parking is provided for the proposed development off Des Oblats Avenue and Deschâtelets Avenue via internal car courts between the proposed buildings. Each building is designed with frontage along the perimeter of the Subject Property providing access to the public realm. Walkways provide direct access to dwelling units from Des Oblats Avenue, Deschâtelets Avenue, the grand allée and forecourt park. The proposed development will require modifications to site grading, drainage and landscaping on the property.

The Subject Property is within the Inner Urban Transect and is designated Neighbourhood on Schedule B2 of the City of Ottawa Official Plan. The Subject Property is located within the Evolving Neighbourhood Overlay. The Subject Property is designated Neighbourhood Low-Rise on Schedule A of the Old Ottawa East Secondary Plan. The Subject Property is located within the Evolving Neighbourhood Overlay. The Subject Property is zoned Residential Third Density, Subzone Q, Urban Exception 2306 (R3Q [2306]) and is located within the Mature Neighbourhoods Overlay in the City of Ottawa's Zoning By-law 2008-250.

1.1.2 Project Description (Design Intent)

The Forecourt development seeks to celebrate and maintain the historical semi-circular nature of Deschâtelets Avenue and the Forecourt Park fronting the Deschâtelets building. The individual housing blocks, landscaping and walkways within the development are arrayed along and take cues from this curve. Each are oriented towards the center of the Deschâtelets building, preserving restoring and enhancing the semi-circular landscape and of the Forecourt Park.

The development activates along the entire perimeter of the property and provides unique experiences along each Deschâtelets Avenue, the Grand Allée, and the Forecourt Park. Along Deschâtelets Avenue, newly planted street trees animate the foreground of the streetscape, while 8 dwelling units fronting on the street define a built street edge and enclose the park beyond. In between these units, the shared car courts act as permeations in the built form, preserving views of the Deschâtelets building along Deschâtelets Avenue. Visual and physical connections to the park and perimeter walkways are enhanced and maintained. Along the Grand allée, dividing the two sites, the design of the six fronting townhome units are intended to speak to the formal landscape of the Forecourt Plaza and are provided front-door access from the perimeter walkways. Great care was taken when configuring the footprint of these blocks to accommodate the critical root zones of the heritage trees near the intersection of the Grand allée with the Forecourt Park. Within the Forecourt Park, the 16 fronting units of the two blocks each face the center of the Deschâtelets building and play homage to the site's Forecourt semi circular historical significance. In addition, stone portal archways supporting second floor balconies of every block define each entrance and are orientated in a semi-circular arrangement to compliment the curvature of the site.

1.2 Response to City Documents

1.2.1 Scope

Figure 1: Official Plan Schedule B2 Excerpt



The Subject Property is designated "Neighbourhood" and "Evolving Neighbourhood Overlay" in the Inner Urban Transect on Schedule B2 of the Official Plan (see Figure 1).

Section 5.2 of the Official Plan sets out general policies and guidance for proposed development within the Inner Urban Transect.

Section 5.2.4, Policy 1 of the Official Plan states that:

- "1) Neighbourhoods located in the Inner Urban area and within a short walking distance of Hubs and Corridors shall accommodate residential growth to meet the Growth Management Framework as outlined in Subsection 3.2, Table 3b. The Zoning By-law shall implement the density thresholds in a manner which adheres to the built form requirements as described in Subsection 5.6.1, as applicable and that:
 - a) Allows and <u>supports a wide variety of housing types with a focus on missing-middle housing</u>, which may include new housing types that are currently not contemplated in this Plan:
 - b) The application of Zoning By-law development standards to be applied as one lot for zoning purposes to support missing middle housing:
 - c) Provides for a low-rise built form, by requiring in Zoning a minimum built height of 2 storeys, generally permitting 3 storeys, and where appropriate, will allow a built height of up to 4 storeys to permit higher-density low-rise residential development;

- d) Provides an emphasis on regulating the maximum built form envelope that frames the public right of way rather than unit count or lot configuration; and
- e) In appropriate locations, to support the production of missing middle housing, lower density typologies may be prohibited."

The Subject Property is designated Neighbourhood on Schedule B2 of the Official Plan. Main Street is designated as a Mainstreet Corridor and is located within 200 metres walking distance of the Subject Property. The proposed semi-detached and townhouse dwellings are an example of missing middle housing that will be developed as a planned unit development oriented to front on and frame Des Oblats Avenue, Deschâtelets Avenue the grand allée and forecourt park. The proposed land use and built form on the Subject Property would be supported by policies of the Official Plan.

Section 5.6.1.1, Policy 1 of the Official Plan states that:

- "1) The Evolving Overlay will apply to areas that are in a location or at stage of evolution that create the opportunity to achieve an urban form in terms of use, density, built form and site design. These areas are proximate to the boundaries of Hubs and Corridors as shown in the B-series of schedules of this Plan. The Evolving Overlay will be applied generally to the properties that have a lot line along a Minor Corridor; lands 150 meters from the boundary of a Hub or Mainstreet designation; and to lands within a 400-metre radius of a rapid transit station. The Overlay is intended to provide opportunities that allow the City to reach the goals of its Growth Management Framework for intensification through the Zoning By-law, by providing:
 - a) Guidance for a gradual change in character based on proximity to Hubs and Corridors,
 - b) Allowance for new building forms and typologies, such as missing middle housing;
 - c) Direction to built form and site design that support an evolution towards more urban built form patterns and applicable transportation mode share goals; and
 - d) Direction to govern the evaluation of development.

The Subject Property is suitable for intensification being located within 200 metres from the Main Street Corridor. The proposed development of semi-detached and townhouse dwellings on the Subject Property is consistent with City objectives to establish a more urban community character and to create opportunities for infill and intensification within walking distance of bus stops providing connections to rapid transit and active transportation routes in the Inner Urban Transect.

1.3 Responses to Comments from Pre-Application Consultations

The following section provides detailed responses to comments regarding Urban Design provided at pre-application consultation meetings that took place on September 19th, 2023 and May 29, 2024.


Urban Design Comments	Response
Views of car courts - prevent looking like back of house. We recommend the design of these spaces work to reflect a similar quality that the outer building faces will have.	The car court facing elevations of all blocks were designed to the same level of care and quality as the outer building faces in terms of aesthetic and material selections. Feature copper panel and bay windows are utilized on car court facing elevations to animate the courts.
Narrow space between A2 & C – this tight and awkward space may limit the quality of material and amount of glazing opportunity possible. We recommend connecting the massing if possible.	This space is invaluable for locating utility metering equipment and mechanical exhausts so that they are out of view from the street. The space additionally lends itself to house required garbage and recycling enclosures so that they are out of sight. The existence of the gap also allows A2 and C blocks to have windows on three sides, rather than two, on the third floors.
Outdoor amenity location? How to design to provide positive public/private relationship. We recommend raising the outdoor patios by two of three risers to further differentiate.	Outdoor amenity location has been provided in the form of second floor balconies at all units, and ground floor terraces at A and C units. The ground floor terraces are between one and three risers above adjacent grade and feature a landscape buffer, separating them from circulation beyond. Additionally, these terraces feature sizable stone piers on public facing sides and create a opaque elements which provide additional privacy.
The previous curved forms illustrated in the master plan have now been lost. We recommend additional design features along the curved park edge to further reinforce the intention of a curved inner built form using low walls, architectural features or other 3-dimensional elements.	While no longer a curved building, the individual structures have been arranged along the curve of Deschâtelets and feature radially arranged perforations through the massing to increase connectivity to the interior park and to frame views of the Deschâtelets building. Street trees along Deschâtelets further support the curvature along the street front. Feature stone piers have been added to support second floor balconies facing Deschâtelets and the forecourt park. The stone piers create a rhythm which reinforces the curvature of the site. Additionally, all landscape paths and planting areas are arrayed around the center of the semicircular forecourt and utilize the curvature of the site to guide their form.

1.4 Context Plan






The Subject Property is located within the Old Ottawa East neighbourhood. Immediately to the north of the Subject Property is a Des Oblats Avenue. To the north across Des Oblats Avenue, the majority of lands are comprised of low-rise residential buildings. Several parks, places of worship, schools and community centres are located further to the north, south and west of the Subject Property (see Figure 2). To the east of the Subject Property is the heritage designated forecourt park and Deschâtelets Building. To the west of the Subject Property are recently constructed mid-rise residential buildings and the grand allée connecting to Main Street. Further to the west along Main Street, a broad range of uses including residential, institutional, places of worship, commercial and retail characterize the corridor. St. Paul University is located to the south of the Subject Property. The University of Ottawa Lees Campus is located to the northeast of the Subject Property along the Rideau River.

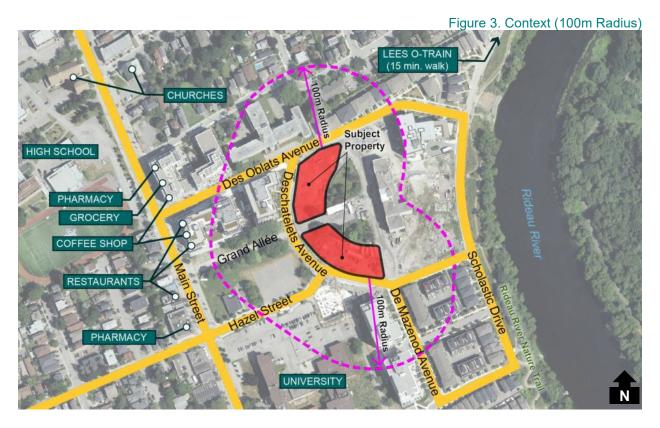

Immediately to the east of the Subject Property is the forecourt park and Deschâtelets Building (see Figure 3). Further to the east is the Rideau River Nature Trail and Rideau River. To the south of the Subject Property is Hazel Street. To the west along Main Street are a mix of retail, restaurant, and commercial uses, schools, recreational uses and places of worship. North and south of the Subject Property is predominantly characterized by a mix of low to mid-rise residential uses.

The Greystone Village neighbourhood is pedestrian and cyclist-oriented and has direct connections throughout the community to a range of local transit options. Bus transportation routes are located along Hazel Street, Des Oblats Avenue and Main Street. The Subject Property is located within a 15 minute walk of the Lees O-Train station providing access to rapid transit within walking distance of the Subject Property.

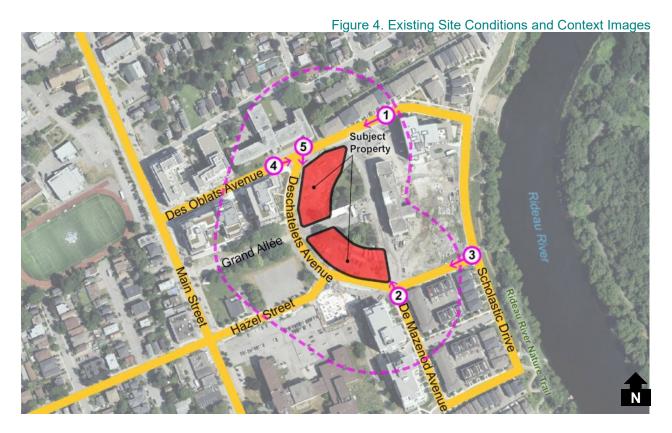

Existing Architectural Context

The architectural context of buildings located to the north of the Subject Property across Des Oblats Avenue are low rise and are generally oriented to the street. A low to mid-rise built form context is present along Deschâtelets Avenue to the east and west of the Subject Property.

The local streets within the surrounding neighbourhood comprise an existing low to mid-rise residential forms with single detached, semi-detached, and townhouses. Several multi unit mid-rise residential building forms have been recently constructed. Buildings located within 100m radius of the Subject Property are consistent with the form and scale of the proposed development.

The proposed development is designed with an appropriate scale and architectural style to fit within the low to mid-rise context with well-designed, contemporary building materials and architectural features.

Please see Figure 4 and the images attached below for reference.



Image 1: Recently Constructed Low to mid-rise development along Des Oblats Avenue (looking west)



Image 2: Recently Constructed Multi-Unit, Mid-rise and Low-rise residential along De Mazenod Avenue



Image 3: Recently constructed Low-rise residential further east along Deschâtelets Avenue



Image 4: Low to Mid-rise residential uses along Des Oblats Avenue (looking east toward Subject Property)



Image 5: Mid-rise development at Des Oblats Avenue and Deschâtelets Avenue intersection (looking south)

2.0 SECTION 2

Section 4.6 of the Official Plan sets out direction for urban design throughout the City. This Design Brief draws from the policies of the relevant sections of the Official Plan.

The following section provides a review of relevant policies regarding the proposed building design and provides design justification in support of the development of a mix of semi-detached and townhouse dwellings on the Subject Property.

2.1 Views

Figure 5. Aerial View from forecourt park Looking West





Figure 6. Townhouse View from Grand Allée Looking North

Figure 7. View from Forecourt Park Looking North



2.2 Grading

Grading is not an issue on the Subject Property. The planned topography has a minor slope of 0.5m along the west property line and a minor slope of 0.5m along the east property line from north to south. There is a slope of 1.4m running along the front property line for a length of approximately 250 metres abutting Des Oblats Avenue, Deschâtelets Avenue and the forecourt park.

2.3 Streetscape (Public Realm)





The proposed development responds to the existing and planned scale envisioned for the surrounding context through an appropriate setback and façade design for each building along the perimeter of each block resulting in a continuous frontage that frames the street, improves pedestrian access and interfaces well with the public realm (see Figure 8). A landscaped private walkway lines the grand allée and forecourt park providing connection to internal car courts and front door access to dwelling units fronting on the parks. A range of three-storey semi-detached and townhouse buildings provide an appropriate scale of development that is compatible with existing low to mid-rise buildings to the north, east, west and south of the Subject Property.

2.4 Relationship to Public Realm

Please refer to Section 2.5 – Plans and Elevations (Building Design) for further descriptions regarding the relationship between the proposed building and the public realm along Des Oblats Avenue, Deschâtelets Avenue and the forecourt park.

2.5 Plans and Elevations (Building Design)





The Official Plan includes policies to improve the quality and safety of the public realm and proposed development on sites throughout the City. Policies 3 and 4 of Section 4.6.5 state that:

"3) Development shall minimize conflict between vehicles and pedestrians and improve the attractiveness of the public realm by internalizing all servicing, loading areas, mechanical equipment and utilities into the design of the building, and by accommodating space on the site for trees, where possible. Shared service areas, and accesses should be used to limit interruptions along sidewalks. Where underground parking is not viable, surface parking must be visually screened from the public realm."

and;

"4) Development shall demonstrate universal accessibility, in accordance with the City's Accessibility Design Standards. Designing universally accessible places ensures that the built environment addresses the needs of diverse users and provides a healthy, equitable and inclusive environment."

All semi detached and townhouse dwellings on the site are single family homes complete with porches, landings and steps (see Figure 9). Landscaped private walkways provide access to principal entrances for private dwellings facing the grand allée or forecourt park. Each walkway is 1.2m wide to emphasize its private use. Direct, barrier-free pedestrian connections around the Subject Property are provided by the public sidewalk along Des Oblats Avenue and Deschâtelets Avenue and through a planned extension of the grand allée into the forecourt park. Individual garages for each dwelling unit are provided via shared internal car courts accessed off Des Oblats Avenue and Deschâtelets Avenue. Bicycle parking is provided in garages accordingly. Access is provided from Des Oblats Avenue and Deschâtelets Avenue to entrances and landscaped private

walkways. Providing consolidated vehicle access points to the property that are separated from principal entrances reduces potential conflicts and improves the safety, accessibility, and movement of pedestrians to and from the Subject Property.

The Official Plan recognizes the importance that building design can have on ensuring intensification remains compatible with the existing context.

Built Form Context & Building Materials

Policy 7 of Section 4.6.6 states that:

"6) Low-rise buildings shall be designed to respond to context, and transect area policies, and shall include areas for soft landscaping, main entrances at-grade, front porches or balconies, where appropriate. Buildings shall integrate architecturally to complement the surrounding context."

Greystone village has experienced a transition to higher density, low to mid-rise built forms surrounding the Subject Property. The level of density proposed on the Subject Property is intended to complement the heritage designated forecourt of the Deschâtelets building with a low-rise built form. The proposed development of a variety of semi-detached and townhouse dwellings is designed to complement the existing character of the neighbourhood and buildings surrounding the Subject Property and to provide an appropriate scale in transition to recently constructed higher density, mid-rise development to the west across Deschâtelets Avenue.

The proposed development is designed to complement existing buildings abutting the Subject Property with each pair of semi-detached dwellings arranged to front on the street or Forecourt Park respectively. Each row of townhouse dwellings is arranged to front directly on the grand allée or Forecourt Park. The townhouse and semi-detached dwelling modules are designed to reference the width and scale of existing buildings in the surrounding community. The townhouse modules are also designed to accommodate the existing heritage trees at the end of the Grand Allee. Gaps between the residential blocks allow for discrete shared "car court" access between buildings to private garages. These gaps also provide lines of site through the development for a more connected and open feel. A variation in materials and horizontal divisions are provided by a brick base and transitioning to metal/copper panel and wood siding at the top of each building. The proposed development is designed to be compatible with low to mid-rise developments located along Des Oblats Avenue, Deschâtelets Avenue and De Mazenod Avenue.

The proposed building materials for each building facing Des Oblats Avenue and Deschâtelets Avenue primarily comprise a classic grey brick, large format grey stone masonry, charcoal wood siding and dark grey coloured metal panelling that are appropriate for the existing neighbourhood context. Copper paneling is used as an accent material across the development. A contemporary rhythm of black windows with horizontal mullions, front-facing glass and metal railing balconies, textured brick/stone masonry and concrete details at grade level are complemented by use of metal/copper panel cladding and wood siding set within recessed portions of the façade, surrounding windows and at the upper level are compatible with the design of existing low-rise buildings in the area.



Figure 10. Forecourt Park View Front Elevation

The proposed development is designed with the principal building façades and walkways to main entrances oriented to Des Oblats Avenue, Deschâtelets Avenue, the grand allée and forecourt park (see Figure 10). Soft landscaping bordering the interlock walkway to main entrances, front facing porches, and internal car courts are designed to be aesthetically pleasing and provide natural features to the development. The principal building façades comprise a high-quality material treatment where the building interfaces with abutting properties and toward the public realm (see Figure 10). The proposed buildings each provide a well-articulated combination of classic, contemporary materials such as glass, brick, stone masonry, wood siding and metal/copper panel along the principal façade to fit with existing built form surrounding the Subject Property. Strategically placed recesses and covered balcony projections clad in large format stone masonry are used to accent building entrances and grade level amenity spaces, create visual breaks in the façade along each frontage and achieve a design aesthetic that is compatible with existing characteristics of the surrounding community.

The proposed development establishes a transit-supportive level of density within walking distance of Lees O-Train station and transit stops along the local transit network on Main Street. The proposed development will fit within the existing and planned residential context surrounding the Subject Property. The proposed development of semi-detached and townhouse dwellings on the Subject Property is appropriate for the existing site and surrounding context and will not cause undue adverse impacts on abutting properties.

2.6 Sustainability

The Official Plan strives to include innovative and sustainable design practices on sites throughout the City. Policy 1 of Section 4.6.4 states:

"1) Innovative, sustainable and resilient design practices and technologies in site

planning and building design will be supported by the High-performance Development Standard, which will apply to site plans, draft plans of subdivision and local plans in accordance with Subsection 11.1, Policy 3). The Standard addresses matters of exterior sustainable design and will align urban design with climate change mitigation and adaptation goals and objectives."



Figure 11. View From Forecourt Park Looking West


The proposed buildings are designed to fit within the context of existing buildings surrounding the subject property and harmonize with the architecture of the Deschâtelets building (see Figure 11).

The dwelling units within each residential block have either a park or street orientation and follow the unique radial pattern of the site. Each townhouse has features which include large operable windows to allow natural light and fresh air for residents. At each front yard, covered terraces and second floor balconies introduce shading while providing outdoor amenity areas. New and existing trees will also provide shading, while water efficient landscaping, native and adaptive vegetation will contribute to the site's sustainability objectives.

Energy efficient mechanical systems and lighting along with Energy Star appliances are incorporated into each building design. High levels of insulation, water efficient plumbing fixtures, energy efficient windows & resilient building materials are also included. Waste management and the use of recycled materials will also be explored. This use of environmentally responsible measures and sustainable building practices will meet energy targets and high performance design standards.

Across the Greystone development, sustainability is promoted by encouraging more active and sustainable modes of transportation. While individual parking garages for motor vehicles are being provided, residents of this development will be able to conveniently walk, cycle, or take transit to nearby amenities.

3.0 MINOR REZONING

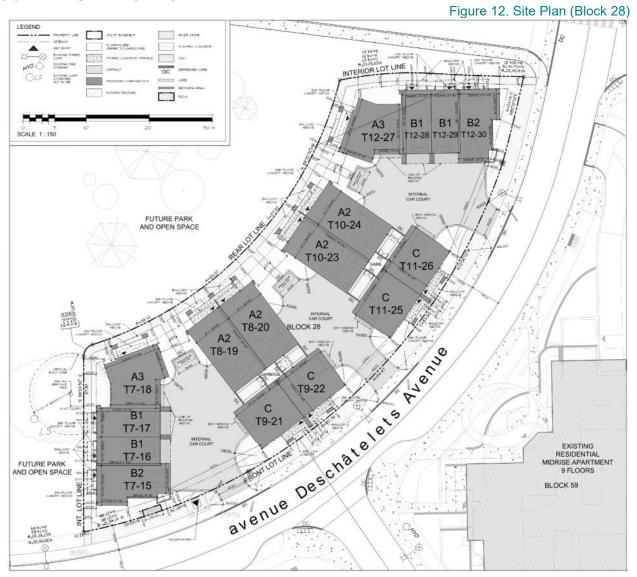

Block 28

It is proposed to develop a total of 8 semi-detached dwellings and 8 townhouse dwellings on Block 28. Site-specific amendments for the Subject Property are required to incorporate the required relief from zoning provisions for a Planned Unit Development to decrease the minimum required front yard setback, to decrease the minimum required rear yard setback, to increase the maximum extent of a stair projection into the front yard, to increase the maximum extent of a balcony projection to the front lot line, to increase the maximum extent of a balcony projection to the interior side lot line, to increase the maximum extent of a balcony projection into the rear yard, to decrease the minimum required width of a private way, to decrease the minimum required setback for any wall from a private way, to decrease the minimum required setback for any garage or carport entrance from a private way, and to reduce the minimum soft landscape area requirements for the proposed development. It is suggested to include the provisions of Section 144 under the list of provisions which do not apply to the Subject Property.



Block 29

It is proposed to develop a total of 10 semi-detached dwellings and 4 townhouse dwellings on Block 28. Site-specific amendments for the Subject Property are required to incorporate the required relief from zoning provisions for a Planned Unit Development to decrease the minimum required front yard setback, to decrease the minimum required corner side yard setback, to decrease the minimum required rear yard setback, to increase the maximum extent of a stair projection into the corner side yard, to increase the maximum extent of a balcony projection into the corner side yard, to increase the maximum extent of a balcony projection into the interior side yard, to increase the maximum extent of a balcony projection to the corner side lot line, to increase the maximum extent of a balcony projection to the rear lot line, to decrease the minimum required width of a private way, to decrease the minimum required setback for any wall from a private way, to decrease the minimum required setback for any garage or carport entrance from a private way, and to reduce the minimum soft landscape area requirements for the proposed development. It is

suggested to include the provisions of Section 144 under the list of provisions which do not apply to the Subject Property.

The site-specific amendment will result in development of 18 semi-detached dwellings and 12 townhouse dwellings that are located with direct access and opportunities for residents to increase use of transit and active transportation infrastructure in the Greystone Village community. The proposed development is within proximity to restaurants, shops, parks and outdoor amenity areas for residents. The requested relief from provisions of the R3Q zone is appropriate to facilitate the proposed development of 30 low-rise residential dwellings on the Subject Property.

Yours Truly,

NOVATECH

Prepared by:

Jeffrey Kelly, MCIP, RPP

Project Manager | Planning & Development

Hobin Architecture Incorporated

Prepared by:


Jamison Duff, OAA, M.Arch


Architect

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Appendix A:

Site Plan and Building Elevations



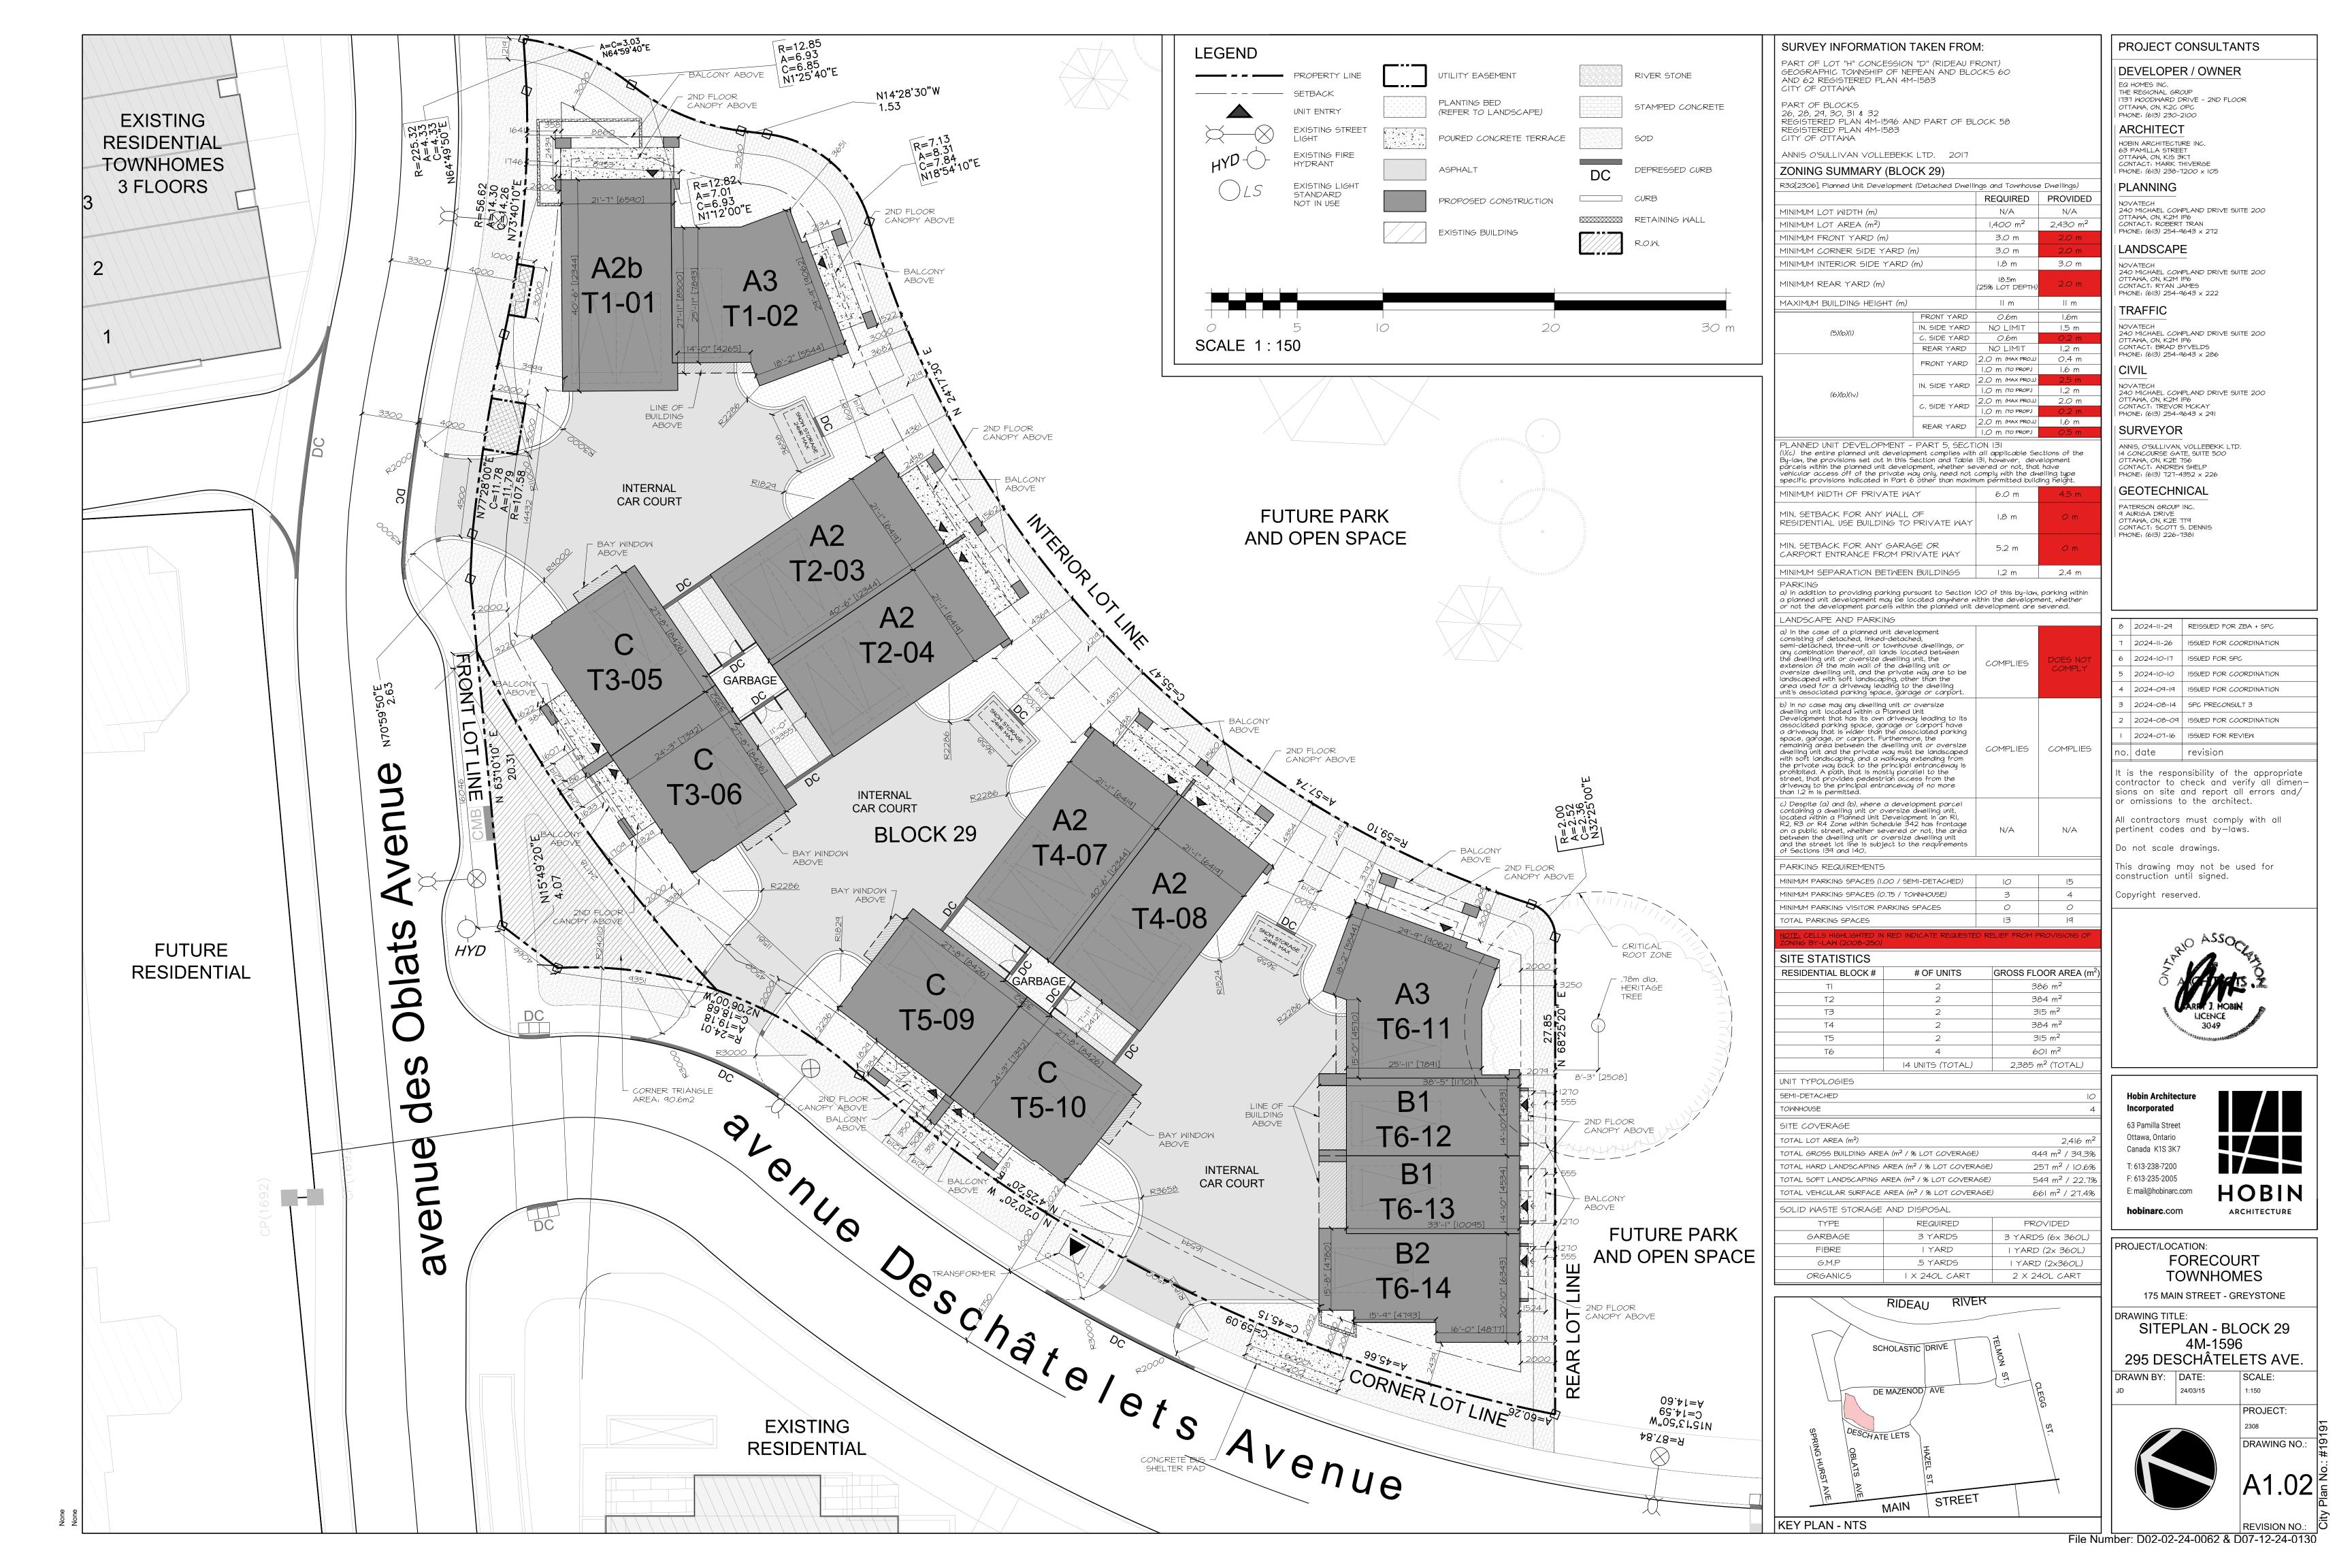

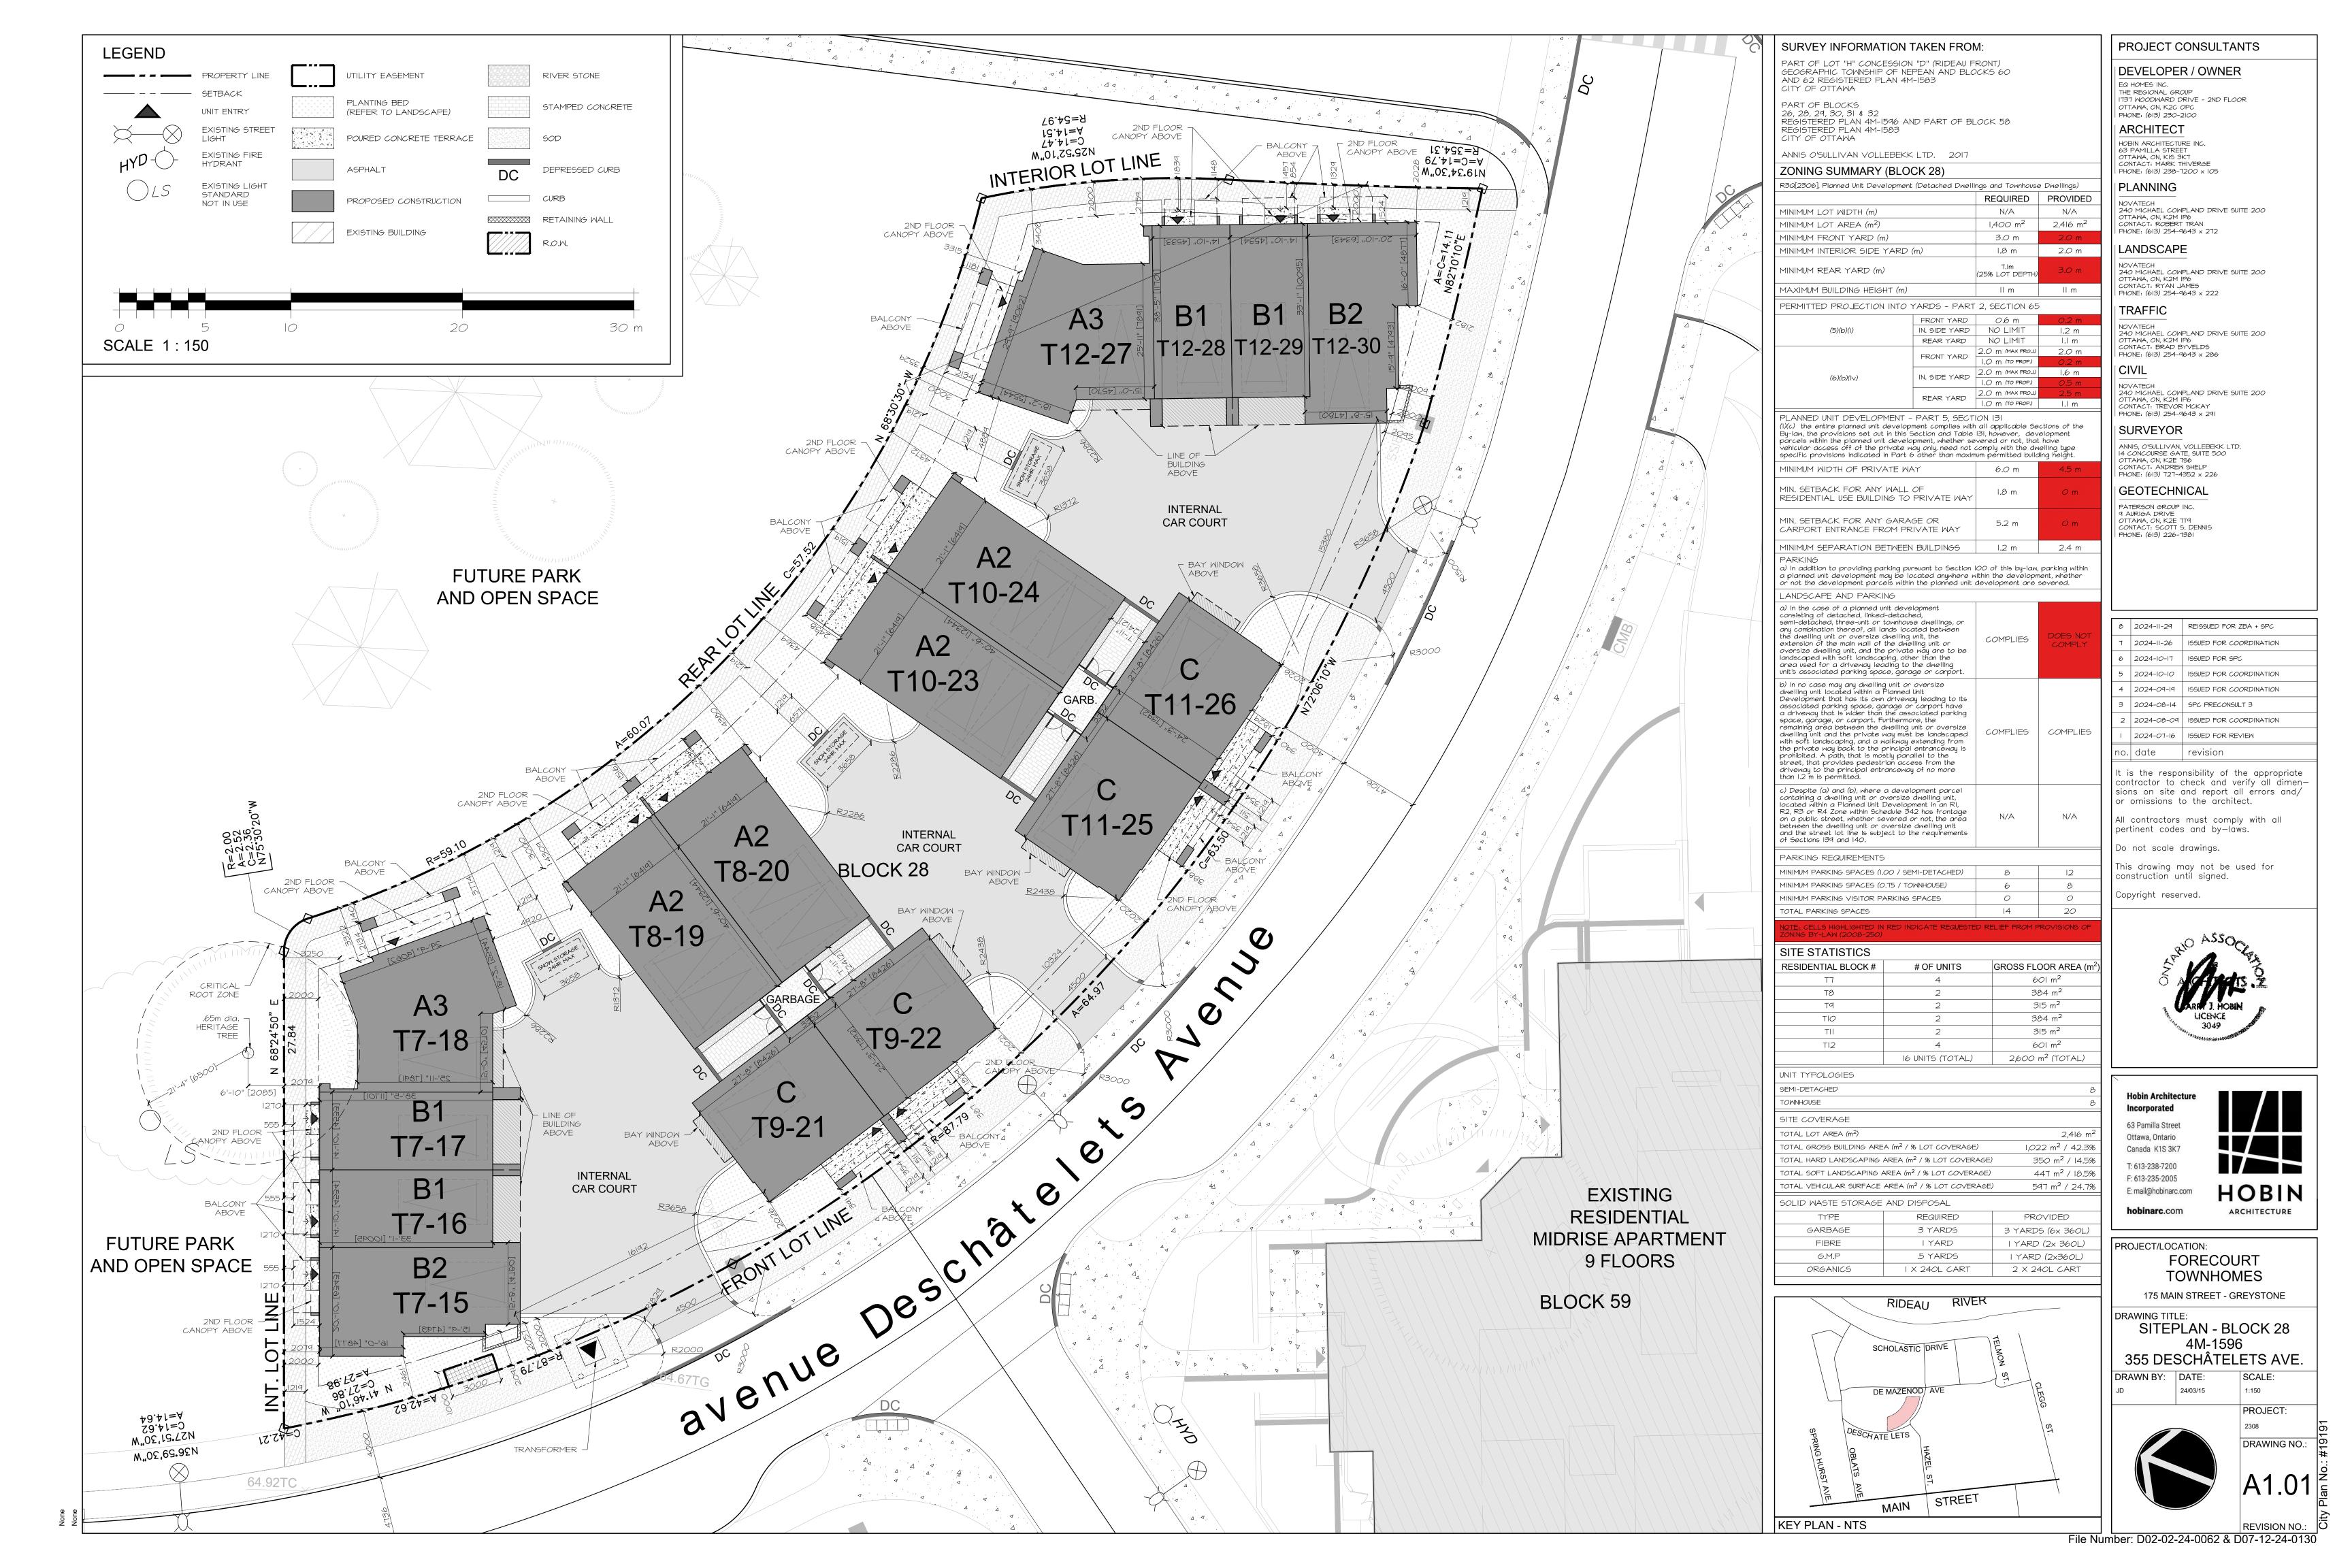



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2	2024-11-29	REISSUED FOR ZBA + SPC
I	2024-10-17	ISSUED FOR SPC
no.	date	revision

contractor to check and verify all dimensions on site and report all errors and/ or omissions to the architect.

It is the responsibility of the appropriate

All contractors must comply with all pertinent codes and by—laws.

Do not scale drawings.

This drawing may not be used for construction until signed.

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HOBIN ARCHITECTURE


PROJECT/LOCATION: **FORECOURT** TOWNHOMES 175 MAIN STREET - GREYSTONE

ELEVATIONS - BLOCK T2 BLOCK 29

295 DESCHÂTELETS AVE. DRAWN BY: DATE: SCALE:


24/09/23 PROJECT:

DRAWING NO.:

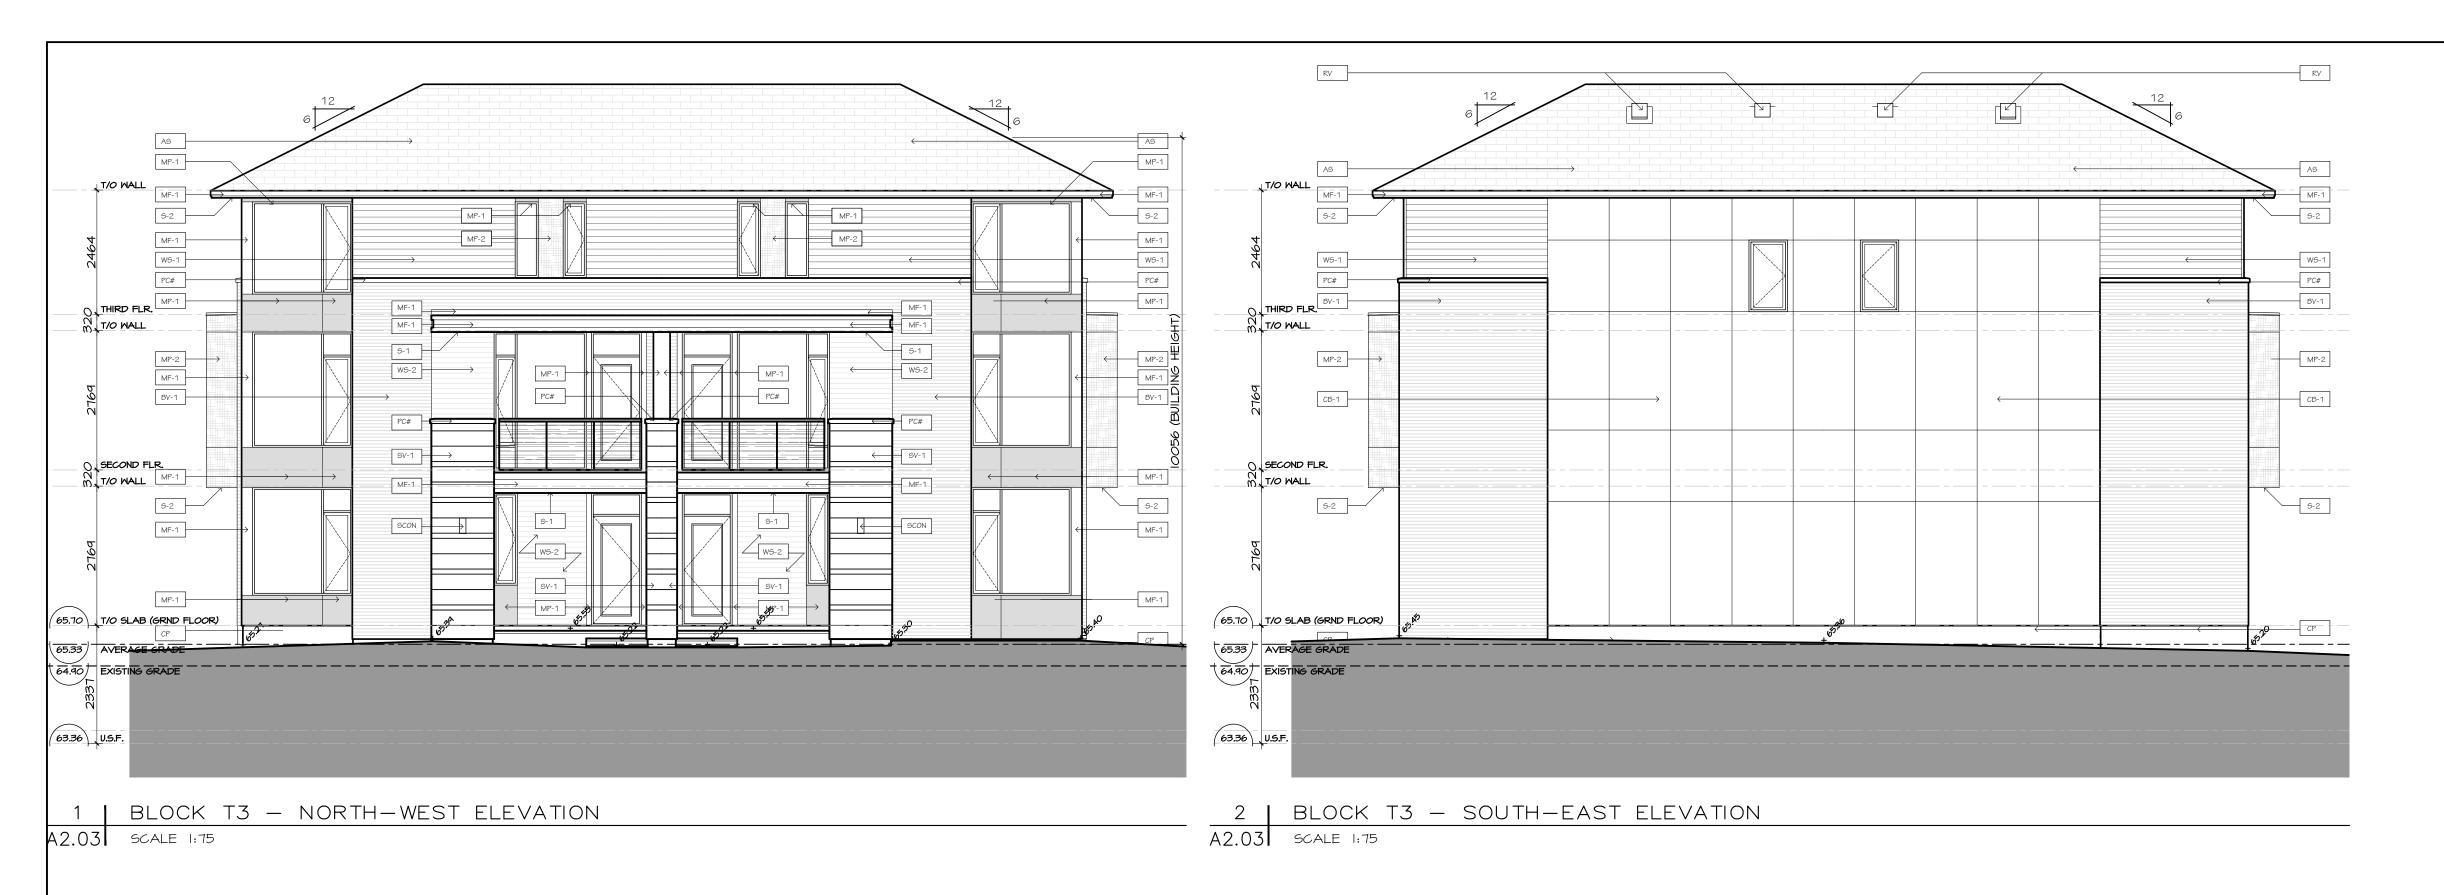



4 BLOCK T3 - NORTH-EAST ELEVATION
A2.03 SCALE 1:75 3 | BLOCK T3 - SOUTH-WEST ELEVATION A2.03 SCALE 1:75

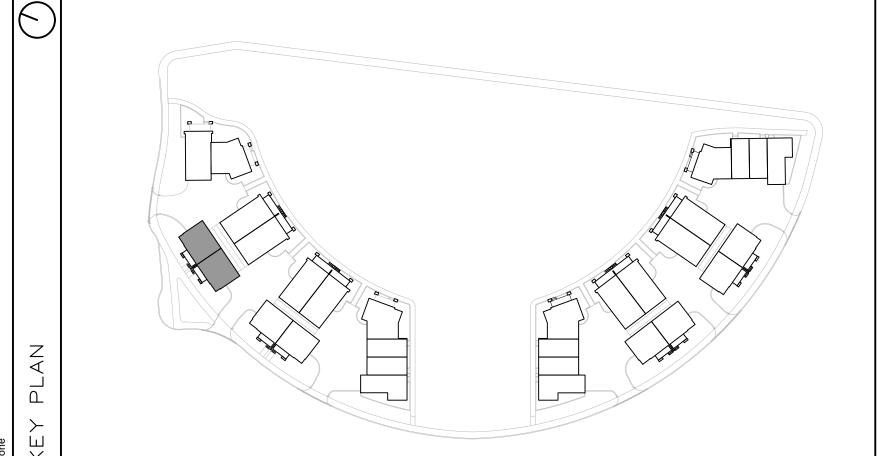



FINISH MATERIAL LEGEND: BRICK VENEER; COLOR TBD STONE VENEER; ARRISCRAFT RENAISSANCE; COLOR: TBD MF-I PRE-FIN. METAL FLASHING; COLOR: GRAPHITE
MP-I ZINC OR EQUIVALENT METAL PANEL; COLOR: CHARCOAL
MP-2 COPPER OR EQUIVALENT METAL PANEL; COLOR: COPPER

T&G CEDAR SOFFIT C/W PRE-FIN. METAL VENT STRIPS
HARDIE SOFFIT PANEL C/W VENT STRIP BY GENTEC; COLOR: GRAPHITE (TBD)

PRE-FIN. HORIZ. WOOD (5"); SIDING BY CAPE COD; COLOR: CHARCOAL (TBD)
PRE-FIN. HORIZ. WOOD (5"); SIDING BY CAPE COD; COLOR: 'LIGHT' (TBD)
PRE-FIN. VERT. WOOD (5"); SIDING BY CAPE COD; COLOR: 'LIGHT' (TBD)
CEMENT BOARD PANELS

PC# PRECAST CONCRETE (PROFILE #)

CEMENT PARGING
PRE-FIN. PRE-ENG. ALUM. & GLASS GUARDRAIL

ROOF VENT

ASPHALT SHINGLES

PROJECT CONSULTANTS

DEVELOPER / OWNER

EQ HOMES INC.
THE REGIONAL GROUP
1737 WOODWARD DRIVE - 2ND FLOOR OTTAWA, ON, K2C OPC

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PHONE: (613) 238-7200 x 105 PLANNING

NOVATECH NOVATECH
240 MICHAEL COMPLAND DRIVE SUITE 200
OTTAWA, ON, K2M IP6
CONTACT: ROBERT TRAN
PHONE: (613) 254-9643 x 272

LANDSCAPE

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TRAFFIC

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CIVIL

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GEOTECHNICAL

PATERSON GROUP INC. 9 AURIGA DRIVE OTTAWA, ON, K2E TT9 CONTACT: SCOTT S. DENNIS PHONE: (613) 226-7361

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no.	date	revision

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HOBIN ARCHITECTURE hobinarc.com

PROJECT/LOCATION: **FORECOURT** TOWNHOMES 175 MAIN STREET - GREYSTONE

ELEVATIONS - BLOCK T3 BLOCK 29

295 DESCHÂTELETS AVE. DRAWN BY: DATE: SCALE: 24/09/23

PROJECT:

DRAWING NO.:



PROJECT CONSULTANTS

DEVELOPER / OWNER

THE REGIONAL GROUP 1737 WOODWARD DRIVE - 2ND FLOOR OTTAWA, ON, K2C OPC PHONE: (613) 230-2100

ARCHITECT HOBIN ARCHITECTURE INC. 63 PAMILLA STREET OTTAWA, ON, KIS 3K7 CONTACT: MARK THIVERGE

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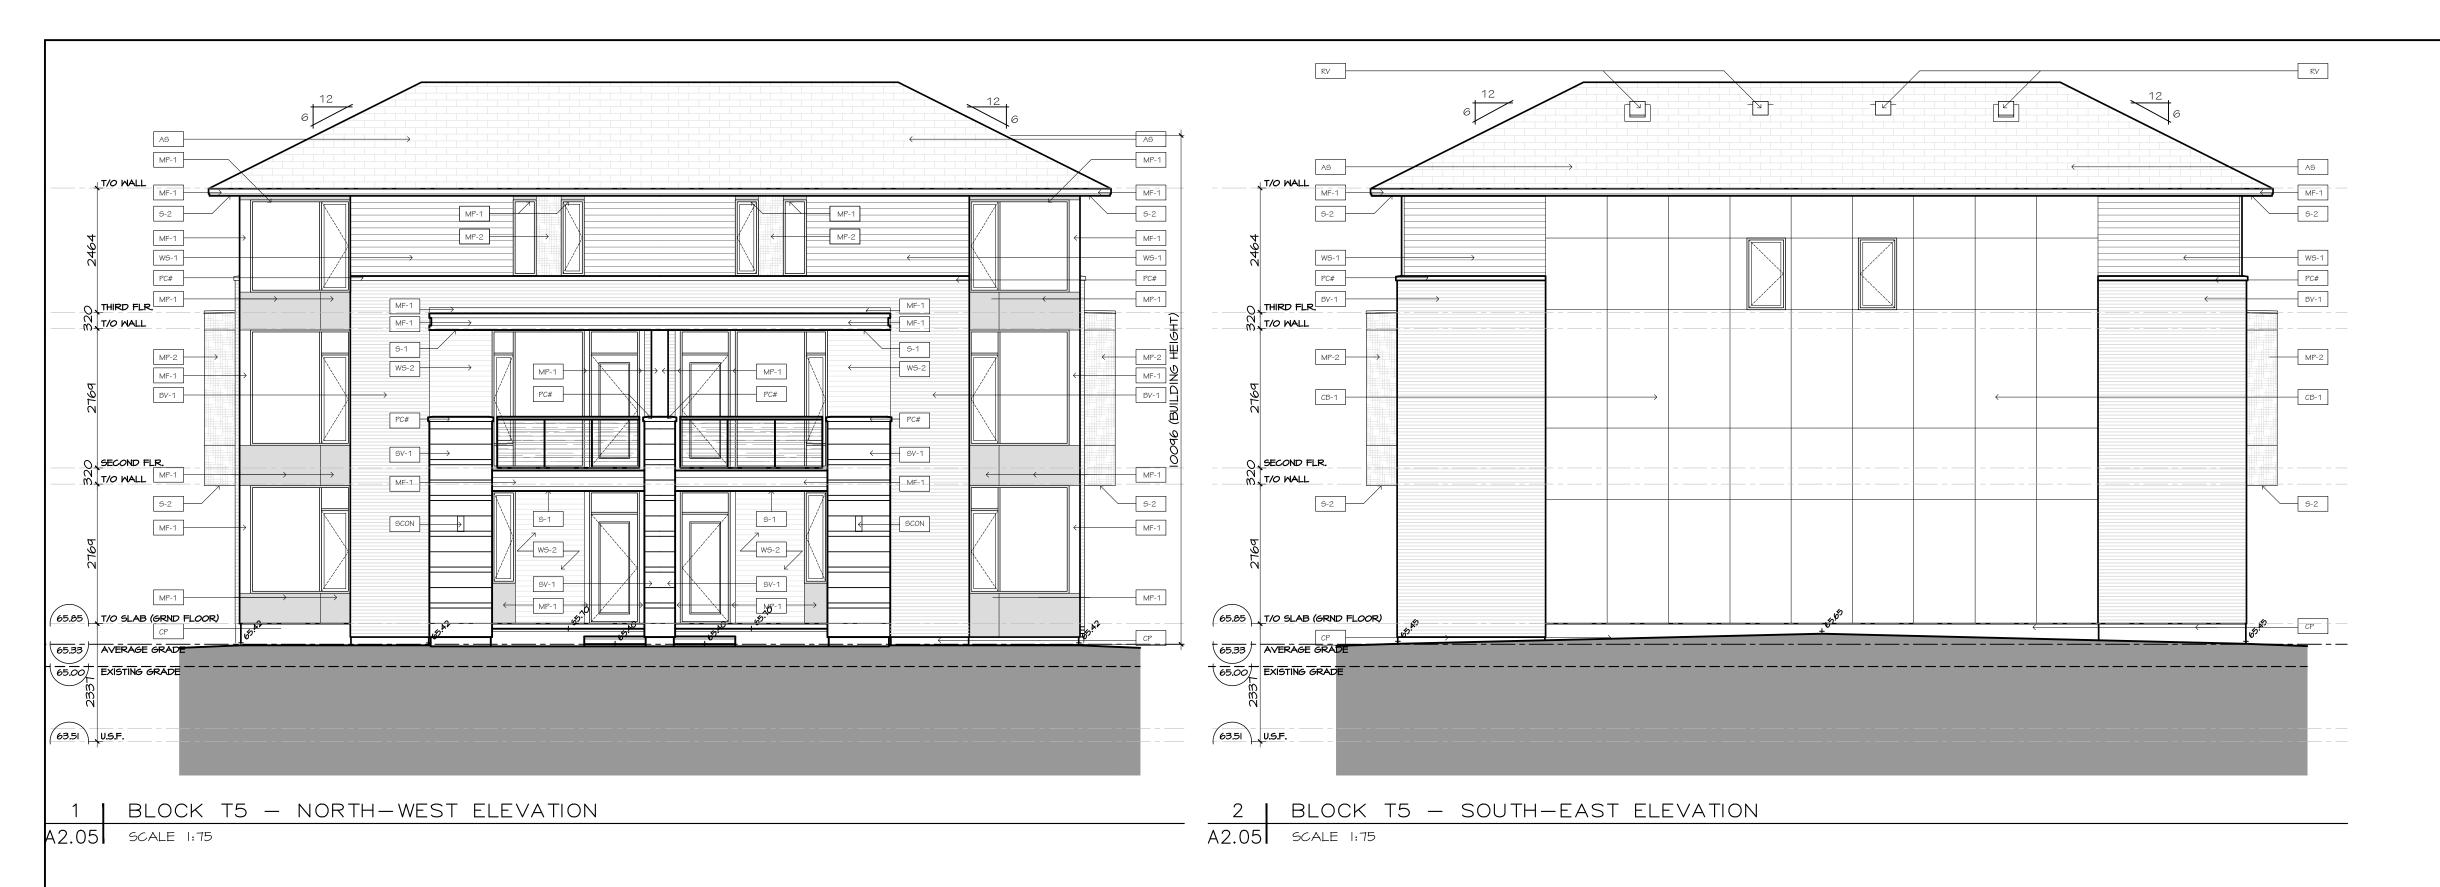
FORECOURT TOWNHOMES

ELEVATIONS - BLOCK T4

BLOCK 29 295 DESCHÂTELETS AVE. DRAWN BY: DATE: SCALE:


24/09/23 PROJECT:

DRAWING NO.:





4 BLOCK T5 - NORTH-EAST ELEVATION A2.05 SCALE 1:75 3 | BLOCK T5 — SOUTH—WEST ELEVATION A2.05 SCALE 1:75

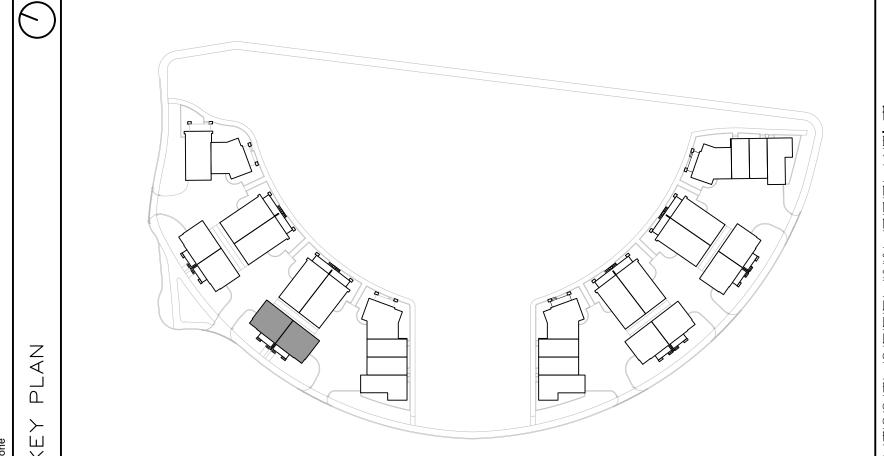



FINISH MATERIAL LEGEND:				
BV-I	BRICK VENEER; COLOR TBD			
SV-I	STONE VENEER; ARRISCRAFT RENAISSANCE; COLOR: TBD			
MF-I	PRE-FIN. METAL FLASHING; COLOR: GRAPHITE			
MP-I	ZINC OR EQUIVALENT METAL PANEL; COLOR: CHARCOAL			
MP-2	COPPER OR EQUIVALENT METAL PANEL; COLOR: COPPER			
<u>5-1</u>	T&G CEDAR SOFFIT C/W PRE-FIN. METAL VENT STRIPS			
<u>S-2</u>	HARDIE SOFFIT PANEL C/W VENT STRIP BY GENTEC; COLOR: GRAPHITE (TBD)			
l				
MS-1	PRE-FIN. HORIZ. WOOD (5"); SIDING BY CAPE COD; COLOR: CHARCOAL (TBD)			
WS-2	PRE-FIN. HORIZ. WOOD (5"); SIDING BY CAPE COD; COLOR: 'LIGHT' (TBD)			

MS-3 PRE-FIN. VERT. MOOD (5"); SIDING BY CAPE COD; COLOR: 'LIGHT' (TBD) CB-I CEMENT BOARD PANELS PC# PRECAST CONCRETE (PROFILE #)

CEMENT PARGING
PRE-FIN. PRE-ENG. ALUM. & GLASS GUARDRAIL

ROOF VENT

ASPHALT SHINGLES

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| DEVELOPER / OWNER

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PLANNING

NOVATECH NOVALECH
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CONTACT: ROBERT TRAN
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LANDSCAPE NOVATECH NOVATECH
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PHONE: (613) 226-7381

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HOBIN

ARCHITECTURE

PROJECT/LOCATION: **FORECOURT** TOWNHOMES 175 MAIN STREET - GREYSTONE

ELEVATIONS - BLOCK T5 BLOCK 29

295 DESCHÂTELETS AVE. DRAWN BY: DATE: SCALE:

PROJECT:

DRAWING NO.:

A2.05



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HOBIN ARCHITECTURE

FORECOURT TOWNHOMES

DRAWING TITLE: ELEVATIONS - BLOCK T6 BLOCK 29

295 DESCHÂTELETS AVE. DRAWN BY: DATE: SCALE:

24/09/23

PROJECT: DRAWING NO.:





REVISION NO.:

HOBIN

ARCHITECTURE


SCALE:

PROJECT:

DRAWING NO.:

File Number: D07-12-24-0130


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3 | BLOCK T9 — SOUTH—EAST ELEVATION A2.09 SCALE 1:75

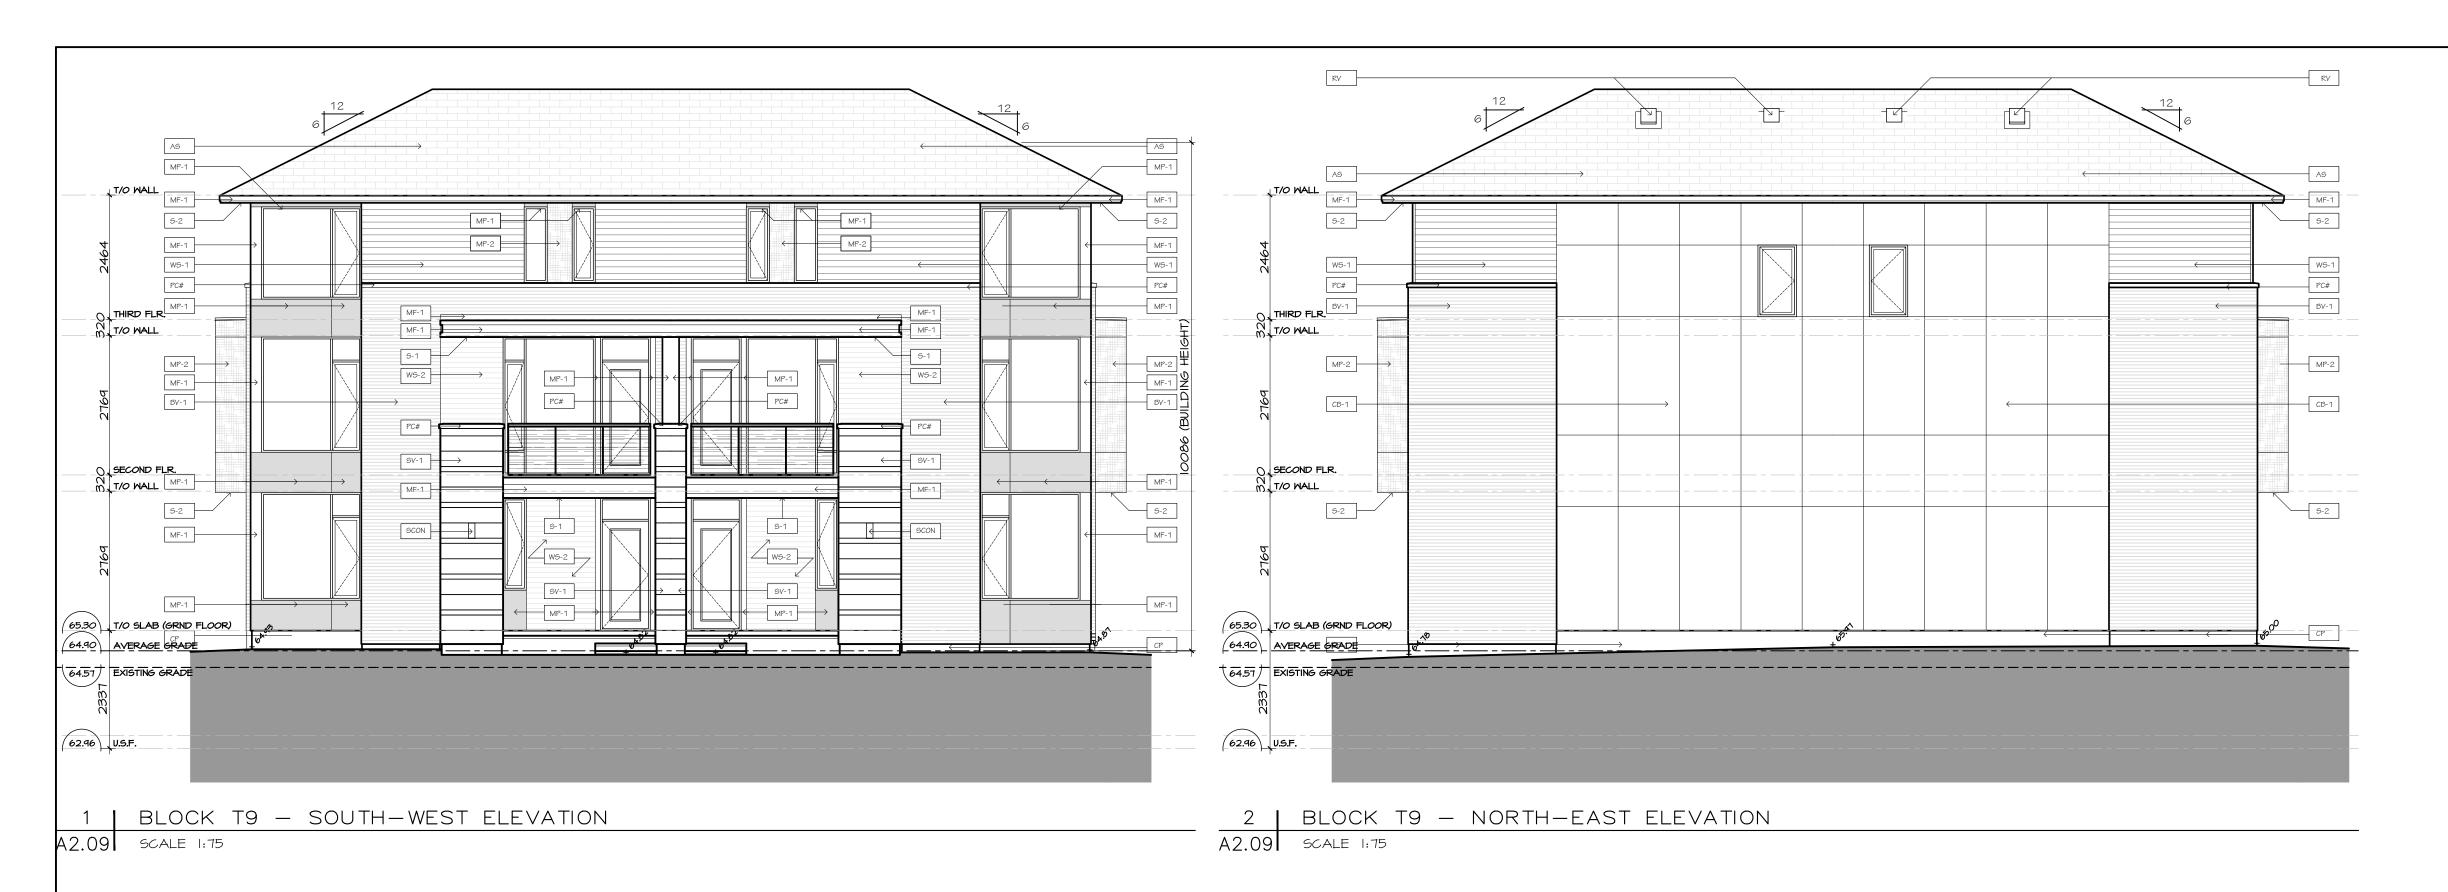4 BLOCK T9 - NORTH-WEST ELEVATION A2.09 SCALE 1:75





FINISH MATERIAL LEGEND:

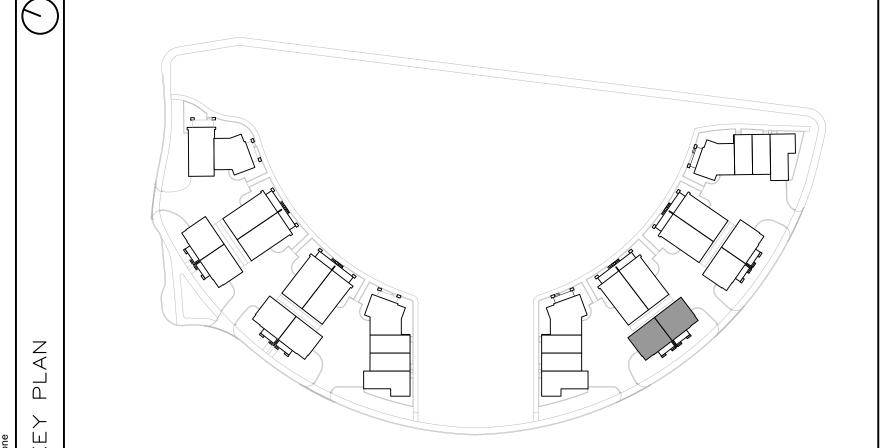	NISH MATERIAL LEGEND:		
<u>BV-I</u>	BRICK VENEER; COLOR TBD		
<u> </u>	STONE VENEER; ARRISCRAFT RENAISSANCE; COLOR: TBD		
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<u>MP-I</u>	ZINC OR EQUIVALENT METAL PANEL; COLOR: CHARCOAL		
MP-2	COPPER OR EQUIVALENT METAL PANEL; COLOR: COPPER		
<u>S-I</u>	T&G CEDAR SOFFIT C/W PRE-FIN. METAL VENT STRIPS		
S-2	HARDIE SOFFIT PANEL C/W VENT STRIP BY GENTEC; COLOR: GRAPHITE (TBD)		
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PC#	PRECAST CONCRETE (PROFILE #)		
 CP	CEMENT PARGING		
G R	PRE-FIN. PRE-ENG. ALUM. & GLASS GUARDRAIL		
RV	ROOF VENT		
AS AS	ASPHALT SHINGLES		
SCON	SCONCE LIGHTING		

PROJECT CONSULTANTS

| DEVELOPER / OWNER

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PHONE: (613) 254-9643 x 272

LANDSCAPE NOVATECH
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TRAFFIC

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HOBIN ARCHITECTURE

PROJECT/LOCATION: **FORECOURT TOWNHOMES**

175 MAIN STREET - GREYSTONE

ELEVATIONS - BLOCK T9 BLOCK 28 295 DESCHÂTELETS AVE. DRAWN BY: DATE: SCALE:

PROJECT: DRAWING NO.:

A2.09



PROJECT CONSULTANTS

DEVELOPER / OWNER

THE REGIONAL GROUP 1737 WOODWARD DRIVE - 2ND FLOOR OTTAWA, ON, K2C OPC

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LANDSCAPE

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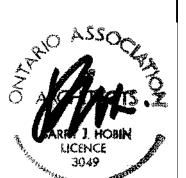
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HOBIN ARCHITECTURE

PROJECT/LOCATION: **FORECOURT TOWNHOMES**

175 MAIN STREET - GREYSTONE

ELEVATIONS - BLOCK T10 BLOCK 28 295 DESCHÂTELETS AVE.

DRAWN BY: DATE: SCALE: 24/09/23


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REVISION NO.:

File Number: D07-12-24-0130






RV

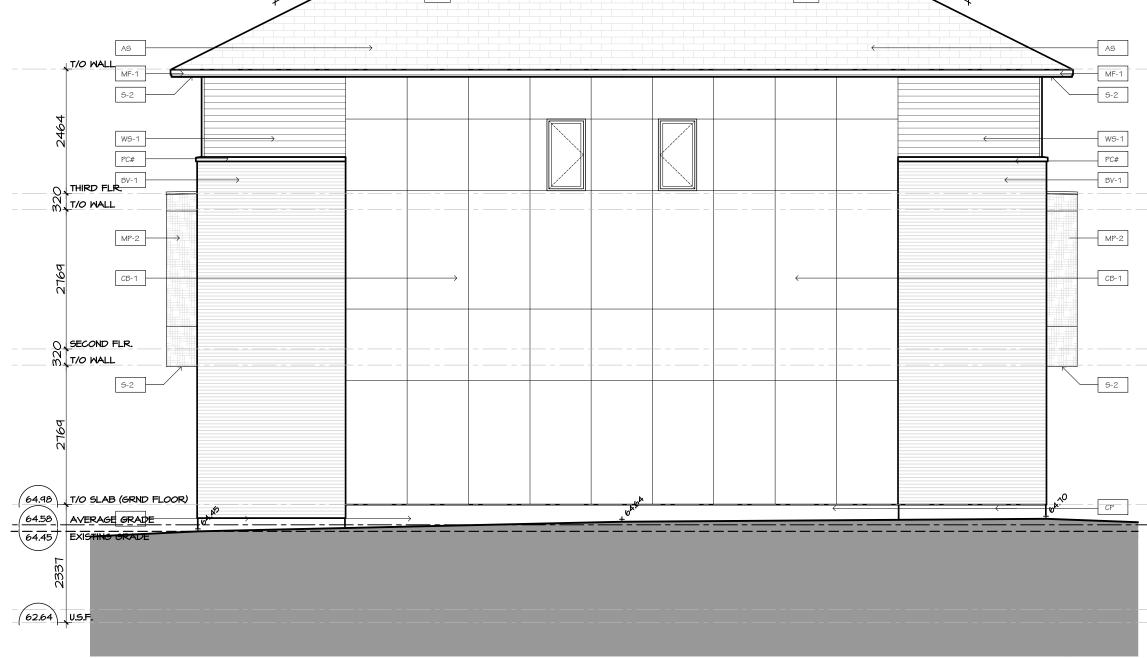
2 | BLOCK T11 — NORTH ELEVATION

A2.11 SCALE 1:75

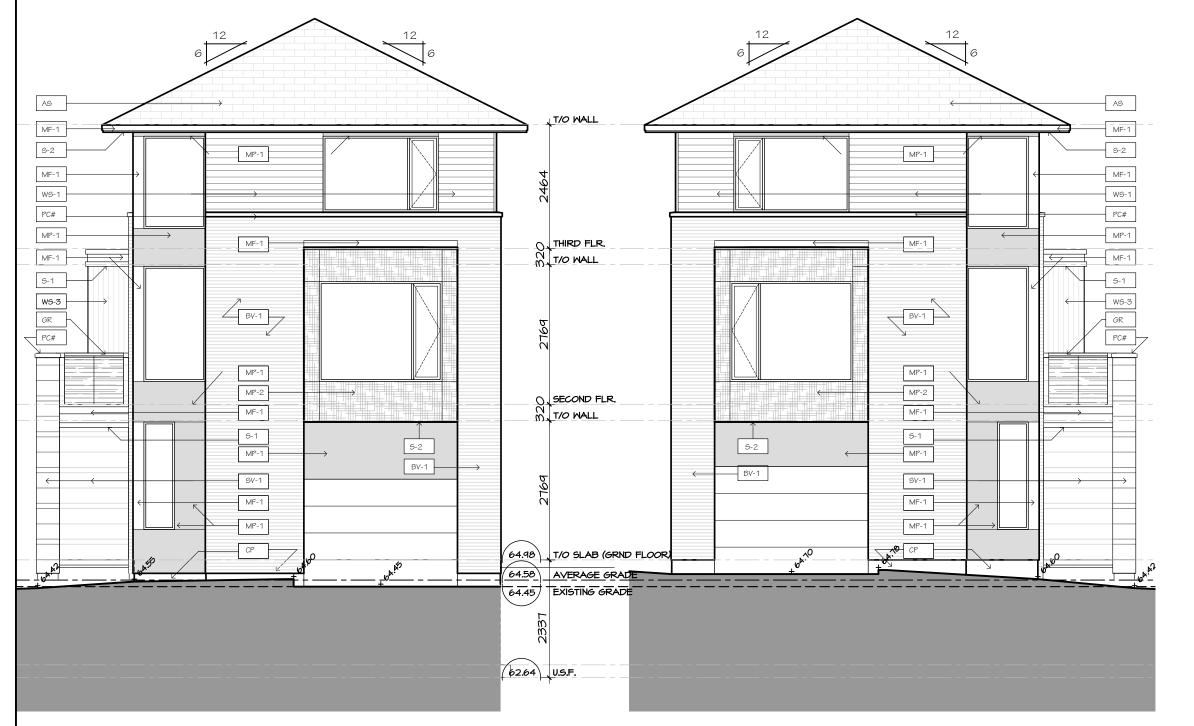

3 | BLOCK T11 — EAST ELEVATION A2.11 SCALE 1:75

4 BLOCK T11 - WEST ELEVATION
A2.11 SCALE 1:75

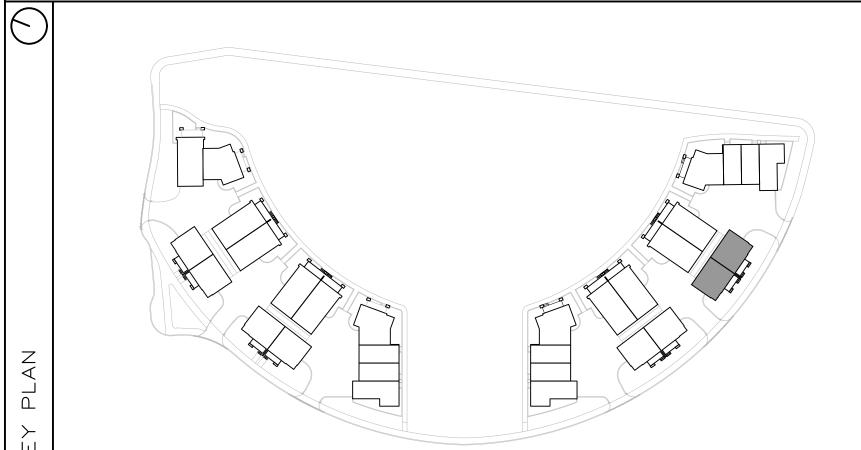



FINIS	SH MATERIAL LEGEND:		
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MP-2			
<u>S-I</u>	T&G CEDAR SOFFIT C/W PRE-FIN. METAL VENT STRIPS		
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<u>CB-I</u>	CEMENT BOARD PANELS		
PC#	PRECAST CONCRETE (PROFILE #)		
CP	CEMENT PARGING		
GR	PRE-FIN. PRE-ENG. ALUM. & GLASS GUARDRAIL		
RV	ROOF VENT		
AS	ASPHALT SHINGLES		
SCON	SCONCE LIGHTING		

| DEVELOPER / OWNER

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PROJECT CONSULTANTS

ARCHITECT

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LANDSCAPE

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HOBIN ARCHITECTURE

PROJECT/LOCATION: **FORECOURT** TOWNHOMES 175 MAIN STREET - GREYSTONE

ELEVATIONS - BLOCK T11 BLOCK 28 295 DESCHÂTELETS AVE.

DRAWN BY: DATE: SCALE:

> PROJECT: DRAWING NO.:

REVISION NO.:



DEVELOPER / OWNER

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HOBIN ARCHITECTURE INC. 63 PAMILLA STREET OTTAWA, ON, KIS 3K7 CONTACT: MARK THIVERGE

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LANDSCAPE

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HOBIN ARCHITECTURE

FORECOURT TOWNHOMES

ELEVATIONS - BLOCK T12 BLOCK 28 295 DESCHÂTELETS AVE.

DRAWN BY: DATE: SCALE:

PROJECT:

DRAWING NO.:

REVISION NO.: File Number: D07-12-24-0130 Appendix B:

Architectural Renders





VIEW TOWARDS BLOCK 29 LOOKING NORTH NOVEMBER 29th, 2024 City Plan No. FROM FORECOURT





AERIAL VIEW OF BLOCK 28 FACING WEST # NOVEMBER 29th, 2024 FROM ABOVE FORECOURT





LOOKING #: 007 12 24 0120 FRONT VIEW OF A2 BLOCK LOOKING **NORTH FROM FORECOURT**





FRONT VIEW OF A2 AND A3 UNITS LOOKING WEST # FROM FORECOURT

November 29th, 2024





VIEW ALONG PRIVATE WALKWAY IN FRONT OF A3 NOVEMBER 29th, 2024





ANGLED VIEW OF A2 AND A3 UNITS LOOKING WEST FROM FORECOURT

NOVEMBER 29th, 2024

File Number: DO7 10 04 0100





ANGLED VIEW OF TOWNHOME BLOCK LOOKING NORTH FROM GRAND ALLEE

NOVEMBER 29th, 2024

Tile November 29th, 2024





FRONT VIEW OF TOWNHOME BLOCK LOOKING NORTH FROM GRAND ALLEE

NOVEMBER 29th, 2024





FRONT VIEW OF C BLOCK LOOKING EAST FROM DESCHATELETS

NOVEMBER 29th, 2024





FRONT VIEW OF A2b/A3 BLOCK LOOKING WEST # FROM FORECOURT

November 29th, 2024





VIEW TOWARDS TYPICAL CARCOURT ENTRY FROM DESCHATELETS LOOKING EAST

NOVEMBER 29th, 2024





VIEW TOWARDS DESCHATELETS BUILDING FROM GRAND ALLEE AT DESCHATELETS

NOVEMBER 29th, 2024 City





VIEW TOWARDS C BLOCKS FROM CORNER OF DES DESCHATELETS

ON

NOVEMBER 29th, 2024

NOVEMBER 29th, 2024 **OBLATES AND DESCHATELETS**





VIEW TOWARDS A2b/A3 BLOCK AND INNER FILE NUMBER 29th, 2024





VIEW TOWARDS TOWNHOME BLOCK FROM ID DE MAZENOD

Sit Plan November 29th, 2024 **CORNER OF DESCHATELETS AND DE MAZENOD**