


RECORD OF REVISIONS:

NO.	DESCRIPTION	DATE
1	ISSUED FOR SITE PLAN CONTROL REV. 4	DECEMBER 2, 2022
2	ISSUED FOR SITE PLAN CONTROL REV. 3	SEPTEMBER 29, 2022
3	ISSUED FOR 6% REVIEW	JULY 15, 2022
4	ISSUED FOR SITE PLAN CONTROL REV. 2	JUNE 7, 2022
5	ISSUED FOR SITE PLAN APPROVAL	DECEMBER 16, 2021

NUMBER: REVISION: DATE: (MM/DD/YYYY)

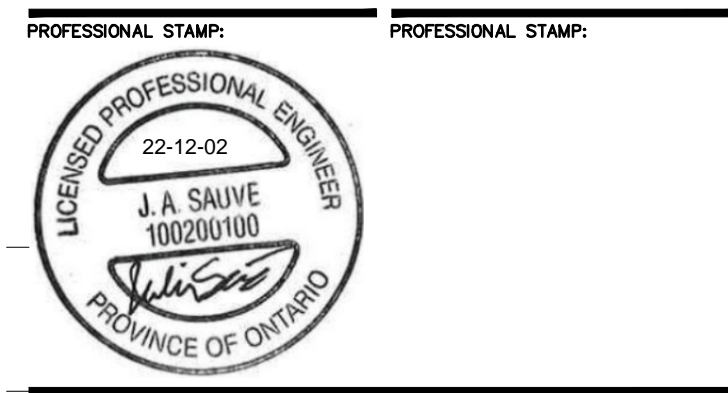


PROJECT TITLE:
FASTFRATE OTTAWA WAREHOUSE AND DISTRIBUTION FACILITY
SCALE: 1:500
SOMME ST. OTTAWA, ON
DRAWING TITLE:

SITE SERVICING PLAN

DRAWN BY: D.CANN DRAWING NUMBER:
DATE: J.A.SAUVÉ C007
REVIEWED BY: J.A.SAUVÉ
APPROVED BY: J.A.SAUVÉ
PRINT DATE: NOVEMBER 26, 2021 REVISION NUMBER:
ISSUED DATE: PROJECT #:
CLIENT PROJECT #: A001083

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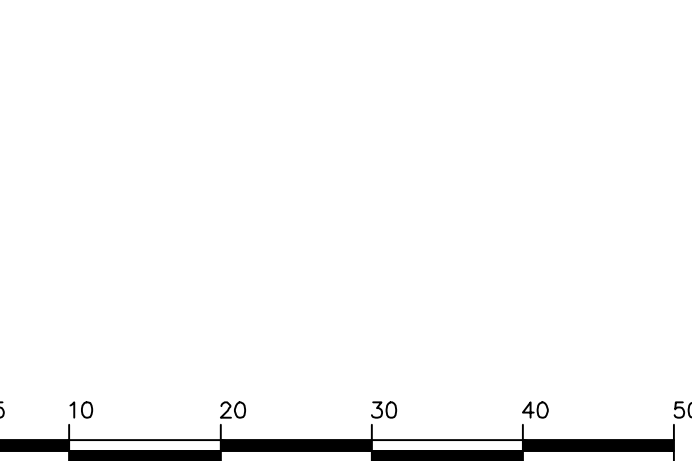
EXISTING

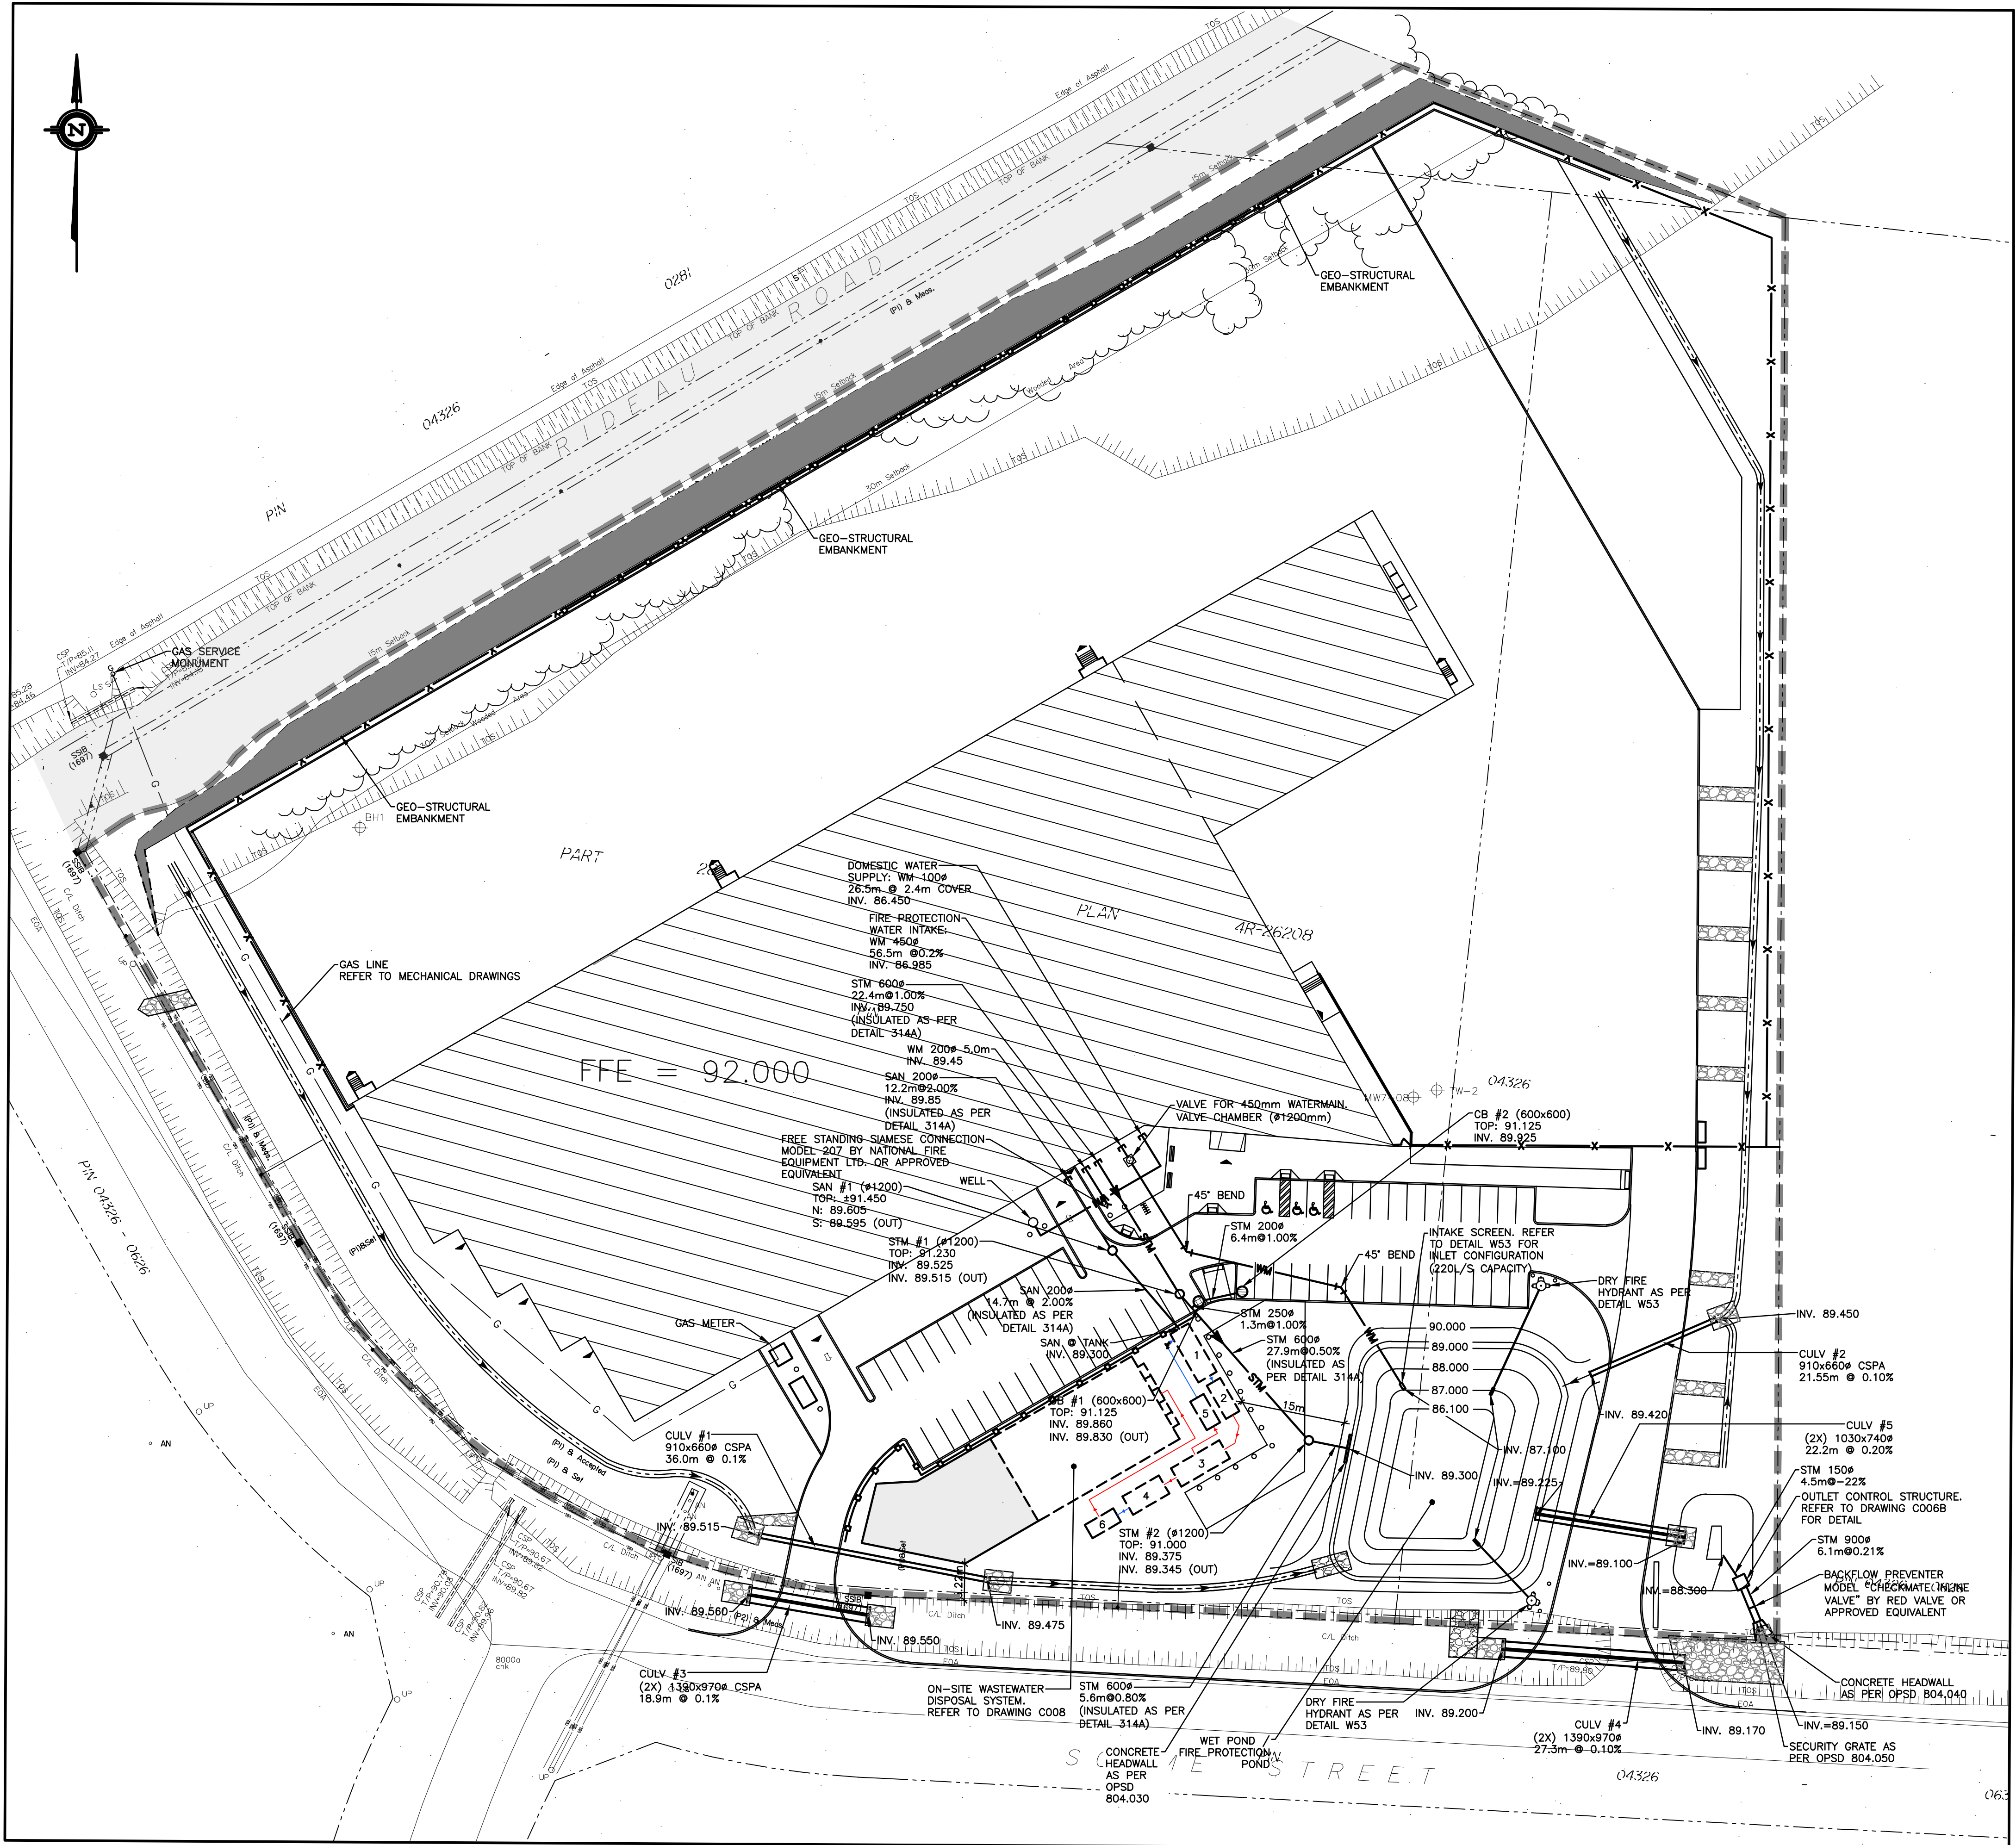- SIB SURVEY MONUMENT PLANTED
- SSIB SURVEY MONUMENT FOUND
- IB STANDARD IRON BAR
- CC SHORT STANDARD IRON BAR
- CP CUT CROSS
- IB# CONCRETE PIN
- SSIB# ROUND IRON BAR
- IB* SHORT STANDARD IRON BAR
- (WIT) IRON BAR
- Meas. WITNESS
- (AOC) MEASURED
- (P1) AINSIE, O'SULLIVAN, VOLLEBECK LTD.
- (P2) REGISTERED PLAN 4M-1388
- LS PLAN 4R-28208
- OP SIGN
- LS LIGHT STANDARD
- UP UTILITY POLE
- AN ANCHOR
- CSP NATURAL GAS LINE
- +65.00 CORRUGATED STEEL PIPE
- C/L LOCATION OF ELEVATIONS
- PROPERTY LINE CENTRELINE
- TOS TOP OF SLOPE
- BOS BOTTOM OF SLOPE
- T/P TOP OF PIPE
- T/G TOP OF GRATE
- EOA EDGE OF ASPHALT
- JB JERSEY BARRIER
- OVERHEAD WIRES WORK LIMIT
- BH-1 BOREHOLE
- A WATERMAIN
- S SANITARY SEWER
- P STORM SEWER
- D DRAIN
- G GAS LINE (APPROX. LOC.)
- T UNDERGROUND TELEPHONE (APPROX. LOC.)
- CA UNDERGROUND CABLE (APPROX. LOC.)
- E UNDERGROUND ELECTRICITY (APPROX. LOC.)
- OVERHEAD WIRES
- LOT LINE
- RIGHT-OF-WAY LIMITS
- EASEMENT
- WORK LIMITS AREA
- TOP OF SLOPE
- DITCH CENTER
- BOTTOM OF SLOPE
- WOOD AREA
- GRADE CROSSING
- FLAGPOLE
- CATCHBASIN
- MANHOLE/CATCHBASIN
- MANHOLE
- FIRE HYDRANT
- VALVE
- REDUCER
- TEE
- VALVE CHAMBER
- PRIVATE UTILITIES (WATERMAIN)
- EXTERIOR WATER FAUCET
- SLUICeway
- NATURAL GAS VALVE
- SON
- STOP SIGN
- TRAFFIC LIGHT
- ELECTRICITY POLE
- TELEPHONE POLE
- ELECT.-TEL-STREET LIGHT POLE
- ELECT.-TEL-TRANSFORMER POLE
- PRIVATE STREET LIGHT
- ELECTRICITY MANHOLE
- TELEPHONE MANHOLE
- SURVEY STATION
- ELEVATION
- DRAINAGE DIRECTION
- OVERLAND FLOW

PROPOSED

- WM WATERMAIN
- SSM SANITARY SEWER
- STM STORM SEWER
- D DRAIN
- G GAS LINE (APPROX. LOC.)
- T UNDERGROUND TELEPHONE (APPROX. LOC.)
- CA UNDERGROUND CABLE (APPROX. LOC.)
- E UNDERGROUND ELECTRICITY (APPROX. LOC.)
- OVERHEAD WIRES
- LOT LINE
- RIGHT-OF-WAY LIMITS
- EASEMENT
- WORK LIMITS AREA
- TOP OF SLOPE
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- PRIVATE STREET LIGHT
- ELECTRICITY MANHOLE
- TELEPHONE MANHOLE
- SURVEY STATION
- ELEVATION
- DRAINAGE DIRECTION
- OVERLAND FLOW

- SEPTIC SYSTEM LEGEND**
1. SEPTIC TANK, MIN. WORKING VOLUME OF 38,400 L
 2. PUMPING CHAMBER, MIN. WORKING VOLUME OF 17,000 L
 3. BASKET BIOFILTRER TANK, 34000 L
 4. WATERNOX-LS TANK, 18500 L
 5. ALKALINITY TANK, 7,700 L
 6. PUMPING CHAMBER, 4,800 L
- PRESSURIZED TANK LINES
— GRAVITY DRIVEN TANK LINES



NOTE OF CAUTION

THE GEODETIC COORDINATES OF EVERY ITEM INCLUDED AS PART OF THIS DOCUMENT HAVE NO LEGAL VALUE. THE SITE LAYOUT MUST BE COMPLETED USING THE OFFICIAL BENCHMARKS OF AN ACCREDITED LAND SURVEYOR.

THE UNDERGROUND FEATURES AND INFORMATION THAT APPEAR ON THE DRAWINGS WERE OBTAINED FROM THE PUBLIC UTILITY COMPANIES AND/OR FROM THE CITY OF OTTAWA RESPECTIVELY.

ALL INFORMATION UNDER THE LEGEND 'EXISTING' IS FOR INFORMATION ONLY. COMPLETE OR EXACT LOCATION AND ELEVATION OF UNDERGROUND SERVICES ARE NOT GUARANTEED.

CERTAIN UNDERGROUND FEATURES ON PRIVATE PROPERTY ARE NOT SHOWN ON THE CURRENT DRAWING.

ANYONE WHO PROCEEDS WITH EXCAVATION WORK SHALL VERIFY THE EXACT LOCATION OF ALL UNDERGROUND FEATURES, BY EXPLORATORY EXCAVATIONS, AND SHALL ASSUME FULL RESPONSIBILITY IF THERE IS ANY DAMAGE THAT OCCURS DURING WORK.

THE CONTRACTOR WILL HAVE THE RESPONSIBILITY AND THE OBLIGATION TO VALIDATE, BY EXPLORATORY EXCAVATION, THE SIZE OF THE PUBLIC UTILITIES UNDERGROUND SERVICES AND TO WARN THE ENGINEER OF ANY CONFLICT WITH THE PROJECTED WORK.