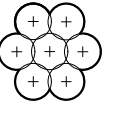
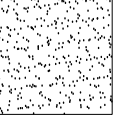

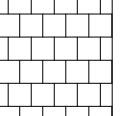
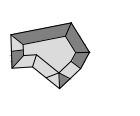



CLIENT: CAPITAL PARKING INC.


CONSULTANTS  
 ARCHITECTS: **chmiel**architects  
 200 - 109 Bank Street  
 Ottawa, ON K1P 0N6  
 T (613) 234-3585  
 F (613) 234-6224

- LEGEND
-  PROPOSED SHRUBS / ORNAMENTAL GRASSES
  -  PROPOSED PEASTONE
  -  PROPOSED SOD
  -  PROPOSED PRECAST CONCRETE PAVERS
  -  PROPOSED BOULDER
  -  PROPOSED DECIDUOUS TREE


- GENERAL NOTES:**
- It is the responsibility of the appropriate contractor or official to report any errors, omissions or discrepancies on this plan with actual site conditions to the Landscape Architect before proceeding with construction.
  - The contractor is to notify all utility companies and authorities prior to any excavation and ascertain locations of underground services.
  - The contractor is to reinstate all areas and items damaged as a result of construction activity.
  - The contractor is to comply with all pertinent codes and by-laws.
  - The contractor is to maintain a positive surface run-off throughout the entire construction period.
  - The Landscape Architect is not responsible for subsurface conditions.
  - The contractor is to identify all existing trees to remain on site with the Landscape Architect prior to construction.
  - The contractor is to stake the proposed location of all plant material in conjunction with the Landscape Architect prior to excavation.
  - Minimum distances for selected deciduous trees are as follows:
    - Building Foundations 7.5m
    - Sidewalks 1.5m
    - Public Streets 2.5m
    - Underground Infrastructure 2.0m
  - All trees within 1m of underground utility trenches are to be excavated by hand.
  - Remove all protective wrapping from tree trunks after installation.
  - Staking of trees shall only be performed if necessary.
  - Ensure that mulch is pulled back a min. distance of 75mm from base of tree trunk.

**PROPOSED PLANT LIST** QTY KEY


KEY	QTY.	BOTANICAL NAME	COMMON NAME	SIZE	CONDITION	REMARKS
<b>TREES</b>						
JL	1	<i>Syringa reticulata</i>	Japanese Tree Lilac	60mm cal.	B&B	
<b>SHRUBS</b>						
AH	18	<i>Hydrangea arborescens</i> 'Annabelle'	Annabelle Hydrangea	1 gallon pot	Potted	Space 1000mm o.c.
SS	7	<i>Sorbaria sorbifolia</i>	Ural False Spirea	600mm ht.	Potted	Space 1000mm o.c.
<b>ORNAMENTAL GRASSES</b>						
KF	8	<i>Calamagrostis x acutiflora</i> 'Karl Foerster'	Feather Reed Grass	250mm pot	Potted	Space 800mm o.c.
RG	27	<i>Phalaris arundinacea</i> 'Dwarf Garters'	Compact Ribbon Grass	100mm pot	Potted	Space 500mm o.c.

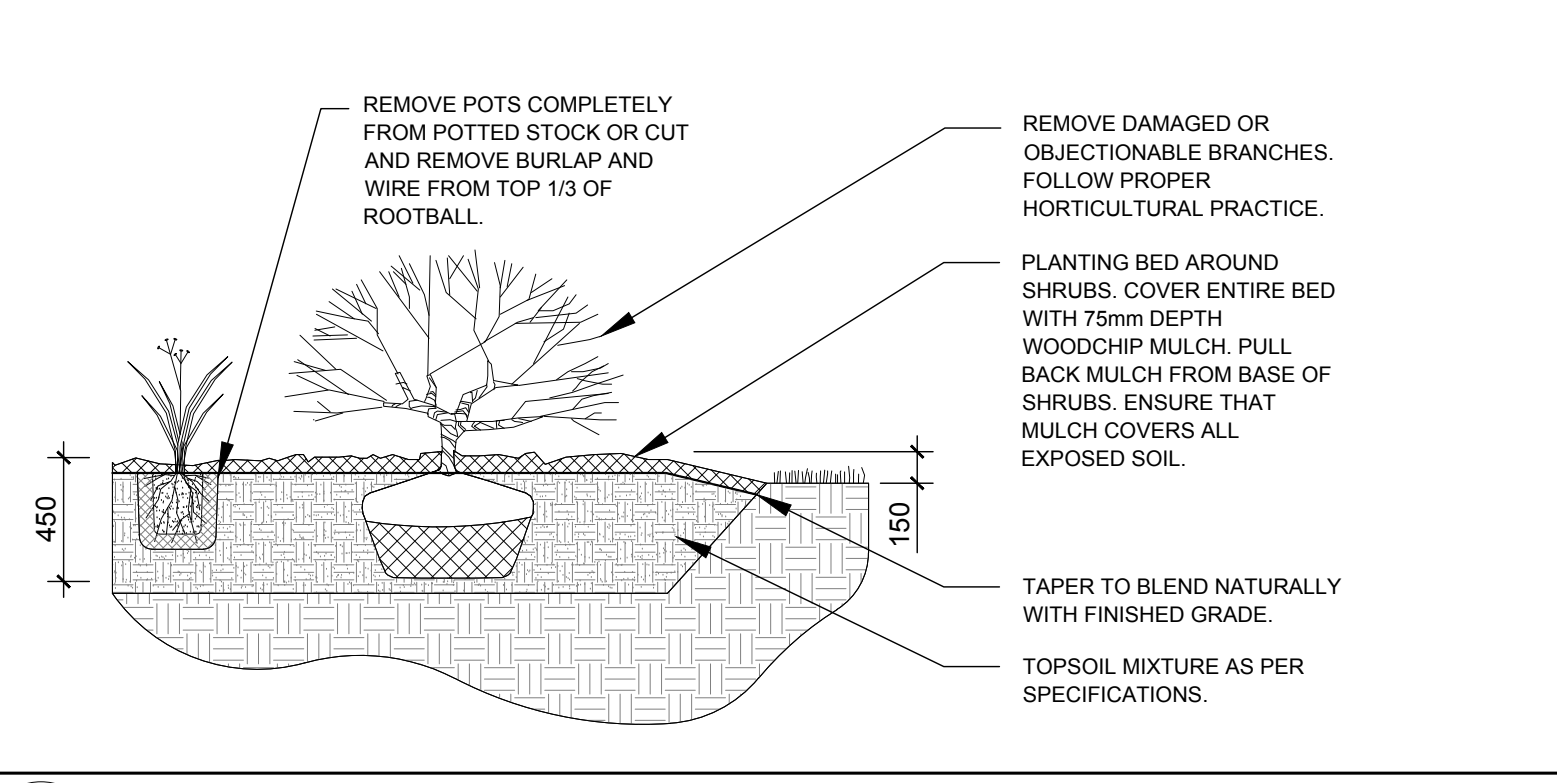

2 SHRUB / ORNAMENTAL GRASS PLANTING  
 SCALE: NTS

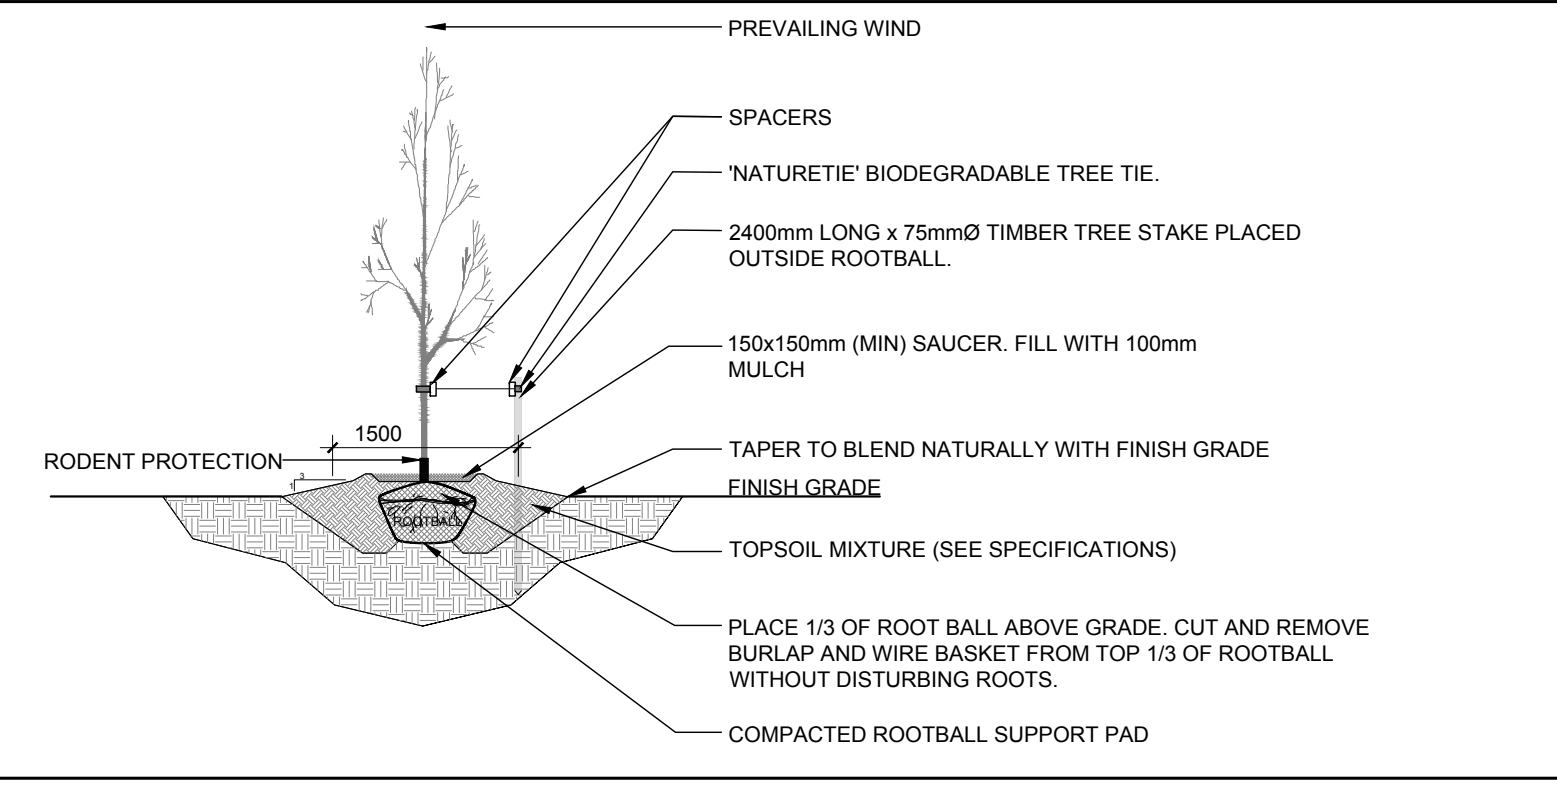

3 DECIDUOUS TREE PLANTING  
 SCALE: NTS

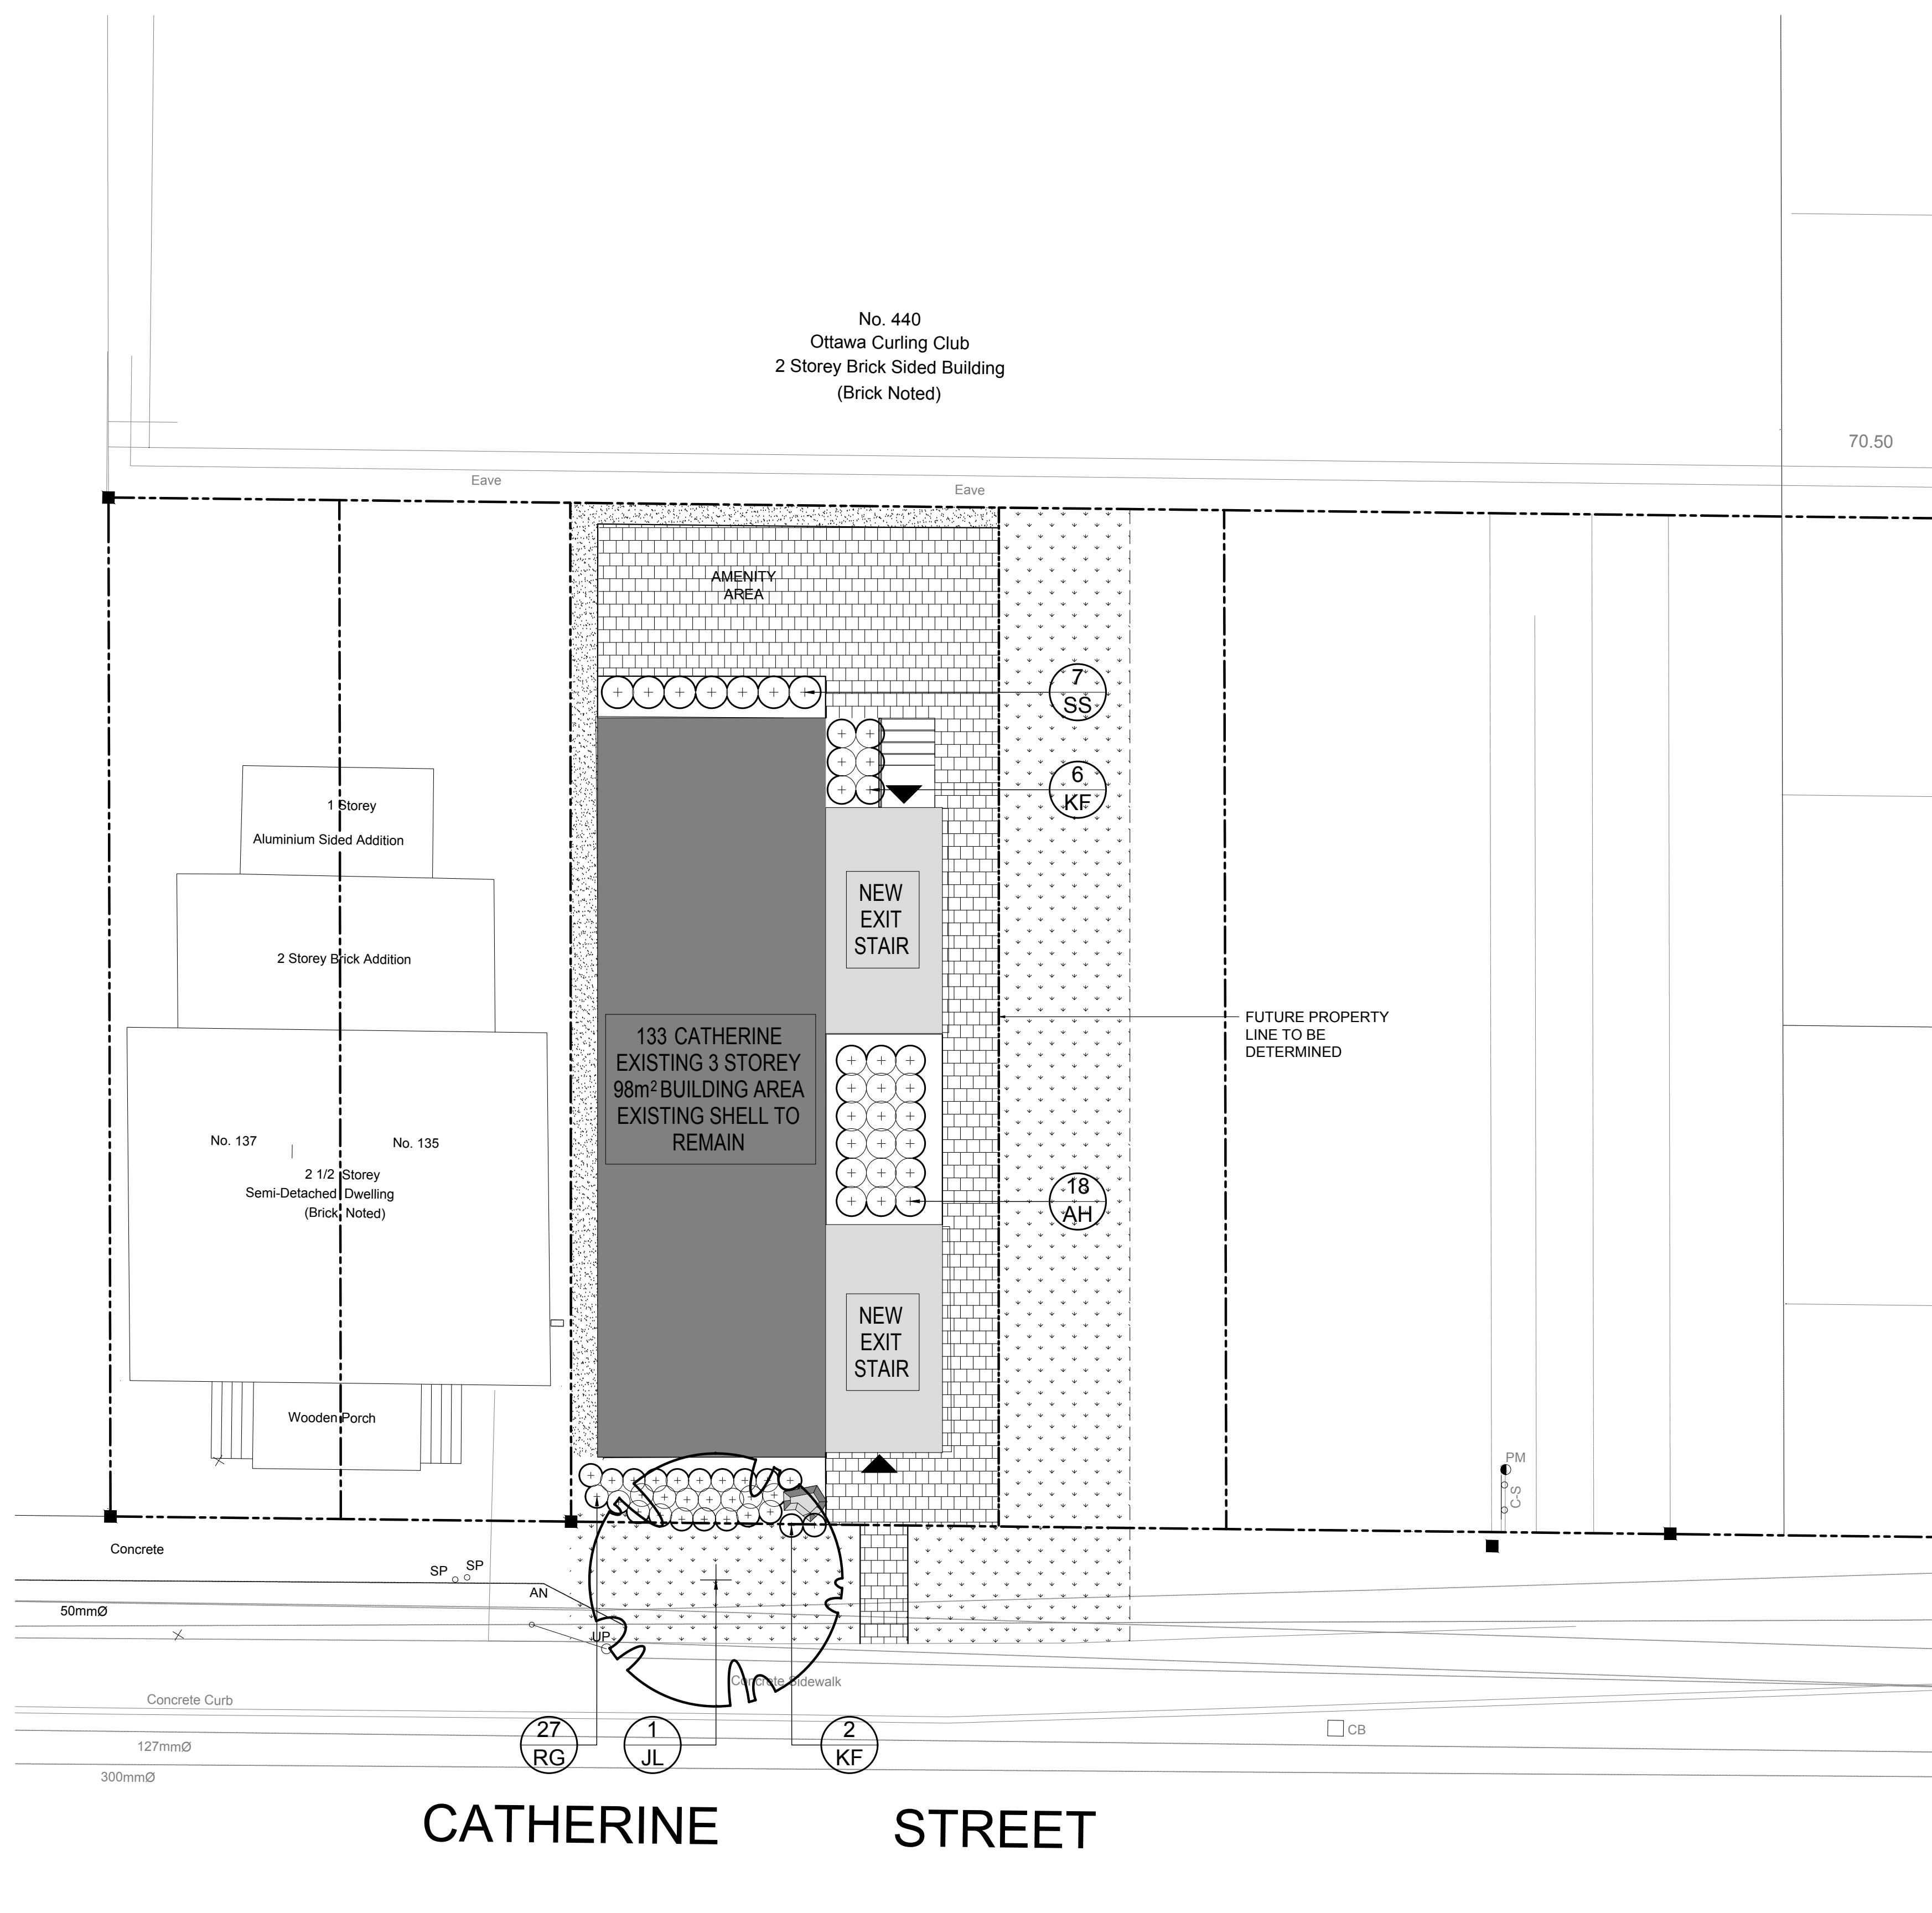

1 LANDSCAPE PLAN  
 SCALE 1:100


No.	Issue	Date	ML	JL
1	ISSUED FOR SITE PLAN CONTROL	10/01/2020	ML	JL

**JAMES B. LENNOX & ASSOCIATES INC.**  
 LANDSCAPE ARCHITECTS  
 3332 CARLING AVE. OTTAWA, ONTARIO K2H 5A8  
 Tel. (613) 722-5168 Fax. (866) 343-3942

PROJECT  
 133 CATHERINE  
 133 CATHERINE STREET, OTTAWA ON

DRAWING  
 LANDSCAPE PLAN

STAMP




SCALE  
 AS SHOWN

START DATE  
 SEPTEMBER 2020

PROJECT NO.

PROJECT NORTH

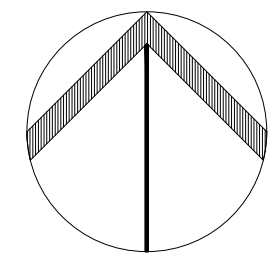

DRAWING NO.  
**L.1**

PLOT SIZE ARCH-D