


METRIC


ALL DIMENSIONS SHOWN ARE
IN METRES AND/OR MILLIMETRES
UNLESS OTHERWISE NOTED.

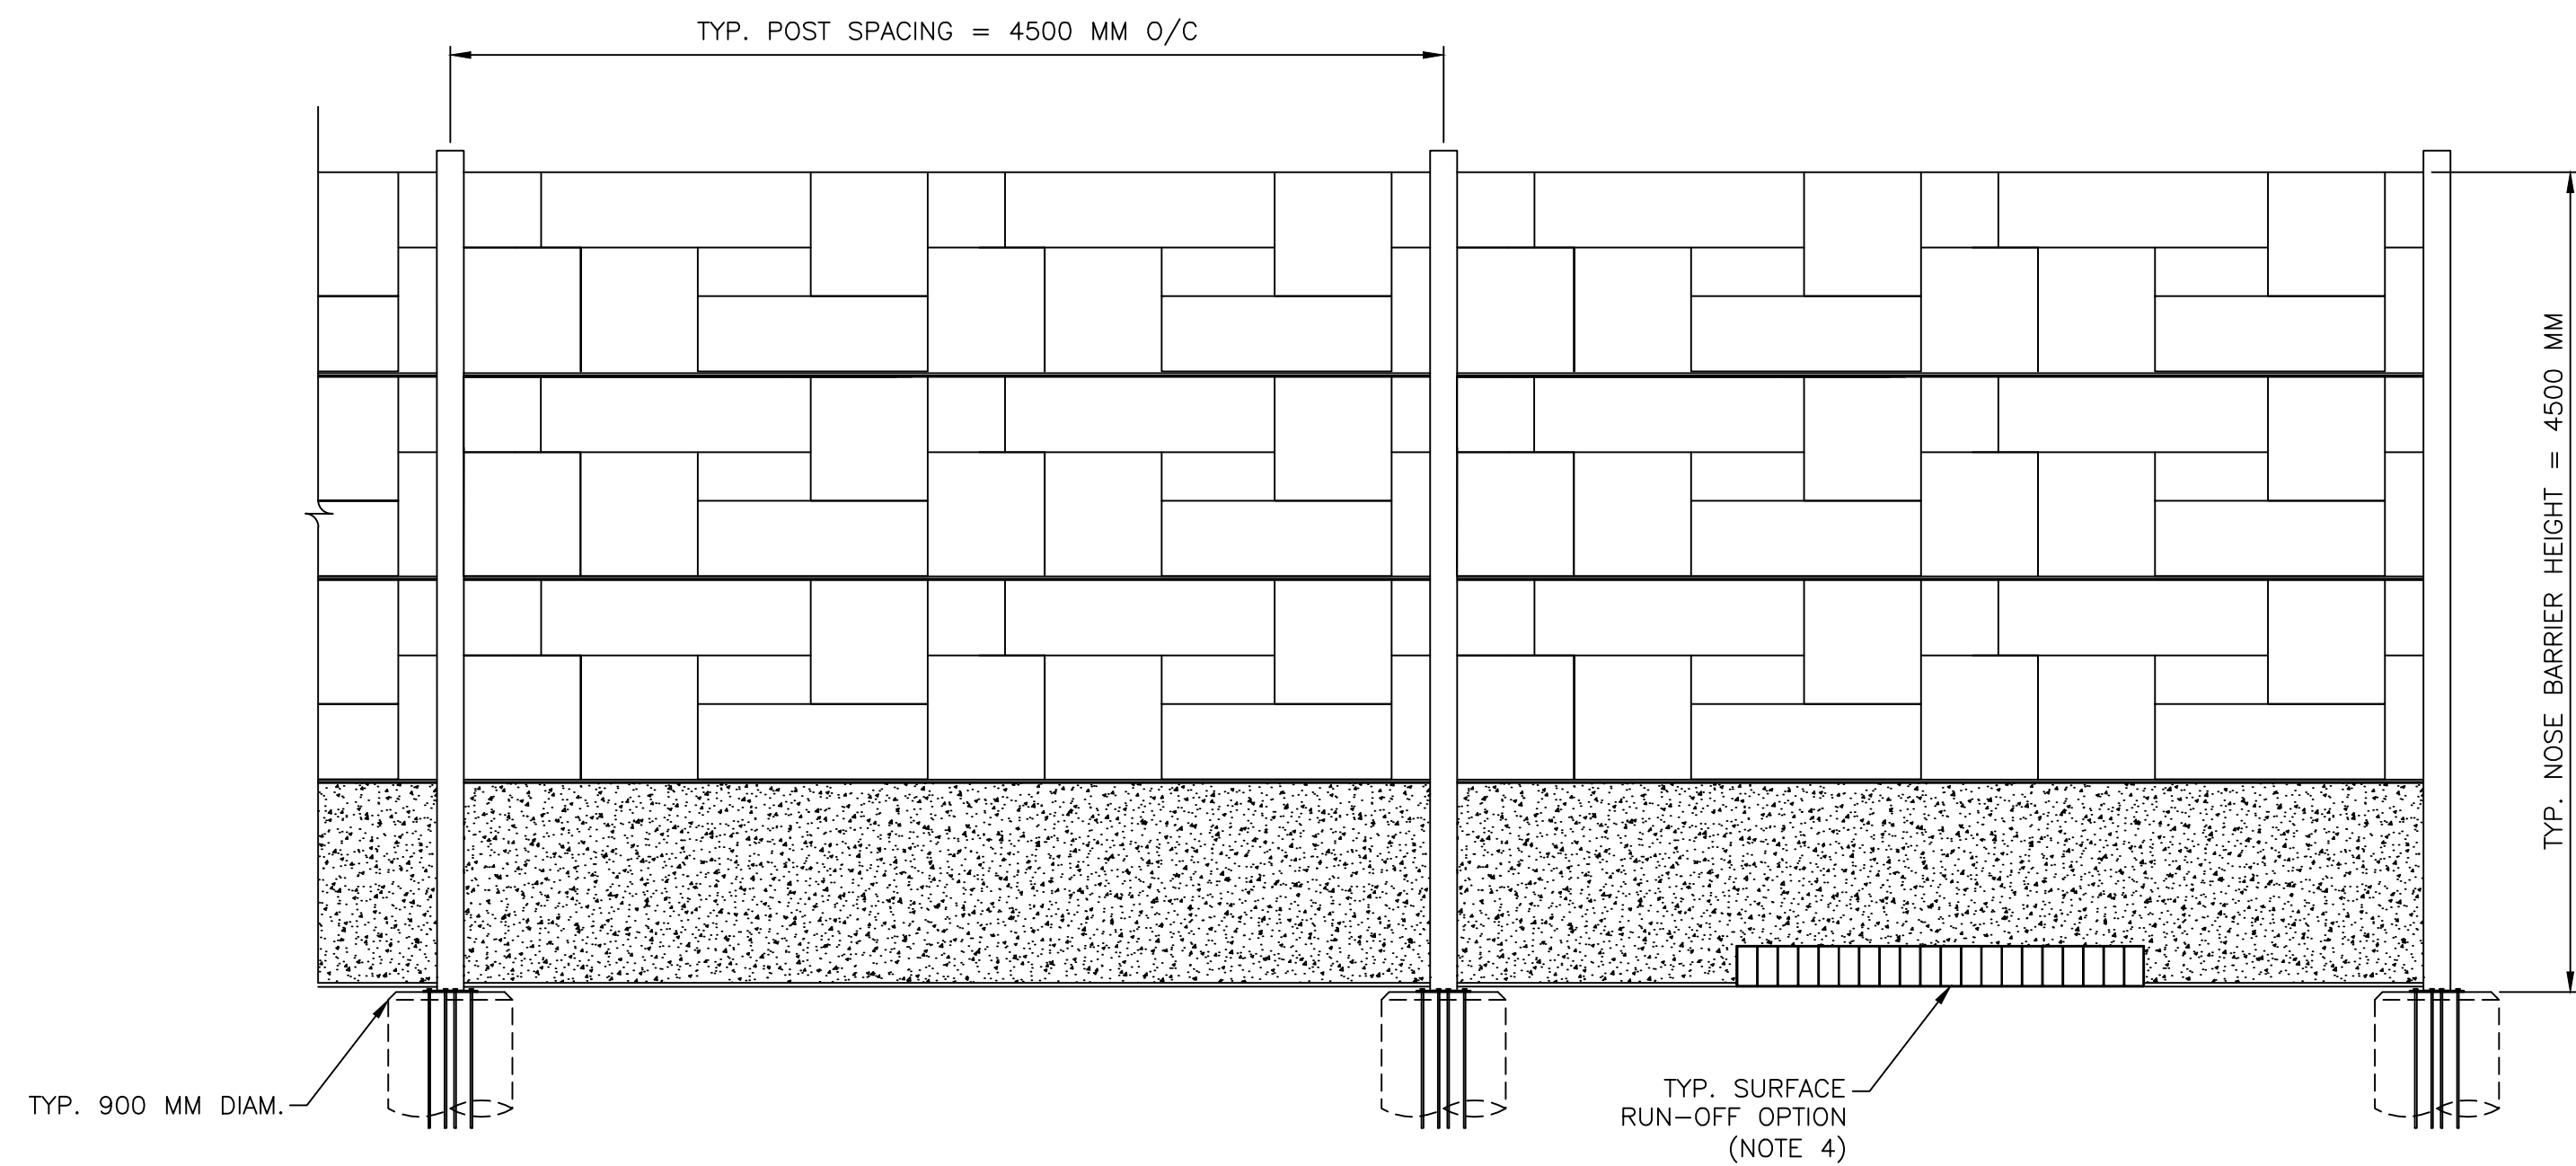

TYPICAL PRECAST NOISE WALL ELEVATION
SCALE NTS

NOTES:

1. FOUNDATION DESIGN AS PER LOCAL CONDITIONS IN ACCORDANCE WITH THE ENGINEER OF RECORD
2. REFER TO GEOTECH REPORTS FOR LOCAL GROUND CONDITIONS
3. REFER TO NOISE ASSESSMENT FOR PROPOSED NOISE BARRIER LAYOUT
4. WATER PASSING GRATE OR EQUIVALENT FOR SURFACE RUN-OFF. SHALL BE DESIGNED IN ACCORDANCE WITH DRAINAGE DESIGN CAPACITY AND SURFACE GRADING.
5. TYP. MIN. ACOUSTIC PANEL SURFACE DENSITY 20 KG/M2 (REFER TO OPSS 760)
6. ALL DIMENSIONS ARE TYPICAL AND SHALL BE REVISED AS PER THE DETAIL DESIGN AND APPROVED BY THE ENGINEER OF RECORD

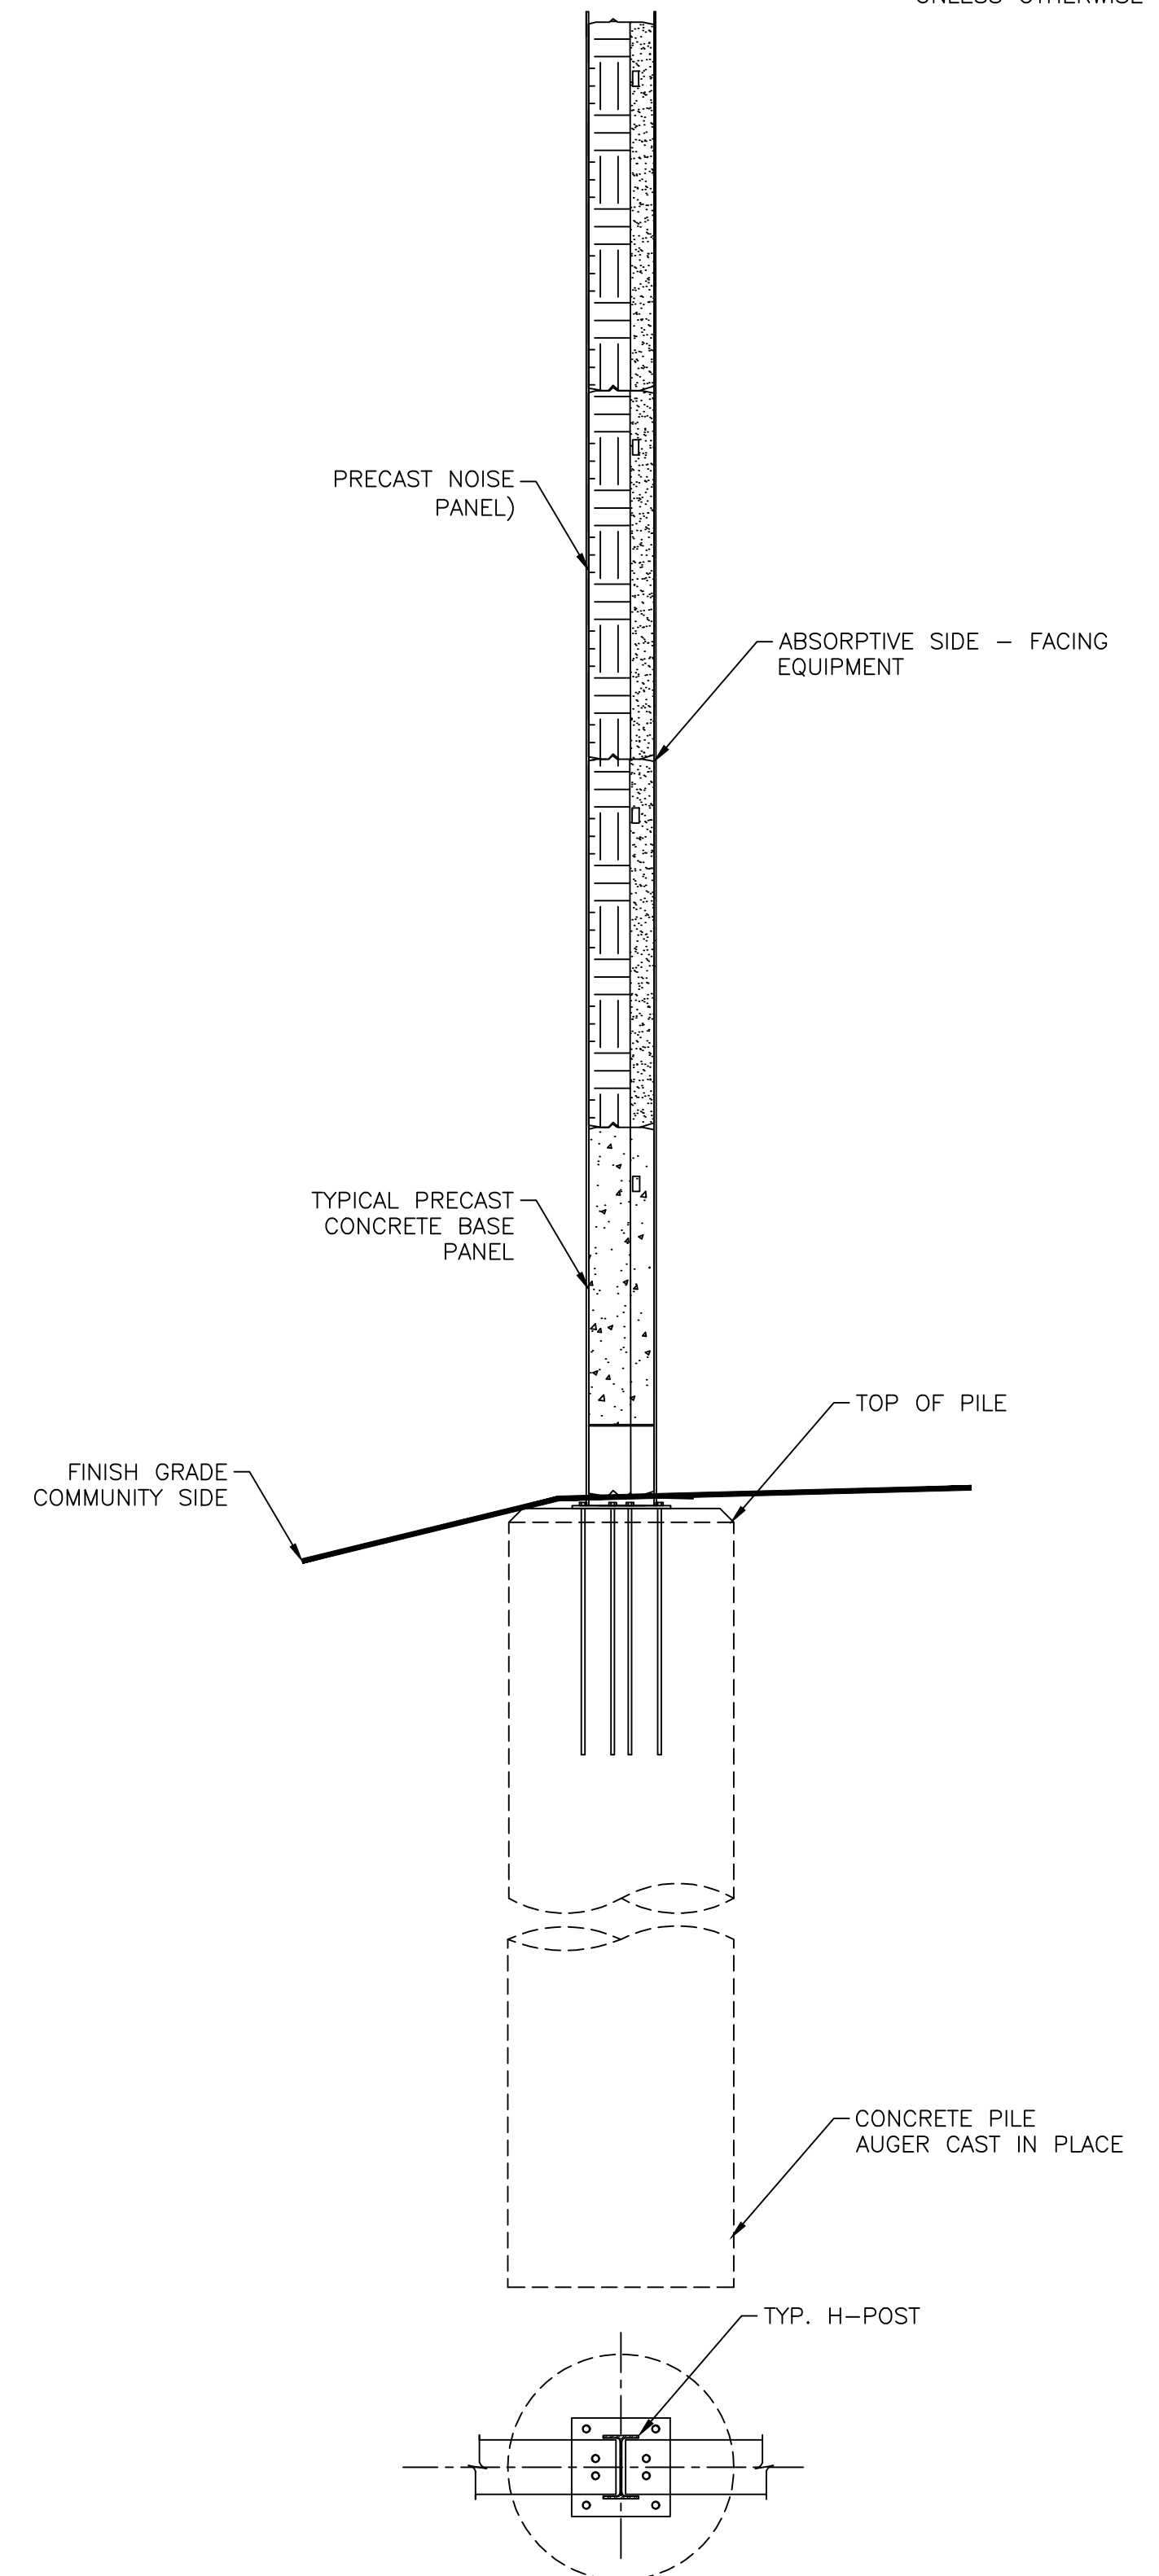

TYPICAL NOISE WALL SECTION
SCALE NTS

REFERENCE DRAWINGS		ISSUE		REVISIONS			DRAWN BY: MC	DESIGNED BY:				PRE-CAST NOISE WALL SHEET 1 OF 1			
							CHECKED BY: MC	APPROVED BY:							