SITE PLAN KEYNOTES:

- 1 EXISTING SIDEWALK TO REMAIN
- 2 EXISTING ASPHALT PAVING TO REMAIN
- 3 EXISTING CURB TO REMAIN

9123

⁺5428 ⁺

3957

SITE AREA

ZONE:

BUILDING AREA

GROSS FLOOR AREA

BUILDING HEIGHT

SCHEDULE 1:

SCHEDULE 1A:

9432

R5B H(19)

AREA B

AREA X

937.6m²

633.56m²

3,810.12m²

6062

/ ← 5 | **→**

19238

- 4 EXISTING SIGN TO REMAIN
- 5 EXISTING LANDSCAPING TO REMAIN.

EXISTING

2.5 STOREY BUILDING

TO REMAIN

41047

NEW BUILDING

84 UNITS

254 ARGYLE AVE.

13070

46.50m N 31° 56' 30" W

- 21 RELOCATE EXISTING CHURCH FACADE TO NEW LOCATION
- 22 VENTED CISTERN LID
- 23 NEW CONCRETE SIDEWALK PER CIVIL
- 24 REINSTATE TOP SOIL AND GRASS IN BETWEEN ROAD AND SIDEWALK AT AREAS EFFECTED BY CONSTRUCTION
- 25 NEW CURB PER CIVIL
- 26 REINSTATE EXISTING ROAD ASSEMBLY PER CIVIL AT AREAS EFFECTED BY DEMOLITION AND CONSTRUCTIONS. PROVIDE SMOOTH TRANSITION TO EXISTING PAVING.

33

- 27 BACKFILL TRENCHES AS REQUIRED PER CIVIL AND GEOTECHNICAL.
- 28 RELOCATE EXISTING FIRE HYDRANT PER CIVIL
- 29 NEW DRIVEWAY PER CIVIL
- 30 NEW CURB WALL PER CIVIL
- 31 OVERHEAD DOOR TO UNDERGROUND PARKING

- 32 WOOD PRIVACY FENCE PER LANDSCAPING
- 33 TERMINATE WOOD PRIVACY FENCE FLUSH TO THE RETAINING WALL PER LANDSCAPING
- 34 PEDESTRIAN GATE

38 VAULT

14132

42

- 35 WALKWAY PER LANDSCAPING
- 36 PATIO PER LANDSCAPING
- 37 PLANTS PER LANDSCAPING

EXISTING 1 STOREY GARAGE

TO REMAIN

5759

4017

30 39

- 39 RAISED PLANTER WALL PER LANDSCAPING
- 40 STEPBACK AT LEVELS 2 TO ROOF
- 41 SETBACK AT LEVEL 1B
- 42 SETBACK AT LEVELS 1C TO ROOF

SITE PLAN LEGEND:

SITE PLAN GENERAL NOTES:

2. DO NOT SCALE THIS DRAWING

CONSULTANT

CONSULTANT

EXCAVATION

EXCAVATION

TO DIGGING

FROM EXISTING PLANS AND SURVEYS

UNKNOWN SUBSURFACE CONDITIONS

3. REPORT ANY DISCREPANCIES PRIOR TO COMMENCING WORK.

SITE AND REPORT ANY ERRORS AND/OR OMISSIONS TO THE

5. REINSTATE ALL AREAS AND ITEMS DAMAGED AS A RESULT OF CONSTRUCTION ACTIVITIES TO THE SATISFACTION OF THE

6. CONTRACTOR TO LAYOUT PLANTING BEDS, PATHWAYS ETC.

TO APPROVAL OF CONSULTANT PRIOR TO ANY JOB

7. THE ACCURACY OF THE POSITION OF UTILITIES IS NOT

GUARANTEED - CONTRACTOR TO VERIFY PRIOR TO

9. ALL DISTURBED AREAS TO BE RESTORED TO ORIGINAL

CONDITION OR BETTER UNLESS OTHERWISE NOTED

8. INDIVIDUAL UTILITY COMPANY MUST BE CONTACTED FOR

CONFIRMATION OF UTILITY EXISTENCE AND LOCATION PRIOR

NO RESPONSIBILITY IS BORN BY THE CONSULTANT FOR

4. CONTRACTOR TO CHECK AND VERIFY ALL DIMENSIONS ON

EXISTING BUILDING & SITE ELEMENTS **NEW BUILDING** NEW ASPHALT PAVING **NEW GRASS** NEW PLANTING BEDS / PLANTS PER LANDSCAPING

NEW CONCRETE SIDEWALK NEW CONCRETE PAD

NEW RIVER STONE PER LANDSCAPING NEW PAVER PER LANDSCAPING

— - - - SET BACK LINE

PROPERTY LINE

---- EXTENT OF PARKING BELOW GRADE --- x ---- x --- NEW FENCE PER LANDSCAPE

—E-WTR—E-WTR— EXISTING WATER MAIN TO REMAIN —wtr—wtr— NEW WATER MAIN PER CIVIL

—E-SAN—E-SAN— EXISTING SANITARY SEWAGE TO REMAIN

——E-ST——E-ST— EXISTING STORM SEWAGE TO REMAIN

—E-OHW——E-OHW— EXISTING ELECTRICAL OVERHEAD SERVICE TO —онw— oнw— NEW ELECTRICAL OVERHEAD SERVICE PER ELECTRICAL

——E-G——E-G—— EXISTING GAS LINE TO REMAIN — G — NEW GAS LINE PER CIVIL

——E-B———E-B—— EXISTING BELL LINE TO REMAIN

——E-R——E-R—— EXISTING ROGER LINE TO REMAIN ENTRANCE/ BARRIER-FREE ENTRANCE

MAIN ENTRANCE

VEHICLE ACCESS \triangle NEW AREA DRAIN PER CIVIL

> CATCH BASIN: EXISTING TO REMAIN / NEW MAINTENANCE HOLE: EXISTING TO REMAIN / **NEW PER CIVIL**

UTILITY POLE: EXISTING TO REMAIN / NEW VALVE AND VALVE BOX : EXISTING TO REMAIN NEW PER CIVIL EX. V&VB V&VB

LIGHT STANDARD ⊕ LS NEW FIRE HYDRANT PER CIVIL -O_{FH}

NEW WATER METER PER CIVIL NEW REMOTE WATER METER PER CIVIL

NEW SIAMESE CONNECTION DC NEW DROPPED CURB

NEW TREE PER LANDSCAPING

EXISTING TREE TO REMAIN

ARCHITECT OF RECORD

CSV ARCHITECTS 1. ALL GENERAL SITE INFORMATION AND CONDITIONS COMPILED

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REV DATE ISSUE

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5. ALL WORK SHALL BE IN ACCORDANCE WITH THE

ONTARIO BUILDING CODE AND ALL SUPPLEMENTS

AND APPLICABLE MUNICIPAL REGULATIONS. CLIENT



OTTAWA ONTARIO, CANADA

PROJECT

254 ARGYLE

254 Argyle Avenue, Ottawa, Ontario

TITLE

SITE PLAN

PROJECT NO: 2023-0250 EF / IK DRAWN:

APPROVED: DH SCALE: As indicated DATE PRINTED: 12/13/2024 2:08:59 PM

REV DRAWING NO.

A100

SHRUB: EXISTING TO REMAIN / NEW PER

MUNICIPAL ADDRESS 254 ARGYLE AVE. OTTAWA, ON

1 NEW SITE PLAN

LOT 16 (SOUTH ARGYLE AVENUE)

LOT 16 (SOUTH ARGYLE AVENUE)

DRAFT OF TOPOGRAPHIC PLAN OF SURVEY OF

PREPARED BY SURVEYED BY ANNIS, O'SULLIVAN,

LEGAL DESCRIPTION

REGISTERED PLAN 30

REFERENCE SURVEY

REGISTERED PLAN 30

CITY OF OTTAWA

VOLLEBEKK LTD.

CITY OF OTTAWA

MIN. LOT WIDTH 22.5m MIN. LOT AREA 937.05m² 675m² 35m 9 STOREYS MIN. FRONT YARD SETBACK MIN. REAR YARD SETBACK 7.5m MIN. INTERIOR YARD SETBACK 1.5m (6m past 21m) MAX. HEIGHT

ZONING PROVISION

AMENITY AREA

LANDSCAPED AREA

VISITOR SPACES ACCESSIBLE PARKING **BICYCLE PARKING**

RESIDENTIAL SPACES

46.50m N 31° 57' 10" W

EXISTING

7 STOREY BUILDING

TO REMAIN

37090

PROVIDED

20.17m

1.42m

3.759m

1.5m

34.5m

582.5m²

270.94m²

42732

REQUIRED

504m² (6m²/unit)

281.12m²

42 (.5/UNIT)

2 BEDROOM

3 BEDROOM TOTAL

UNIT TYPES

1 BEDROOM

STUDIO

3759

GFA BREAKDOWN

RESIDENTIAL

WINE BAR


TOTAL

PROVIDED

3718.81m²

91.31m²

3810.12m²

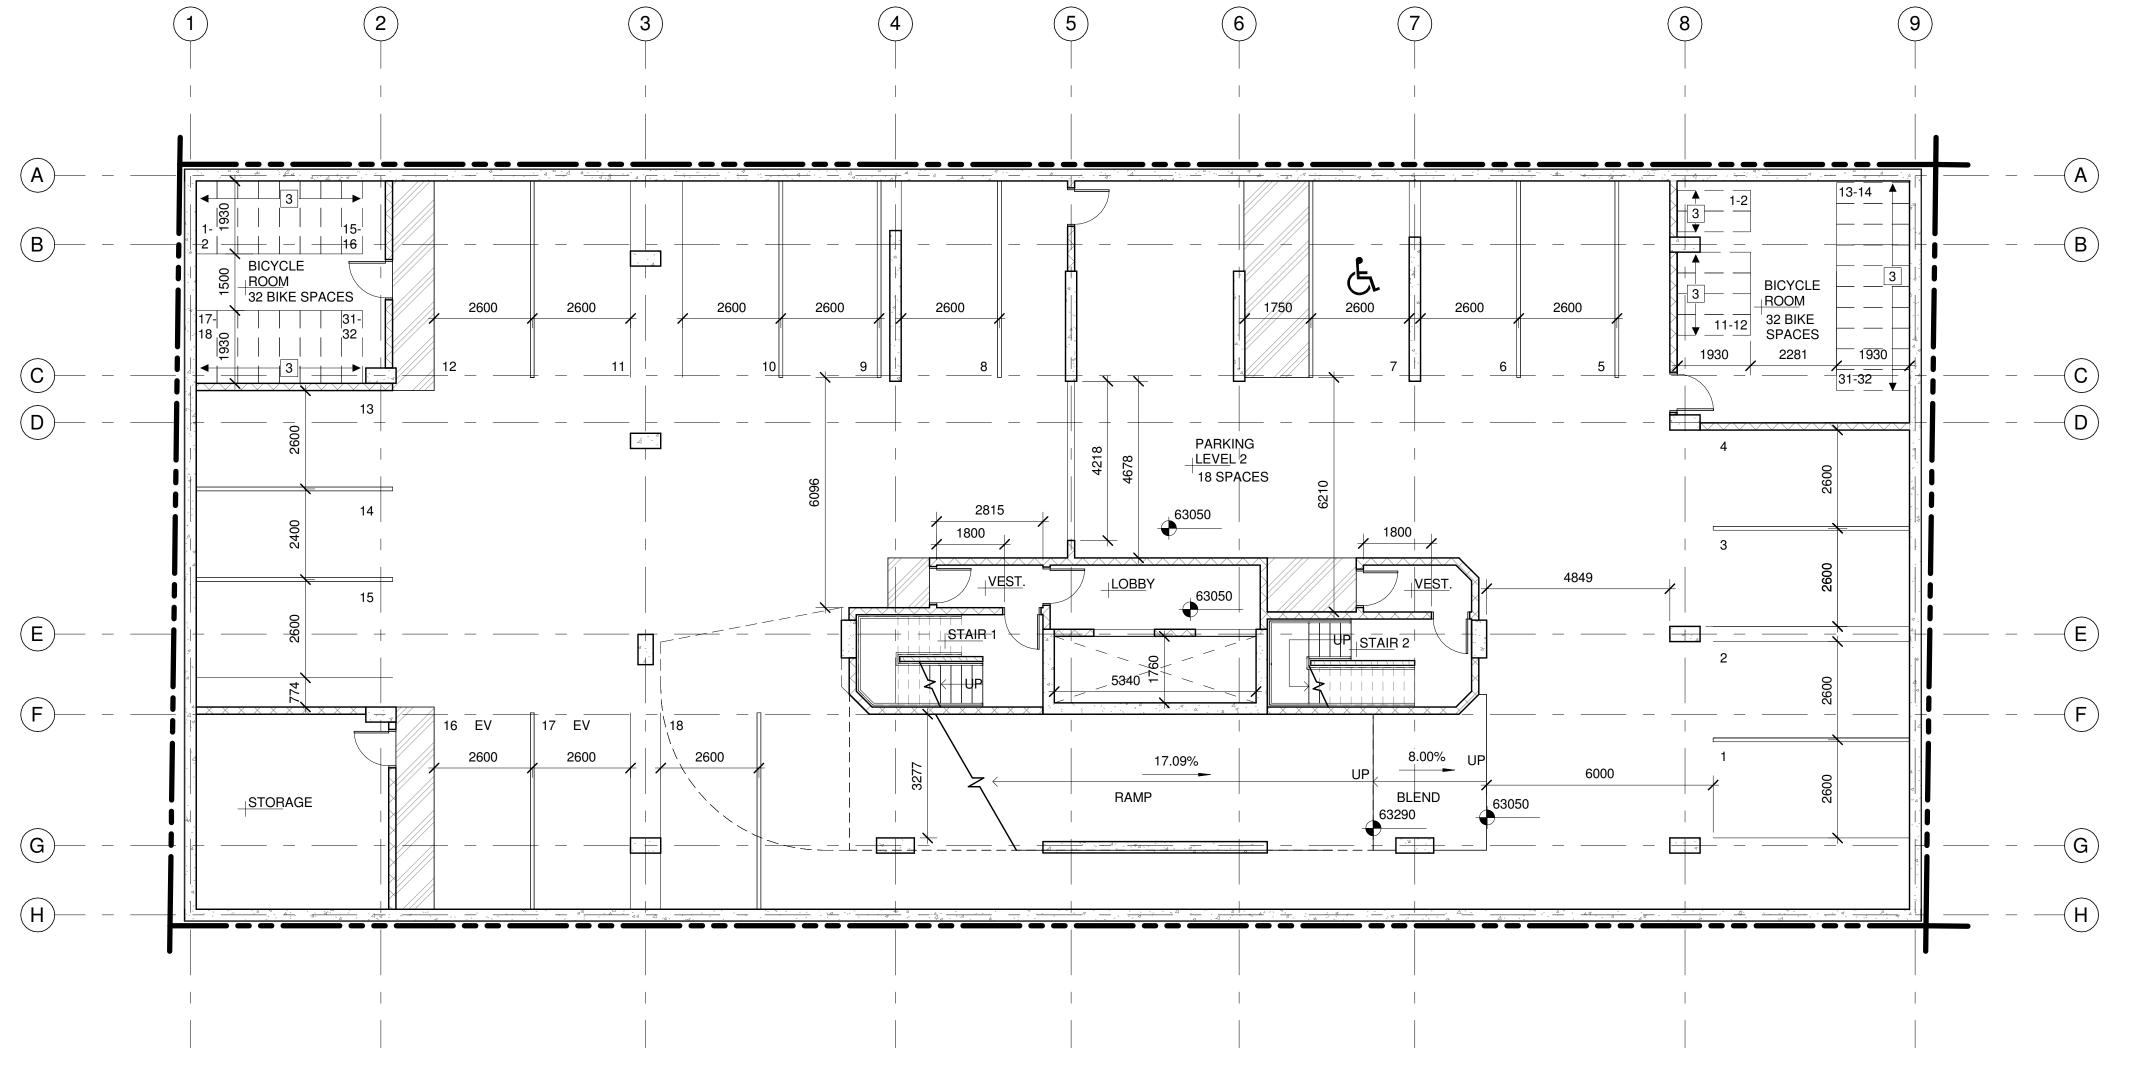

1 LEVEL -2 PLAN

GENERAL REFERENCE PLAN NOTES:

- A. DO NOT SCALE DRAWINGS. B. DIMENSIONS ARE FOR LOCATION ONLY. REFER TO STRUCTURAL DRAWINGS FOR FOOTINGS, COLUMNS AND FOUNDATION WALL SIZES.
- DETAILS OF UNDERGROUND SERVICES.
- NOTED. F. ALL WINDOWS ARE DIMENSIONED TO CENTERLINE OF
- OPENING, INCLUDING SIDELIGHT FRAMING, UNLESS OTHERWISE NOTED
- FINISHED FACE, UNLESS NOTED OTHERWISE. I. ALL INTERIOR DIMENSIONS ARE DIMENSIONED FROM
- OTHERWISE NOTED. PARTITION, UNLESS OTHERWISE NOTED. CONSIDER OFFSET FROM PARTITION CENTERLINE TO STUD FRAMING CENTER
- K. ENSURE 25mm MINIMUM THICKNESS OF CONCRETE COVER OVER VERTICAL STEEL REINFORCEMENT TO ALL REINFORCED CONCRETE STRUCTURAL COLUMNS AND WALLS.

REFERENCE PLAN KEYNOTES:

- 2 EXTENT OF DROPPED SLAB ABOVE
- 3 DOUBLE TEAR BICYCLE STORAGE SPACES
- 4 EXIT ONLY

- C. REFER TO MECHANICAL + ELECTRICAL DRAWINGS FOR D. ALL EXTERIOR FOUNDATION WALLS ARE DIMENSIONED TO
- EXTERIOR FACE OF ASSEMBLY UNLESS OTHERWISE NOTED. E. ALL INTERIOR FOUNDATION WALLS + FOOTINGS ARE DIMENSIONED FROM GRIDLINE TO FACE UNLESS OTHERWISE
- WINDOW OPENING, UNLESS OTHERWISE NOTED. G. ALL DOORS ARE DIMENSIONED TO CENTERLINE OF DOOR
- H. ALL EXTERIOR WALLS ARE DIMENSIONED TO THE EXTERIOR
- INTERIOR FINISHED FACES OF EXTERIOR WALLS, UNLESS J. ALL INTERIOR WALLS ARE DIMENSIONED TO CENTERLINE OF
- BASED ON WALL ASSEMBLY.

- 1 CISTERN OVERFLOW AND HATCH / VENTED CISTERN LID

- 5 EXTENT OF FOUNDATION WALL BELOW

REFERENCE PLAN LEGEND:



NOT IN CONTRACT

PAINTED PARKING ISLAND

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3 2024.10.25 REISSUED FOR SPC AND REZONING 2 2024.08.29 ISSUED FOR SPC AND REZONING REV DATE ISSUE

ARCHITECT OF RECORD

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AND APPLICABLE MUNICIPAL REGULATIONS. CLIENT



BE RESPONSIBLE TO VERIFY DIMENSIONS ON SITE. 5. ALL WORK SHALL BE IN ACCORDANCE WITH THE

ONTARIO BUILDING CODE AND ALL SUPPLEMENTS

OTTAWA ONTARIO, CANADA

PROJECT

254 ARGYLE

254 Argyle Avenue, Ottawa, Ontario

TITLE

LEVEL -2 PLAN


PROJECT NO: 2023-0250 DRAWN: Author APPROVED: Approver 1:100


DATE PRINTED: 2025-03-24 11:59:31 AM

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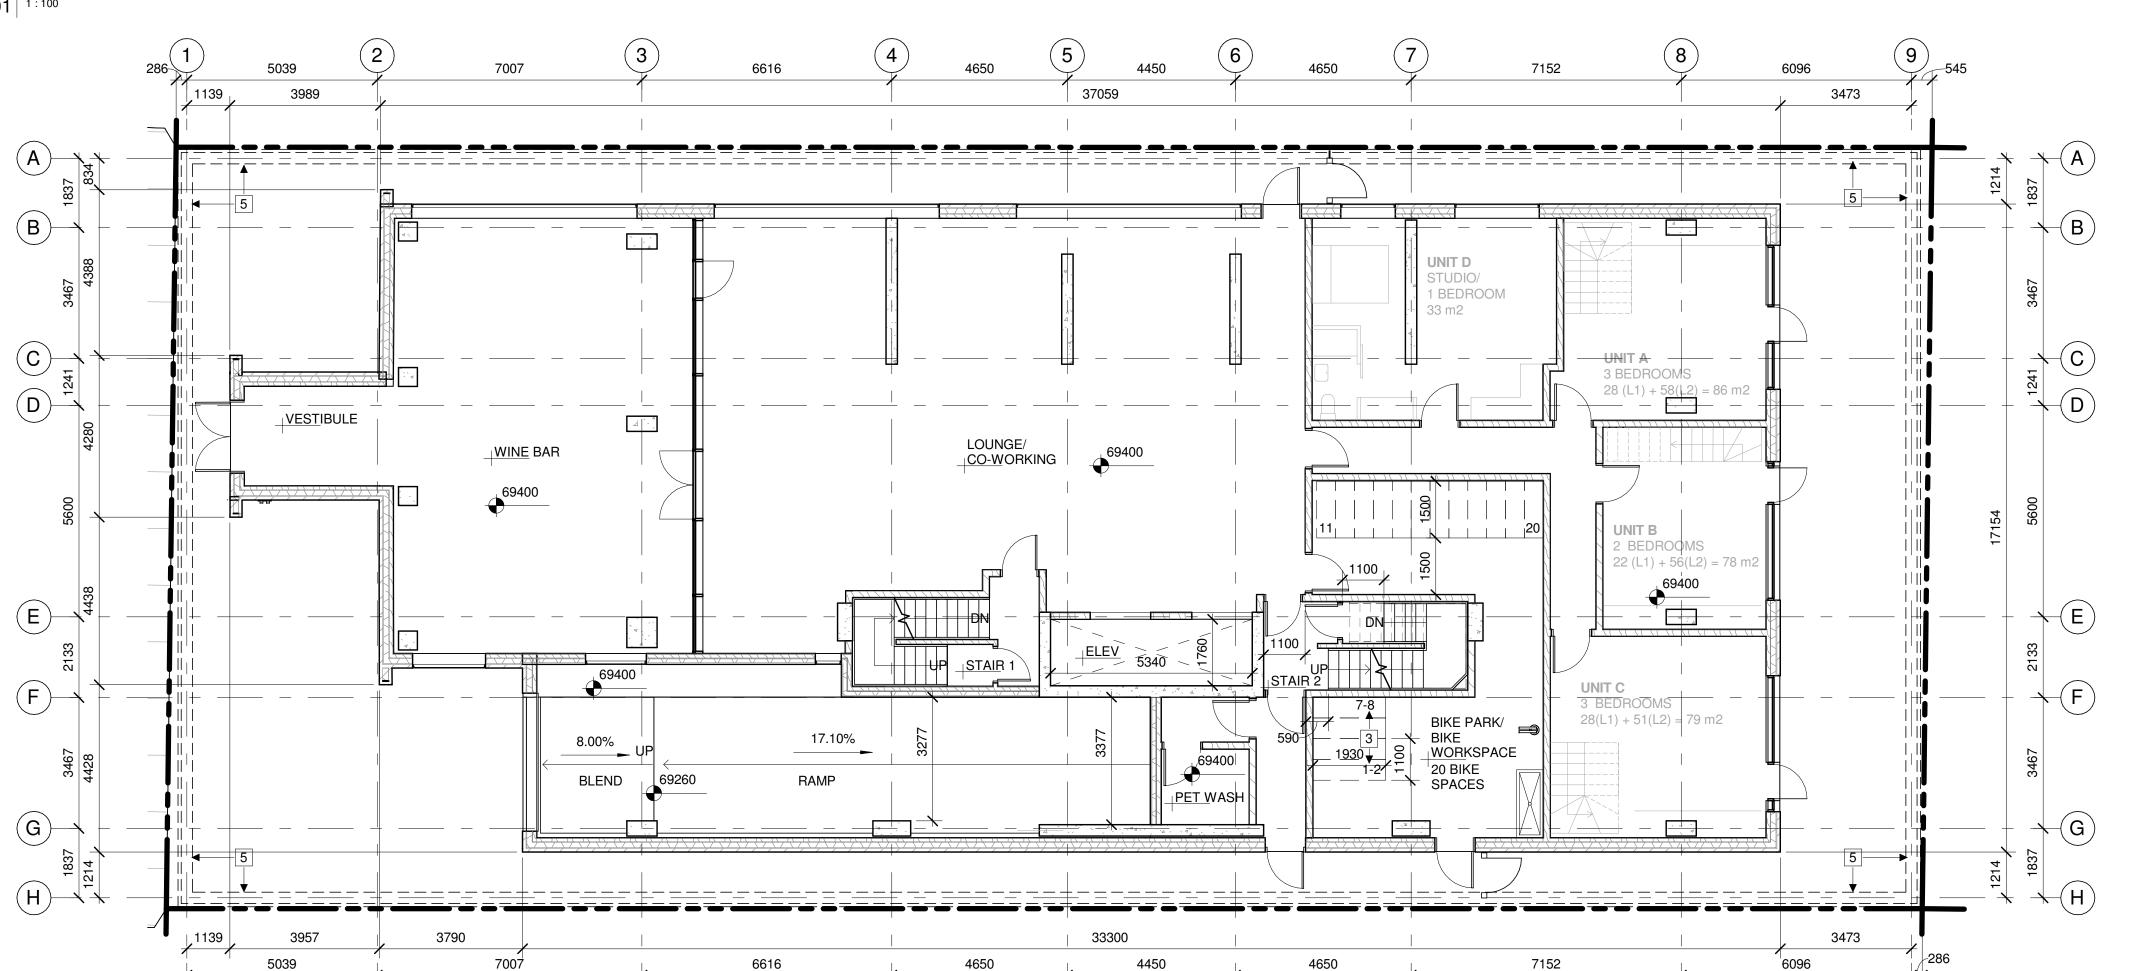
A200

DRAWING NO.



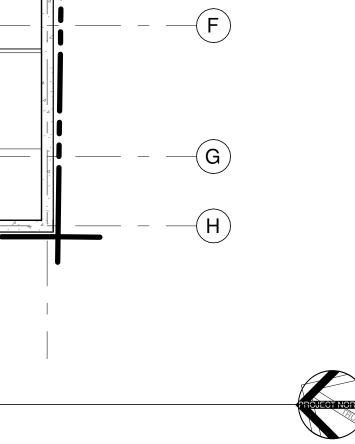

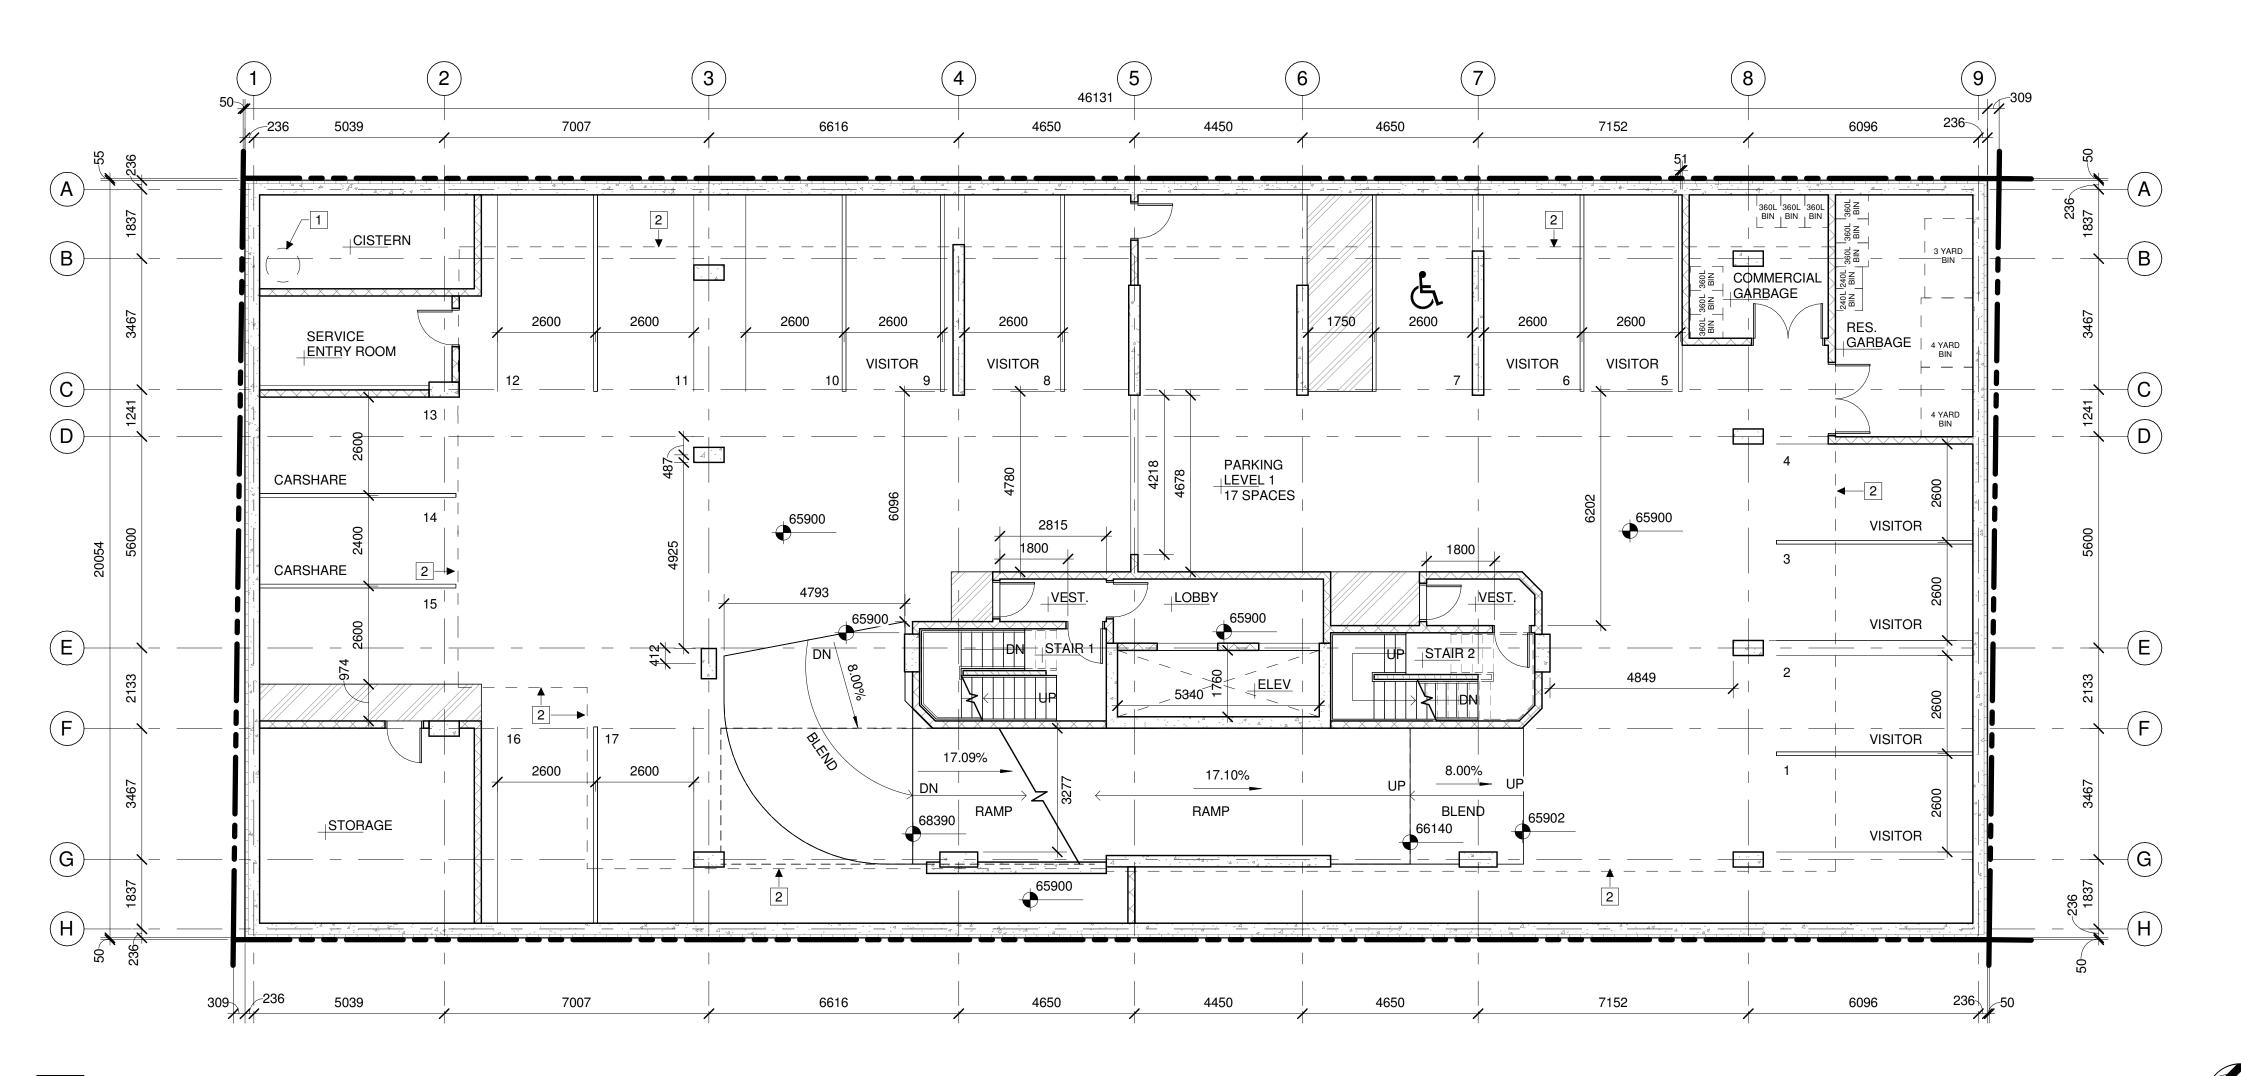1 LEVEL -1 PLAN A201 1:100



2 GROUND FLOOR REFERENCE PLAN

A201 1:100

- 2 EXTENT OF DROPPED SLAB ABOVE
- 3 DOUBLE TEAR BICYCLE STORAGE SPACES
- 4 EXIT ONLY
- 5 EXTENT OF FOUNDATION WALL BELOW



NOT IN CONTRACT

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4 2024.12.20 ISSUED FOR SPC AND REZONING COMMENT RESPONSE 01

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REV DATE ISSUE

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CLIENT



OTTAWA ONTARIO, CANADA

PROJECT

254 ARGYLE

254 Argyle Avenue, Ottawa, Ontario

TITLE

LEVEL -1 AND GROUND FLOOR PLANS


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IK / EF DH 1:100 DATE PRINTED: 2025-03-24 11:59:32 AM


DRAWING NO.

A201

REV

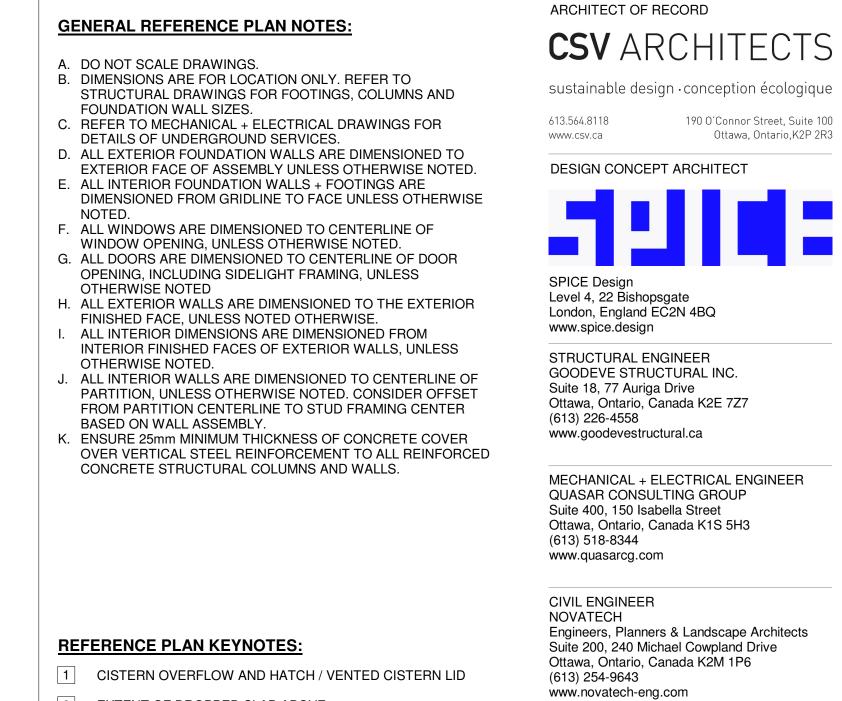

REFERENCE PLAN LEGEND:

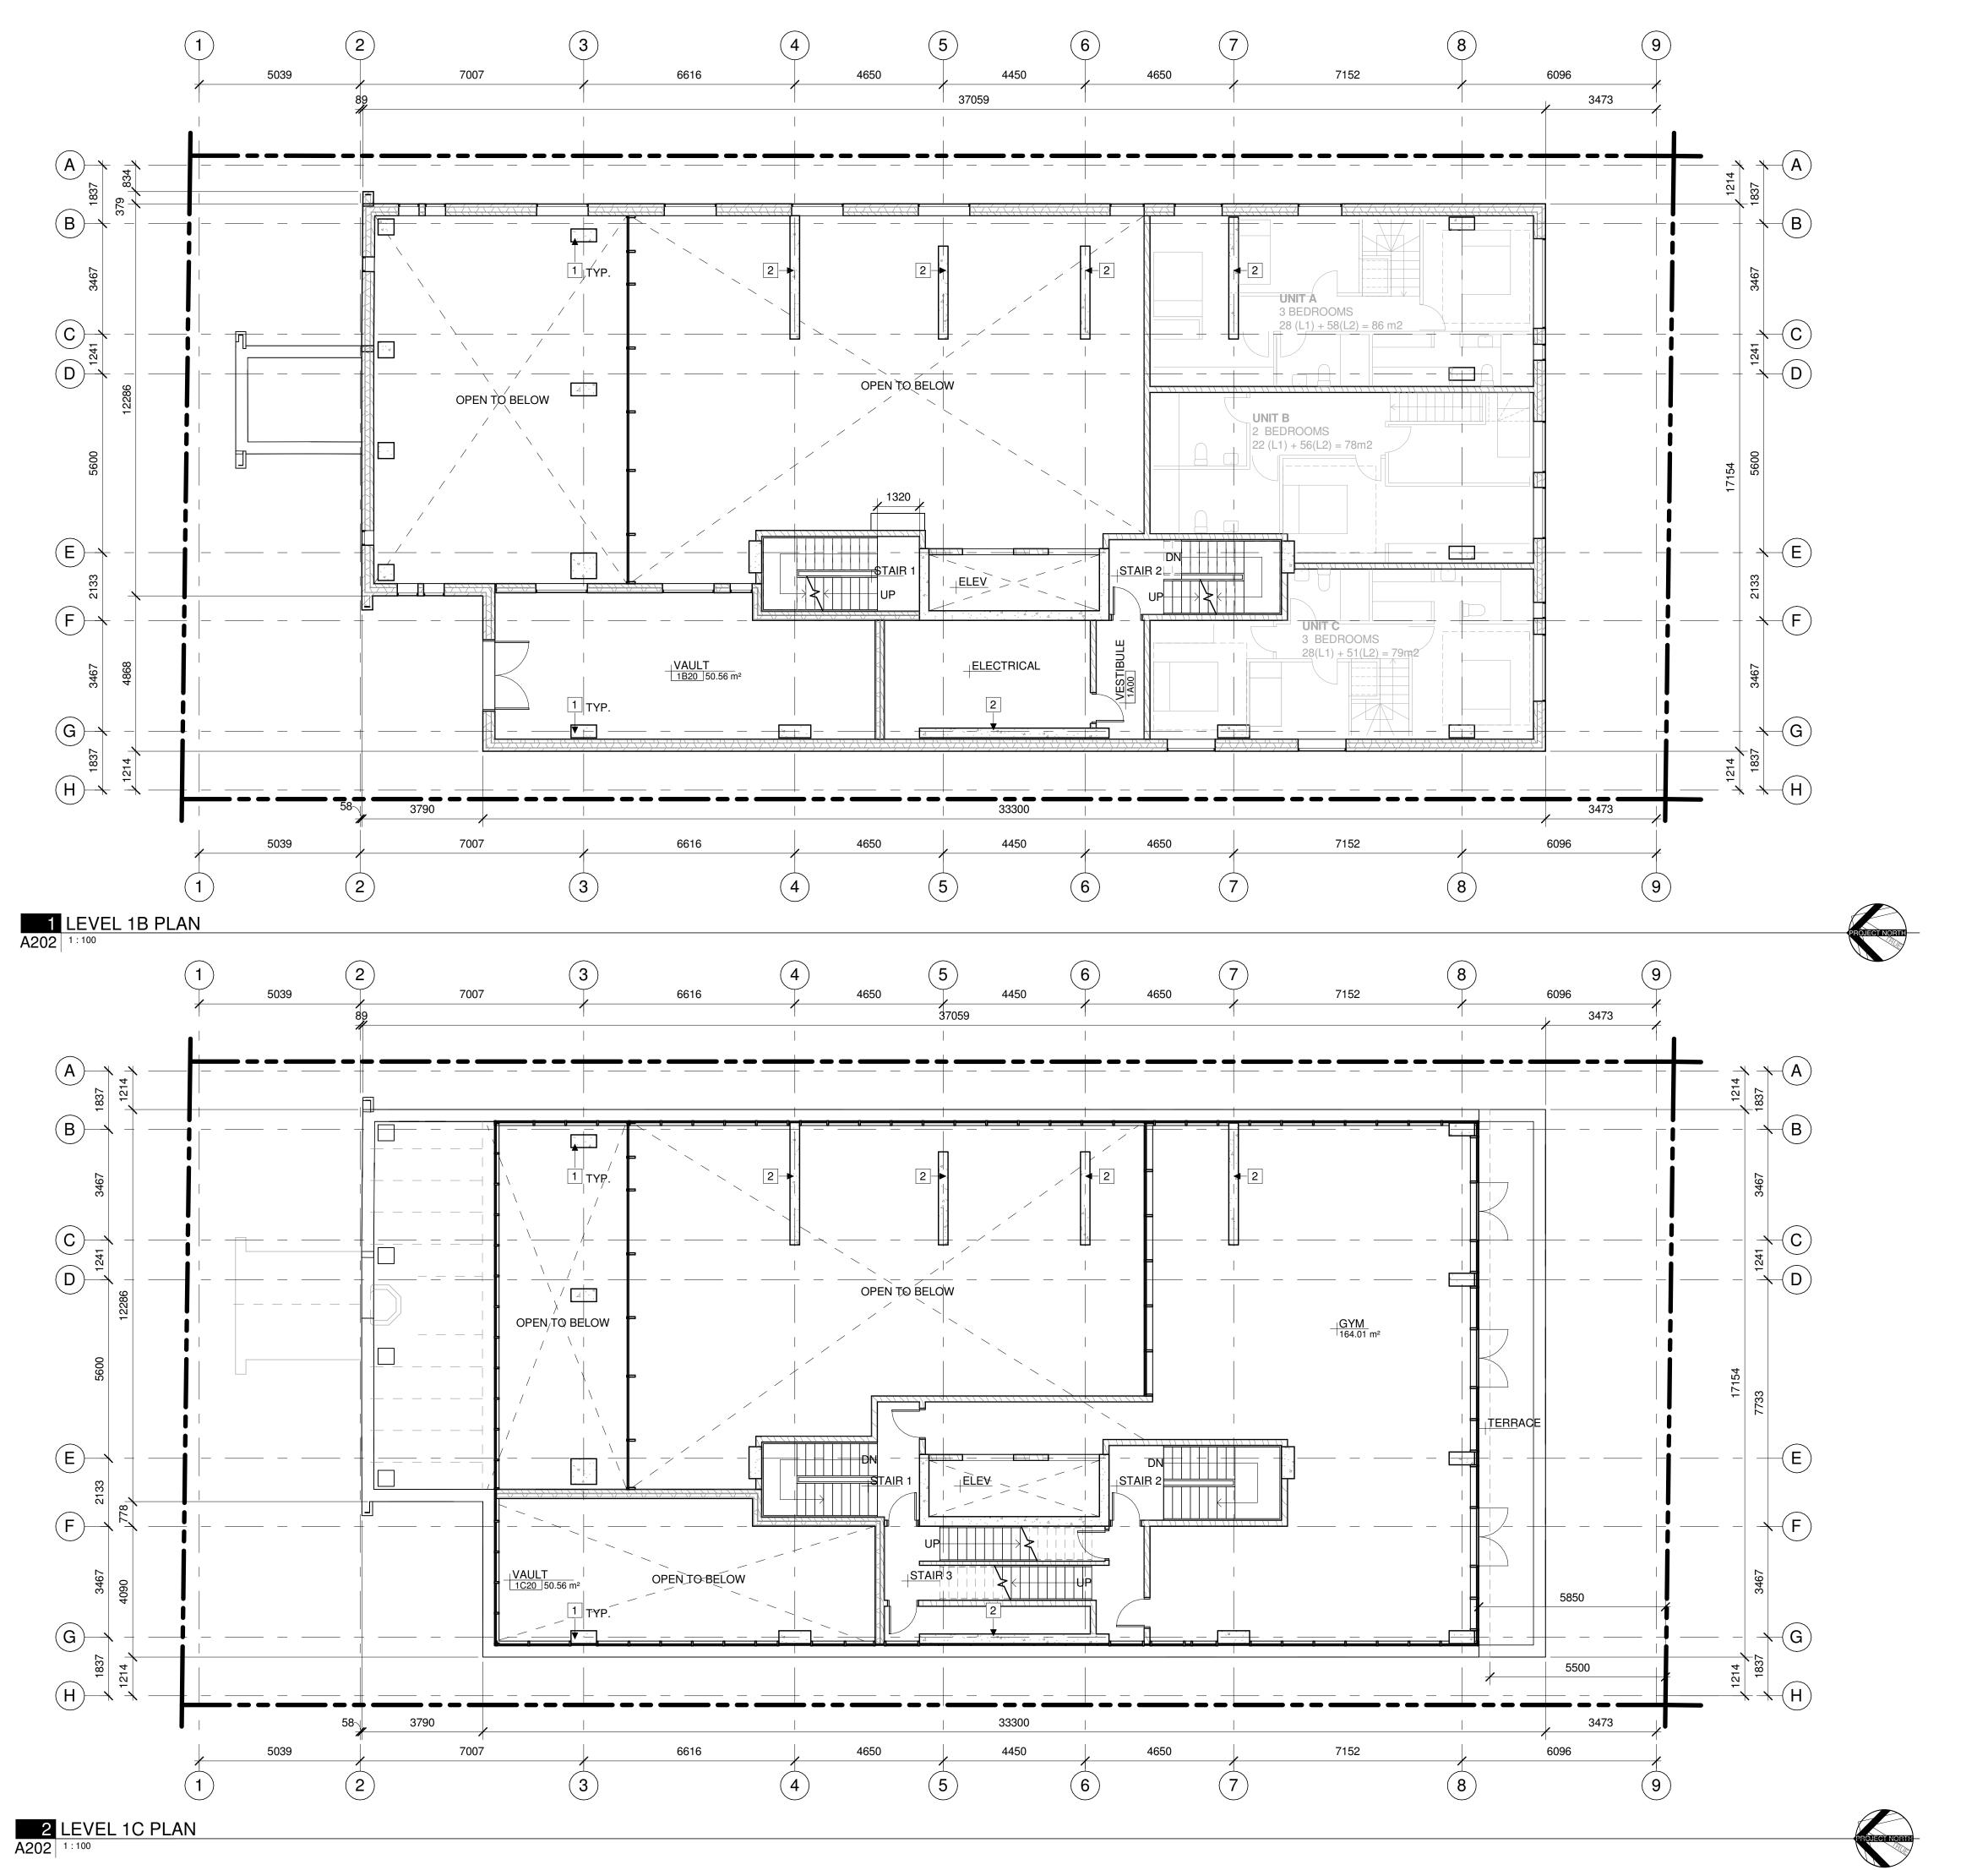

GENERAL REFERENCE PLAN NOTES:

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- C. REFER TO MECHANICAL + ELECTRICAL DRAWINGS FOR DETAILS OF UNDERGROUND SERVICES.
- D. ALL WINDOWS ARE DIMENSIONED TO CENTERLINE OF WINDOW OPENING, UNLESS OTHERWISE NOTED. E. ALL DOORS ARE DIMENSIONED TO CENTERLINE OF DOOR OPENING, INCLUDING SIDELIGHT FRAMING, UNLESS
- OTHERWISE NOTED F. ALL EXTERIOR WALLS ARE DIMENSIONED TO THE EXTERIOR
- FINISHED FACE, UNLESS NOTED OTHERWISE. G. ALL INTERIOR DIMENSIONS ARE DIMENSIONED FROM
- INTERIOR FINISHED FACES OF EXTERIOR WALLS, UNLESS OTHERWISE NOTED. H. ALL INTERIOR WALLS ARE DIMENSIONED TO CENTERLINE OF PARTITION, UNLESS OTHERWISE NOTED. CONSIDER OFFSET
- FROM PARTITION CENTERLINE TO STUD FRAMING CENTER BASED ON WALL ASSEMBLY. ENSURE 25mm MINIMUM THICKNESS OF CONCRETE COVER
- OVER VERTICAL STEEL REINFORCEMENT TO ALL REINFORCED CONCRETE STRUCTURAL COLUMNS AND WALLS.

REFERENCE PLAN KEYNOTES:

- 1 COLUMN PER STRUCTURAL
- 2 WALL PER STRUCTURAL

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ARCHITECT OF RECORD

DESIGN CONCEPT ARCHITECT

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REFERENCE PLAN LEGEND:

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OTTAWA ONTARIO, CANADA

PROJECT

254 ARGYLE

254 Argyle Avenue, Ottawa, Ontario


TITLE

LEVEL 1B AND LEVEL 1C PLANS

PROJECT NO: 2023-0250 DRAWN: IK / EF / RK APPROVED: DH 1:100 DATE PRINTED: 2025-03-20 9:35:07 AM

REV DRAWING NO.

A202

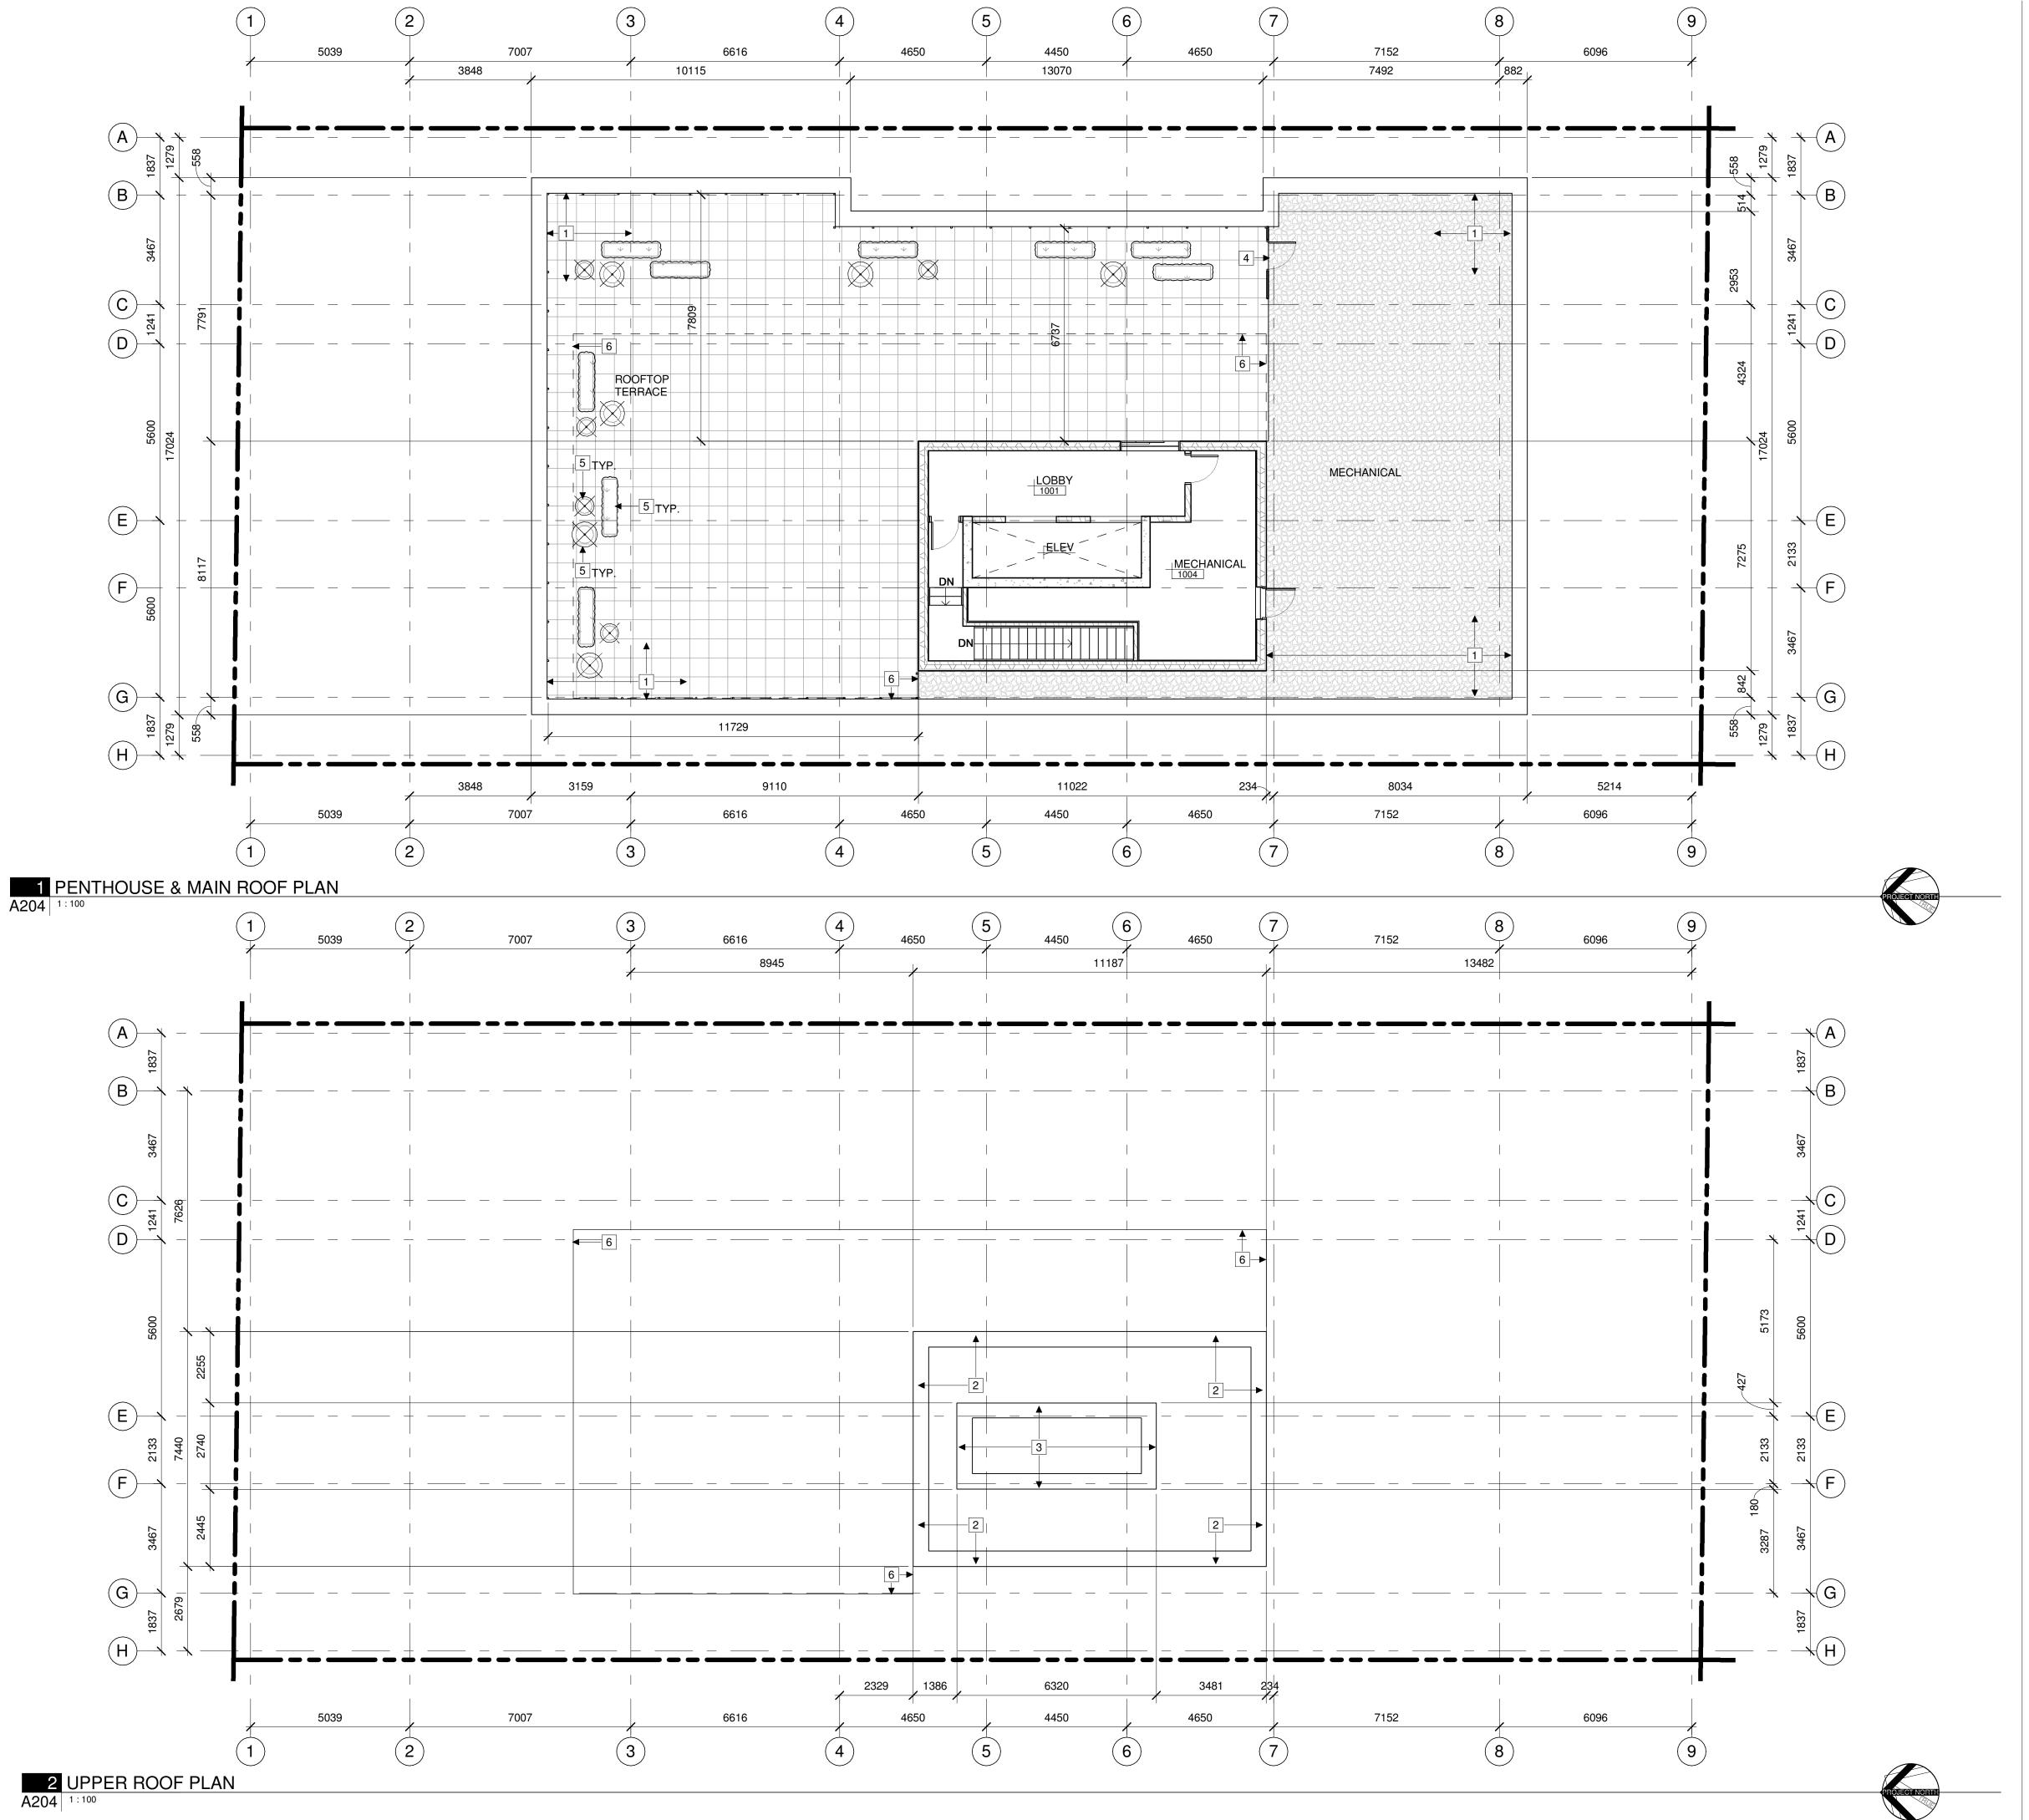

GENERAL REFERENCE PLAN NOTES:

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- C. REFER TO MECHANICAL + ELECTRICAL DRAWINGS FOR DETAILS OF UNDERGROUND SERVICES.
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- ENSURE 25mm MINIMUM THICKNESS OF CONCRETE COVER OVER VERTICAL STEEL REINFORCEMENT TO ALL REINFORCED CONCRETE STRUCTURAL COLUMNS AND WALLS.

REFERENCE PLAN KEYNOTES:

- 1 LOWER LEVEL ROOF
- 2 UPPER ROOF
- 3 ELVATOR SHAFT ROOF
- 4 ROOF SCREEN AND GATE
- 5 SHRUBS IN PLANTER
- 6 EXTENT OF PERGOLA

REFERENCE PLAN LEGEND:



NOT IN CONTRACT

ARCHITECT OF RECORD

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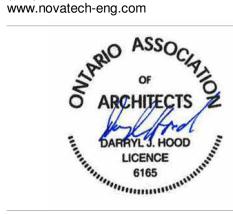
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- 4 2024.12.13 ISSUED FOR SPC AND REZONING
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AND APPLICABLE MUNICIPAL REGULATIONS. CLIENT



OTTAWA ONTARIO, CANADA

PROJECT

254 ARGYLE

254 Argyle Avenue, Ottawa, Ontario

TITLE

ROOFS & PENTHOUSE PLANS

PROJECT NO: 2023-0250 DRAWN: IK / EF / RK APPROVED: DH 1:100 DATE PRINTED: 12/13/2024 2:09:08 PM

DRAWING NO.

A204