1815 MONTREAL ROAD

1815 MONTREAL ROAD

ISSUED FOR SITE PLAN CONTROL 3: 2024.01.05

COVER PAGE SITE PLAN SITE PLAN CONTEXT SITE ACCESS/ TURNING TEMPLATES PARKING LEVEL 2 PLAN PARKING LEVEL 1 PLAN 1st FLOOR PLAN 2nd FLOOR PLAN 3rd FLOOR PLAN 4th FLOOR PLAN A.215 5th FLOOR PLAN 6th FLOOR PLAN 7th FLOOR PLAN 8th FLOOR PLAN 9th FLOOR PLAN A.219a PENTHOUS PLAN SOUTH ELEVATION **EAST ELEVATION** NORTH ELEVATION WEST ELEVATION

STREETSCAPE SECTIONS



LOCATION PLAN



CSV ARCHITECTS

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7 2024.01.05 ISSUED FOR SITE PLAN CONTROL 3 6 2023.10.10 ISSUED FOR SITE PLAN CONTROL 2 5 2023 05 26 ISSUED FOR SITE PLAN CONTROL 2 2023 04 18 ISSUED FOR COORDINATION

1 2023 04 03 ISSUED FOR REVIEW
REV DATE ISSUE

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CLIENT

OTTAWA ONTARIO, CANADA

PROJECT

1815 MONTREAL ROAD

1815 MONTREAL ROAD

TITLE

COVER PAGE

PROJECT NO: 222450

DRAWN: R.R.

APPROVED: D.H.


SCALE: 1:100

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A000

7



UNIT MIX

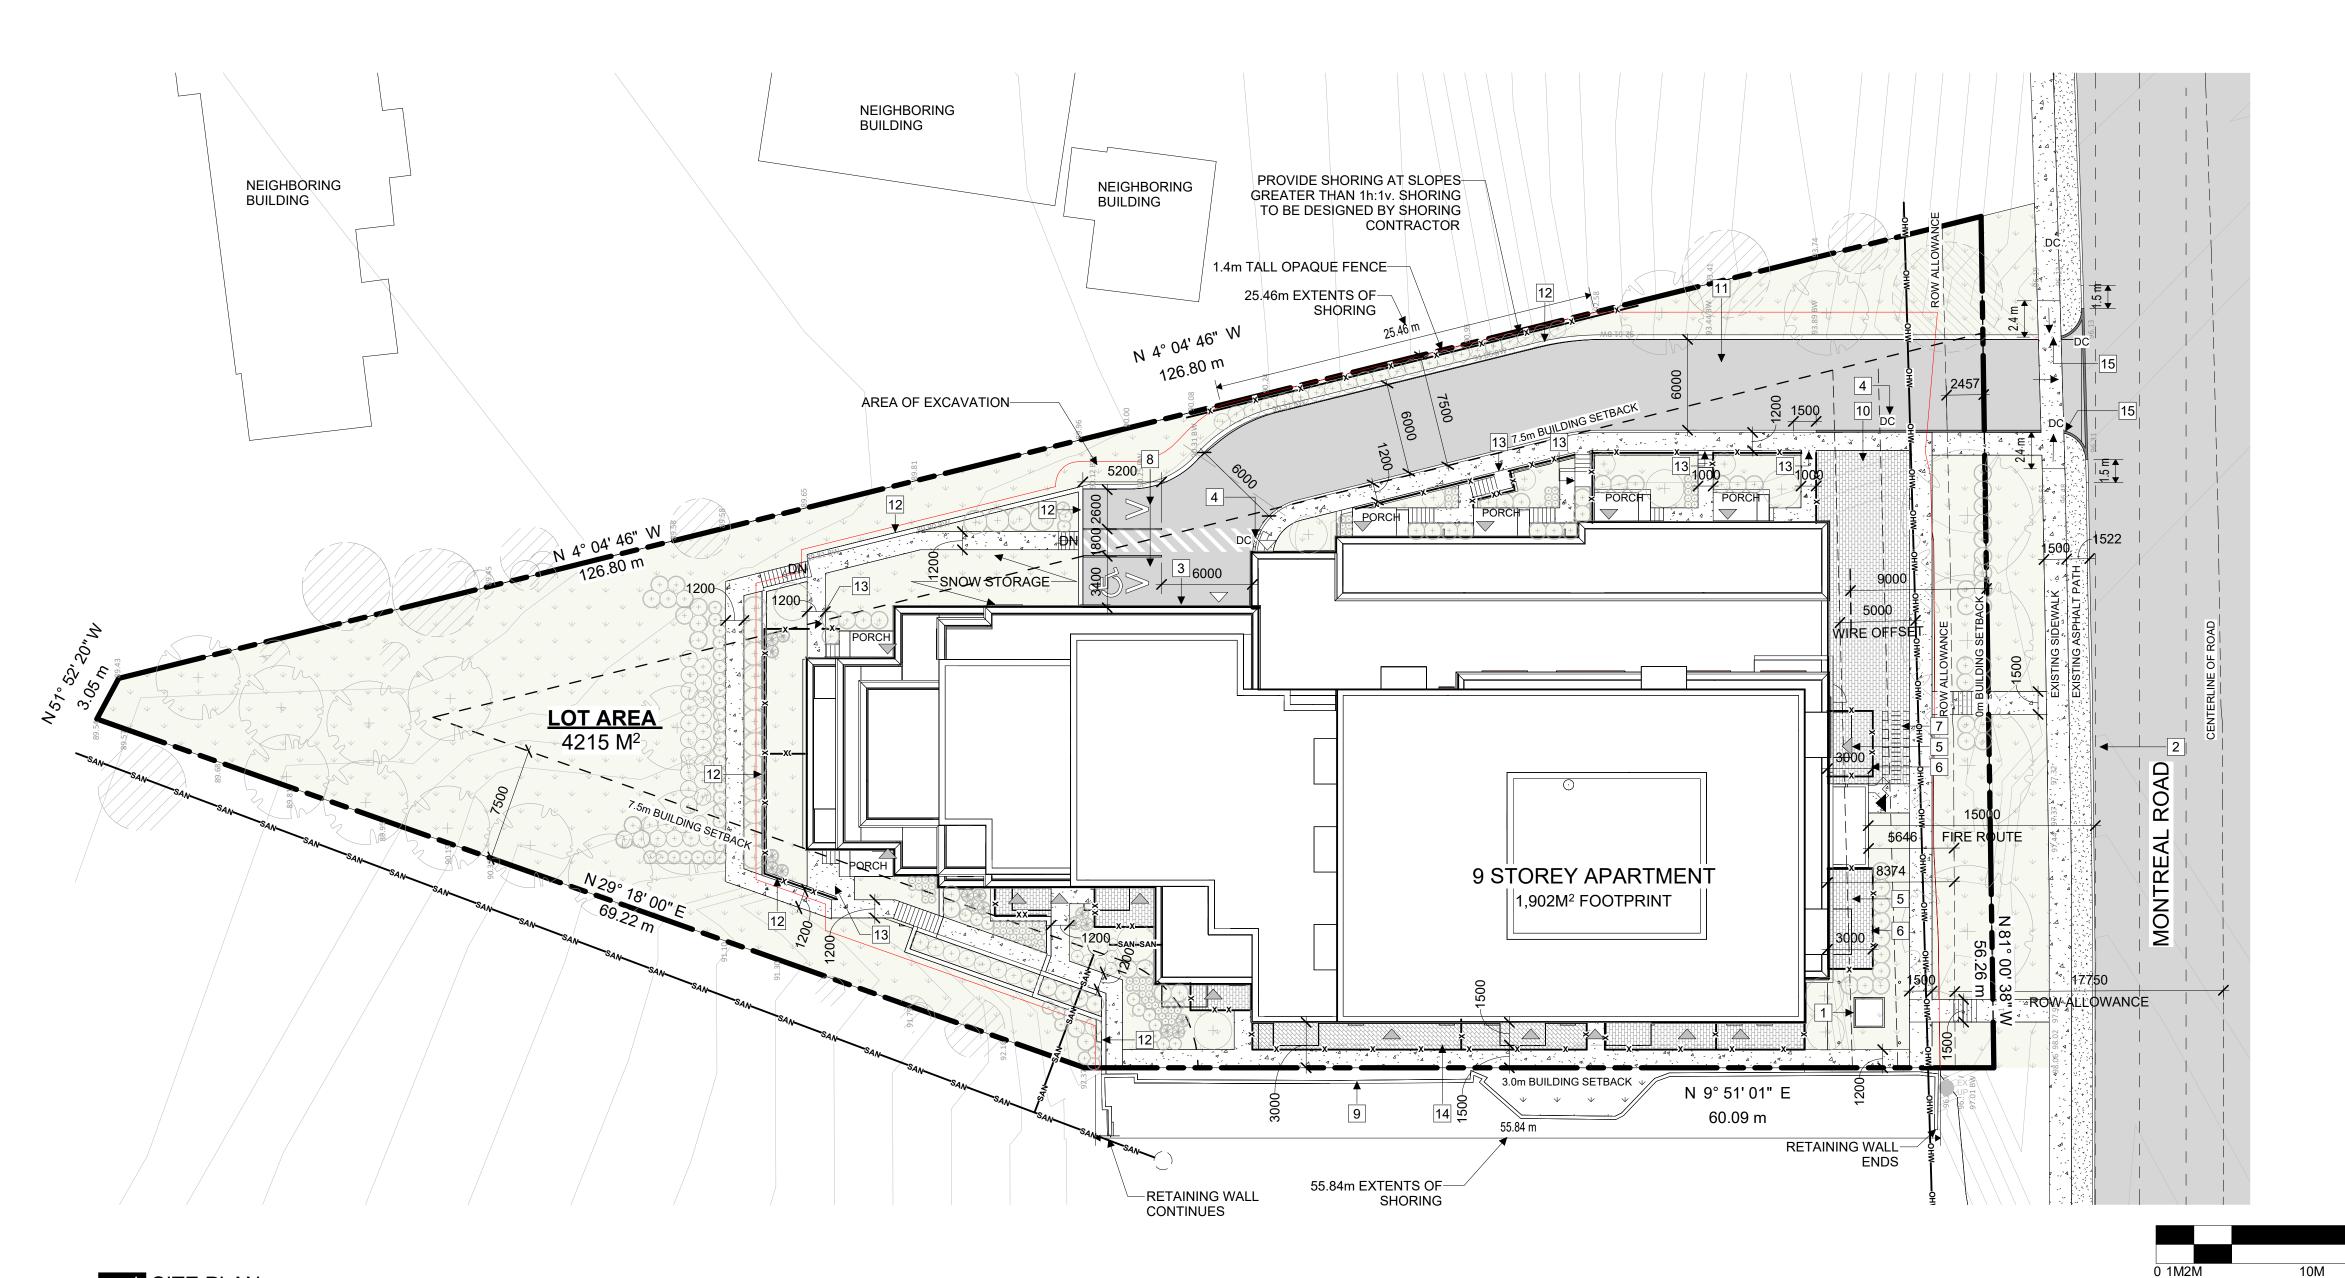1 BED APT

2 BED APT

3 BED APT

GFU*

BACH

TOTAL

DENSITY

SITE AREA (m²)

SITE AREA (Ha)

DENSITY du/Ha

*GROUND FACING UNIT

13

130

4352

0.4352

299

1 SITE PLAN **LEGAL DESCRIPTION:** LOT 141 REGISTERED PLAN 652 CITY OF OTTAWA

REFERENCE SURVEY: BASED ON INFORMATION FROM A SURVEY PREPARED BY R.P., J.D. BARNES LIMITED. DATED: 3RD DAY OF OCTOBER, 2022. **MUNICIPAL ADDRESS:** 1815 MONTREAL ROAD, CITY OF OTTAWA, ON **DEVELOPMENT INFORMATION:** SITE AREA 4,215 m² $1,902 \, \text{m}^2$ = 45%

BUILDING FOOTPRINT LOT COVERAGE GROSS FLOOR AREA 10,918 m² (1st FLOOR - 9th FLOOR) **BUILDING HEIGHT** +/-31m Proposed - AM10 ZONE Current - R1AA AREA C "URBAN AND GREEN BELT SCHEDULE 1:

AREA" SCHEDULE 1A: AREA C "SUBURBAN" DISTANCE EXCEEDS 600 m SCHEDULE 2:

ZONING PROVISION REQUIRED PROVIDED MIN. LOT WIDTH NO MINIMUM 54.9m AFTER ROW MIN. LOT AREA MIN. FRONT YARD SETBACK 3m 5.6m **ROW DEDICATION** 17.75m FROM 2.4m REQUIREMENT CENTERLINE (2.39m) HYDRO SETBACK 5m 5m MIN. REAR YARD SETBACK 7.5m 45.5m MIN. INTERIOR SIDE YARD 7.5m 7.5m ABUTTING A RESIDENTIAL ZONE MIN. INTERIOR SIDE YARD ABUTTING AN AM ZONE OM 3.0M Maximum Up to 20 meters Building Height | from a R1, R2, R3 Zone (height is from 31.28m average grade) 20m to 30m from 20m R1-R3 Zone 30m from 30 m, max. 9

East:24.8m West: 31.28m storeys. property line abutting R1-R4 Zone 30m, max. 9 In all other cases

Landscaped Abutting a Min 3 m; reduced to 1.4m opaque residential zone 1 m where 1.4 m high opaque fence | fence is provided. is provided In all other cases No minimum TOTAL LANDSCAPED AREA 1,916M²

Balconies= 805.7 6m² per dwelling unit. Amenity NO MINIMUM 4215m² AFTER ROW Requirements | Min 50% communal, aggregated into areas of 54m² and where more than one Communal aggregated area is provided, at least one Rooftop Terrace must be minimum 54m² = 780 m² (2nd and 7th floor): 135 m² (Can count towards landscape Outdoor Private Patio (ground floor): 127 m² Interior amenity space = 210.2 m^2 Rear Yard Area: 770.2 m² Total amenity area= 2048.1 m² PARKING QUEING + LOADING <u>REQUIRED</u> **PROVIDED** RESIDENTIAL SPACES 156 89 TOTAL (18) 4.6m x 2.4m (71) 6m x 2.6m VISITOR SPACES 18 TOTAL (16) 5.2m x 2.6m (2) BF 6m x 3.40m C/W 1.5m Transfer space Total: 66

REQUIRED

<u>PROVIDED</u>

Residential: 12 @P2

Residential: 19 @P1

Residential: 27 @L1

Visitors: 8 Outside

BICYCLE PARKING All spaces are 1.8m x 0.6m

ZONING PROVISION

If outdoor: Located within 9m from lot line | Pickup staging at Garbage abutting a public street, 3m from any other interlock paver lot line, and screened from view with an area greater than Collection Location opaque screen of minimum height of 2m. 9m away from lot line abutting a public street.

SITE PLAN GENERAL NOTES:

- 1. ALL GENERAL SITE INFORMATION AND CONDITIONS COMPILED FROM EXISTING PLANS AND SURVEYS
- 2. DO NOT SCALE THIS DRAWING 3. REPORT ANY DISCREPANCIES PRIOR TO COMMENCING WORK. NO RESPONSIBILITY IS BORN BY THE CONSULTANT FOR
- **UNKNOWN SUBSURFACE CONDITIONS** 4. CONTRACTOR TO CHECK AND VERIFY ALL DIMENSIONS ON SITE AND REPORT ANY ERRORS AND/OR OMISSIONS TO THE
- CONSULTANT 5. REINSTATE ALL AREAS AND ITEMS DAMAGED AS A RESULT OF CONSTRUCTION ACTIVITIES TO THE SATISFACTION OF THE
- CONSULTANT 6. CONTRACTOR TO LAYOUT PLANTING BEDS, PATHWAYS ETC. TO APPROVAL OF CONSULTANT PRIOR TO ANY JOB

CONFIRMATION OF UTILITY EXISTENCE AND LOCATION PRIOR

- EXCAVATION 7. THE ACCURACY OF THE POSITION OF UTILITIES IS NOT
- GUARANTEED CONTRACTOR TO VERIFY PRIOR TO **EXCAVATION** 8. INDIVIDUAL UTILITY COMPANY MUST BE CONTACTED FOR
- 9. ALL DISTURBED AREAS TO BE RESTORED TO ORIGINAL CONDITION OR BETTER UNLESS OTHERWISE NOTED

SITE PLAN KEYNOTES:

- 1 HYDRO-TRANSFORMER
- 2 6m WIDE FIRE TRUCK ACCESS
- 3 UNDERGROUND PARKING ACCESS RAMP
- 4 DEPRESSED CURB
- 5 PRIVATE PATIO
- 6 PRIVACY FENCE
- 7 8 X VISITOR BIKE RACKS 1800x600 TYP
- 8 VISITOR PARKING SPACE
- 9 EXISTING RETAINING WALL
- 10 INTERLOCK AREA/ GARBAGE PICKUP
- 11 NEW ASPHALT LANEWAY
- 12 RETAINING WALL
- 13 GATE
- 14 BALCONIES ABOVE
- 15 ACCESS TO SITE DESIGNED AS PER CITY OF OTTAWA "CURB RETURN ENTRANCE" DWG. NO. SC7.1 "CURB RETURN AT A PRIVATE OR COMMERCIAL ENTRANCE WITH **BOULEVARD - UNSIGNALIZED INTERSECTION"**

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2 2023 04 18 ISSUED FOR COORDINATION 1 2023 04 03 ISSUED FOR REVIEW REV DATE ISSUE

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OTTAWA

CLIENT

△ OTHER ENTRANCES / EXIT

CONCRETE SIDEWALK

PATIO PAVER TYPE

EXISTING BUILDING

ASPHALT PAVING

PARKLAND AREA

NEW GRASS

▲ BUILDING MAIN ENTRANCE

PROPERTY LINE

SITE PLAN LEGEND:

-x-x- FENCE

-onw-onw- EXISTING OVERHEAD WIRE PERIMETER OF EXCAVATION

- FIRE HYDRANT

FIRE HYDRANT EXISTING UTILITY POLE EXISTING

SIAMESE CONNECTION

DROPPED CURB SIGN

ONTARIO, CANADA PROJECT

1815 MONTREAL ROAD

1815 MONTREAL ROAD


SITE PLAN

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CLIENT

OTTAWA ONTARIO, CANADA

PROJECT

1815 MONTREAL ROAD

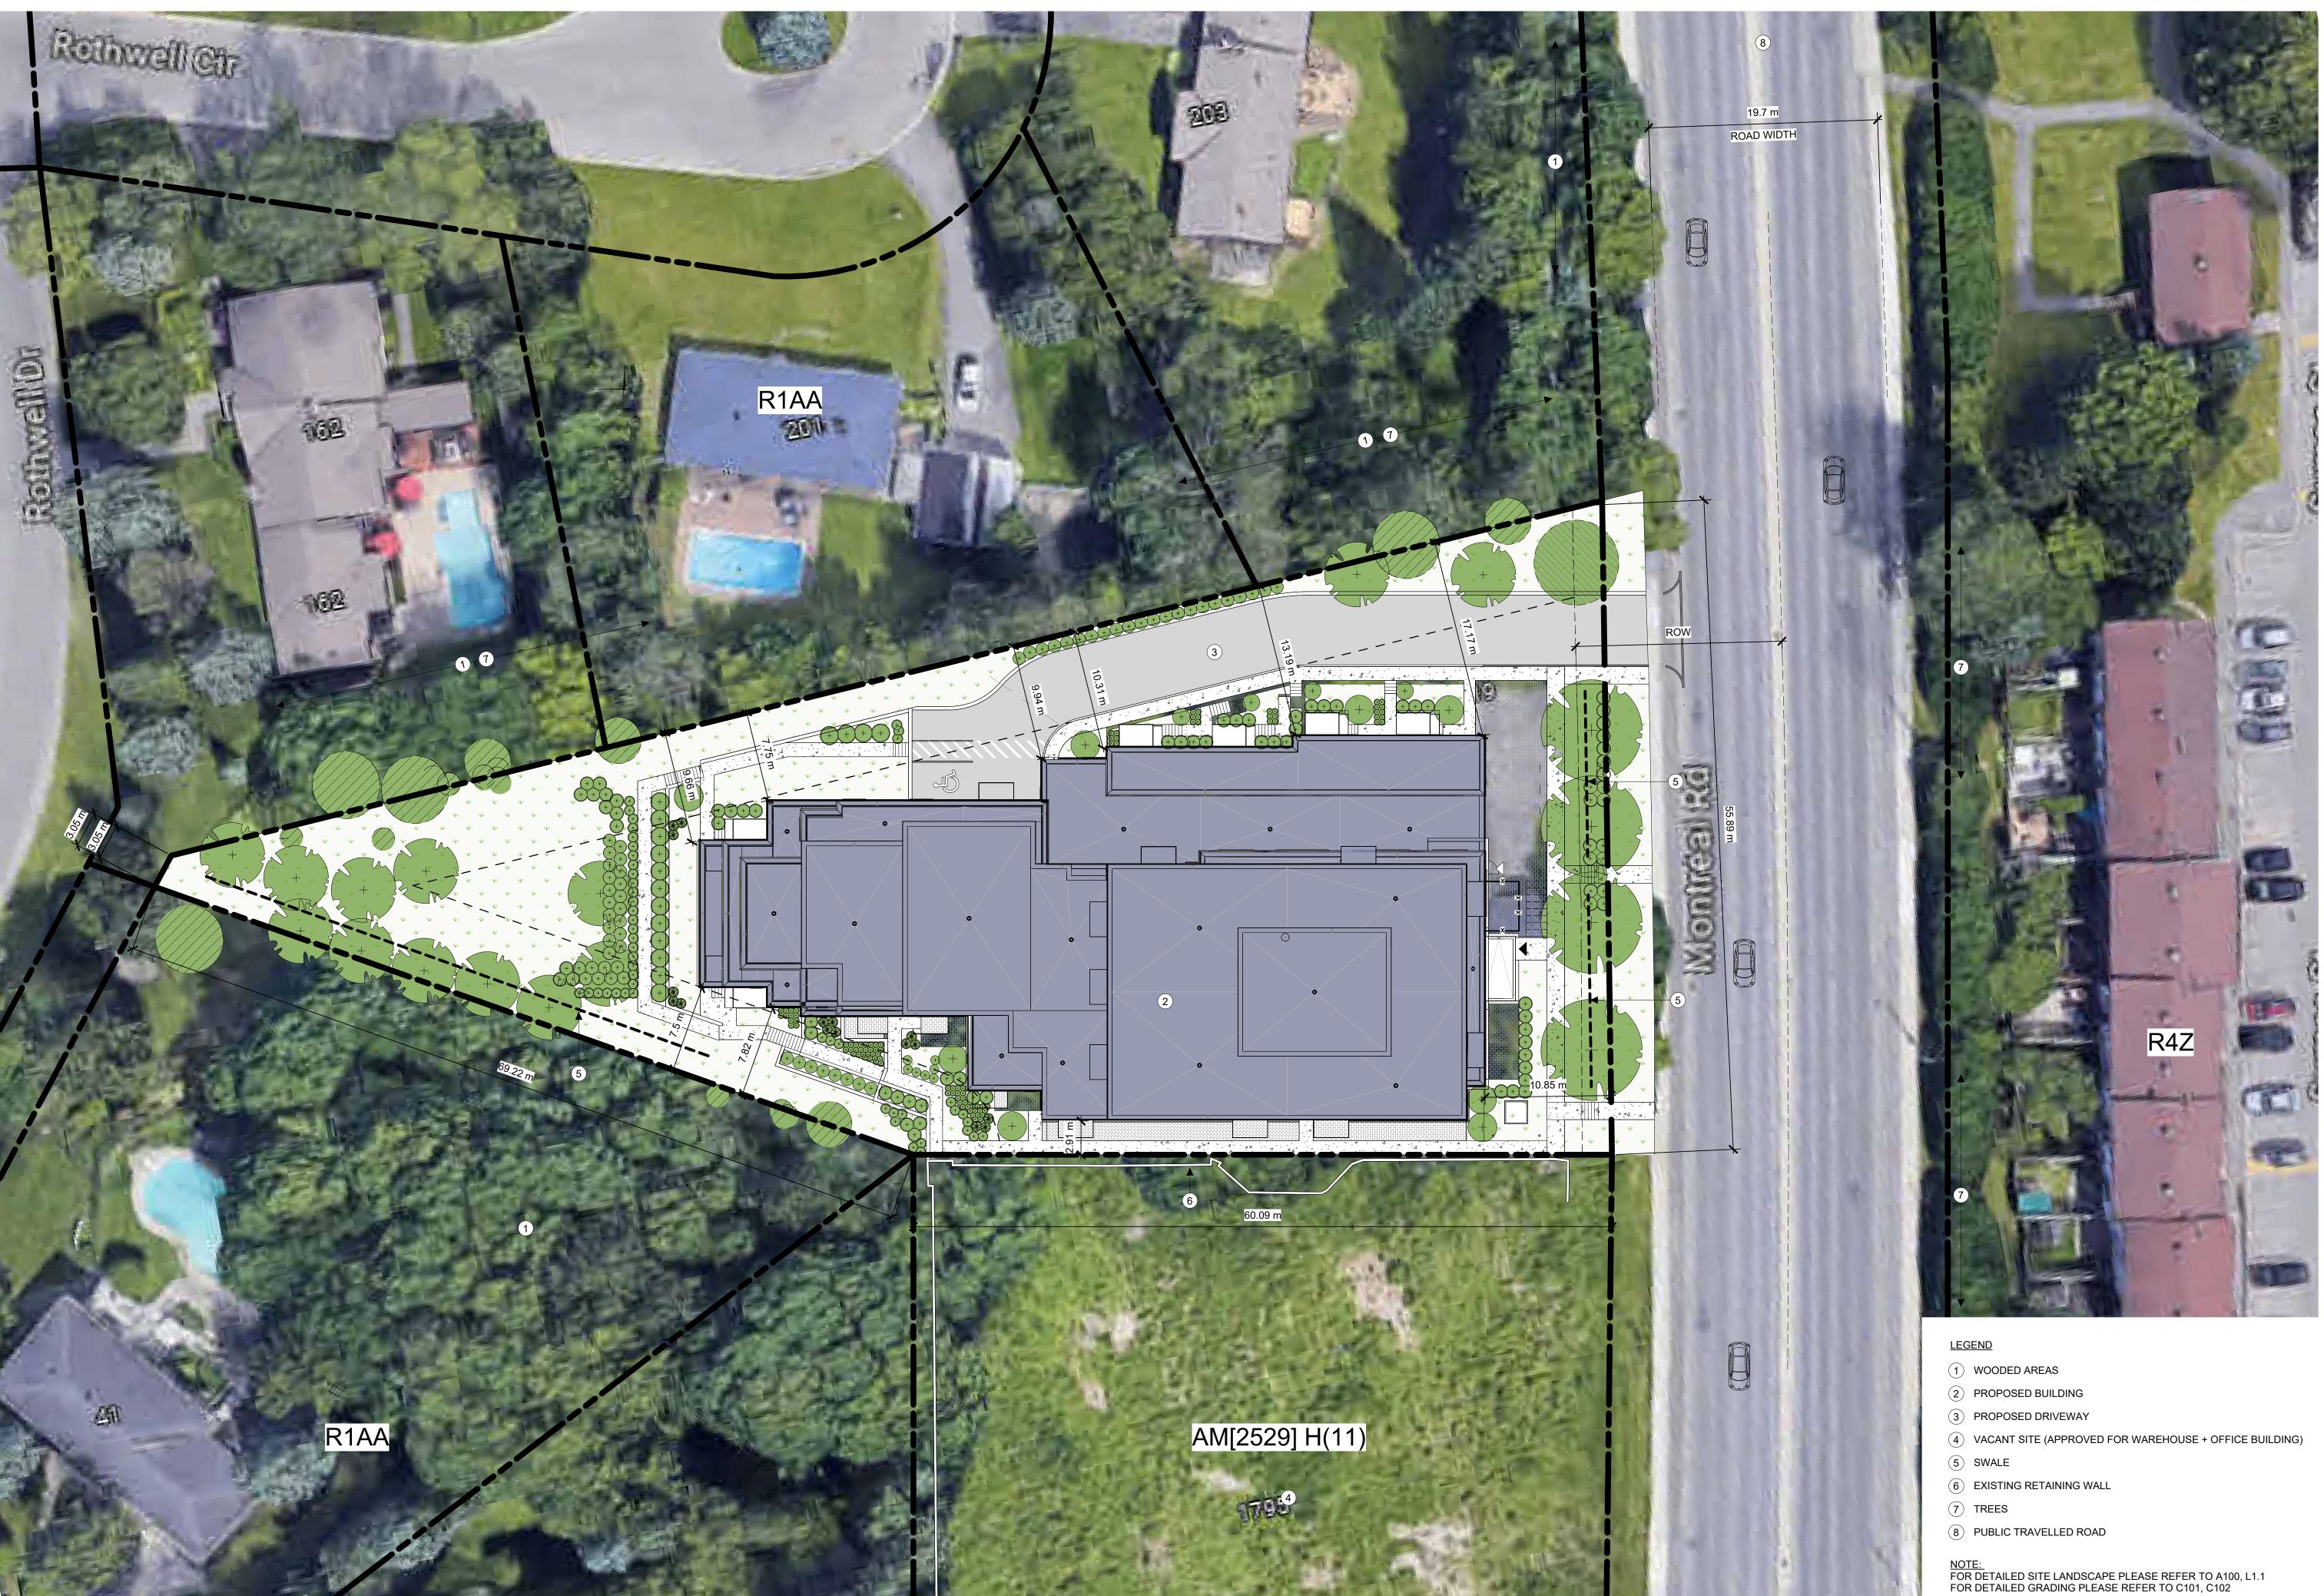1815 MONTREAL ROAD

TLE

SITE PLAN CONTEXT

PROJECT NO: 222450
DRAWN: R.R.
APPROVED: D.H.


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P - Passenger Car

Passenger Car
Overall Length 5.600m
Overall Width 2.000m
Overall Body Height 1.555m
Min Body Ground Clearance 0.340m
Track Width 2.000m
Lock-to-lock time 4.00s
Curb to Curb Turning Radius 6.300m



Passenger Car
Overall Length 5.600m
Overall Width 2.000m
Overall Body Height 1.555m
Min Body Ground Clearance 0.340m
Track Width 2.000m
Lock-to-lock time 4.00s
Curb to Curb Turning Radius 6.300m

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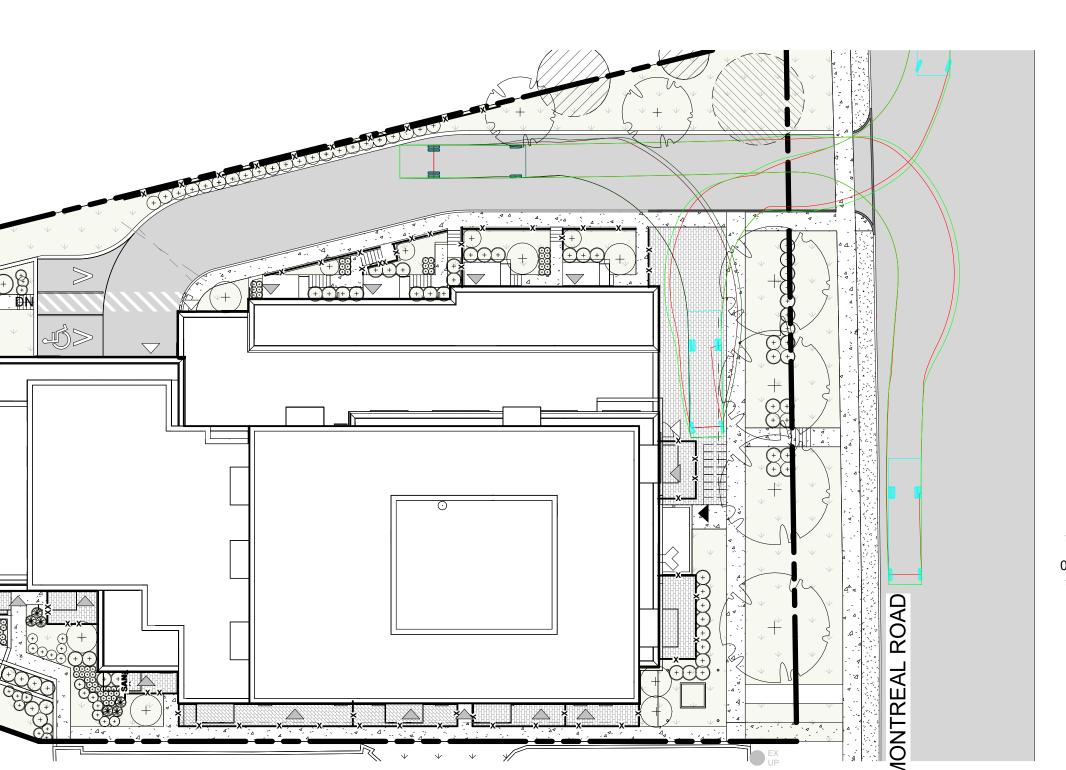
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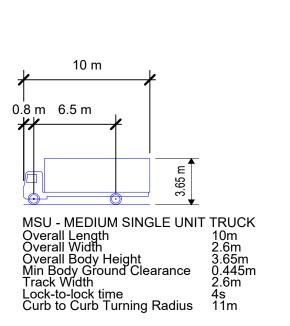
1 TURNING TEMPLATE - Car Entering
A102 1:300

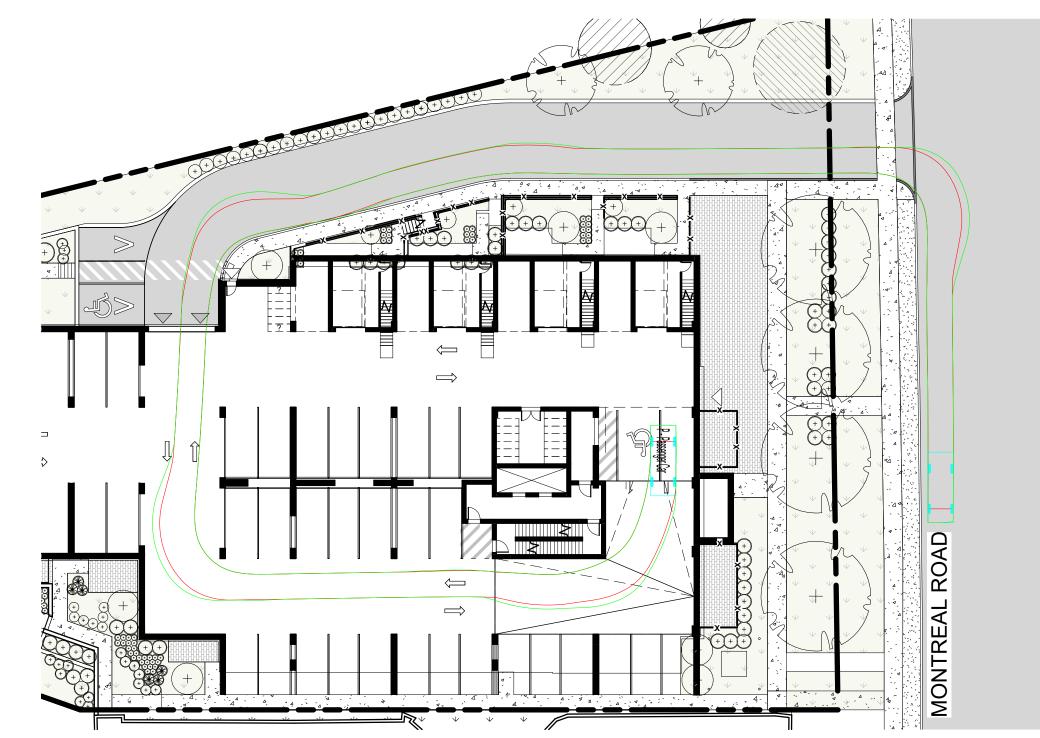
3 TURNING TEMPLATE - Garbage


A102 1:300 TURNING TEMPLATE - Car Exiting

4 TURNING TEMPLATE - U-Haul A102 1:300





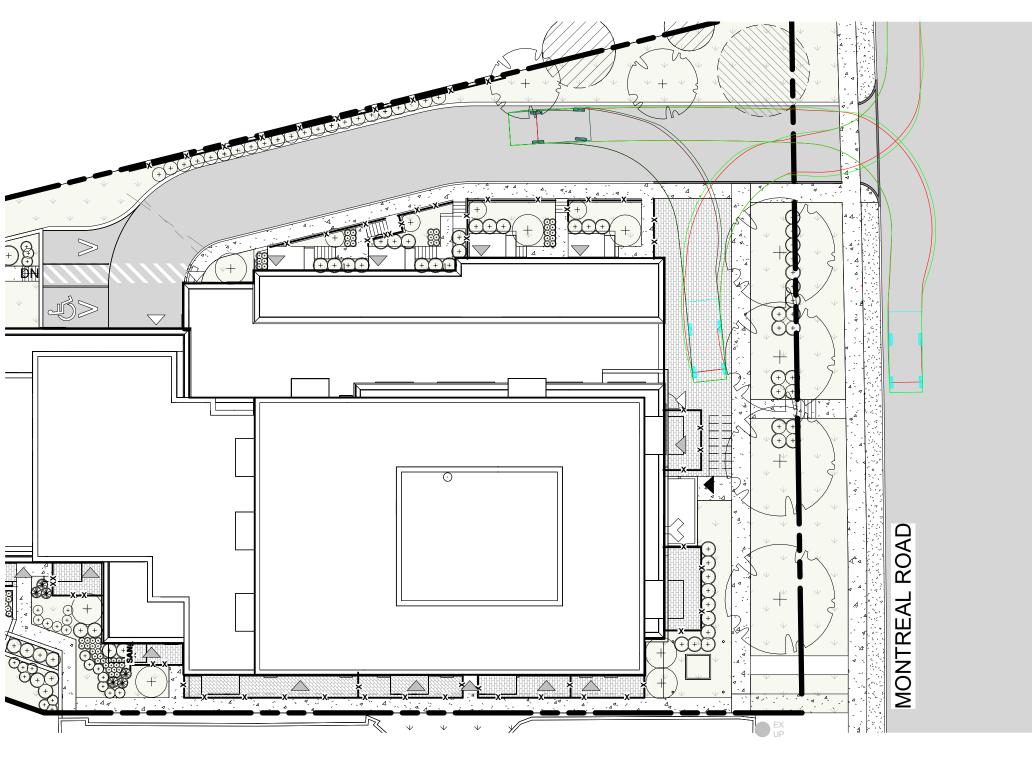

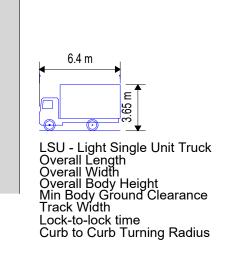

6.400m 2.600m 3.650m 0.445m 2.600m 4.00s 6.300m

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PROJECT

1815 MONTREAL ROAD

1815 MONTREAL ROAD

SITE ACCESS/ **TURNING TEMPLATES**


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DRAWING NO.

A102

Resident	
17	COMPACT
72	NORMAL
Visitor	
2	BF PARKING
16	NORMAL

Bike Parking 66

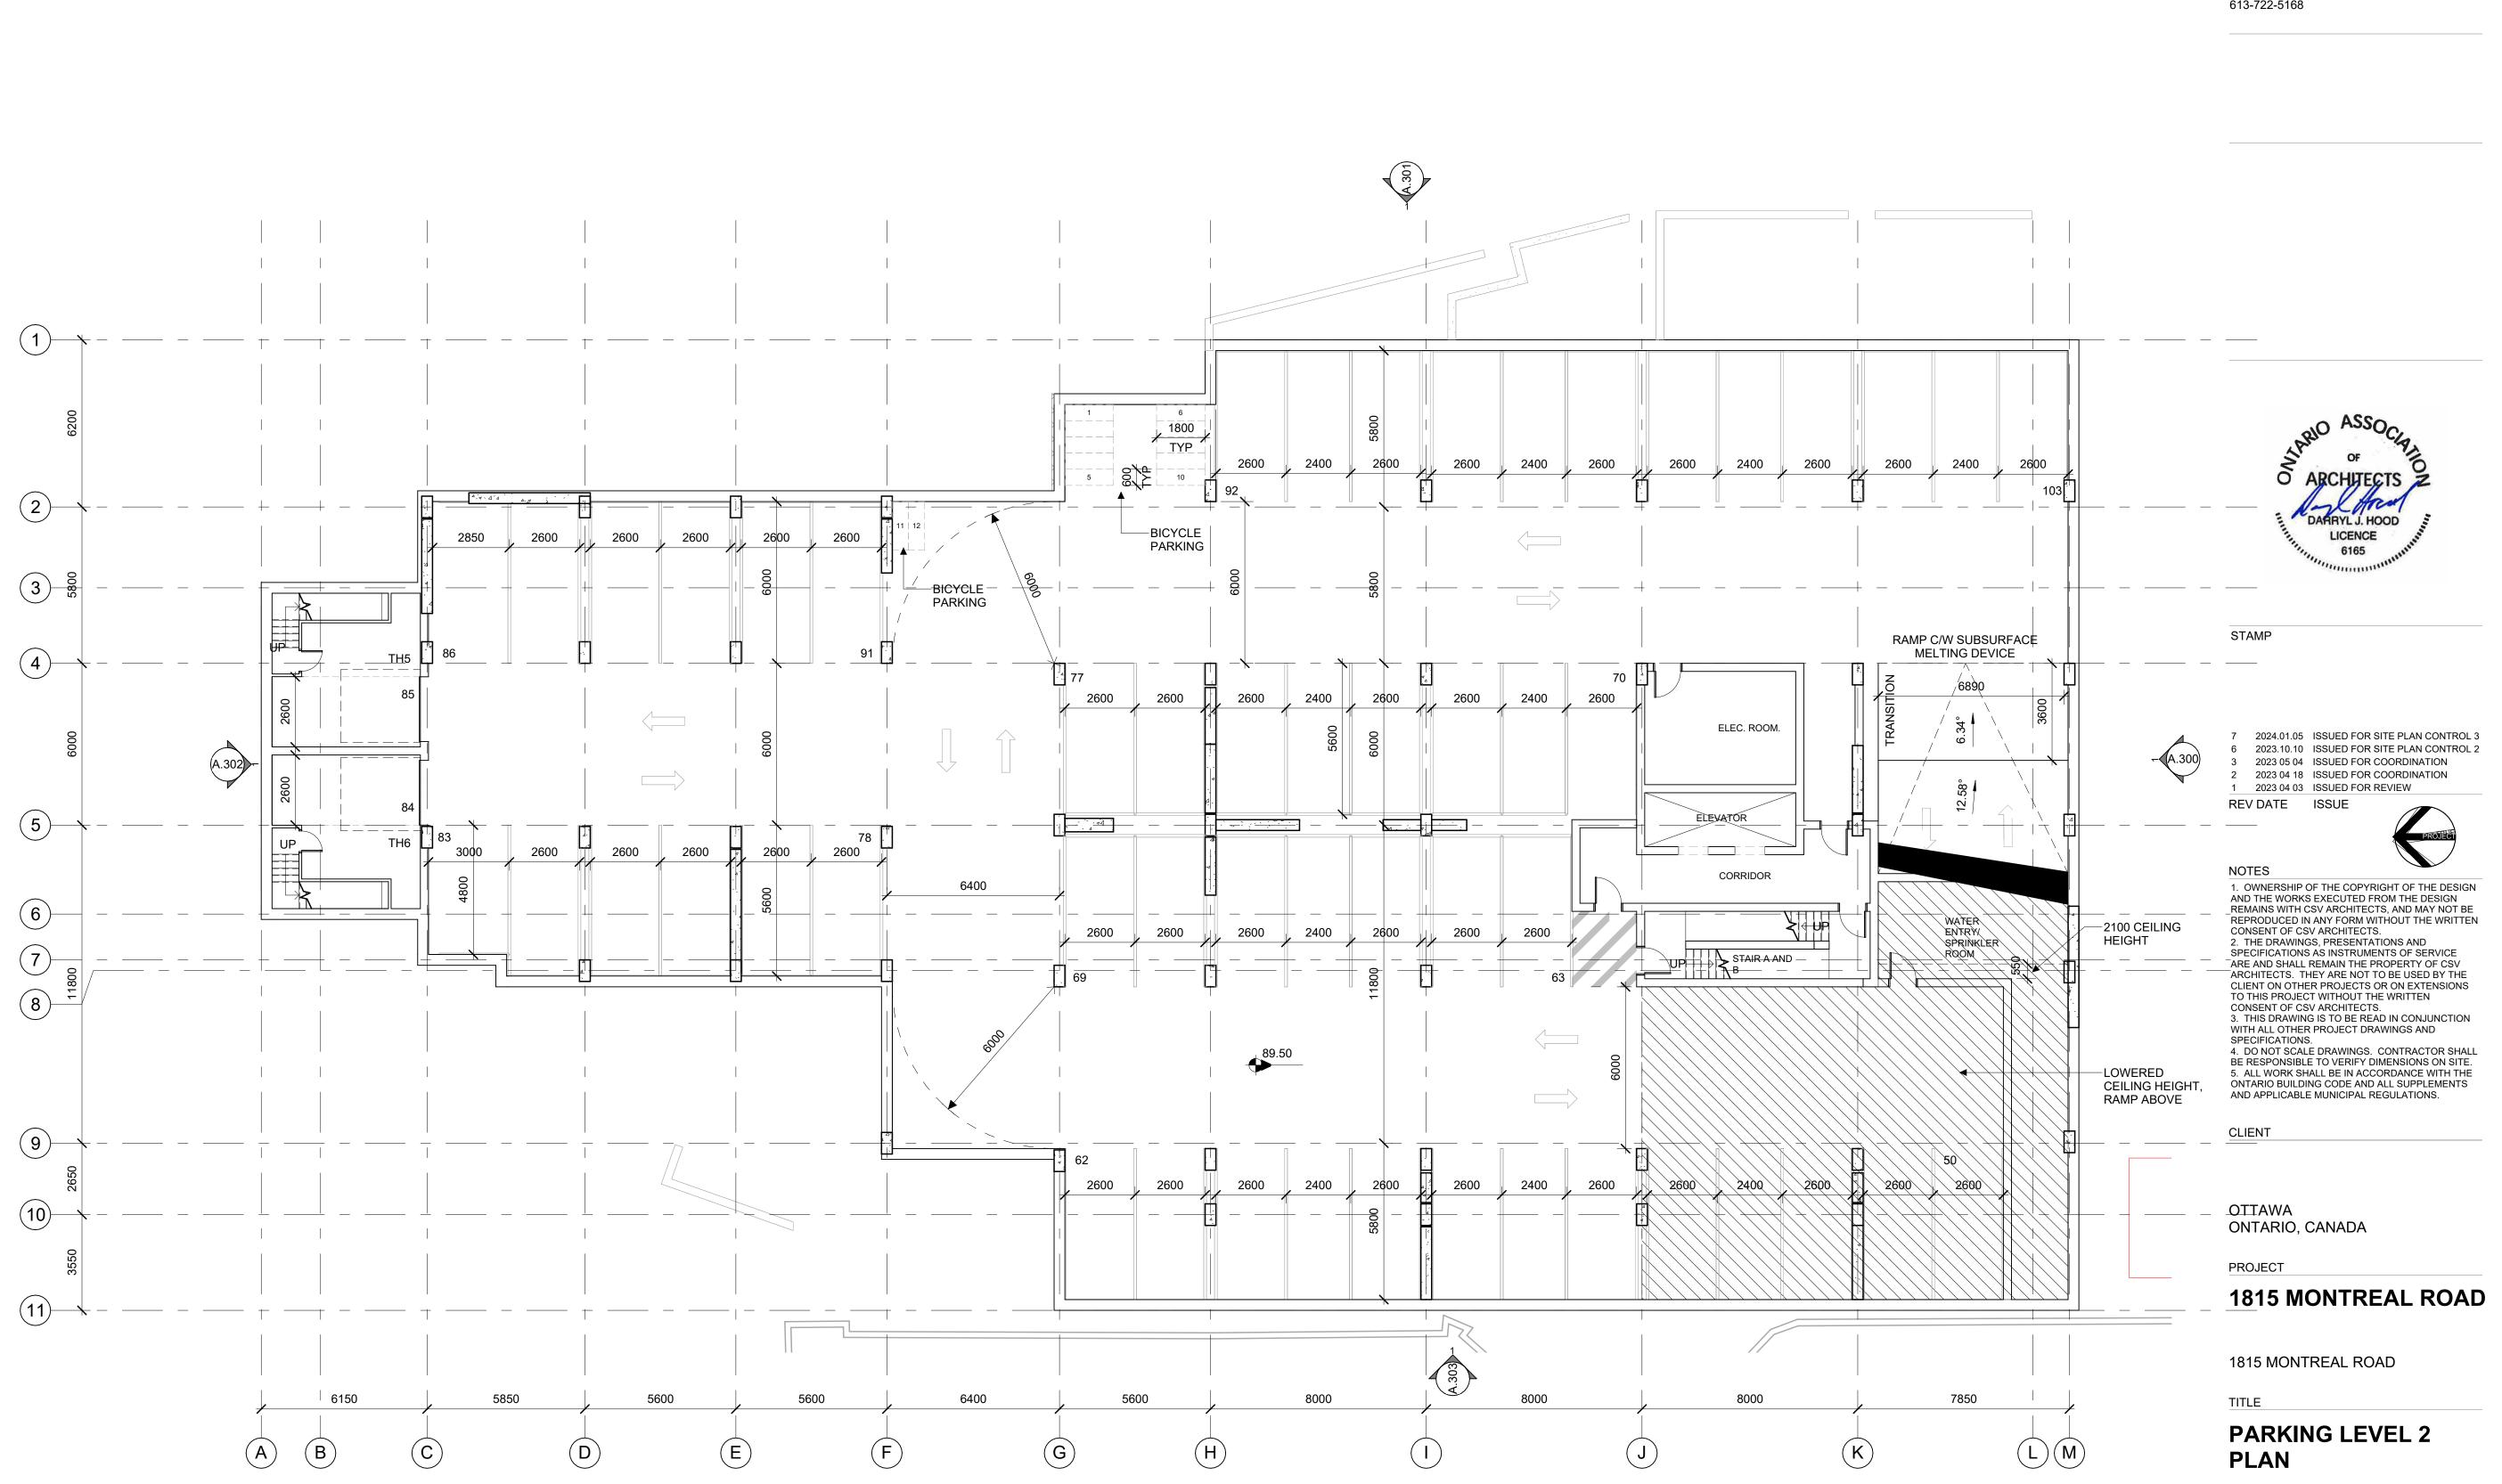

1 PARKING LEVEL 2 A.201 1: 125 **CSV** ARCHITECTS

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DRAWN: R.R.

APPROVED: D.H.

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REV DRAWING NO.

Resident	
17	COMPACT
72	NORMAL
Visitor	
2	BF PARKING
16	NORMAL
107	

Bike Parking 66




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1M 2M

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1M 2M

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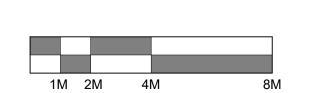
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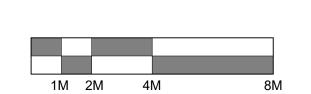
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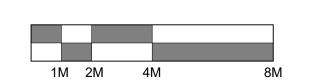
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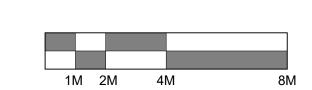
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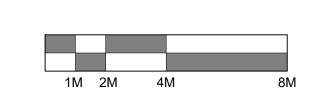
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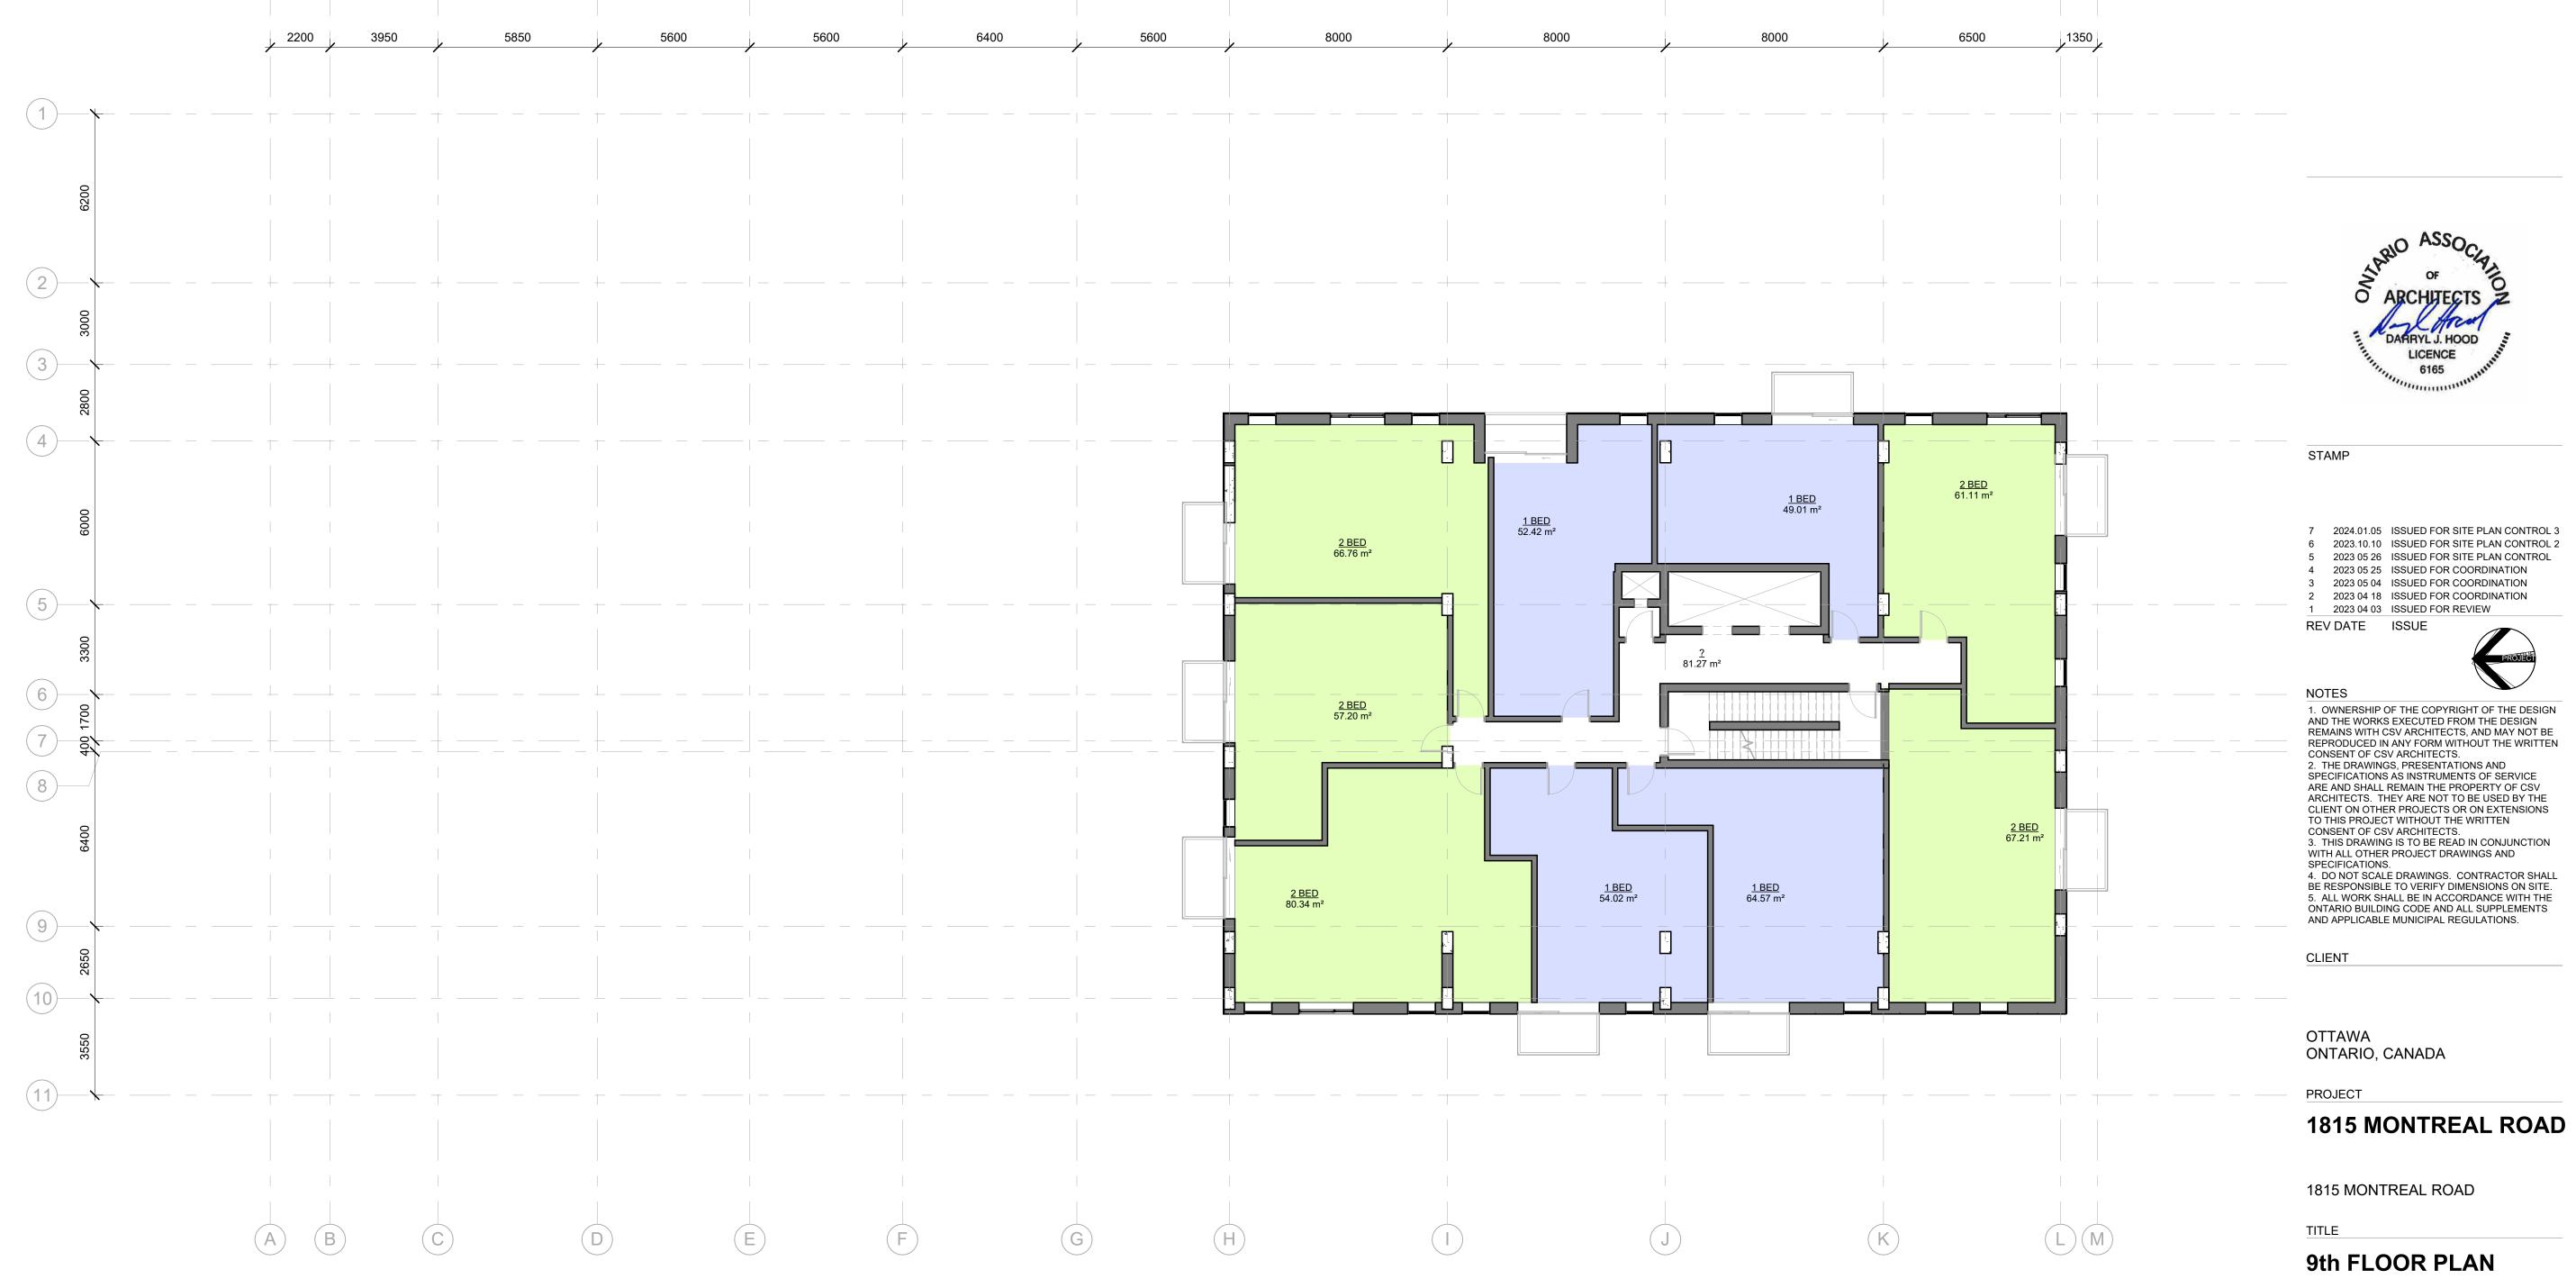
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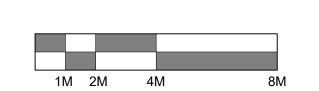
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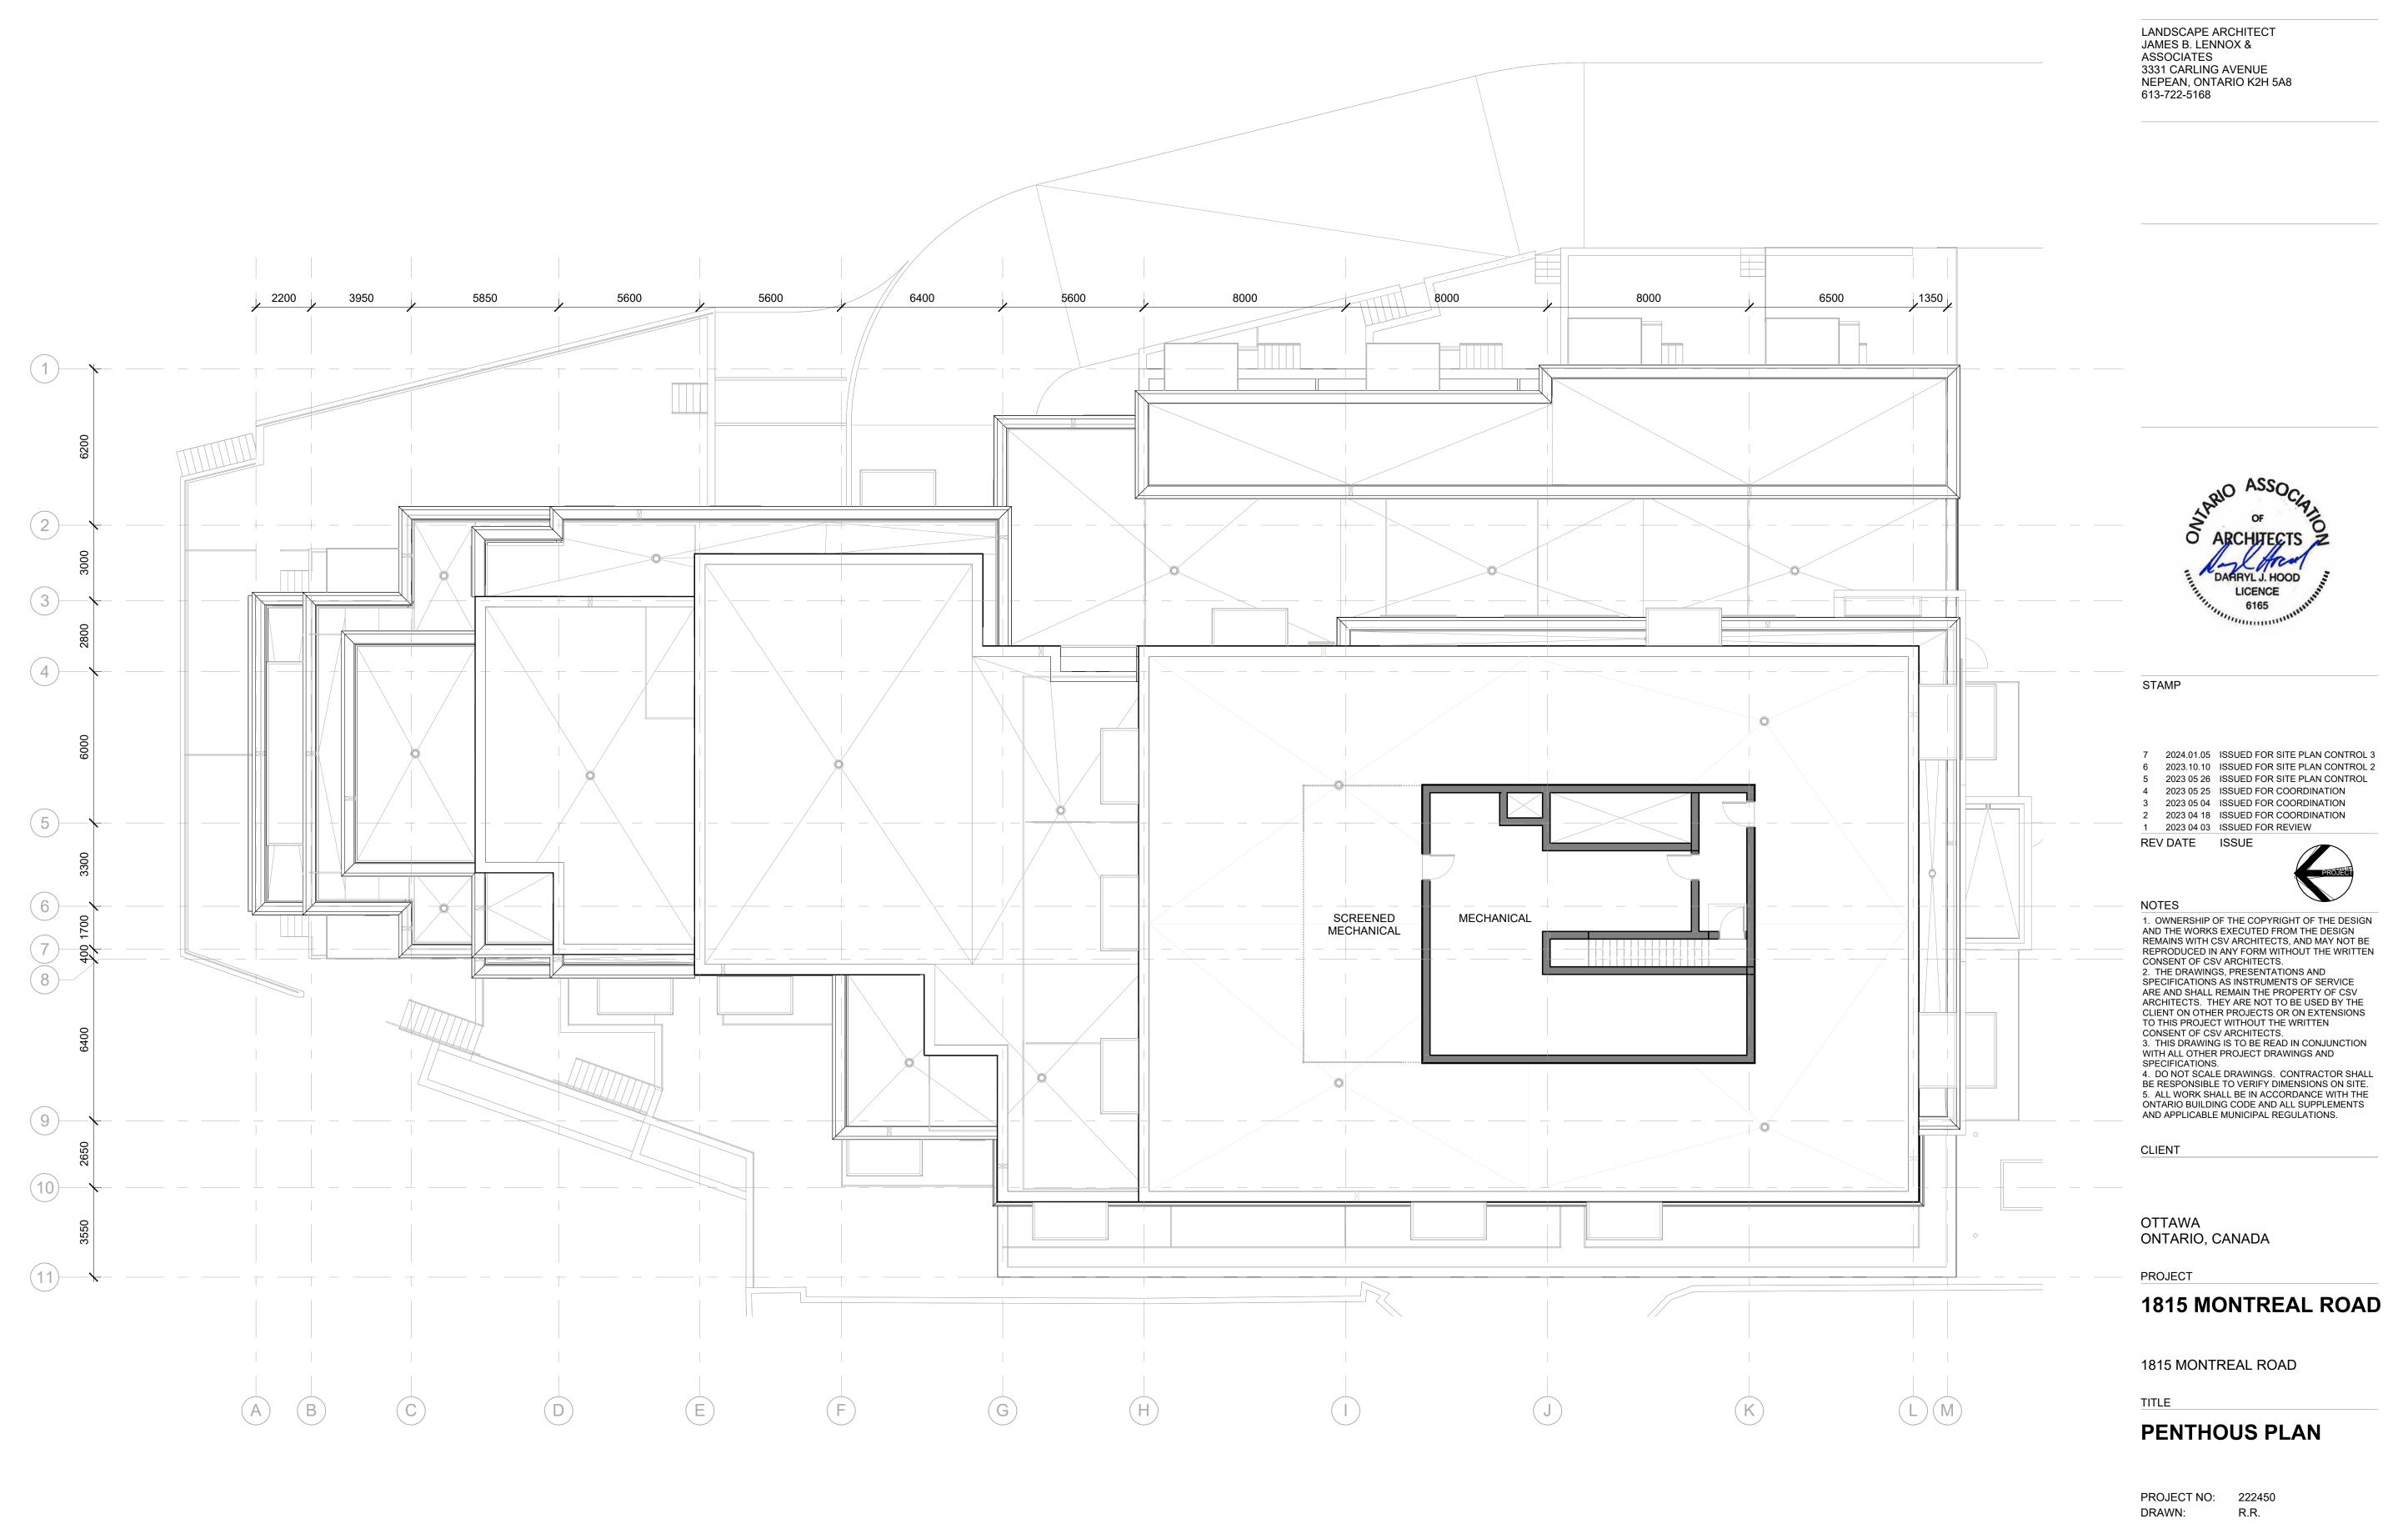
LANDSCAPE ARCHITECT
JAMES B. LENNOX &
ASSOCIATES
3331 CARLING AVENUE
NEPEAN, ONTARIO K2H 5A8
613-722-5168



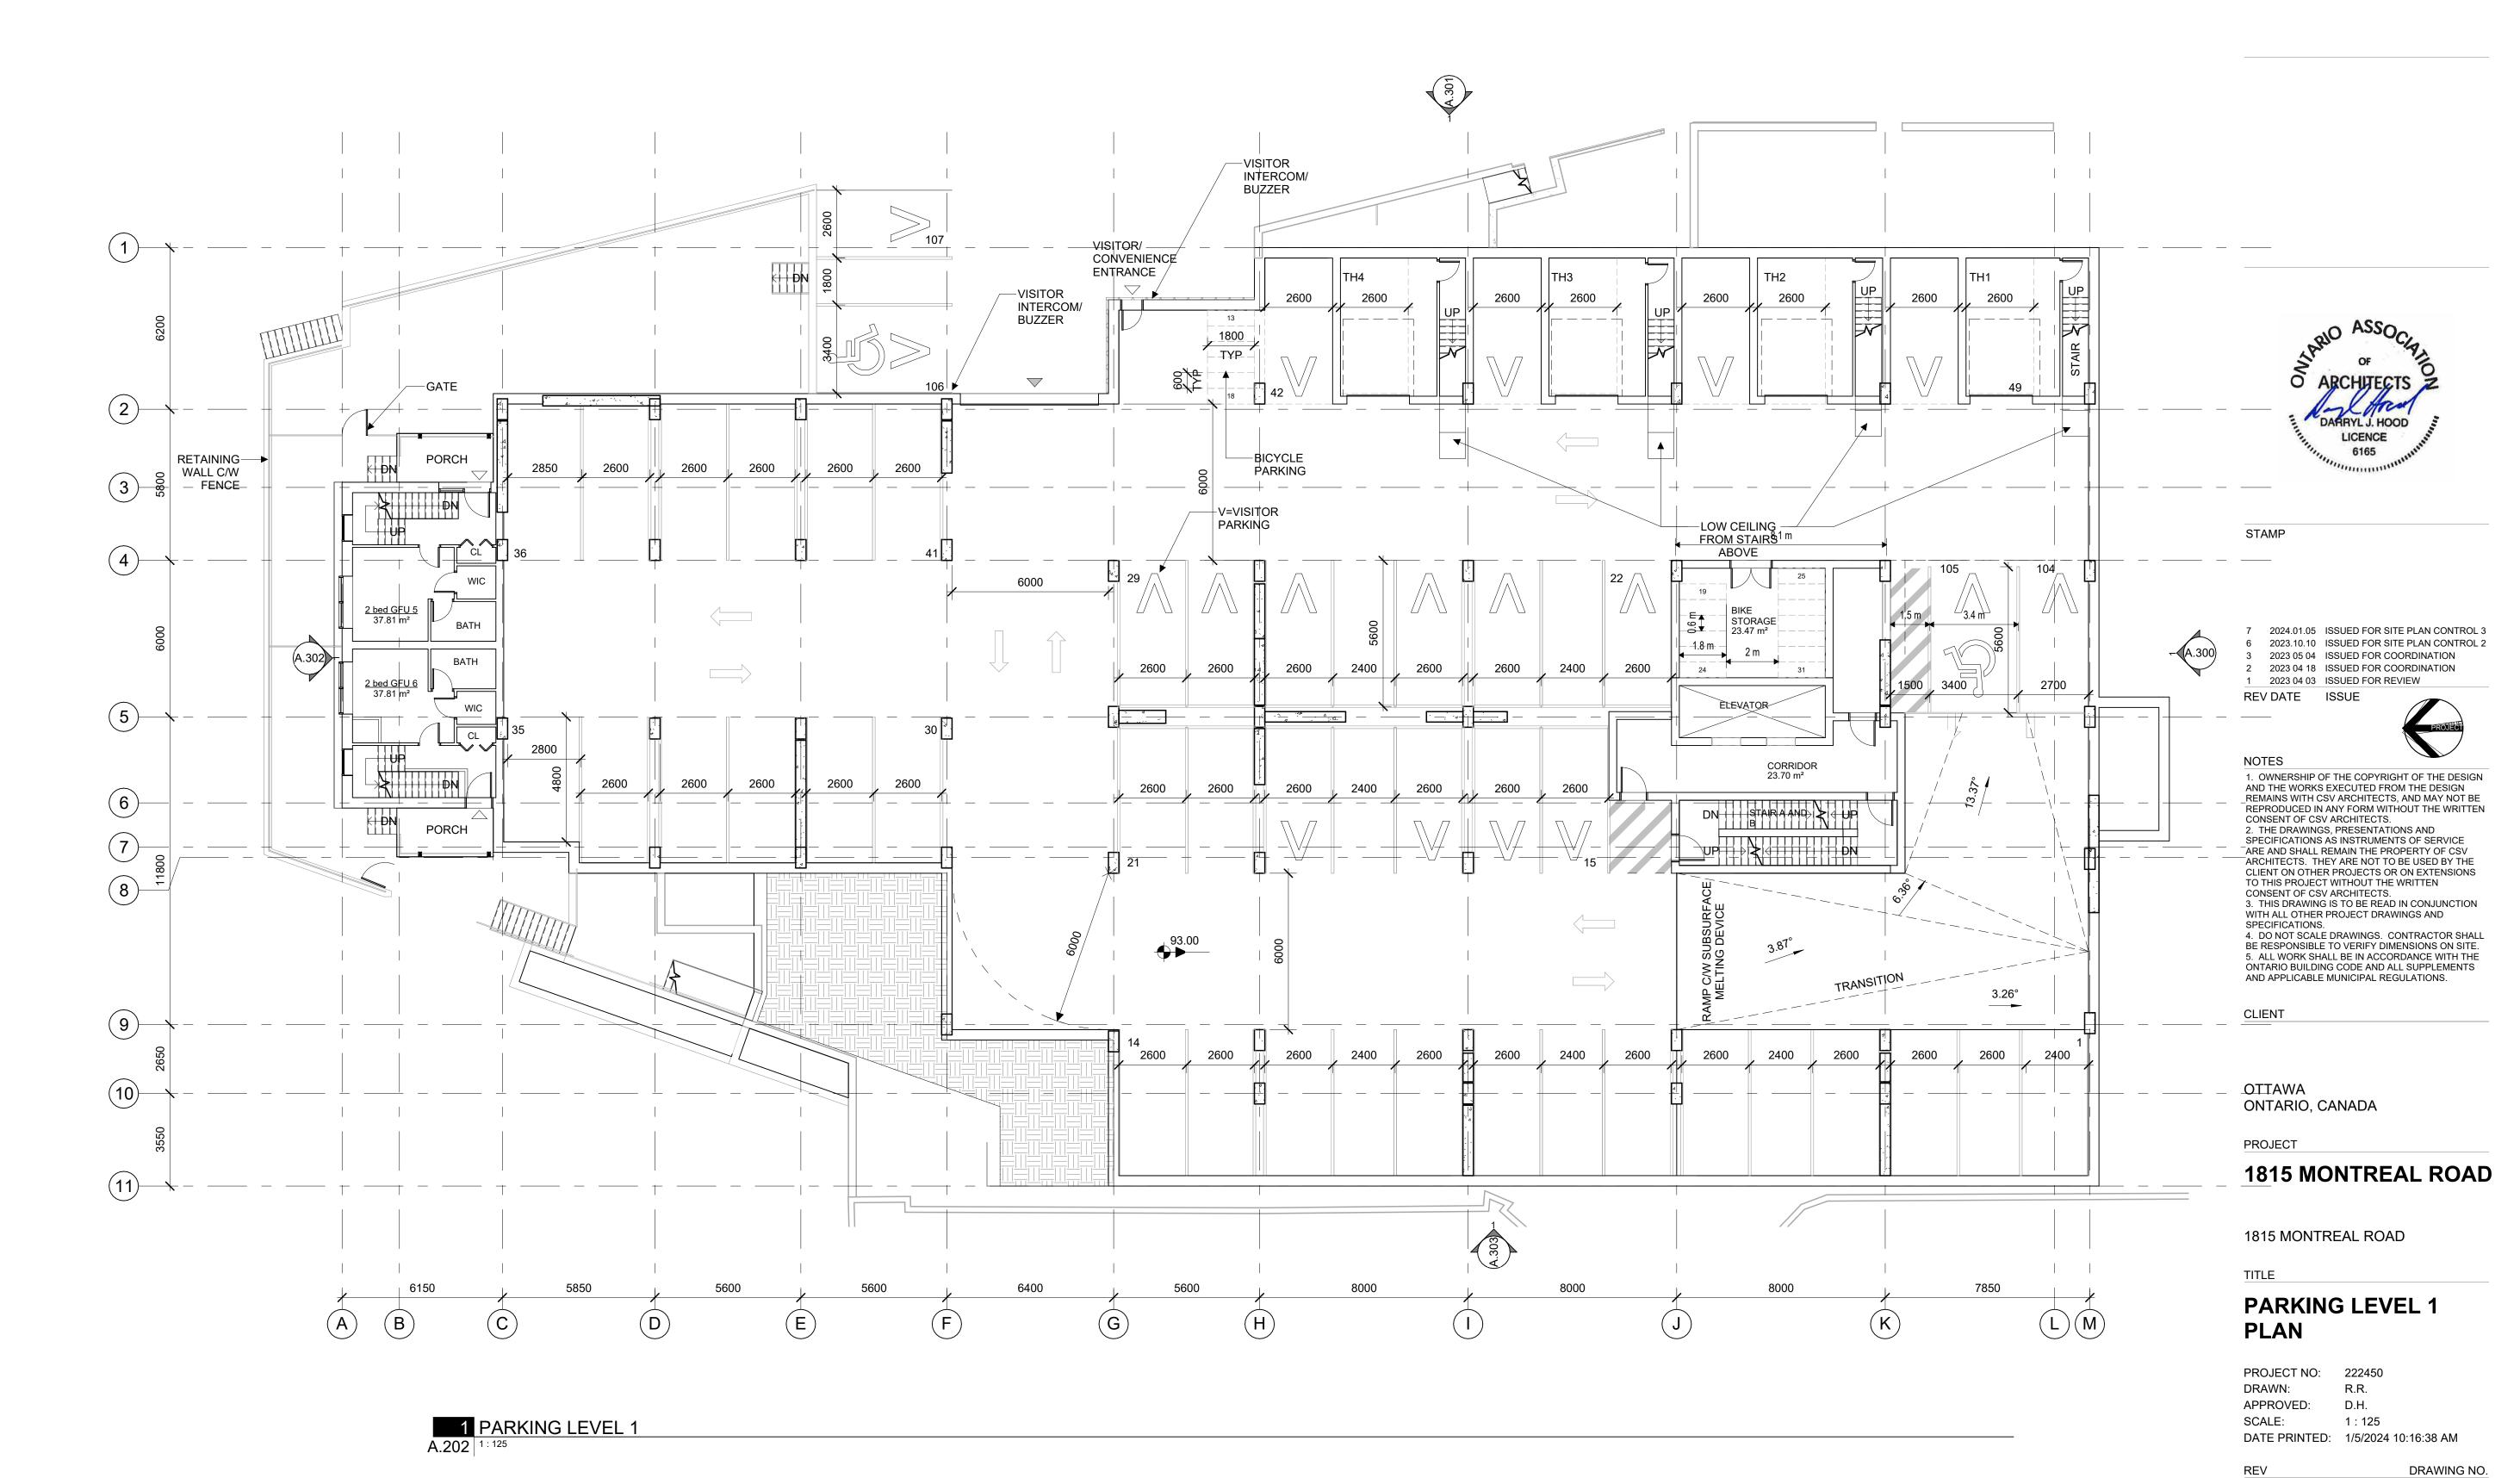

PROJECT NO: 222450 DRAWN: R.R. APPROVED: D.H. SCALE: 1:125 DATE PRINTED: 1/5/2024 10:16:46 AM

DRAWING NO.



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PROJECT NO: 222450

DRAWN: R.R.

APPROVED: D.H.

SCALE: 1 : 125

DATE PRINTED: 1/5/2024 10:16:48 AM

REV

1M 2M 4M

A.219a



1 SOUTH ELEVATION A.300 1:125

ELEVATION NOTES:

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BIRD-SAFE GLASS TO BE USED AT A MIN. 90% OF ALL GLASS WITHIN THE FIRST 16M ABOVE AVERAGE GRADE (OR TO THE HEIGHT OF THE ADJACENT MATURE TREES)

ELEVATION KEYNOTES:

SAMPLE TEXT

SAMPLE TEXT

SAMPLE TEXT

SAMPLE TEXT MULTI LINE

SAMPLE TEXT

ELEVATION LEGEND:

HATCH PATTERNS SHOWN ARE FOR GRAPHIC PURPOSES ONLY AND SHOULD BE COORDINATED WITH ACTUAL SPECIFIED MATERIALS.

HATCH	SYMBOL	DESCRIPTION
		BRICK VENEER MANUFACTURER: COLOUR:
		STONE VENEER - BLOCK MANUFACTURER: COLOUR:
		FIBERCEMENT CLADDING MANUFACTURER: COLOUR:

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LANDSCAPE ARCHITECT
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ASSOCIATES
3331 CARLING AVENUE
NEPEAN, ONTARIO K2H 5A8 613-722-5168



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CLIENT

OTTAWA ONTARIO, CANADA

PROJECT

1815 MONTREAL ROAD

1815 MONTREAL ROAD

SOUTH ELEVATION

PROJECT NO: 222450 DRAWN: R.R. APPROVED: D.H. SCALE: As indicated DATE PRINTED: 1/5/2024 10:16:58 AM

DRAWING NO.



A.301 1:125

ELEVATION NOTES:

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ELEVATION KEYNOTES:

SAMPLE TEXT

SAMPLE TEXT

SAMPLE TEXT

SAMPLE TEXT MULTI LINE

SAMPLE TEXT

ELEVATION LEGEND:

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HATCH SYMBOL	DESCRIPTION
	BRICK VENEER MANUFACTURER: COLOUR:
	STONE VENEER - BLOCK MANUFACTURER: COLOUR:
	FIBERCEMENT CLADDING MANUFACTURER: COLOUR:



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CLIENT

OTTAWA ONTARIO, CANADA

PROJECT


1815 MONTREAL ROAD

1815 MONTREAL ROAD

EAST ELEVATION

PROJECT NO: 222450 DRAWN: R.R. APPROVED: D.H. SCALE: As indicated DATE PRINTED: 1/5/2024 10:17:08 AM

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ELEVATION KEYNOTES:

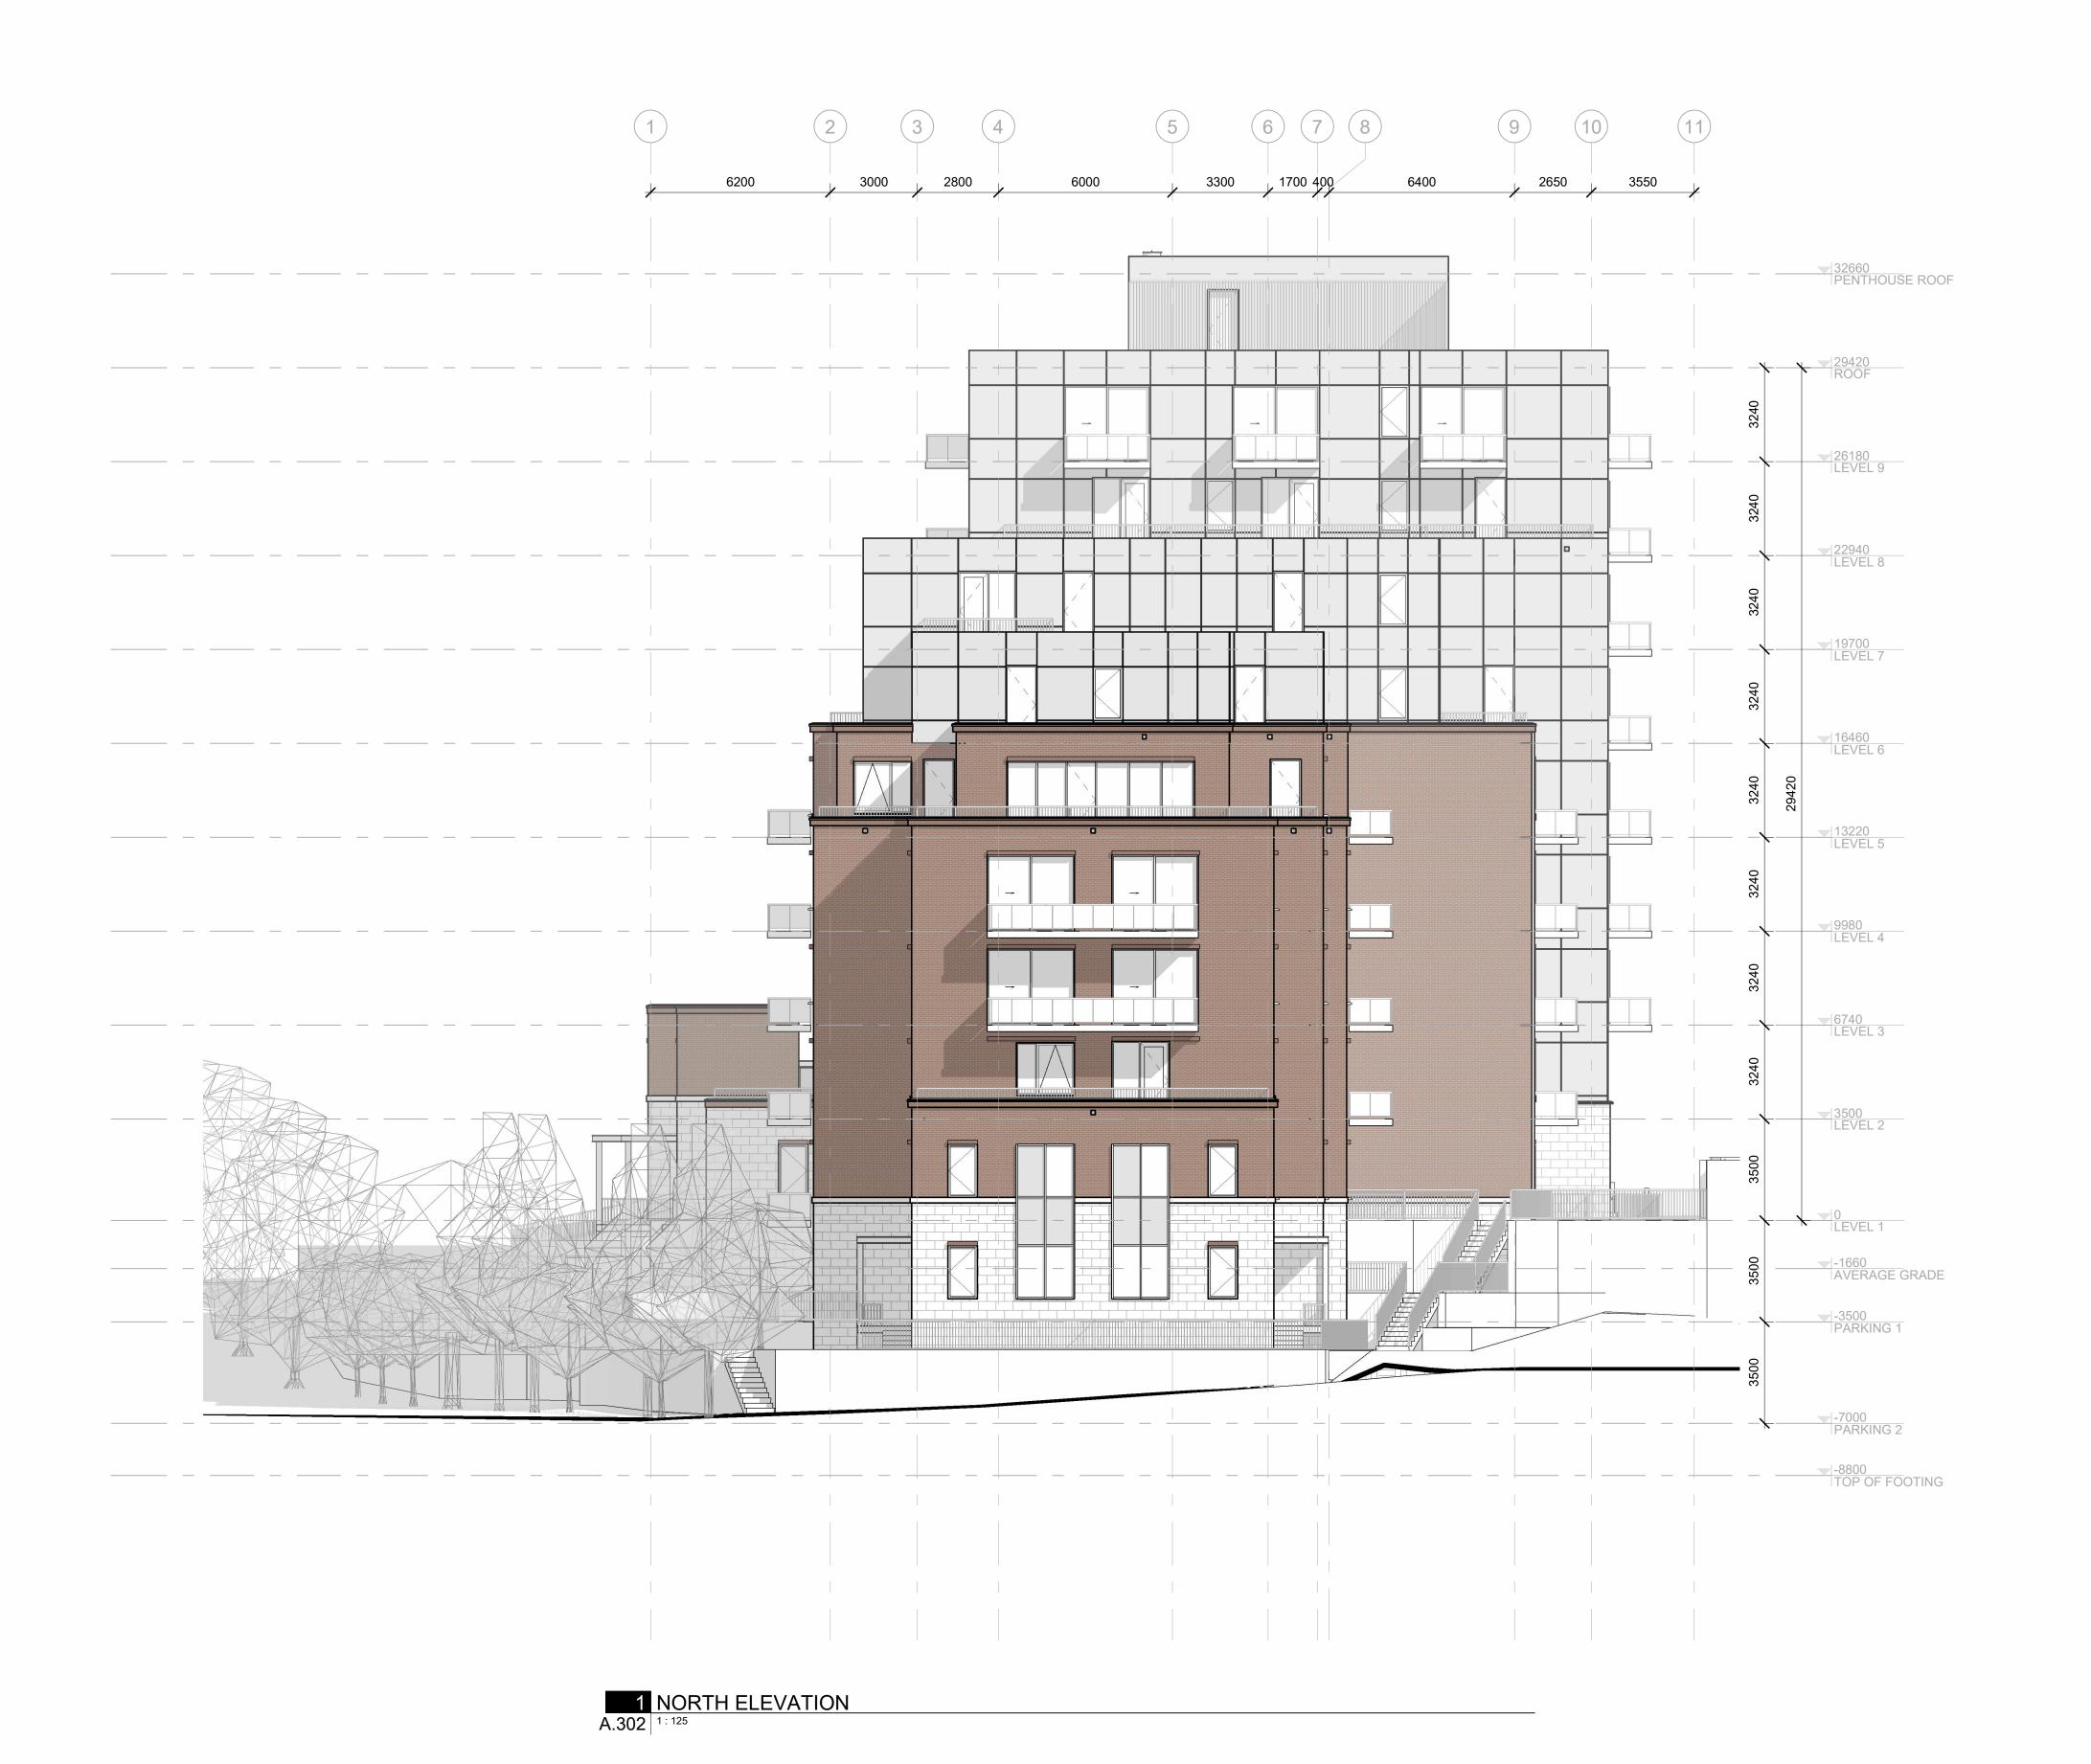SAMPLE TEXT

SAMPLE TEXT

SAMPLE TEXT

SAMPLE TEXT MULTI LINE

SAMPLE TEXT

ELEVATION LEGEND:

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HATCH	SYMBOL	DESCRIPTION	
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		FIBERCEMENT CLADDING MANUFACTURER: COLOUR:	

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5 2023 05 26 ISSUED FOR SITE PLAN CONTROL
4 2023 05 25 ISSUED FOR COORDINATION
3 2023 05 04 ISSUED FOR COORDINATION
2 2023 04 18 ISSUED FOR COORDINATION
1 2023 04 03 ISSUED FOR REVIEW

NOTES

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CLIENT

OTTAWA ONTARIO, CANADA

PROJECT

1815 MONTREAL ROAD

1815 MONTREAL ROAD


TITLE

NORTH ELEVATION

PROJECT NO: 222450
DRAWN: R.R.
APPROVED: D.H.
SCALE: As indicated
DATE PRINTED: 1/5/2024 10:17:18 AM

ΕV

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ELEVATION NOTES:
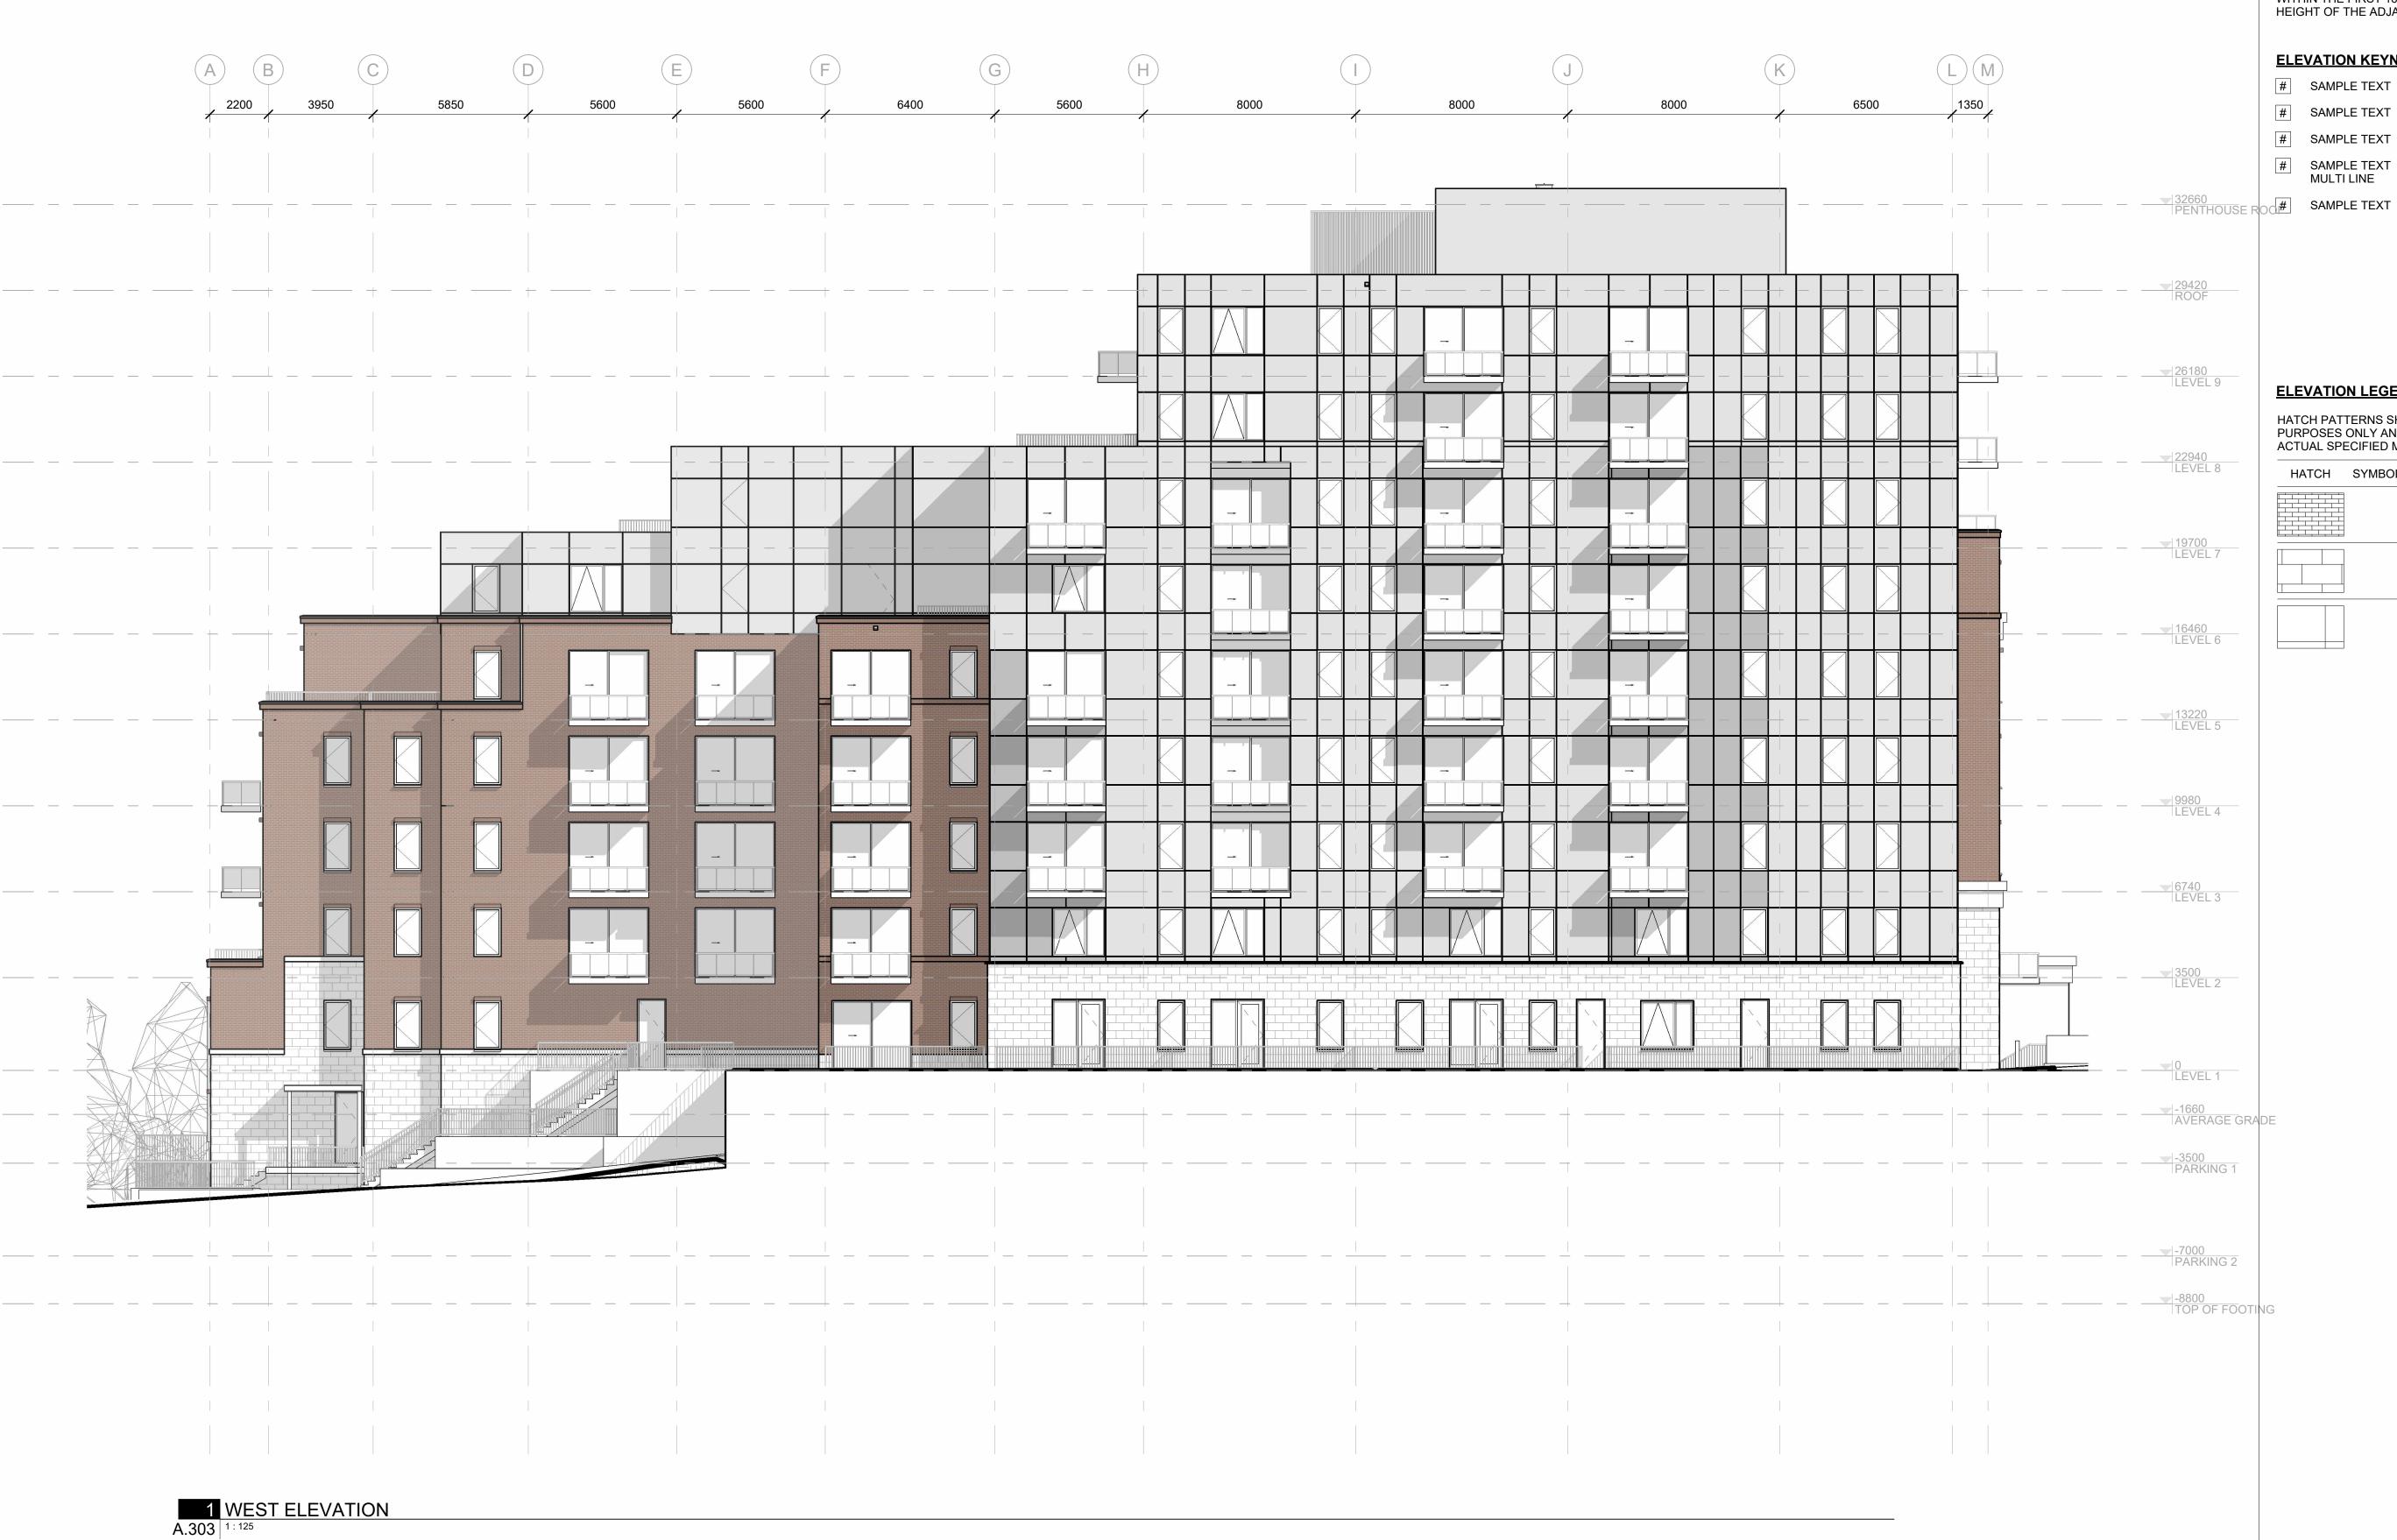
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ELEVATION KEYNOTES:

- # SAMPLE TEXT
- # SAMPLE TEXT MULTI LINE

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		FIBERCEMENT CLADDING MANUFACTURER:

COLOUR:

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CLIENT

OTTAWA ONTARIO, CANADA

PROJECT


1815 MONTREAL ROAD

1815 MONTREAL ROAD

WEST ELEVATION

PROJECT NO: 222450 DRAWN: R.R. APPROVED: D.H. SCALE: As indicated DATE PRINTED: 1/5/2024 10:17:31 AM

DRAWING NO.

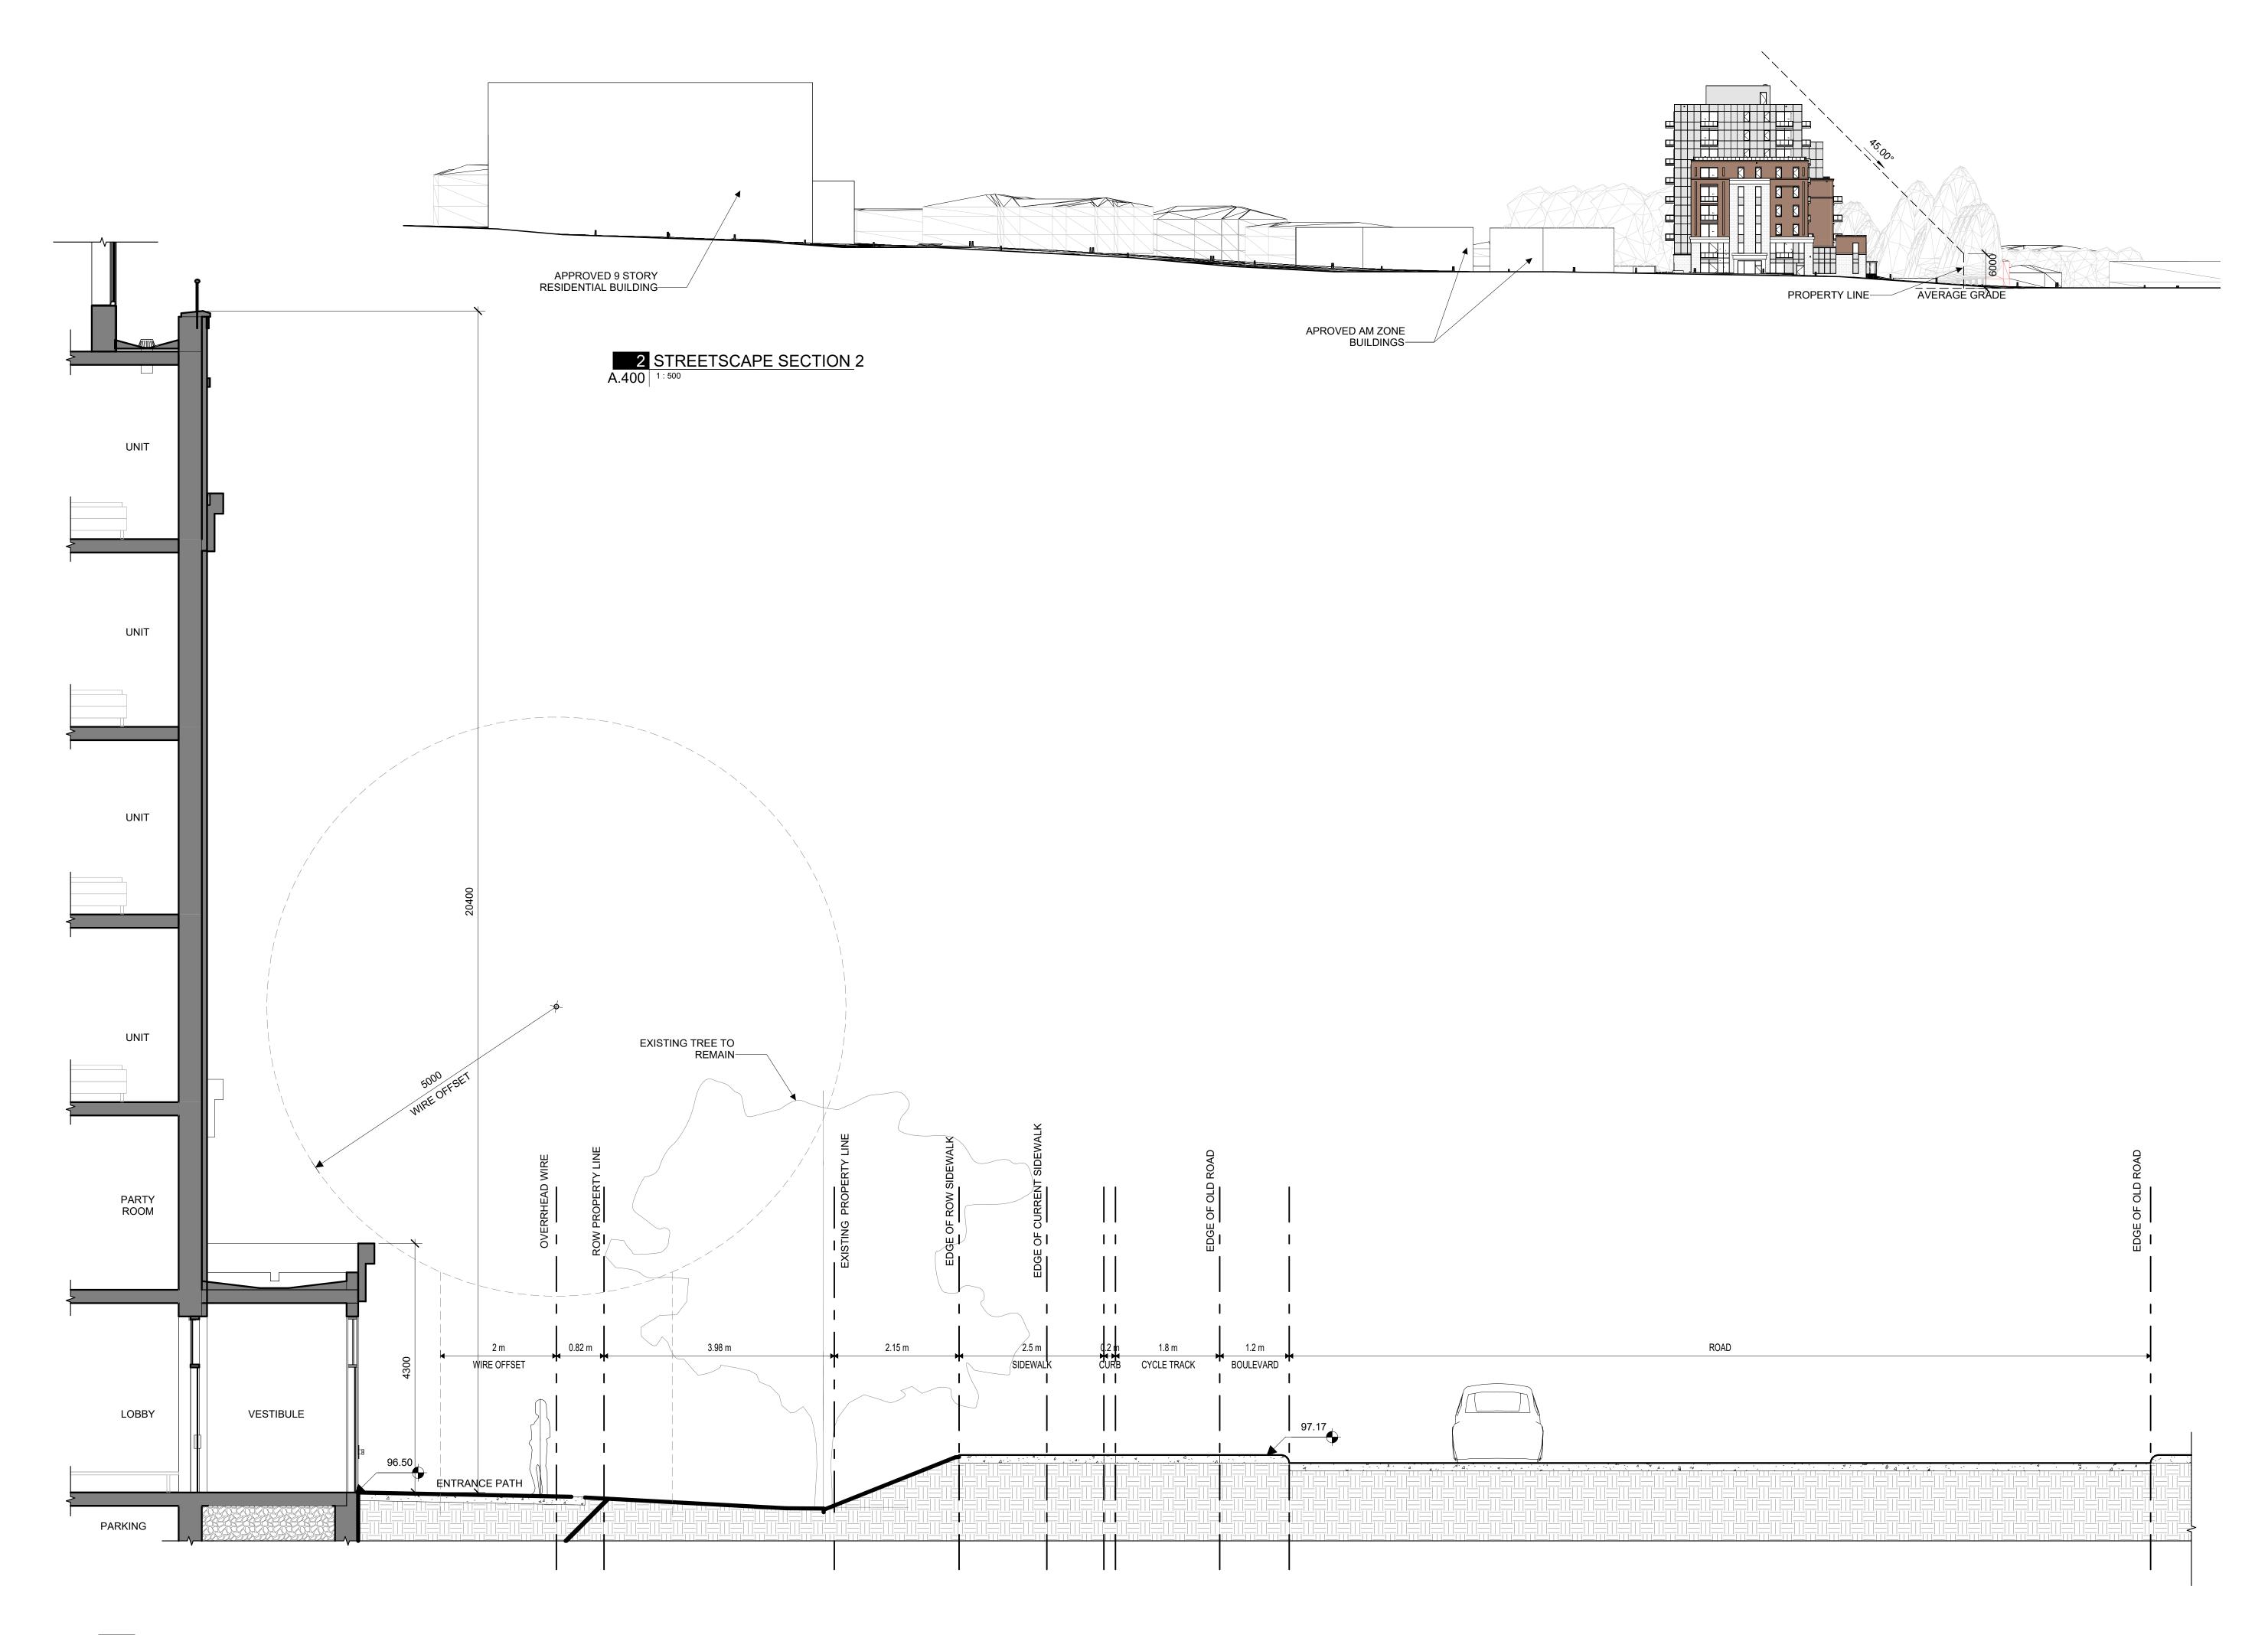

1 STREETSCAPE SECTION 1 A.400 1:50

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CLIENT

OTTAWA ONTARIO, CANADA

PROJECT

1815 MONTREAL ROAD

1815 MONTREAL ROAD

TITLE

STREETSCAPE **SECTIONS**

PROJECT NO: 222450 DRAWN: R.R. APPROVED: D.H. SCALE: As indicated DATE PRINTED: 1/5/2024 10:17:35 AM

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