


**1 LANDSCAPE PLAN**  
SCALE: 1:200


- GENERAL NOTES:**
- It is the responsibility of the appropriate contractor or official to report any errors, omissions or discrepancies on this plan with actual site conditions to the Landscape Architect before proceeding with construction.
  - The contractor is to notify all utility companies and authorities prior to any excavation and ascertain locations of underground services.
  - The contractor is to reinstate all areas and items damaged as a result of construction activity.
  - The contractor is to comply with all pertinent codes and by-laws.
  - The contractor is to maintain a positive surface run-off throughout the entire construction period.
  - The Landscape Architect is not responsible for subsurface conditions.
  - The contractor is to identify all existing trees to remain on site with the Landscape Architect prior to construction.
  - The contractor is to stake the proposed location of all plant material in conjunction with the Landscape Architect prior to excavation.
  - Minimum distances for selected deciduous trees are as follows:
    - Building Foundations 7.5m for small (mature height up to 7.5m) and medium size trees (mature height 7.5 to 14m) provided that the following conditions are met:
      - The underside of footing (USF) is 2.1 m or greater below the lowest finished grade/footings within 10 m from the tree, as measured from the centre of the tree trunk and verified by means of the Grading Plan.
    - A small tree must be provided with a minimum of 25 m³ of available soils volume while a medium tree must be provided with a minimum of 30 m³ of available soil volume. The developer is to ensure that the soil is generally un-compacted when backfilling in street tree planting locations.
    - The tree species must be small (mature tree height up to 7.5 m) to medium size (mature tree height 7.5 m to 14 m)
    - The foundation walls are to be reinforced at least minimally (minimum of two upper and two lower 15M bars in the foundation wall).
  - Grading surrounding the tree must promote drainage to the tree root zone (in such a manner as not to be detrimental to the tree), as noted on the subdivision Grading
    - Sidewalks 1.5m
    - Public Streets 2.2m
    - Underground Infrastructure 2.0m
  - All trees within 1m of underground utility trenches are to be excavated by hand.
  - Remove all protective wrapping from tree trunks after installation.
  - Staking of trees shall only be performed if necessary.
  - Ensure that mulch is pulled back a min. distance of 75mm from base of tree trunk.
  - Contractor is to provide a 2 year warranty for plant material

**PROPOSED PLANT LIST**


KEY	QTY.	BOTANICAL NAME	COMMON NAME	SIZE	CONDITION	REMARKS
<b>TREES</b>						
CA	2	Cornus alternifolia	Pagoda Dogwood	30mm cal.	Potted, 4m oc. min	Single leader
HA	3	Crataegus crus-galli var inermis	Thornless Hawthorn	50mm cal.	B&B, 4m oc. min	
HB	2	Celtis occidentalis	Hackberry	50mm cal.	B&B, 7.5m oc. min	
JL	2	Syringa reticulata	Japanese Tree Lilac	50mm cal.	B&B, 4m oc. min	Single leader
SB	4	Amelanchier canadensis	Servicberry	50mm cal.	B&B, 4m oc. min	Single leader
SF	3	Amelanchier laevis 'JFS-ARB'	Spring Flurry Serviceberry	50mm cal.	B&B, 4m oc. min	Single leader
<b>SHRUBS</b>						
CL	4	Syringa vulgaris	Common Lilac	2000 mm ht	Potted	2000mm o.c.
DG	37	Physocarpus opulifolius	Common Ninebark	1000 mm ht.	Potted	1100mm o.c.
DN	38	Physocarpus opulifolius 'Diablo'	Diablo Ninebark	1000 mm ht.	Potted	1100mm o.c.
JK	20	Sorbaria sorbifolia	Ural False Spirea	1000mm ht.	Potted	1500mm o.c.
MP	16	Pinus mugo	Mugo Pine	800 mm ht.	Potted	800mm o.c.
PH	4	Hydrangea paniculata 'PeeGee'	PeeGee Hydrangea	2000 mm ht.	Potted	2000mm o.c.
<b>PERENNIALS AND ORNAMENTAL GRASSES</b>						
BL	58	Leymus arenarius 'Blue Dune'	Blue Lyme Grass	250mm pot	Potted	500mm o.c.
DL	85	Hemerocallis 'Red Magic'	Red Magic Daylily	100 mm pot	Potted	400mm o.c.
KF	53	Calamagrostis 'Karl Foerster'	Feather Reed Grass	250mm pot	Potted	800mm o.c.

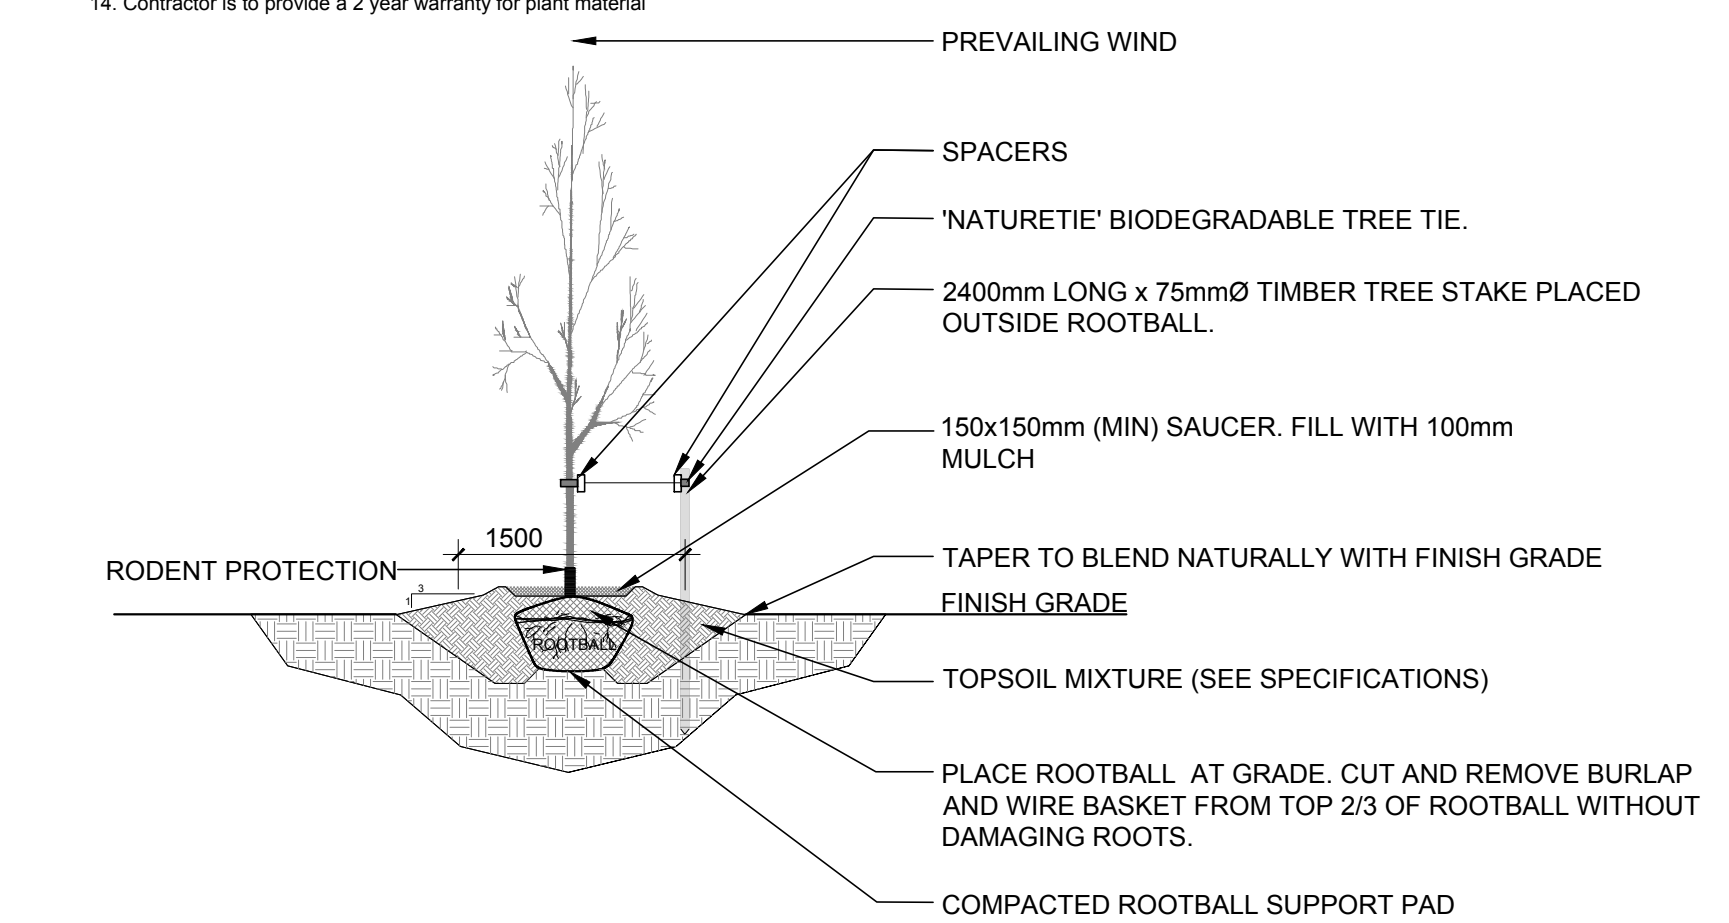

**2 DECIDUOUS TREE PLANTING**  
SCALE: 1:NTS

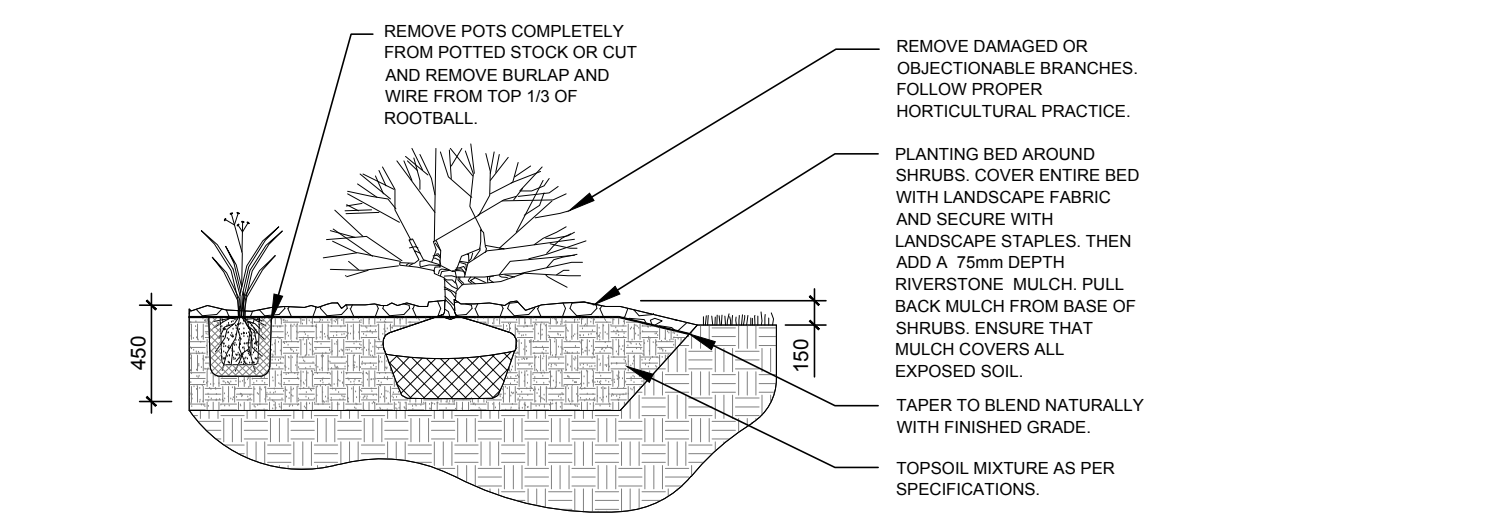

**3 SHRUB & ORNAMENTAL GRASS PLANTING**  
SCALE: 1:NTS

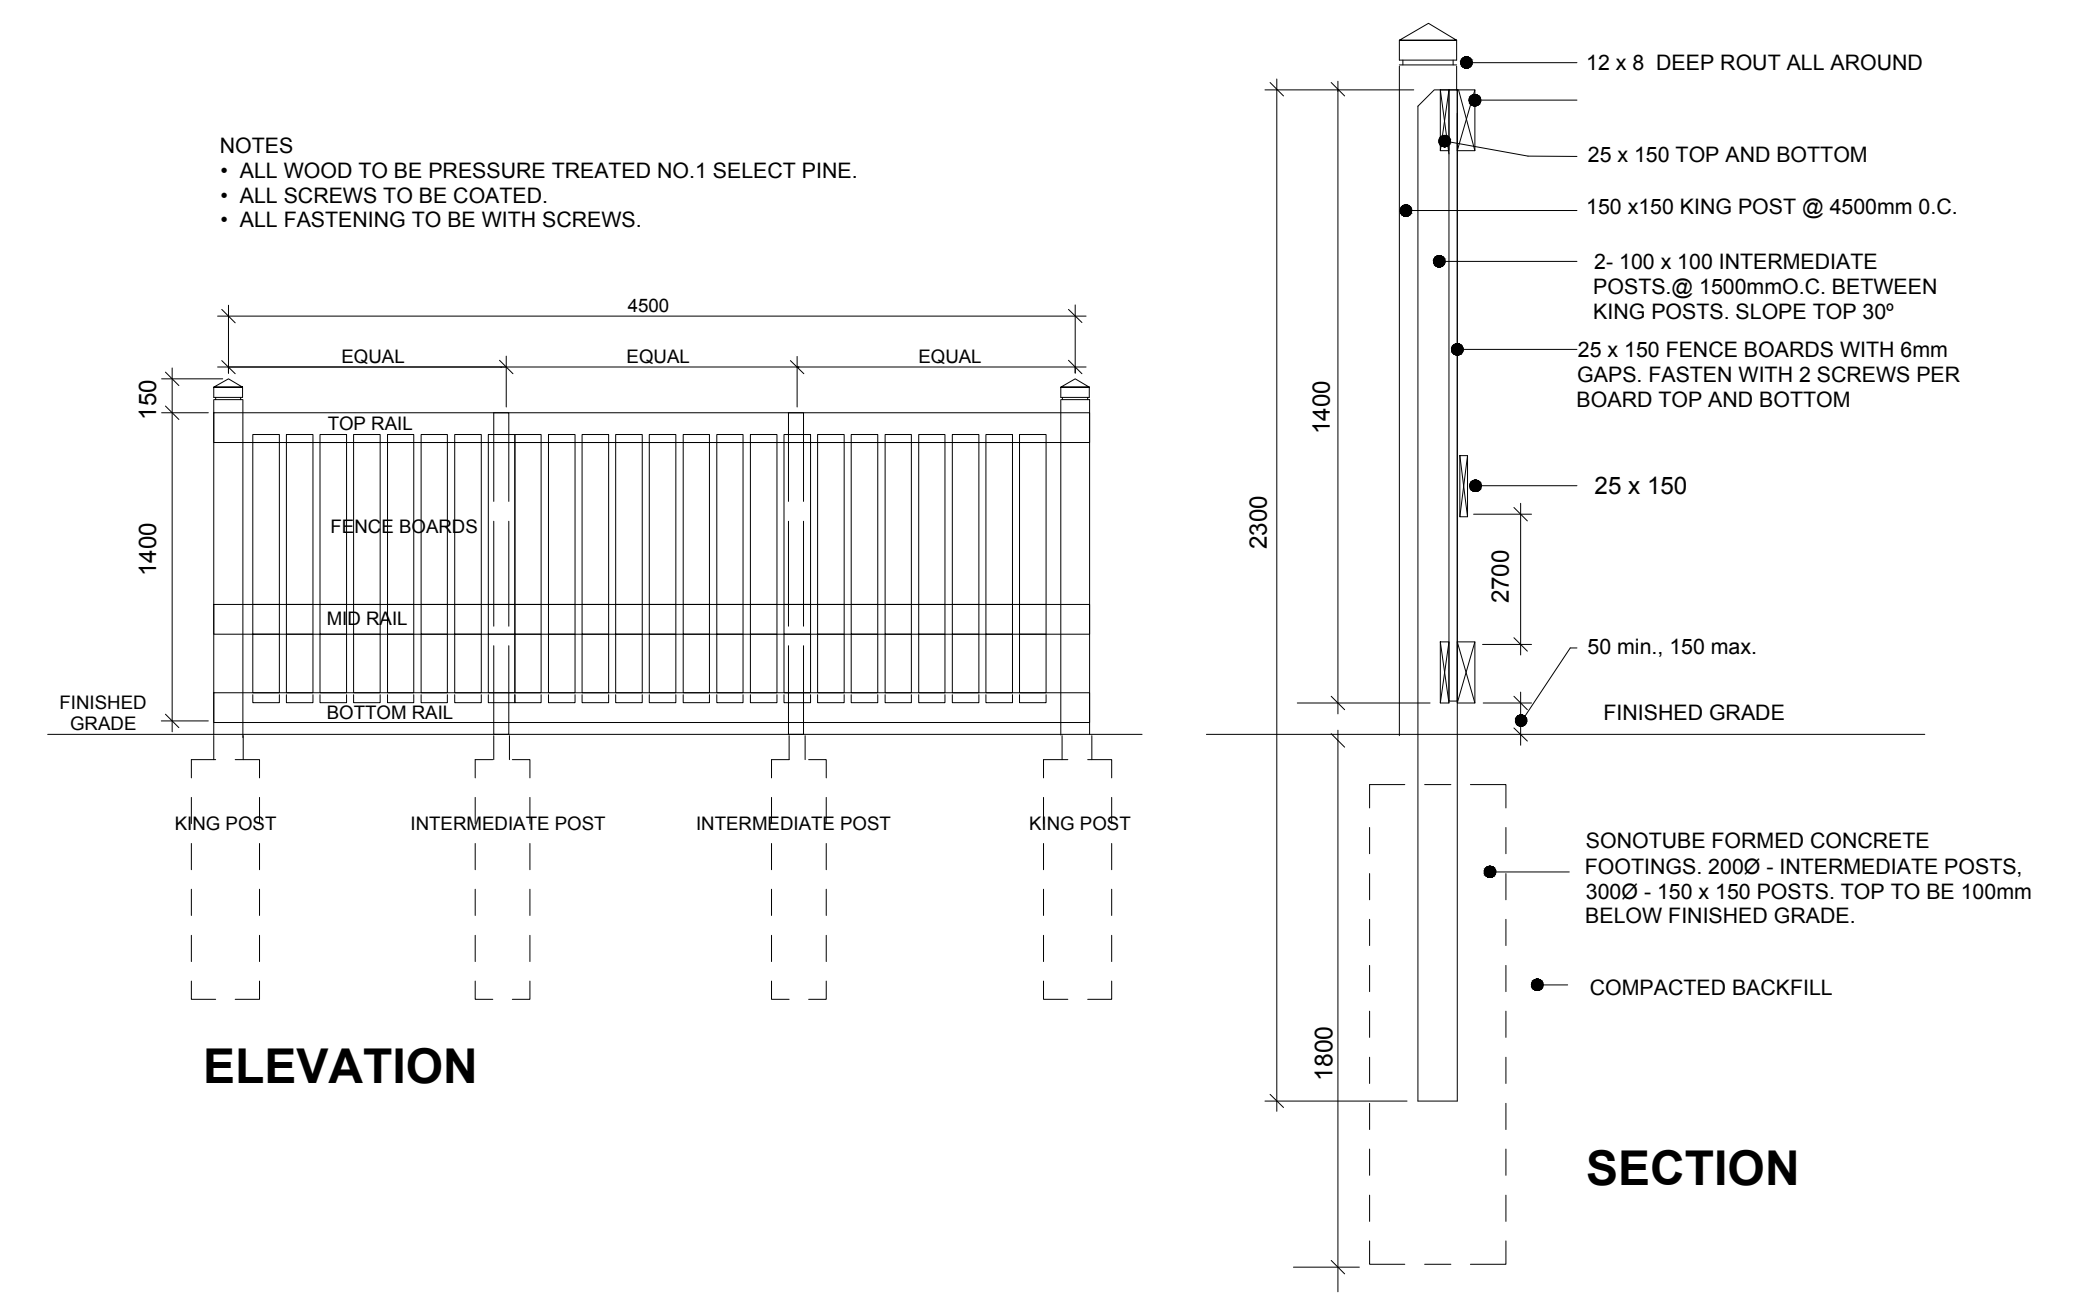

**4 1.4m Ht. WOOD SCREEN FENCE**  
SCALE: NTS

CLIENT  
**Creative Development Ventures - 14193679 CANADA INC**

CONSULTANTS  
ARCHITECTS: **CSV ARCHITECTS**  
sustainable design - conception écologique  
413.564.8118  
www.csv.ca  
190 O'Connor Street, Suite 100  
Ottawa, Ontario K2P 2K3

SURVEYORS:  
**J.D. BARNES**  
LAND INFORMATION SPECIALISTS  
1000 BROADVIEW AVE. SUITE 100  
OTTAWA, ONTARIO K1K 1R2  
TEL: 613-735-1111 FAX: 613-735-1112

**LEGEND**

- PROPOSED DECIDUOUS TREE
- EXISTING TREE TO REMAIN SEE TCR FOR DETAILS
- PROPOSED SHRUBS / PERENNIALS / ORNAMENTAL GRASSES
- PROPOSED SOD
- PROPOSED PRECAST PAVERS
- PROPOSED 1.4m HL WOOD SCREEN FENCE
- PROPERTY LINE
- TREE PROTECTION FENCE
- LIMIT OF EXCAVATION
- 7.5M PLANTING SETBACK
- SOIL VOLUME AREA

4	REVISED PER CITY COMMENTS	01/03/2024	ML	JL
3	REVISED PER GEOTECHNICAL REPORT	10/24/2023	ML	JL
2	REVISED PER CITY COMMENTS	10/06/2023	ML	JL
1	ISSUED FOR SITE PLAN CONTROL	05/30/2023	CM	JL
Issue	Date	Issue	Date	Issue
	10/05/2023		10/05/2023	
	DR		CK	

**JAMES B. LENNOX & ASSOCIATES INC.**  
**LANDSCAPE ARCHITECTS**  
3332 CARLING AVE. OTTAWA, ONTARIO K2H 5A8  
Tel: (613) 722-5168 Fax: (866) 343-3942

PROJECT  
**PROPOSED DEVELOPMENT**  
1815 Montréal Rd, Gloucester, ON K1J 6N1

DRAWING  
**LANDSCAPE PLAN**

STAMP	SCALE
	AS SHOWN
	START DATE
	APRIL 2023
	PROJECT NO.
	23CSV2349
PROJECT NORTH	DRAWING NO.
	<b>L.1</b>
	PLOT SIZE ARCH-D