



845 CHAMPLAIN ST.

2023-07-26

RE-ZONING DRAFT : 23-07-26 PRE-CONSULT : 23-07-28 RE-ZONING APP. : 23-12-21

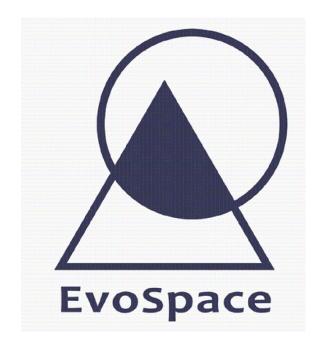



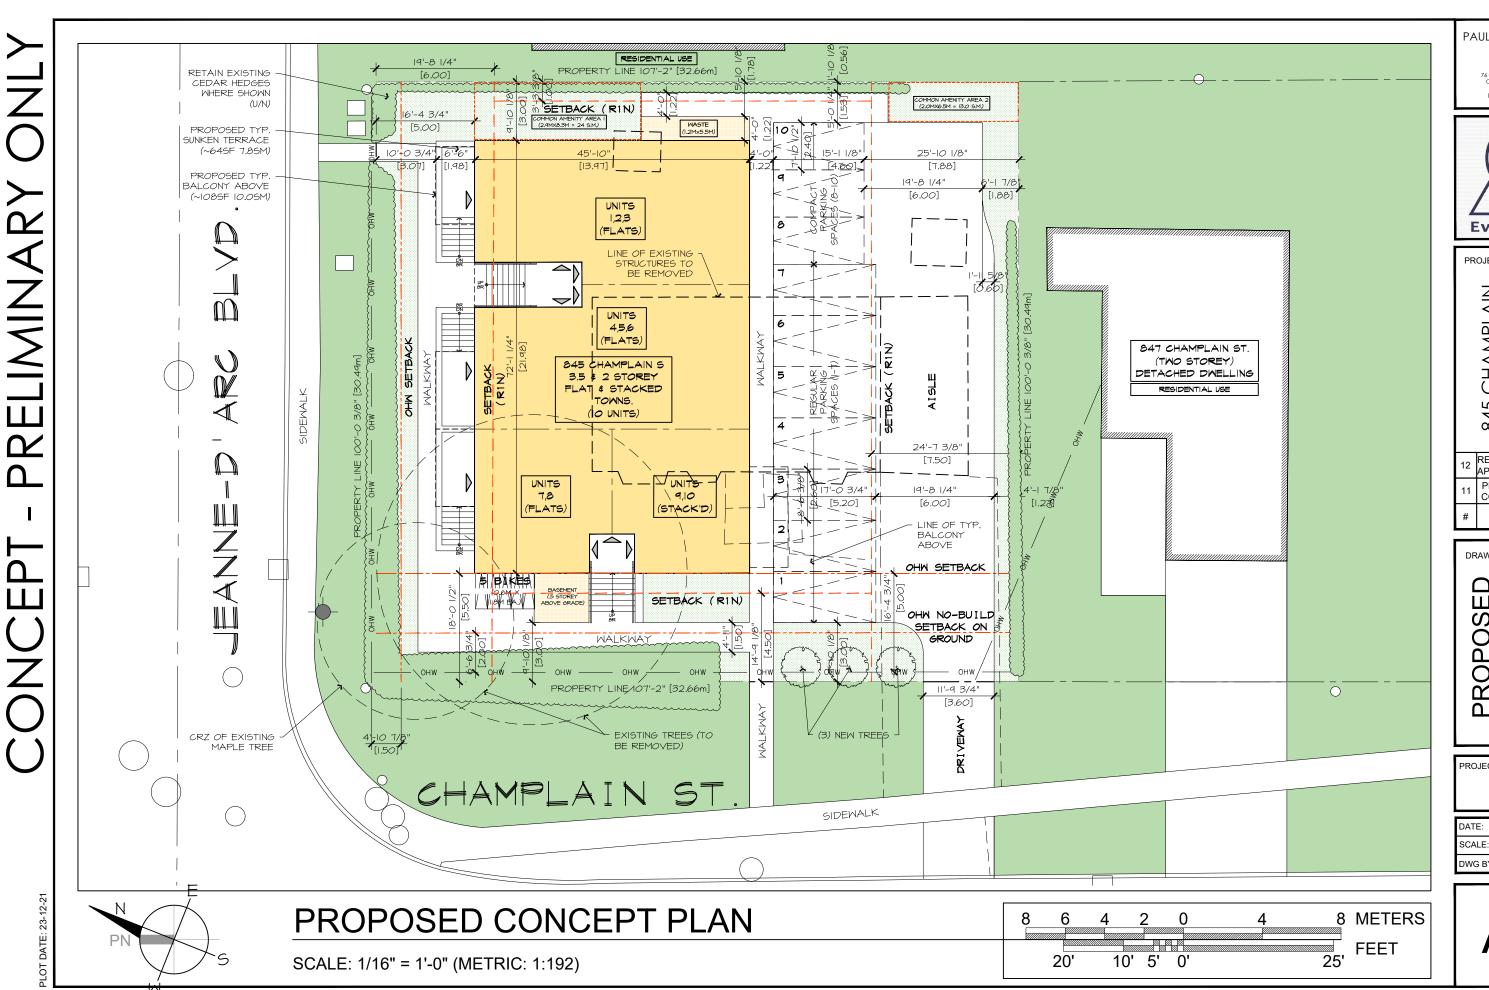

PAUL A. COOPER

76 CHAMBERLAIN AVE. OTTAWA, ONTARIO K1S 1V9 (819) 685 9512 Tel



PROJECT TITLE

845 CHAMPLAIN STREET ONI. OTTAWA,

12	RE-ZONING	2023
12	APPLICAT'N	12-21
11	PRE-APP.	2023
	CONSULT	10-18
#	RFV	2023
#	INLV.	XX-XX

DRAWING TITLE:

ED CONCEPT PLAN **PROPOS**

PROJECT No.

DATE:	23-02-20
SCALE:	NOTED
DWG BY:	P.A.C.

A0

PLOT DATE: 23-12-21

ZONING COMPLIANCE MATRIX

By-Law Section	Provision (Stacked Dwelling)	Required & Permitted	Proposed
Table 162A	Minimum lot width	18 m	30.49 m
Table 162A	Minimum lot area	540 m ²	995.8 m ²
Table 162A & 161(9)	Maximum building height	14.5 m and not more than 4 storeys	≤ 13.5 m (3.5 storeys)
Table 162A	Minimum front yard setback	6 m	5 m
Table 162A	Minimum corner side yard setback	4.5 m	3 m
Tables 162A & 162B Endnote 4	Minimum rear yard setback	1 m	12.11 m
Tables 162A & 162B Endnote 3	Minimum interior yard setback	3 m and the yard must be landscaped	3 m landscaped yard, with the exception of a communal waste storage room having a setback of 1.78 m
Table 65(5)(b)	Permitted projection into the front and corner side yard for fire escapes, open stairways, stoop, landing, steps and ramps	i) where at or below the floor level of the first floor:2. no closer than 0.6m to a lot line	3.07 m (front lot line)
Table 65(5)(c)	Permitted projection into the front and corner side yard for Covered or uncovered balcony, porch, deck, platform and verandah, with a maximum of two enclosed sides, excluding those covered by canopies and awnings	2 metres, but no closer than 1 metre from any lot line.	±1.98 m projection that is ±3.07 m from the front lot line
110(1)(a)	Minimum required landscaping buffer around	(a) abutting a street: 3 m	3 m
110(1)(u)	a parking lot of 10 or less spaces	(b) not abutting a street: none	NA
110(1)(b)	Minimum required landscaping within a parking lot	15%, and may consist of landscaped islands, landscaped medians, pedestrian pathways or public plazas	29.9% (125 m²)
161(8)	Minimum required landscaped area for a lot containing a stacked dwelling	30% of lot area	33.9% (337.8 m²)
By-law No. 2023- 435	(11) In the R1, R2, R3, R4, and R5 zones:	(a) No more than 70 per cent of the rear yard area may be occupied by parking spaces and driveways and aisles accessing parking.	70%
		(b) At least 15 per cent of the rear yard area must be provided as soft landscaping.	19%
137(5)	Minimum required communal amenity area may required landscaped buffer where it is aggregated.	NA - see Note 4	
		Total amenity required: 60 m ²	≥60 m² (private terraces, balconies, and porches)
137(6)	A stacked dwelling of 9 or more dwelling units requires a total amenity area of 6 m² per dwelling unit, with a minimum communal amenity area of 50% of the total amount required	Communal amenity required: 30 m²	37 m² (one space of 2 m² in the interior side yard and one space of 13 m² in the rear yard
		Layout of communal amenity area: aggregated into areas up to 54 m², and where more than one aggregated area is provided, at least one must be a minimum of 54 m²	NA - the total require amount of communal amenity area is less than 54 m² (30 m²), and so there is no requirement for the layout of the area.
Table 111A(b)(i)	Bicycle parking space rates: 0.5 per dwelling unit	5 spaces	5 spaces
107(1)(aa)(i)	Maximum width for a driveway providing access to a parking lot of less than 20 parking spaces	3.6 m	3.6 m

ZONING COMPLIANCE MATRIX (CONT'D)

107(1)(c)(ii)	In the case of a parking lot accessory to a residuances angled at between 56 and 90 degrees in		6 m
101(5)(d), 101(3)(a), Table 101	Minimum required parking for an Area C residential use building with an active entrance within 600 metres of a rapid transit station is based on Area X rates, being 0.5 per dwelling unit for a stacked dwelling. However, subsection 101(3)(a) states that within Area X no parking is required for the first twelve units of a residential use. In applying subsection 101(5)(d), although not specifically stated, the intent is for parking to not be required for the first 12 dwelling units.	0	10
102(5), 102(2), Table 102	Minimum required visitor parking for an Area C residential use building with an active entrance within 600 metres of a rapid transit station is based on Area X rates, being 0.1 per dwelling unit for a stacked dwelling However, subsection 102(5) states subsection 101(5)(d) applies with necessary modification to section 102 for the purposes of applying Table 102 and subsections 102(2) and 102(3). Subsection 102(2) states that no visitor parking is required for the first twelve dwelling units on a lot.	o	0
103(1)	Maximum Limit on Number of Parking Spaces within 600 metres of Rapid Transit Stations	Does not apply to stacked dwellings (for context purposes the maximum rate for apartments is 1.75 spaces per dwelling unit)	NA
106(3)	Maximum amount of parking spaces in a parking lot that may be reduced to a minimum of 4.6m long and 2.4m wide	50% (5 spaces as 10 are proposed)	3
Notes:	1. Vehicle and bicycle parking spaces are to co. 2. The proposed residential building will have a Place d'Orleans rapid transit station, which v at the transit station and the entrances of the once the new LRT station is operational. The 3. Although proposed, communal waste storag 4. Subsection 137(5) states: minimum required required landscaped buffer [emphasis add locations of the proposed communal amenity landscaping, however, none of those landscrequirement of Subsection 110(1)(a), that releas spaces and a street, which is not relevant to the text of the street of	active entrances located approximately will vary slightly depending on where the proposed building. This distance will e intent of provision 101(5)(d) is met. e is not required per Subsections 143(d communal amenity area may only be led] where it is aggregated into areas of a rea are within yards (interior side an aping requirements are "buffer" specifiquires a 3 m landscape buffer between to to the locations of the proposed contractions will be a supposed to the locations of the proposed contractions will be a supposed to the locations of the proposed contractions are supposed to the locations of the proposed contractions are supposed to the locations of the proposed contractions are supposed to the locations of the proposed contractions are supposed to the locations of the proposed contractions are supposed to the locations of the proposed contractions are supposed to the locations of the proposed contractions are supposed to the locations of the proposed contractions are supposed to the locations of the proposed contractions are supposed to the locations of the proposed contractions are supposed to the locations of the proposed contractions are supposed to the locations of the proposed contractions are supposed to the locations of the proposed contractions are supposed to the locations of the proposed contractions are supposed to the locations are supposed to t	600 metres from the e measurement is take shorten by 100 metres b)(iii) and 143(d). included as part of a of 54 m² or more. The drear) requiring c, except for the n a parking lot of 10 or mmunal amenity area.

BUILDING STATISTICS

DEVELOPMENT INFORMATION	DWELLING UNIT (DU	MIX INFORMATION
LOT AREA:	BASEMENT: IST FLOOR:	3 UNITS (3 FLATS) 3 UNITS (3 FLATS)
EXISTING LOT AREA=~10720 G.S.F. (996 S.M.) BUILDING AREAS:	2ND FLOOR: 3RD FLR. (STACKED)	4 UNITS (2 FLATS & STACKED)
EXISTING STRUCTURE FOOTPRINT= ~1433 G.S.F. (~133 G.S.M.)	BARRIER FREE:	O UNITS TOTAL
PROPOSED IO UNIT TOWNHOUSE BUILDING FOOTPRINT= ~3306 G.S.F. (~307 G.S.M.)	TOTAL:	IO DWELLING UNITS (TOWNHOMES)

<ed)< td=""><td>3 UNITS (3 FLATS) 3 UNITS (3 FLATS) 4 UNITS (2 FLATS & STACKED)</td><td>UNIT #I (FLAT): UNIT #2 (FLAT): UNIT #3 (FLAT): UNIT #4 (FLAT): UNIT #5 (FLAT):</td><td>~1035 6.5.F. (96 6.5.M.) ~1035 6.5.F. (96 6.5.M.) ~1102 6.5.F. (102 6.5.M.) ~1035 6.5.F. (106 6.5.M.) ~1102 6.5.F. (102 6.5.M.)</td></ed)<>	3 UNITS (3 FLATS) 3 UNITS (3 FLATS) 4 UNITS (2 FLATS & STACKED)	UNIT #I (FLAT): UNIT #2 (FLAT): UNIT #3 (FLAT): UNIT #4 (FLAT): UNIT #5 (FLAT):	~1035 6.5.F. (96 6.5.M.) ~1035 6.5.F. (96 6.5.M.) ~1102 6.5.F. (102 6.5.M.) ~1035 6.5.F. (106 6.5.M.) ~1102 6.5.F. (102 6.5.M.)
	O UNITS TOTAL	UNIT #6 (FLAT):	~1035 G.S.F. (96 G.S.M.)
	IO DWELLING UNITS (TOWNHOMES)		~1126 G.S.F. (105 G.S.M.) ~1053 G.S.F. (98 G.S.M.) ~1089 G.S.F. (101 G.S.M.) ~1089 G.S.F. (101 G.S.M.)

Accordingly, the locations of the proposed communal amenity area do not conflict with Subsection 137(5).

TOTAL DWELLING UNIT AREA:

~10749 G.S.F. (999 G.S.M.)

PAUL A. COOPER

76 CHAMBERLAIN AVE. OTTAWA, ONTARIO K1S 1V9 (819) 685 9512 Tel.



PROJECT TITLE 845 CHAMPLAIN STREET OTTAWA, ONT.

12 RE-ZONING 2023 APPLICAT'N 12-21 PRE-APP. 2023 CONSULT 2023 REV. XX-XX

DRAWING TITLE:

DEVELOPMENT INFORMATION

PROJECT No. :

DATE: 23-02-20 SCALE: NOTED DWG BY: P.A.C.







PROJECT TITLE 845 CHAMPLAIN STREET OTTAWA, ONT.

REV.

DRAWING TITLE: UNIT FLOOR **PROPOSED**

PROJECT No. :

23-02-20 NOTED DWG BY: P.A.C.

|E=======| BDRM. #2 12'-6" X 9'-10" COMBO 31'-5" X 13'-4" SUNKEN **TERRACE** 5'-5" X 15'-6" (84SF-7.8SM) BDRM. #1 11'-6" X 9'-10" **EN-SUITE** BATH 5'-0" X 10'-7" 6'-0" X 10'-7" W.I.C. 6'-6" X M&E 5'-5" X 4'-3" FURN.

> BASEMENT (FLAT) (3 BEDROOM):

> > GROSS FLOOR AREA: ~1255 SQFT. (117 M²)

8 METERS


FEET

0' 5' 10'

UNIT #1 - BASEMENT FLR. PLAN - FLAT (END UNIT)

SCALE: 3/16" = 1'-0"

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PROJECT TITLE 845 CHAMPLAIN STREET OTTAWA, ONT.

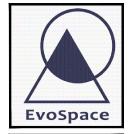REV.

DRAWING TITLE: PROPOSED UNIT FLOOR PLAN

PROJECT No. :

23-02-20 NOTED DWG BY: P.A.C.

EEEEEEEE CL. BDRM. #2 10'-6" X 10'-2" COMBO 34'-6" X 12'-9" **BALCONY** 6'-5" X 16'-9" (108SF-10.0SM) BDRM. #1 EN-SUITE 5'-0" X 7'-6" BATH 10'-6" X 10'-2" **ENTRY** 6'-0" X 7'-6" 4'-6" X 7'-10" **MASTER** BDRM. PRLANDING LANDING 9'-5" X 7'-6"

UNIT #2 - MAIN FLOOR PLAN - FLAT (END UNIT)

SCALE: 3/16" = 1'-0"

8 METERS FEET 0' 5' 10'

MAIN FLOOR (FLAT) (3 BEDROOM):

GROSS FLOOR AREA: ~1182 SQFT. (110 M²)

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PROJECT TITLE

845 CHAMPLAIN STREET OTTAWA,

11	PRE-APP.	2023
11	CONSULT	10-18
#	RFV	2023
#	INLV.	XX-XX

DRAWING TITLE:

UNIT FLOOR **PROPOSED**

PROJECT No. :

23-02-20 NOTED DWG BY: P.A.C.

DEEEEEEEEE CATHEDRAL CEILING W.I.C. 6'-6" X 7'-4" BATH **EN-SUITE** BDRM. #2 6'-0" X 5'-0" X 11'-0" 11'-0" 12'-2" X 11'-0" BDRM. 14'-2" X 11'-0" MEZZANINE CO/ 13O 34'-6" X 13'-4" (ABOVE) 12'-0" X 21'-5" (~155 SF) BDRM. #1 BALCONY CATHEDRAL 10'-6" X 10'-4" 6'-5" X 16'-9" LINE OF MEZZANINE (108SF-10.0SM) CL. LINE OF ENTRY WALLS BELOW

> 2ND FLOOR (FLAT) (3 BEDROOM):

GROSS FLOOR AREA: \sim 1296 SQFT. (120 M^2) + MEZZANINE ~155 SQFT. (14 M²)=

~1451 SF (135 SM)

PLOT DATE: 23-10-18

UNIT #3 - SECOND FLOOR PLAN - FLAT (END UNIT)

SCALE: 3/16" = 1'-0"

8 METERS FEET 0' 5' 10'

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PROJECT TITLE

845 CHAMPLAIN STREET OTTAWA, ONT.


PRE-APP. 2023 CONSULT 10-18 REV.

DRAWING TITLE:

PROPOSED UNIT FLOOR

PROJECT No. :

23-02-20 NOTED P.A.C. DWG BY:

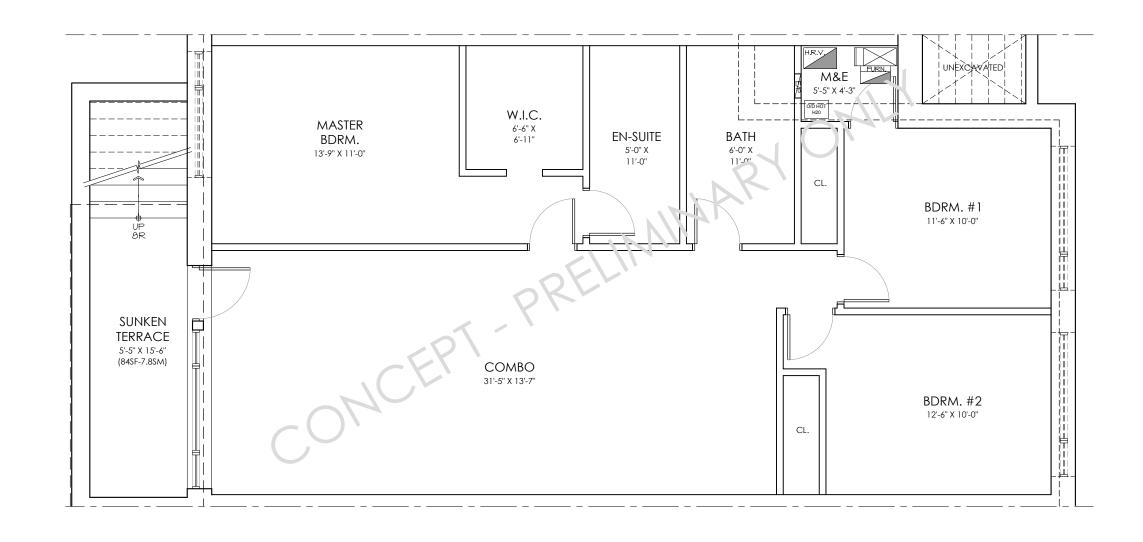

(3 BEDROOM):

BASEMENT (FLAT)

GROSS FLOOR AREA: \sim 1259 SQFT. (117 M^2)

8 METERS FEET 0' 5' 10'

UNIT #4 - BASEMENT FLOOR PLAN - FLAT

SCALE: 3/16" = 1'-0"

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PROJECT TITLE

845 CHAMPLAIN STREET OTTAWA, ONT.

11	PRE-APP. CONSULT	2023 10-18
#	REV.	2023 XX-XX

DRAWING TITLE:

PROPOSED UNIT FLOOR PLAN

PROJECT No. :

MAIN FLOOR (FLAT) (3 BEDROOM):

GROSS FLOOR AREA: \sim II82 SQFT. (IIO M^2)


8 METERS

FEET

0' 5' 10'

DATE:	23-02-20
SCALE:	NOTED
DWG BY:	P.A.C.

A5

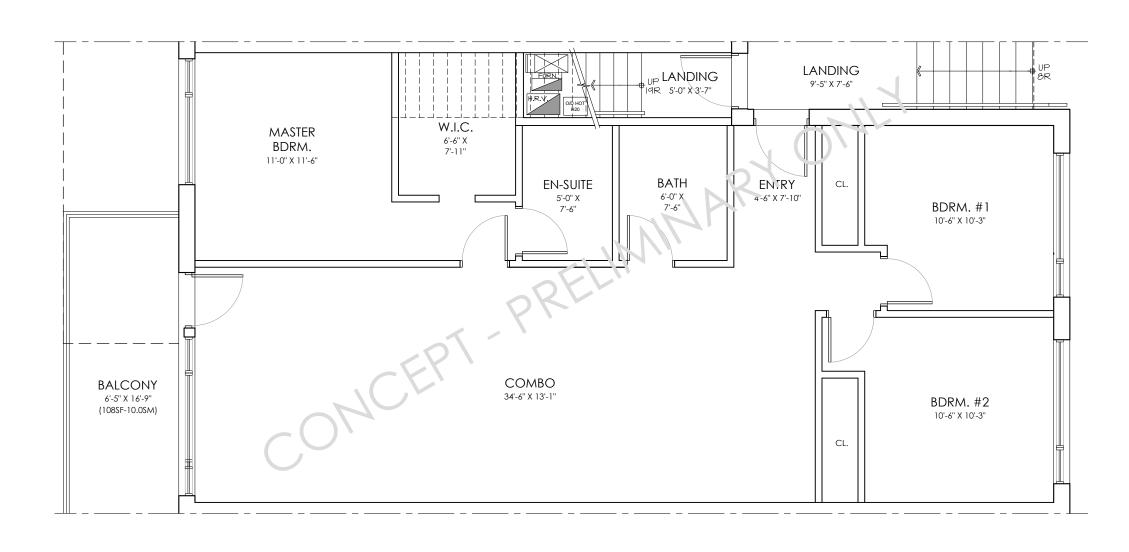

UNIT #5 - MAIN FLOOR PLAN - FLAT

SCALE: 3/16" = 1'-0"





845 CHAMPLAIN STREET OTTAWA, ONT.

11 PRE-APP. 2023 CONSULT 10-18 # REV. 2023 XX-XX

PROPOSED UNIT FLOOR PLAN

PROJECT No. :

2ND FLOOR (FLAT) (3 BEDROOM):

GROSS FLOOR AREA:

8 METERS

FEET

0' 5' 10'


DATE: 23-02-:

DATE: 23-02-20

SCALE: NOTED


DWG BY: P.A.C.

A6

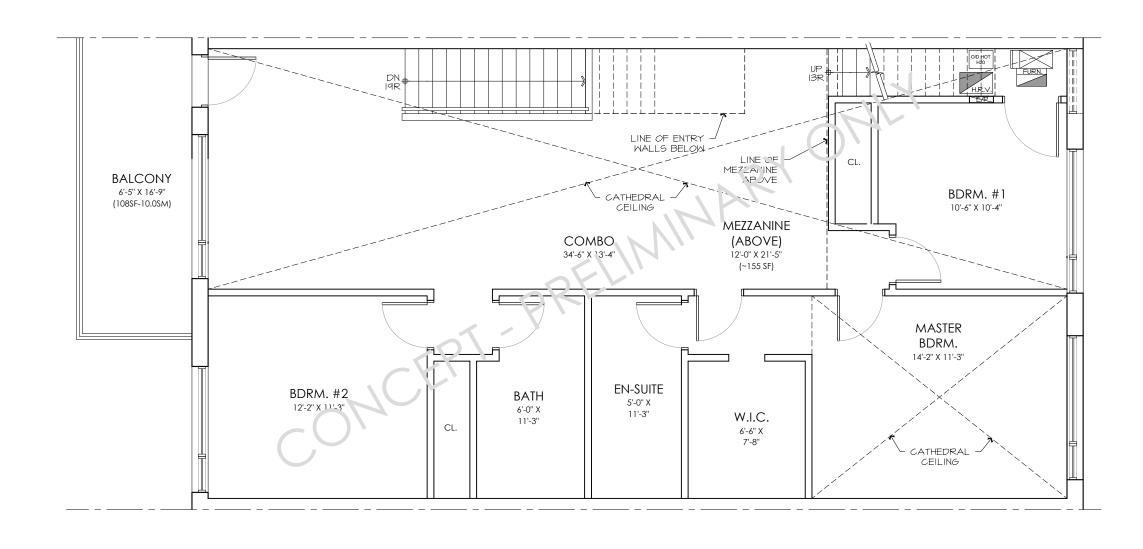


 \sim 1296 SQFT. (120 M²) + MEZZANINE \sim 155 SQFT. (14 M²)= \sim 1451 SF (135 SM)

UNIT #6 - SECOND FLOOR PLAN - FLAT

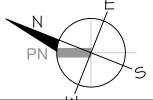

PLOT DATE: 23-10-18

PLOT DATE: 23-10-18

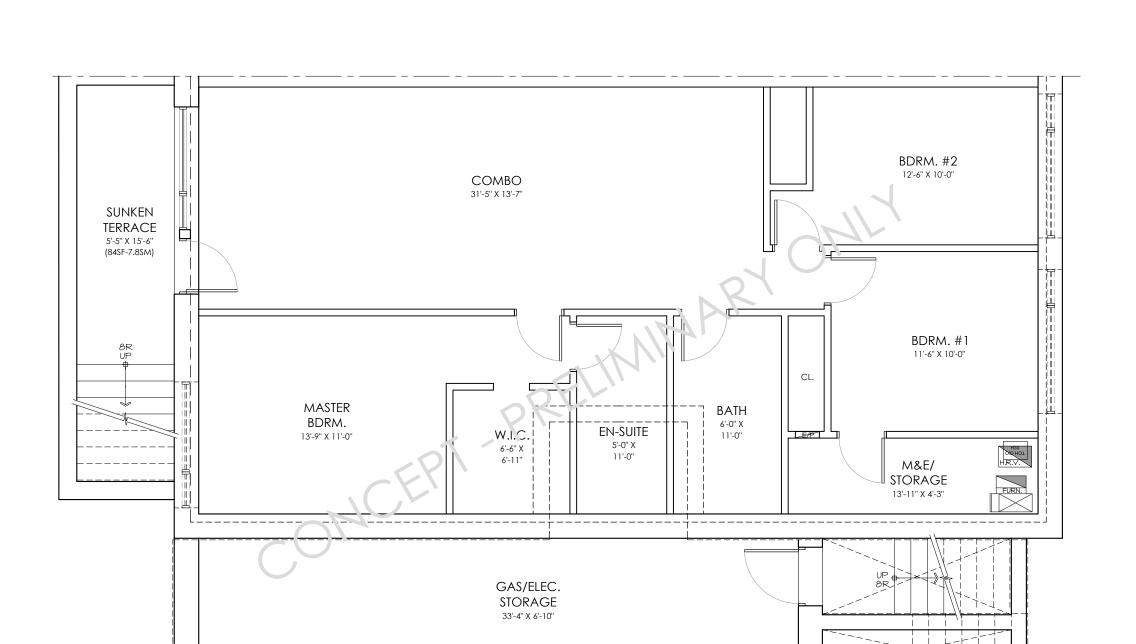

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PROJECT TITLE

845 CHAMPLAIN STREET OTTAWA, ONT.

11	PRE-APP. CONSULT	2023 10-18
#	REV.	2023 XX-XX

DRAWING TITLE:

PROPOSED UNIT FLOOR PLAN

PROJECT No. :

BASEMENT (FLAT) (3 BEDROOM):

GROSS FLOOR AREA: \sim 1267 SQFT. (118 M^2)


8 METERS

FEET

0' 5' 10'

DATE:	23-02-20
SCALE:	NOTED
DWG BY:	P.A.C.

UNIT #7 - BASEMENT FLOOR PLAN - FLAT

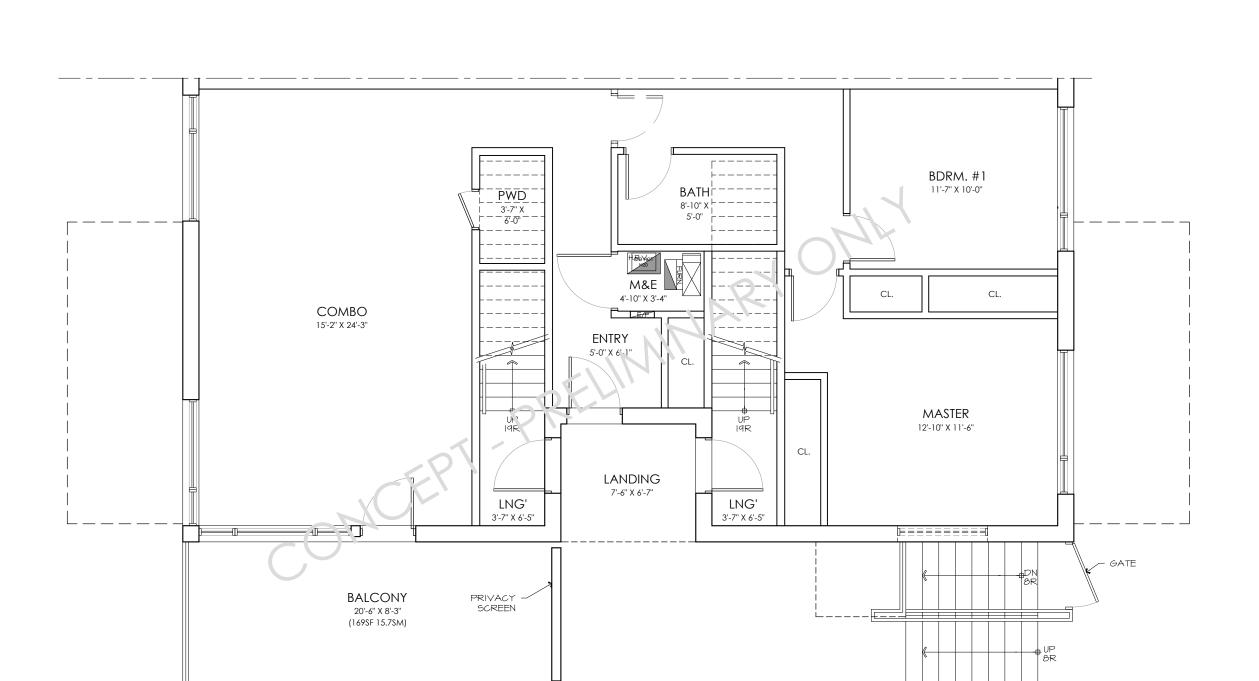

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845 CHAMPLAIN STREET OTTAWA, ONT.

11 PRE-APP. 2023 CONSULT 10-18 # REV. 2023 XX-XX

PROPOSED UNIT FLOOR PLAN

PROJECT No. :

_		
0	ATE:	23-02-20
S	CALE:	NOTED
С	WG BY:	P.A.C.

A8

UNIT #8 - MAIN FLOOR PLAN - FLAT

SCALE: 3/16" = 1'-0"

S


PLOT DATE: 23-10-18

0 2 4 6' 8 METERS 0' 5' 10' 20' FEET

MAIN FLOOR (FLAT)
(2 BEDROOM):

UNIT #8

GROSS FLOOR AREA: ~1096 SQFT. (102 M²)

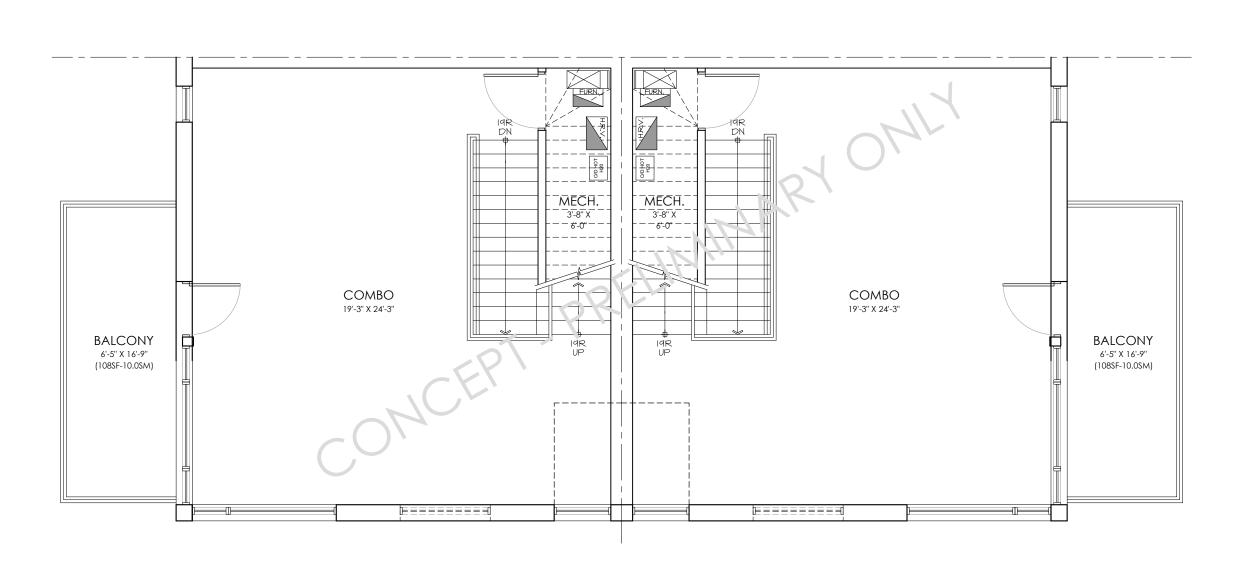

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PROJECT TITLE

845 CHAMPLAIN STREET OTTAWA, ONT.

11 PRE-APP. 2023 CONSULT 10-18 # REV. 2023 XX-XX

PROPOSED UNIT FLOOR PLAN

DRAWING TITLE:

PROJECT No. :

 DATE:
 23-02-20

 SCALE:
 NOTED

 DWG BY:
 P.A.C.

Д9

2ND FLOOR (STACKED) (2 BEDROOM):


UNITS #9 & #10

GROSS FLOOR AREA: 2ND:~637 SQFT. (59 M²)+ 3RD:~637 SQFT. (59 M²)=

8 METERS

FEET


0' 5' 10'

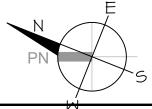

PLOT DATE: 23-10-18

UNITS #9 & #10 - 2ND FLOOR PLAN - STACKED

PLOT DATE: 23-10-18

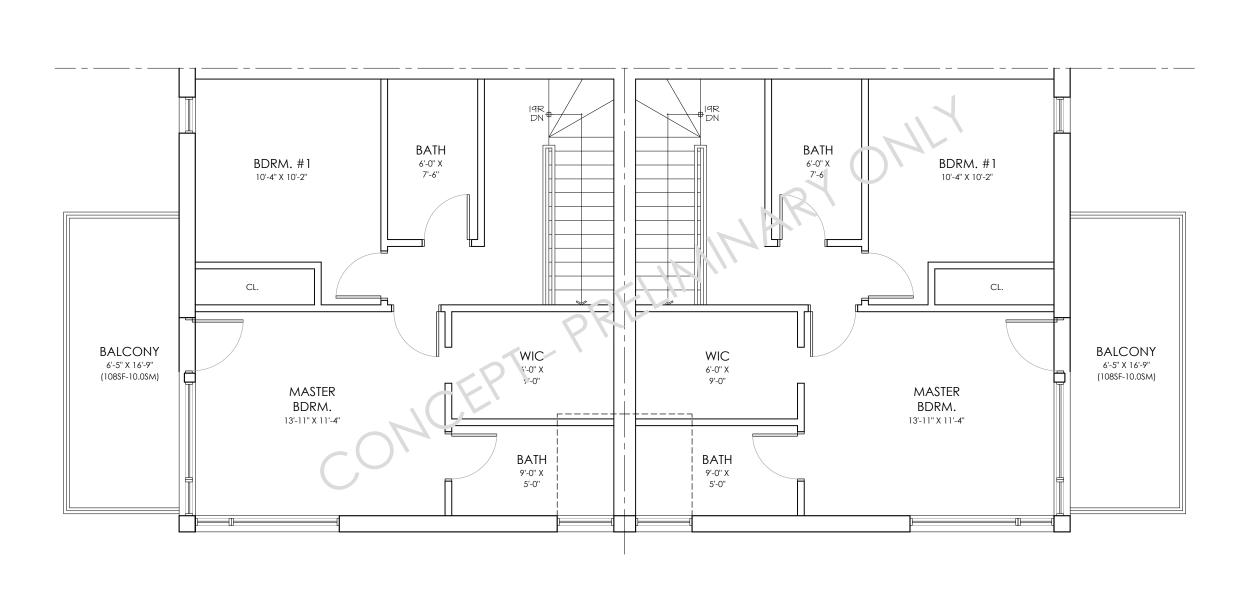

PAUL A. COOPER
ARCHITECT

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PROJECT TITLE

845 CHAMPLAIN STREET OTTAWA, ONT.

11 PRE-APP. 2023 CONSULT 10-18 # REV. 2023 XX-XX

DRAWING TITLE:

PROPOSED UNIT FLOOR

PROJECT No. :

 DATE:
 23-02-20

 SCALE:
 NOTED

 DWG BY:
 P.A.C.

A10

2ND FLOOR (STACKED) (2 BEDROOM): UNITS #9 & #10

GROSS FLOOR AREA: 2ND:~637 SQFT. (59 M²)+ 3RD:~637 SQFT. (59 M²)=

FEET

0' 5' 10'

8 METERS

 $\frac{\mathsf{UN}}{\mathsf{UN}}$

UNITS #9 & #10 - THIRD FLOOR PLAN - STACKED



RE-ZONING 2023 APPLICAT'N 12-21

BUILDING HEIGHT

23-02-20 NOTED P.A.C.



PROJECT TITLE

845 CHAMPLAIN STREET OTTAWA, ONT.

RE-ZONING 2023 APPLICAT'N 12-21 PRE-APP. REV.

DRAWING TITLE:

PROPOSED BUILDING HEIGHT

PROJECT No.

METERS

FEET

10'

20'


DATE:	23-02-20
SCALE:	NOTED
DWG BY:	P.A.C.


A12

PROPOSED SECTION 2 - LOOKING WEST

SCALE: 1/8" = 1'-0"

SCALE: 1/16" = 1'-0"

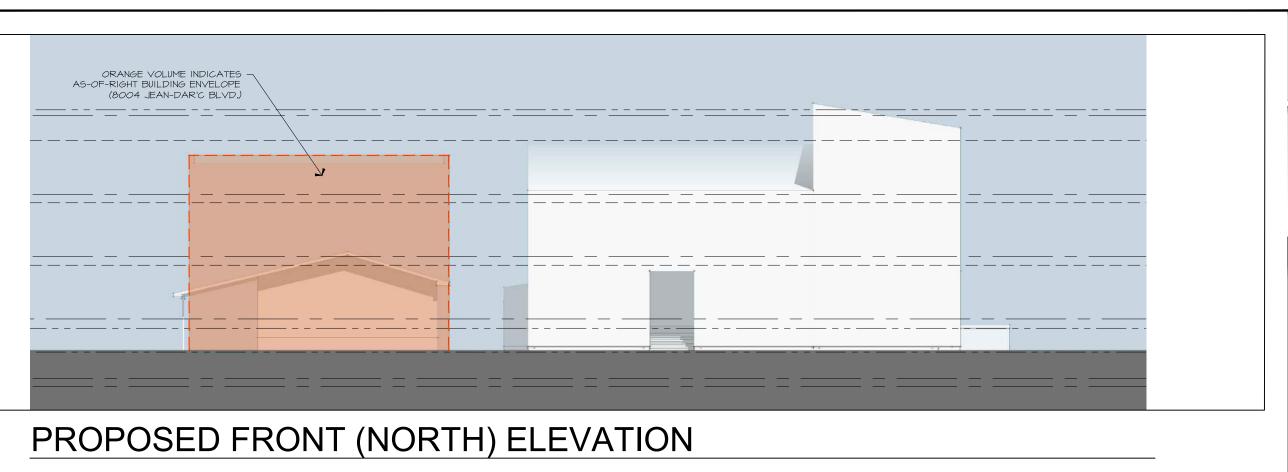

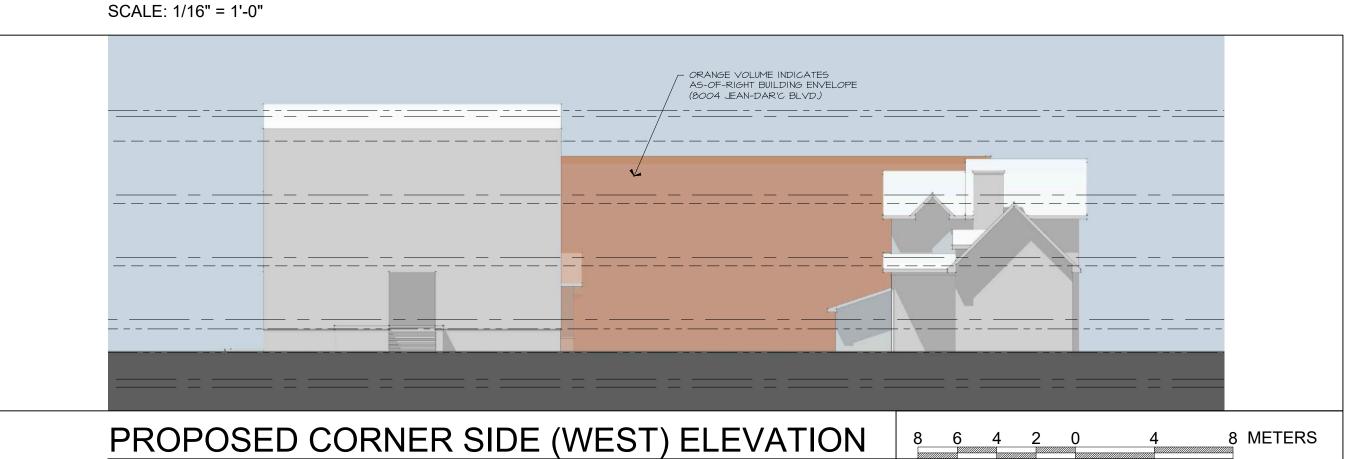

PAUL A. COOPER ARCHITECT

76 CHAMBERLAIN AVE.

76 CHAMBERLAIN AVE. OTTAWA, ONTARIO K1S 1V9 (819) 685 9512 Tel



PROJECT TITLE

845 CHAMPLAIN STREET OTTAWA, ONT.

12 RE-ZONING 2023 APPLICAT'N 12-21 11 PRE-APP. 2023 CONSULT 10-18 # REV. 2023 XX-XX

DRAWING TITLE:

MASSING ELEVATION

PROJECT No.


DATE:	23-02-20
SCALE:	NOTED
DWG BY:	P.A.C.


A13

FEET 25'

10' 5' 0'

SCALE: 1/16" = 1'-0"

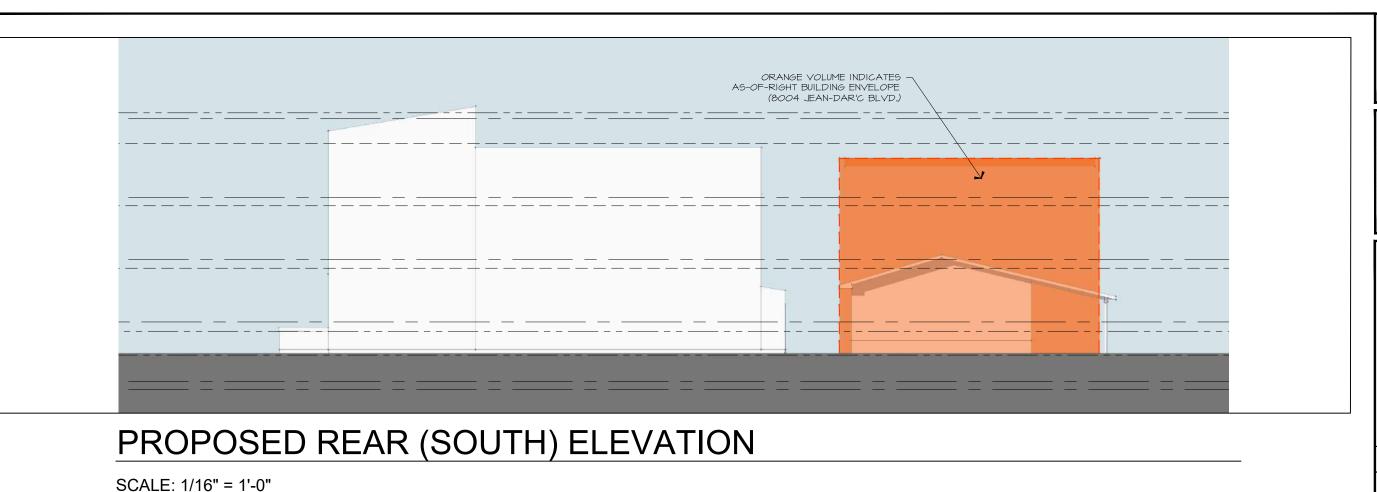

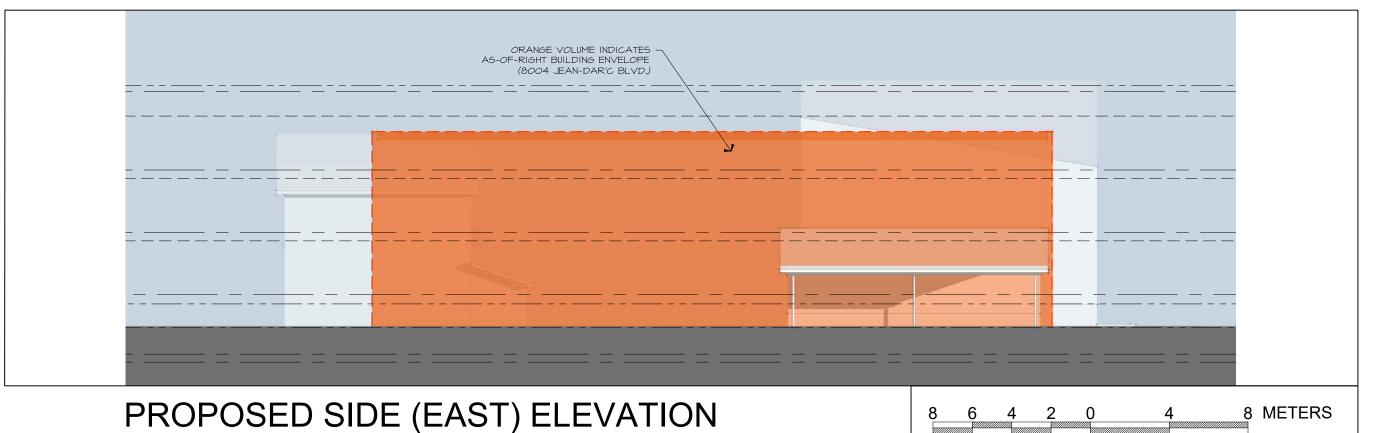

PAUL A. COOPER ARCHITECT

76 CHAMBERLAIN AVE. OTTAWA, ONTARIO K1S 1V9 (819) 685 9512 Tel



PROJECT TITLE

845 CHAMPLAIN STREET OTTAWA, ONT.

RE-ZONING 2023 APPLICAT'N 12-21 PRE-APP. REV.

DRAWING TITLE:

ELEVATION MASSING


PROJECT No. :

8 METERS

FEET

10' 5' 0'

DATE:	23-02-20
SCALE:	NOTED
DWG BY:	P.A.C.

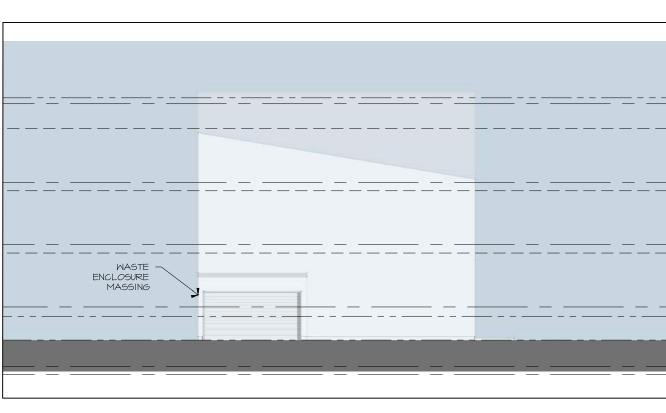


PERS. 1

SCALE: N.T.S.


PROPOSED WASTE ELEVATION

SCALE: 1/16" = 1'-0" (METRIC: 1:192)

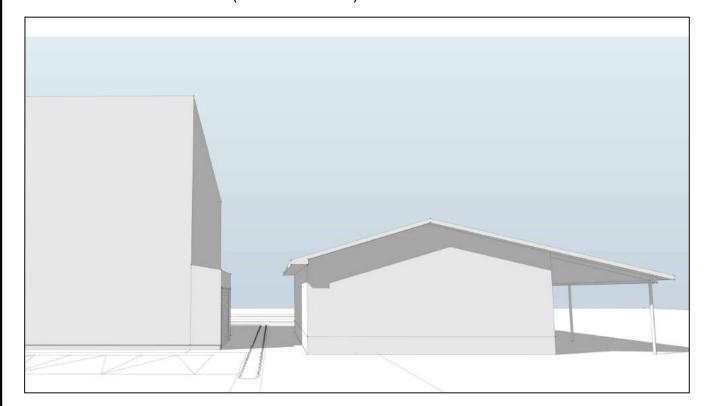

PERS. 2

SCALE: N.T.S.

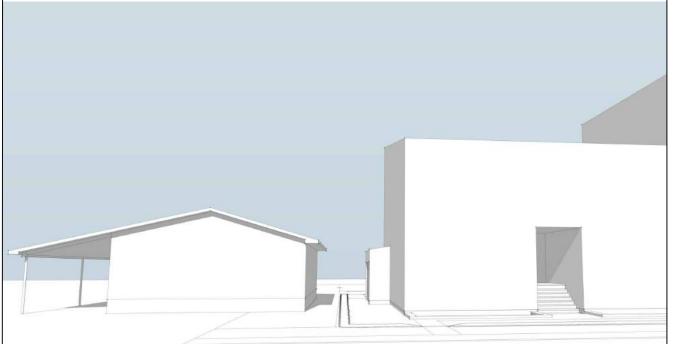

PERS. 3	8	6	4	2	0	4	8	METERS	
SCALE: N.T.S.		20'	10	D' 5'	0'		25'	FEET	

PAUL A. COOPER
ARCHITECT

76 CHAMBERLAIN AVE.
OTHAWA. ONTARIO
KIS 1/19



845 CHAMPLAIN STREET OTTAWA, ONT.

12 RE-ZONING 2023 APPLICAT'N 12-21 11 PRE-APP. 2023 CONSULT 10-18 # REV. 2023 XX-XX

MASTE ENCLOSURE

PROJECT No. :

DATE:	23-02-20			
SCALE:	NOTED			
DWG BY:	P.A.C.			

A15