

EXISTING TREE LIST KEY										
KEY	BOTANICAL NAME	COMMON NAME	SIZE	CRITICAL ROOT ZONE	OWNERSHIP	CONDITION	ACTION			
1-AF	Acer x freemanii	Freeman's Maple	90mm DBH	900mm	City of Ottawa	POOR	TO REMAIN			
1-AN	Acer negundo	Manitoba Maple	90mm DBH	1500mm	226 Preston	GOOD	TO REMAIN			
1-RC	Rhamnus cathartica	Common Buckthorn	150mm DBH	1000mm	119 Balsam	GOOD	TO REMAIN			
1-SR	Syringa reticulata	Japanese Tree Lilac	150mm DBH	9000mm	119 Balsam	GOOD	TO REMAIN			
1-UW	Ulmus wilsoniana 'Prospector'	Prospector Elm	110mm DBH	1100mm	City of Ottawa	POOR	TO REMAIN			


KEY	QTY.	BOTANICAL NAME	COMMON NAME	SIZE	CONDITION	REMARKS	
TRE	ES						
SB	1	Amelanchier canadensis	Serviceberry	60mm cal.	B&B	Single leader	


GENERAL NOTES:

- 1. It is the responsibility of the appropriate contractor or official to report any errors, omissions or discrepancies on this plan with actual site conditions to the Landscape Architect before proceeding with construction.
- 2. The contractor is to notify all utility companies and authorities prior to any excavation and ascertain locations of underground services.
- 3. The contractor is to reinstate all areas and items damaged as a result of construction activity.
- 4. The contractor is to comply with all pertinent codes and by-laws.
- 5. The contractor is to maintain a positive surface run-off throughout the entire construction period.
- 6. The Landscape Architect is not responsible for subsurface conditions.
- 7. The contractor is to identify all existing trees to remain on site with the Landscape Architect prior to construction.
- 8. The contractor is to stake the proposed location of all plant material in conjunction with the Landscape Architect prior to excavation.
- 9. Minimum distances for selected deciduous trees are as follows:
- Building Foundations 7.5m
- Sidewalks 1.5m Public Streets 2.5m
- Underground Infrastructure 2.0m
- 10. All trees within 1m of underground utility trenches are to be excavated by hand.
- 11. Remove all protective wrapping from tree trunks after installation.
- 12. Staking of trees shall only be performed if necessary.
- 13. Ensure that mulch is pulled back a min. distance of 75mm from base of tree trunk.

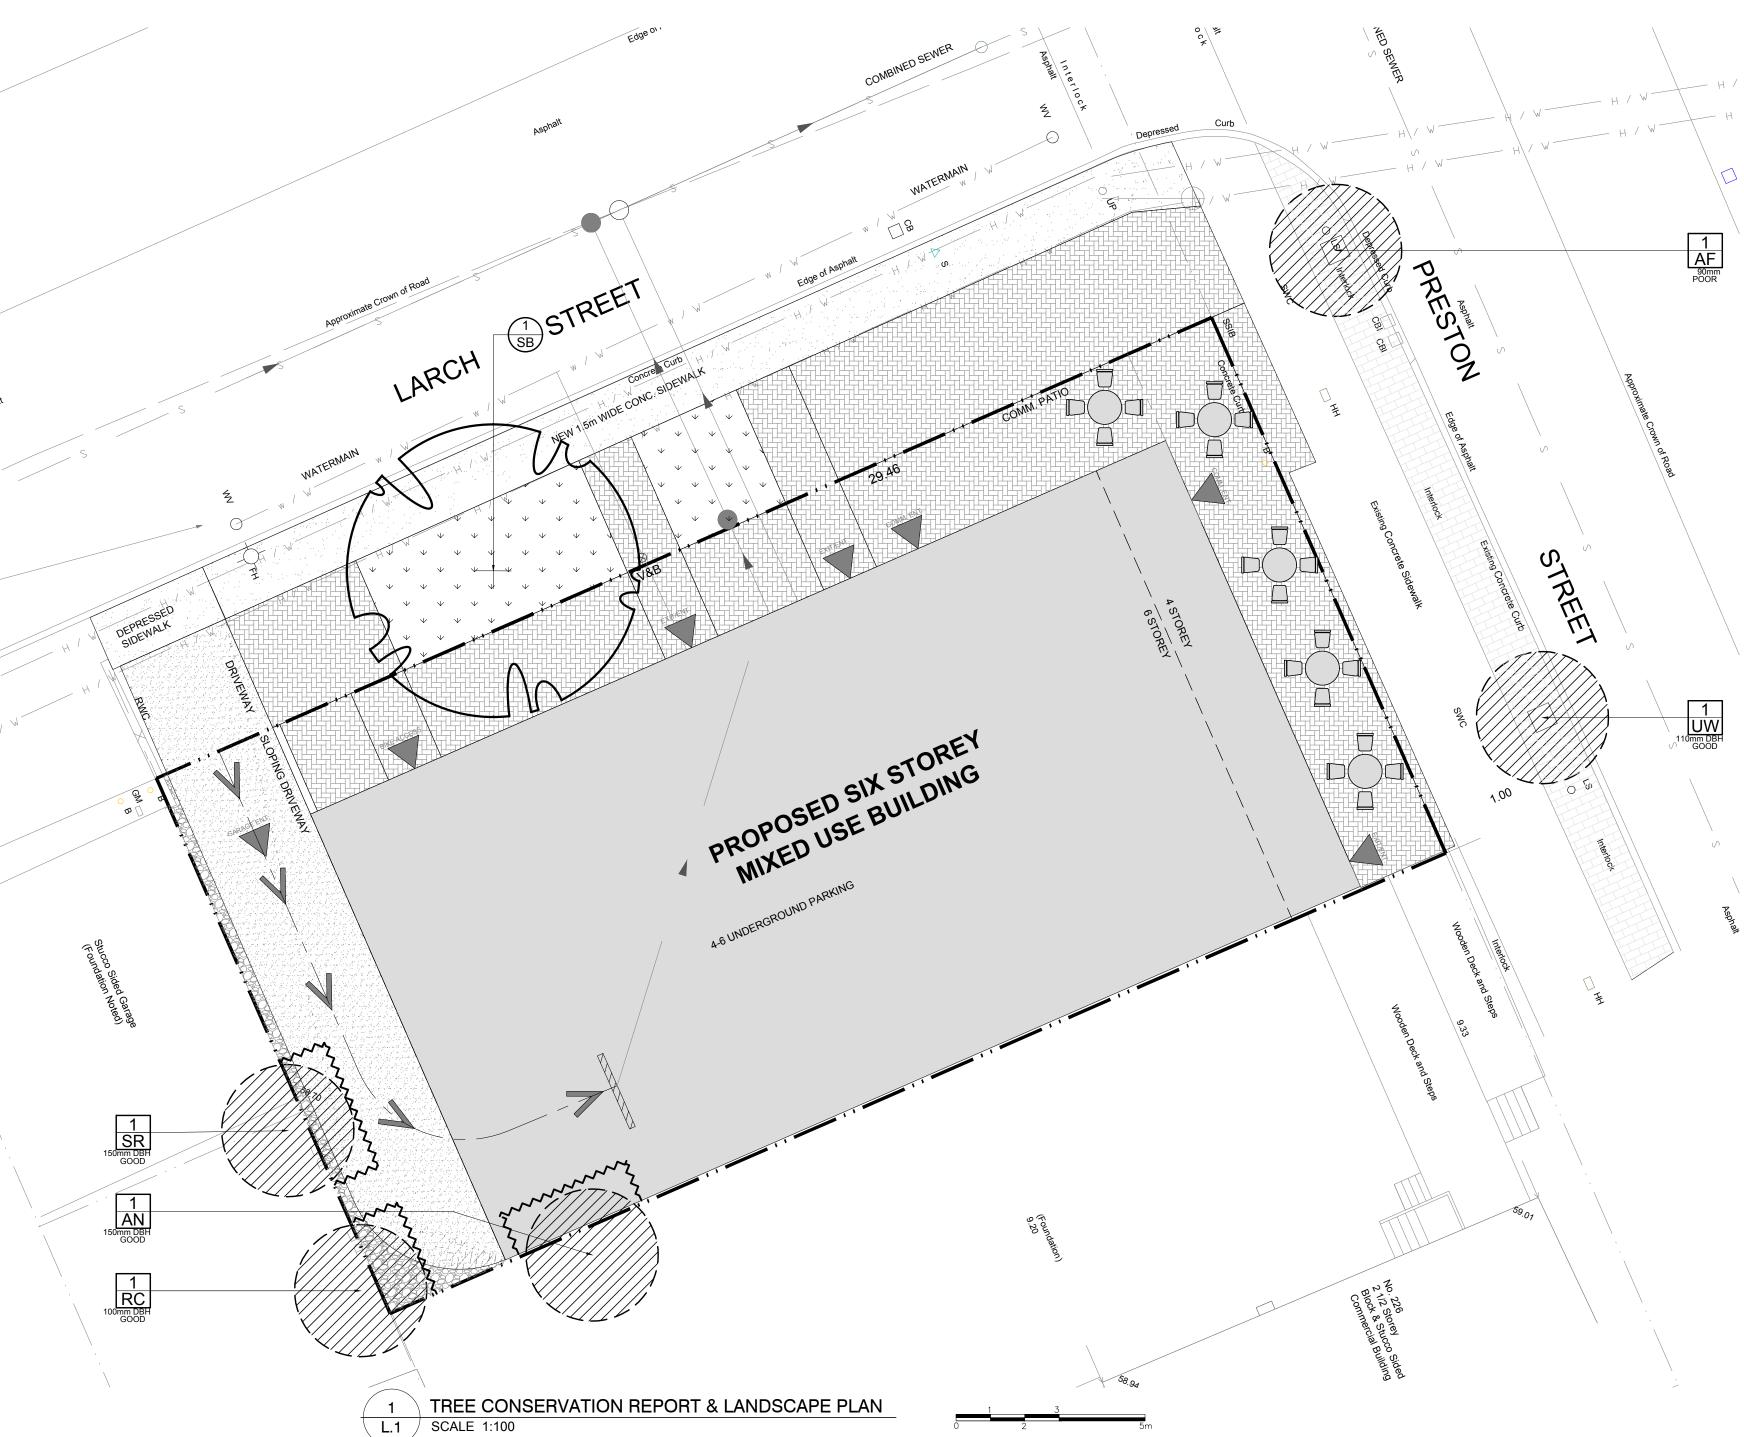

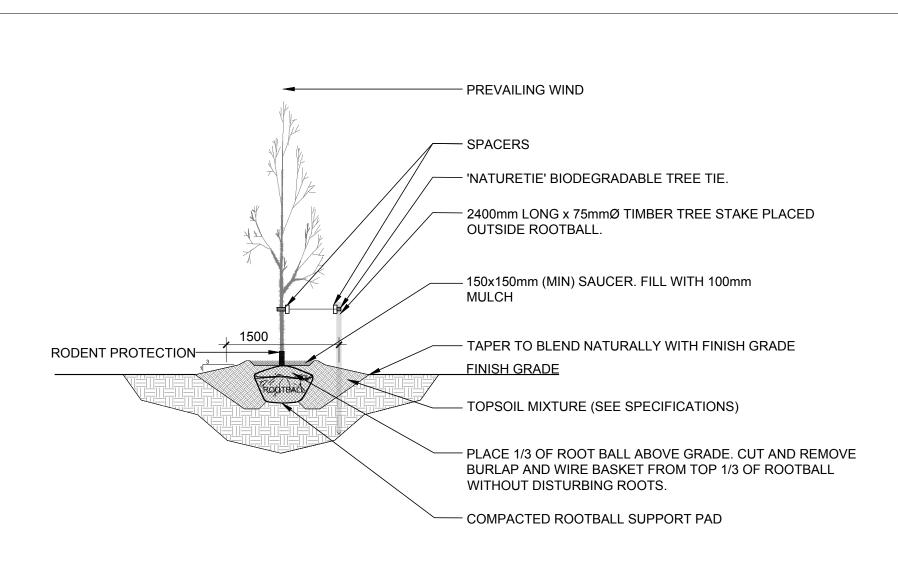

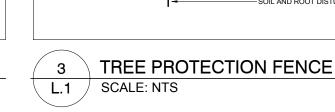

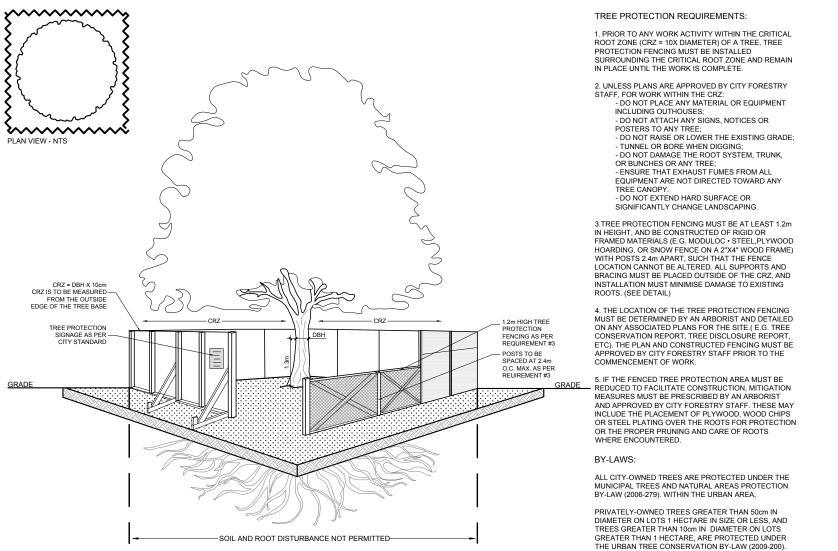





ANNIS, O'SULLIVAN, VOLLEBEKK LTD.


14 Concourse Gate, Suite 500
Nepean, Ont. K2E 756
Phone: (613) 727-0850 / Fax: (613) 727-1079

Email: Managan@anutel.com Nepean, Ont. K2E 7S6 Phone: (613) 727-0850 / Fax: (613) 727-1079 Email: Nepean@aovltd.com


exp Services Inc.

t: +1.613.688.1899 | f: +1.613.225.7330 2650 Queensview Drive, Unit 100 Ottawa, ON K2B 8H6 www.exp.com


LEGEND

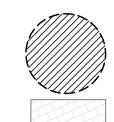

EXISTING TREE TO REMAIN

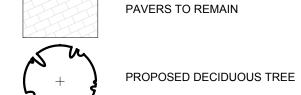


EXISTING PRECAST CONCRETE

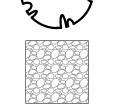

PROPOSED RIVERSTONE



PROPOSED PRECAST CONCRETE **PAVERS**

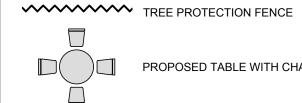


PROPOSED TABLE WITH CHAIRS

REVISED PER NEW SITE PLAN 03/15/2023 ML 3 11/16/2022 ML 3 ISSUED FOR DISCUSSION & REVIEW Date DR CK

JAMES B. LENNOX & ASSOCIATES INC. LANDSCAPE ARCHITECTS 3332 CARLING AVE. OTTAWA, ONTARIO K2H 5A8 Tel. (613) 722-5168 Fax. 1(866) 343-3942

PROPOSED SIX STOREY MIXED USE BUILDING 224 PRESTON STREET, OTTAWA ON


TREE CONSERVATION REPORT & LANDSCAPE PLAN

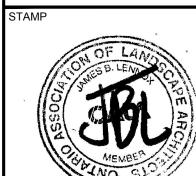

SCALE AS SHOWN TART DATE

NOVEMBER 2022 PROJECT NO. 23MIS2308

PROJECT NORTH

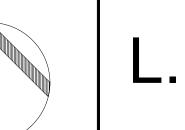

DRAWING NO.

2 DECIDUOUS TREE PLANTING L.1 SCALE: NTS