
LONG TERM CARE FACILITY - ORLEANS

	LEGE	ND	
DESCRIPTION	EXISTING	ABANDONED	NEW
	SEWE	ERS	
SANITARY	250 S	AB 250 S	250 S
STORM	375 ST	AB 375 ST	——375 ST———
COMBINED	300 C	AB 300 C	300 C
MANHOLE CATCH BASIN	O MH □ CB		
DITCH INLET CB	□ DICB		■ DICB
TWIN INLET CB	☐ TICB		■ TICB
CULVERT			
SANITARY SERVICE	——— S		<u> </u>
STORM SERVICE CLEANOUT	ST O co		ST O CO
CURB INLET CB	□ CICB		□ CICB
TWIN CURB INLET CB	☐ TCICB		™ TCICE
	WAT	1	
MANHOLE	— — 150 W — —	— — AB 150 W— —	
MANHOLE VALVE	O WMH		<u> </u>
TAP SLEEVE & VALVE	Ψ 11 Y		⊖ ⊖ TS&V
FIRE HYDRANT	↔ FH.		
BLOW-OFF	∘ B0		ÓB0
PRIVATE SERVICE	——— W		—-W
SERVICE VALVE	⊕ WSV GA	<u> </u>	⊗ WSV
MAIN		AB 100 G	
VALVE	⊖ GV		
	BEL	L	
BURIED	В ——	AB B	
MANHOLE PEDESTAL, OPI	O BMH		
POLE (GUY)	B ← →		
	HYD	RO	
BURIED	——— н ———	AB H	— н —
MANHOLE DOLE (OLIV)	Онмн		● HMH1
POLE (GUY) LIGHT	н •——>		H ←→>
TRANSFORMER	· L		
VAULT			V
	CABLE		
BURIED PEDESTAL	TV — TV PED	AB TV	CTV
POLE	• TV		TV ●
	TRAF	FIC	
BURIED	—— т ———	AB T	
MANHOLE	Отмн		● TMH1
JUNCTION BOX CONTROLLER	□ JB □□ TC		□JB1 □□ TC
POLE	<u> </u>		● T1
	PAVEN	MENT	
CONCRETE	CONC		
ASPHALT ASPH ON CONC	ASPH ASPH/CONC		
PAVING STONE	PAVER		
TAR AND CHIP	TAR & CHIP		
GRAVEL	GRAV		
OIDEWAY!	MISCELLA	ANEOUS	
SIDEWALK (CONC. or ASPH.) SIGN	CSW ASW		
TREE(dia) or BUSH	(·) 300 × 300 (·)		
HEDGE			
FENCE	XXX	,	×—×—×—
GATE	XXX		
BOREHOLE	⊕ BH ⊕ AH		
AUGERHOLE PROPERTY BAR	⊕ AH ⊡ IB ⊡ SIB ⊡ RIB		
NAIL	□ NAIL		
CONCRETE MONUMENT	⊡ MON		
GROUND ELEVATION	176.25		176.25

IN THE CITY OF OTTAWA, ONTARIO


ARCH CORPORATION

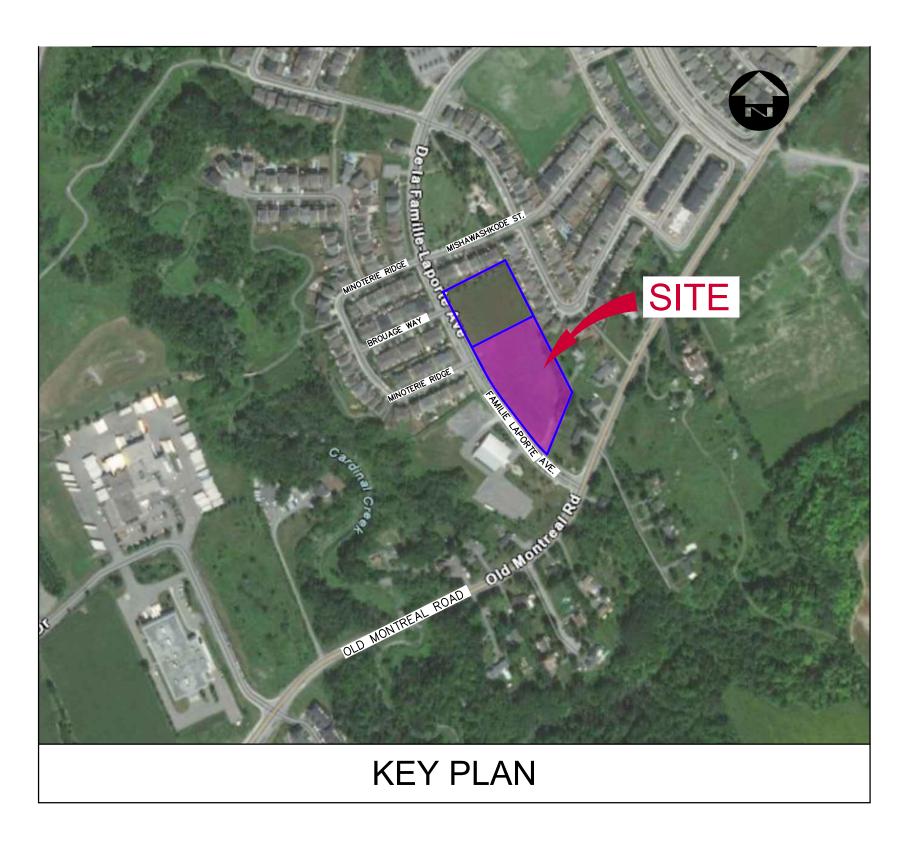



BENCH MARKS


INDEX				
SHEET	DESCRIPTION			
	COVER SHEET			
CIV-1	SITE SERVICING PLAN			
CIV-2	SITE GRADING PLAN			
CIV-3	SOIL EROSION CONTROL PLAN			
CIV-4	NOTES, CROSS SECTION AND DETAILS			
CIV-5	NOTES AND MISCELLANEOUS DETAILS			

ALL EXISTING INVERTS TO BE FIELD CHECKED PRIOR TO CONSTRUCTION

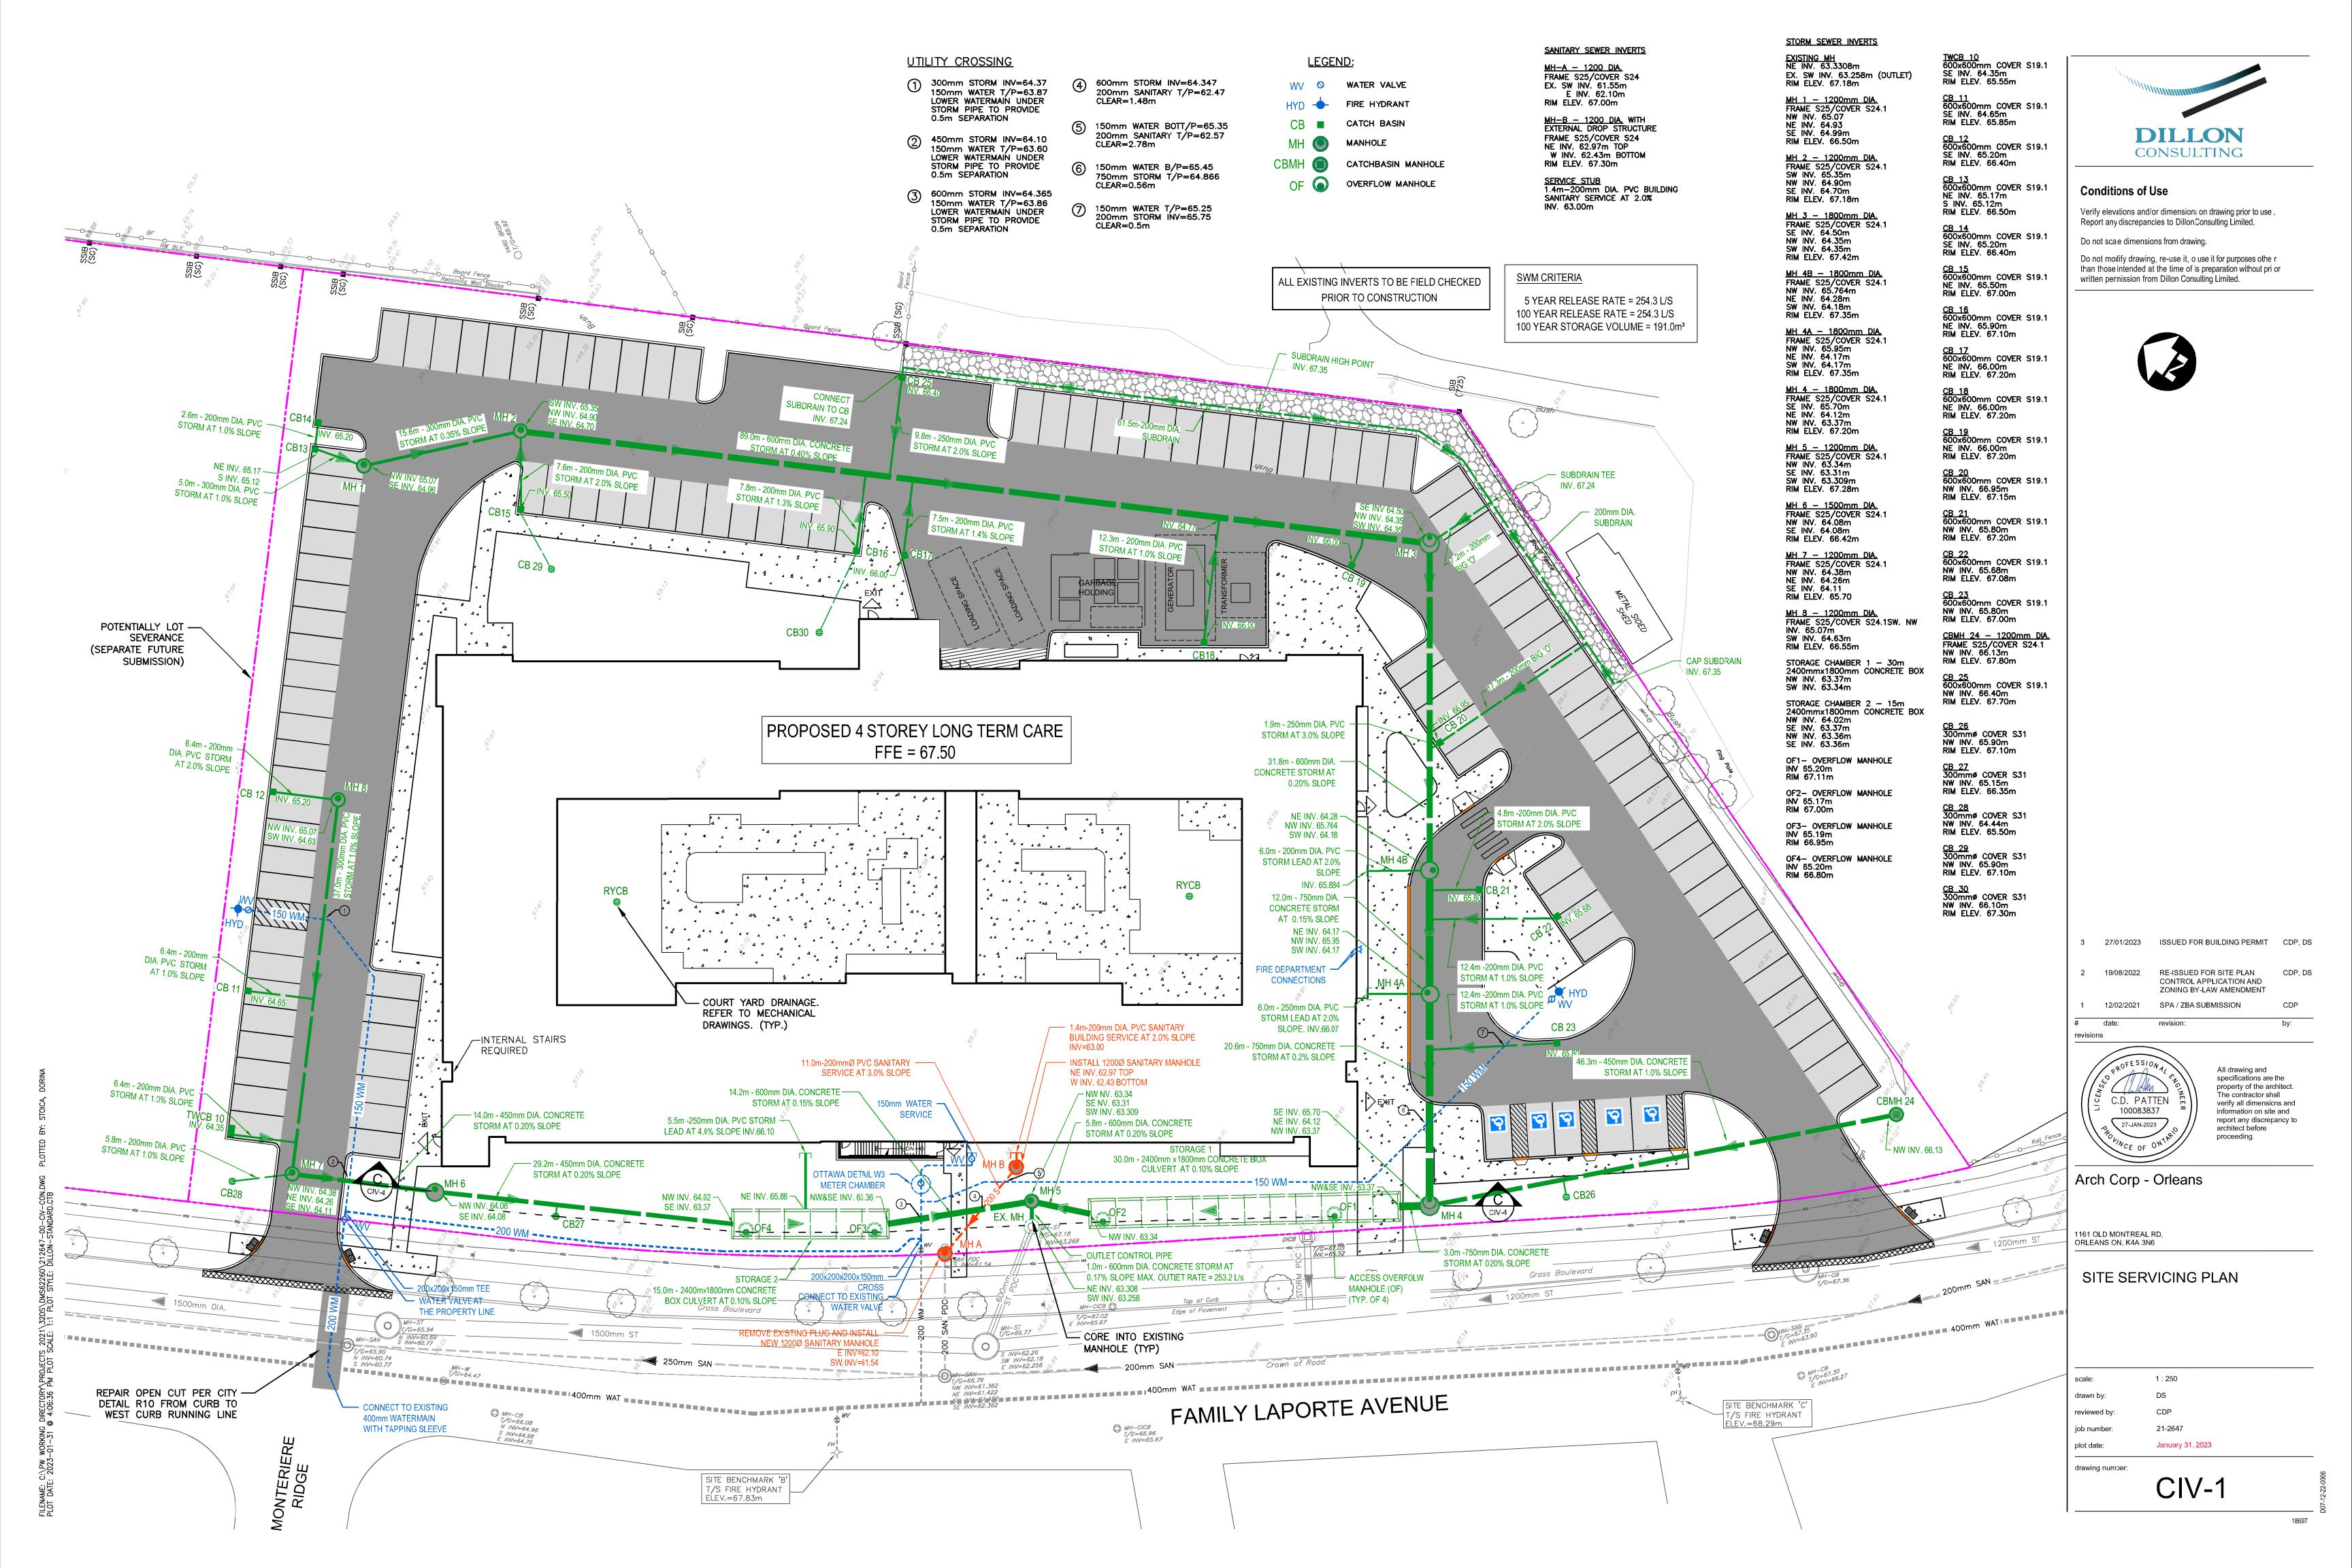

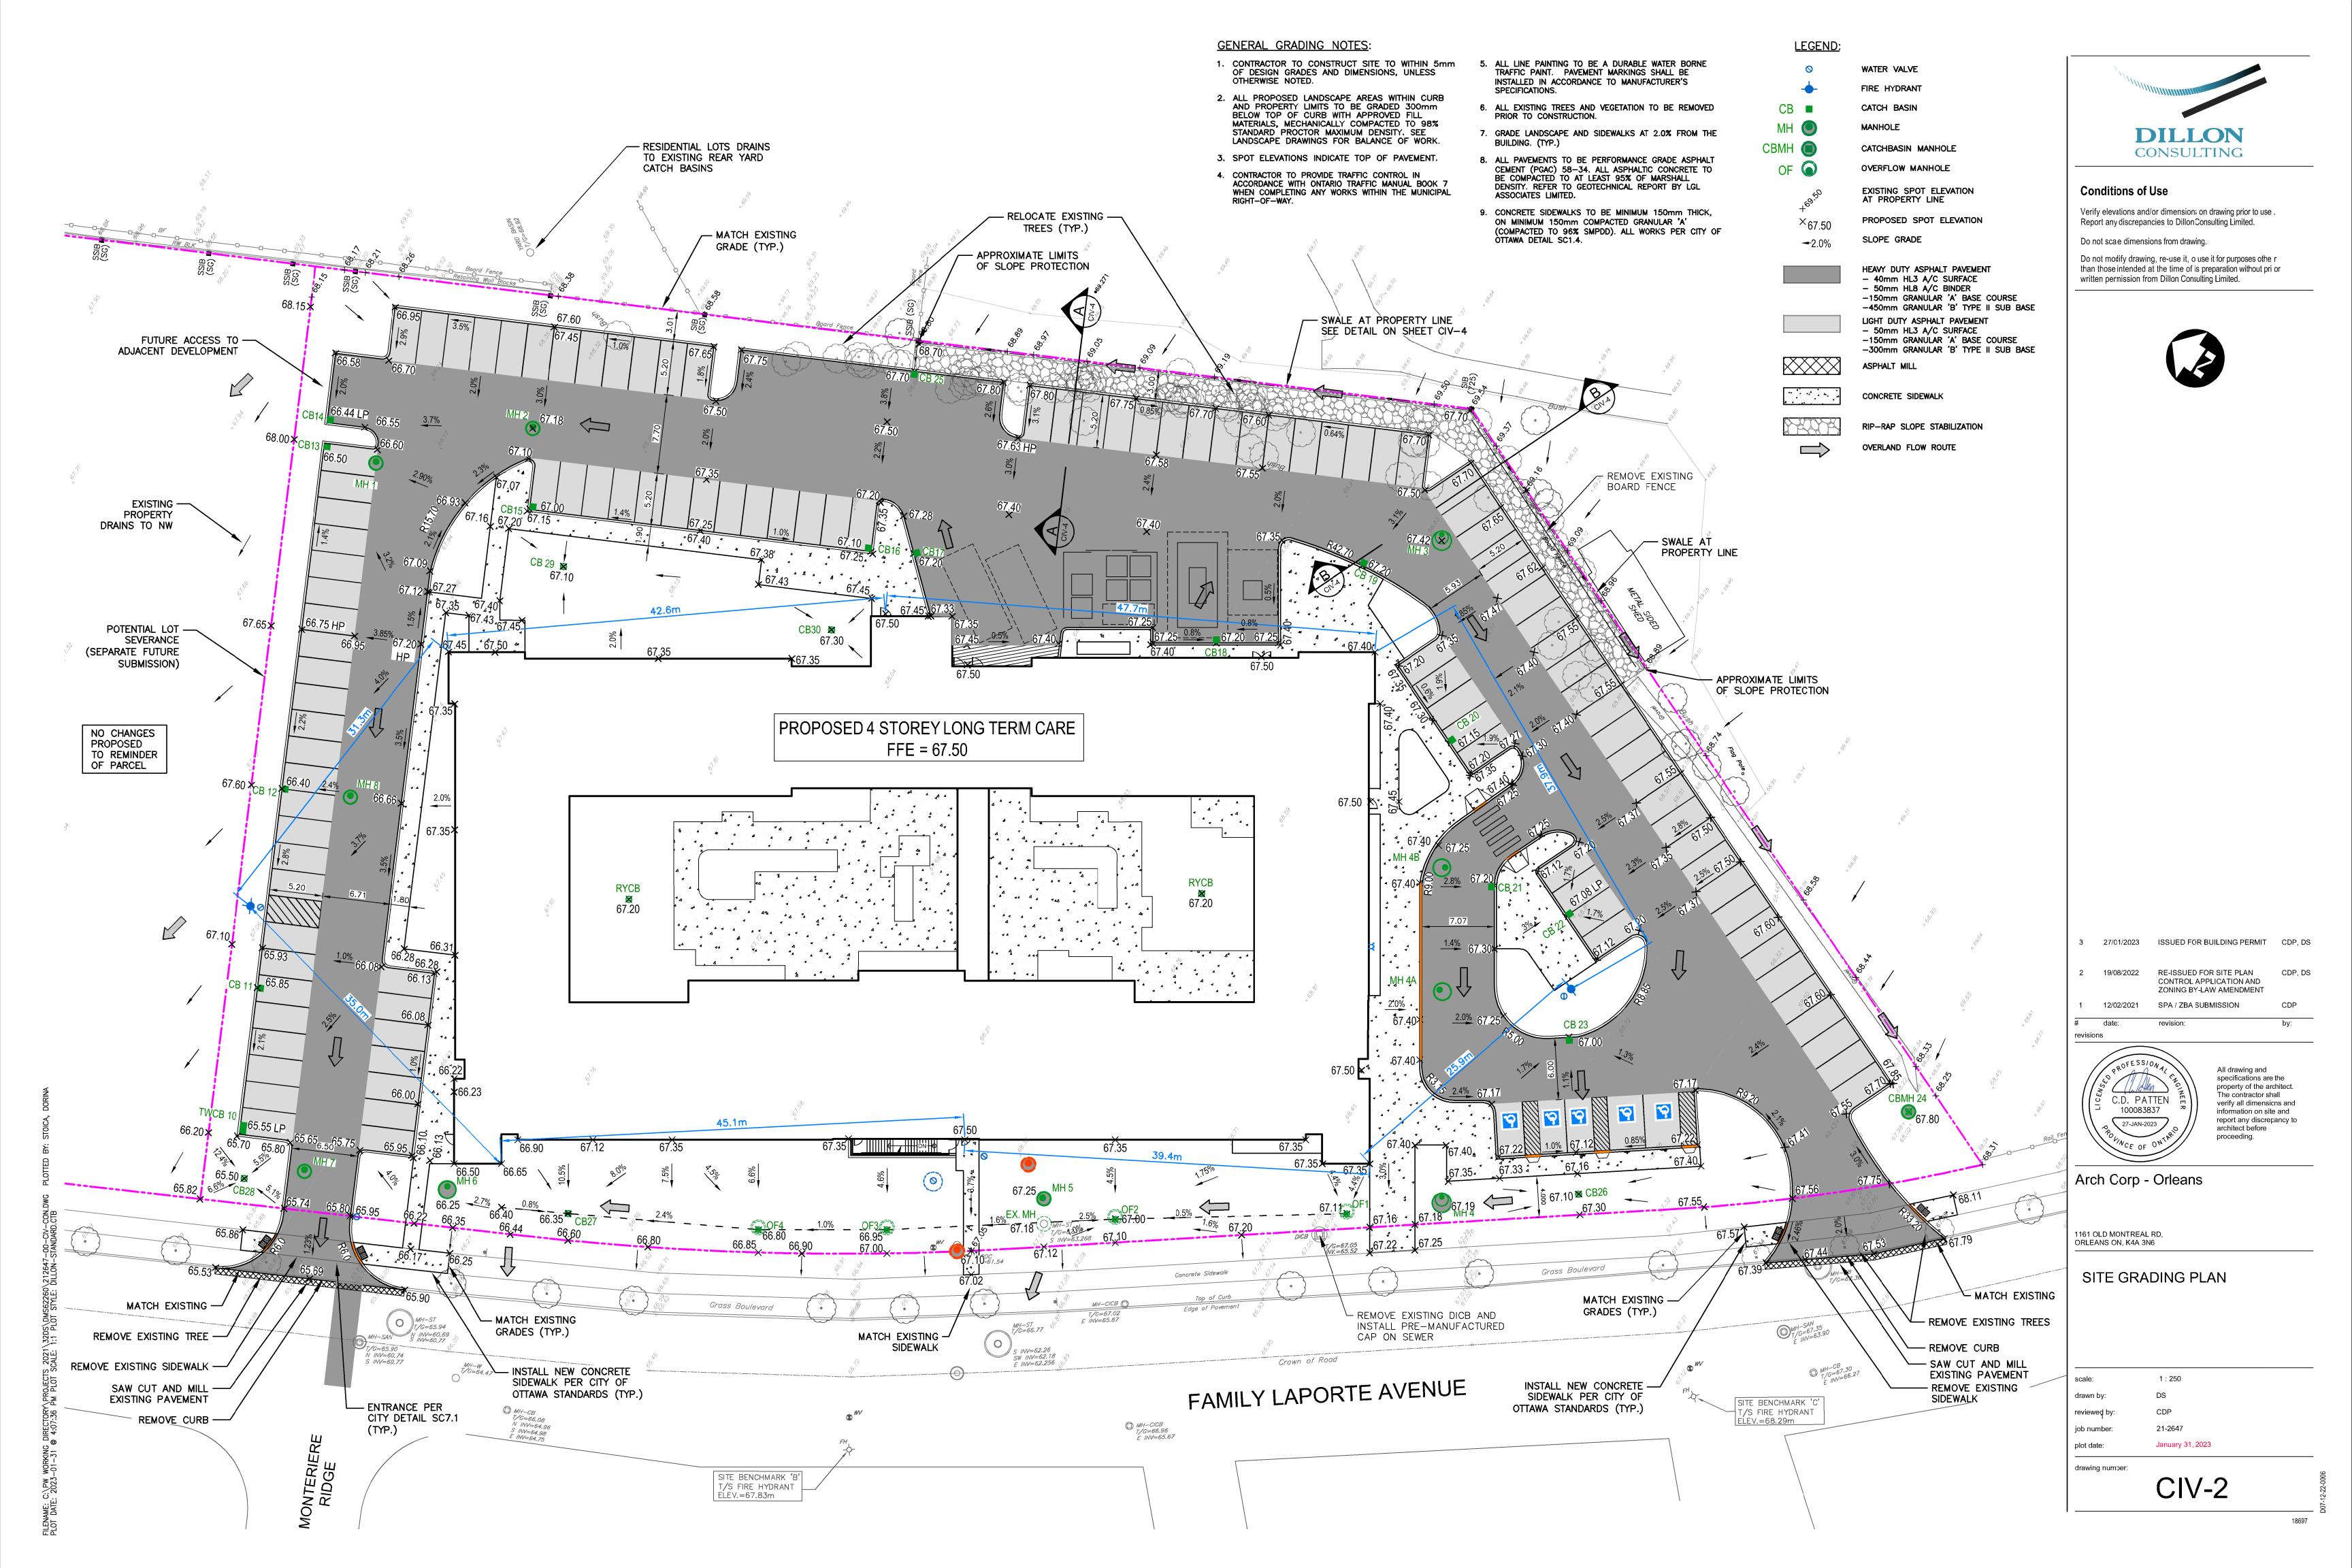


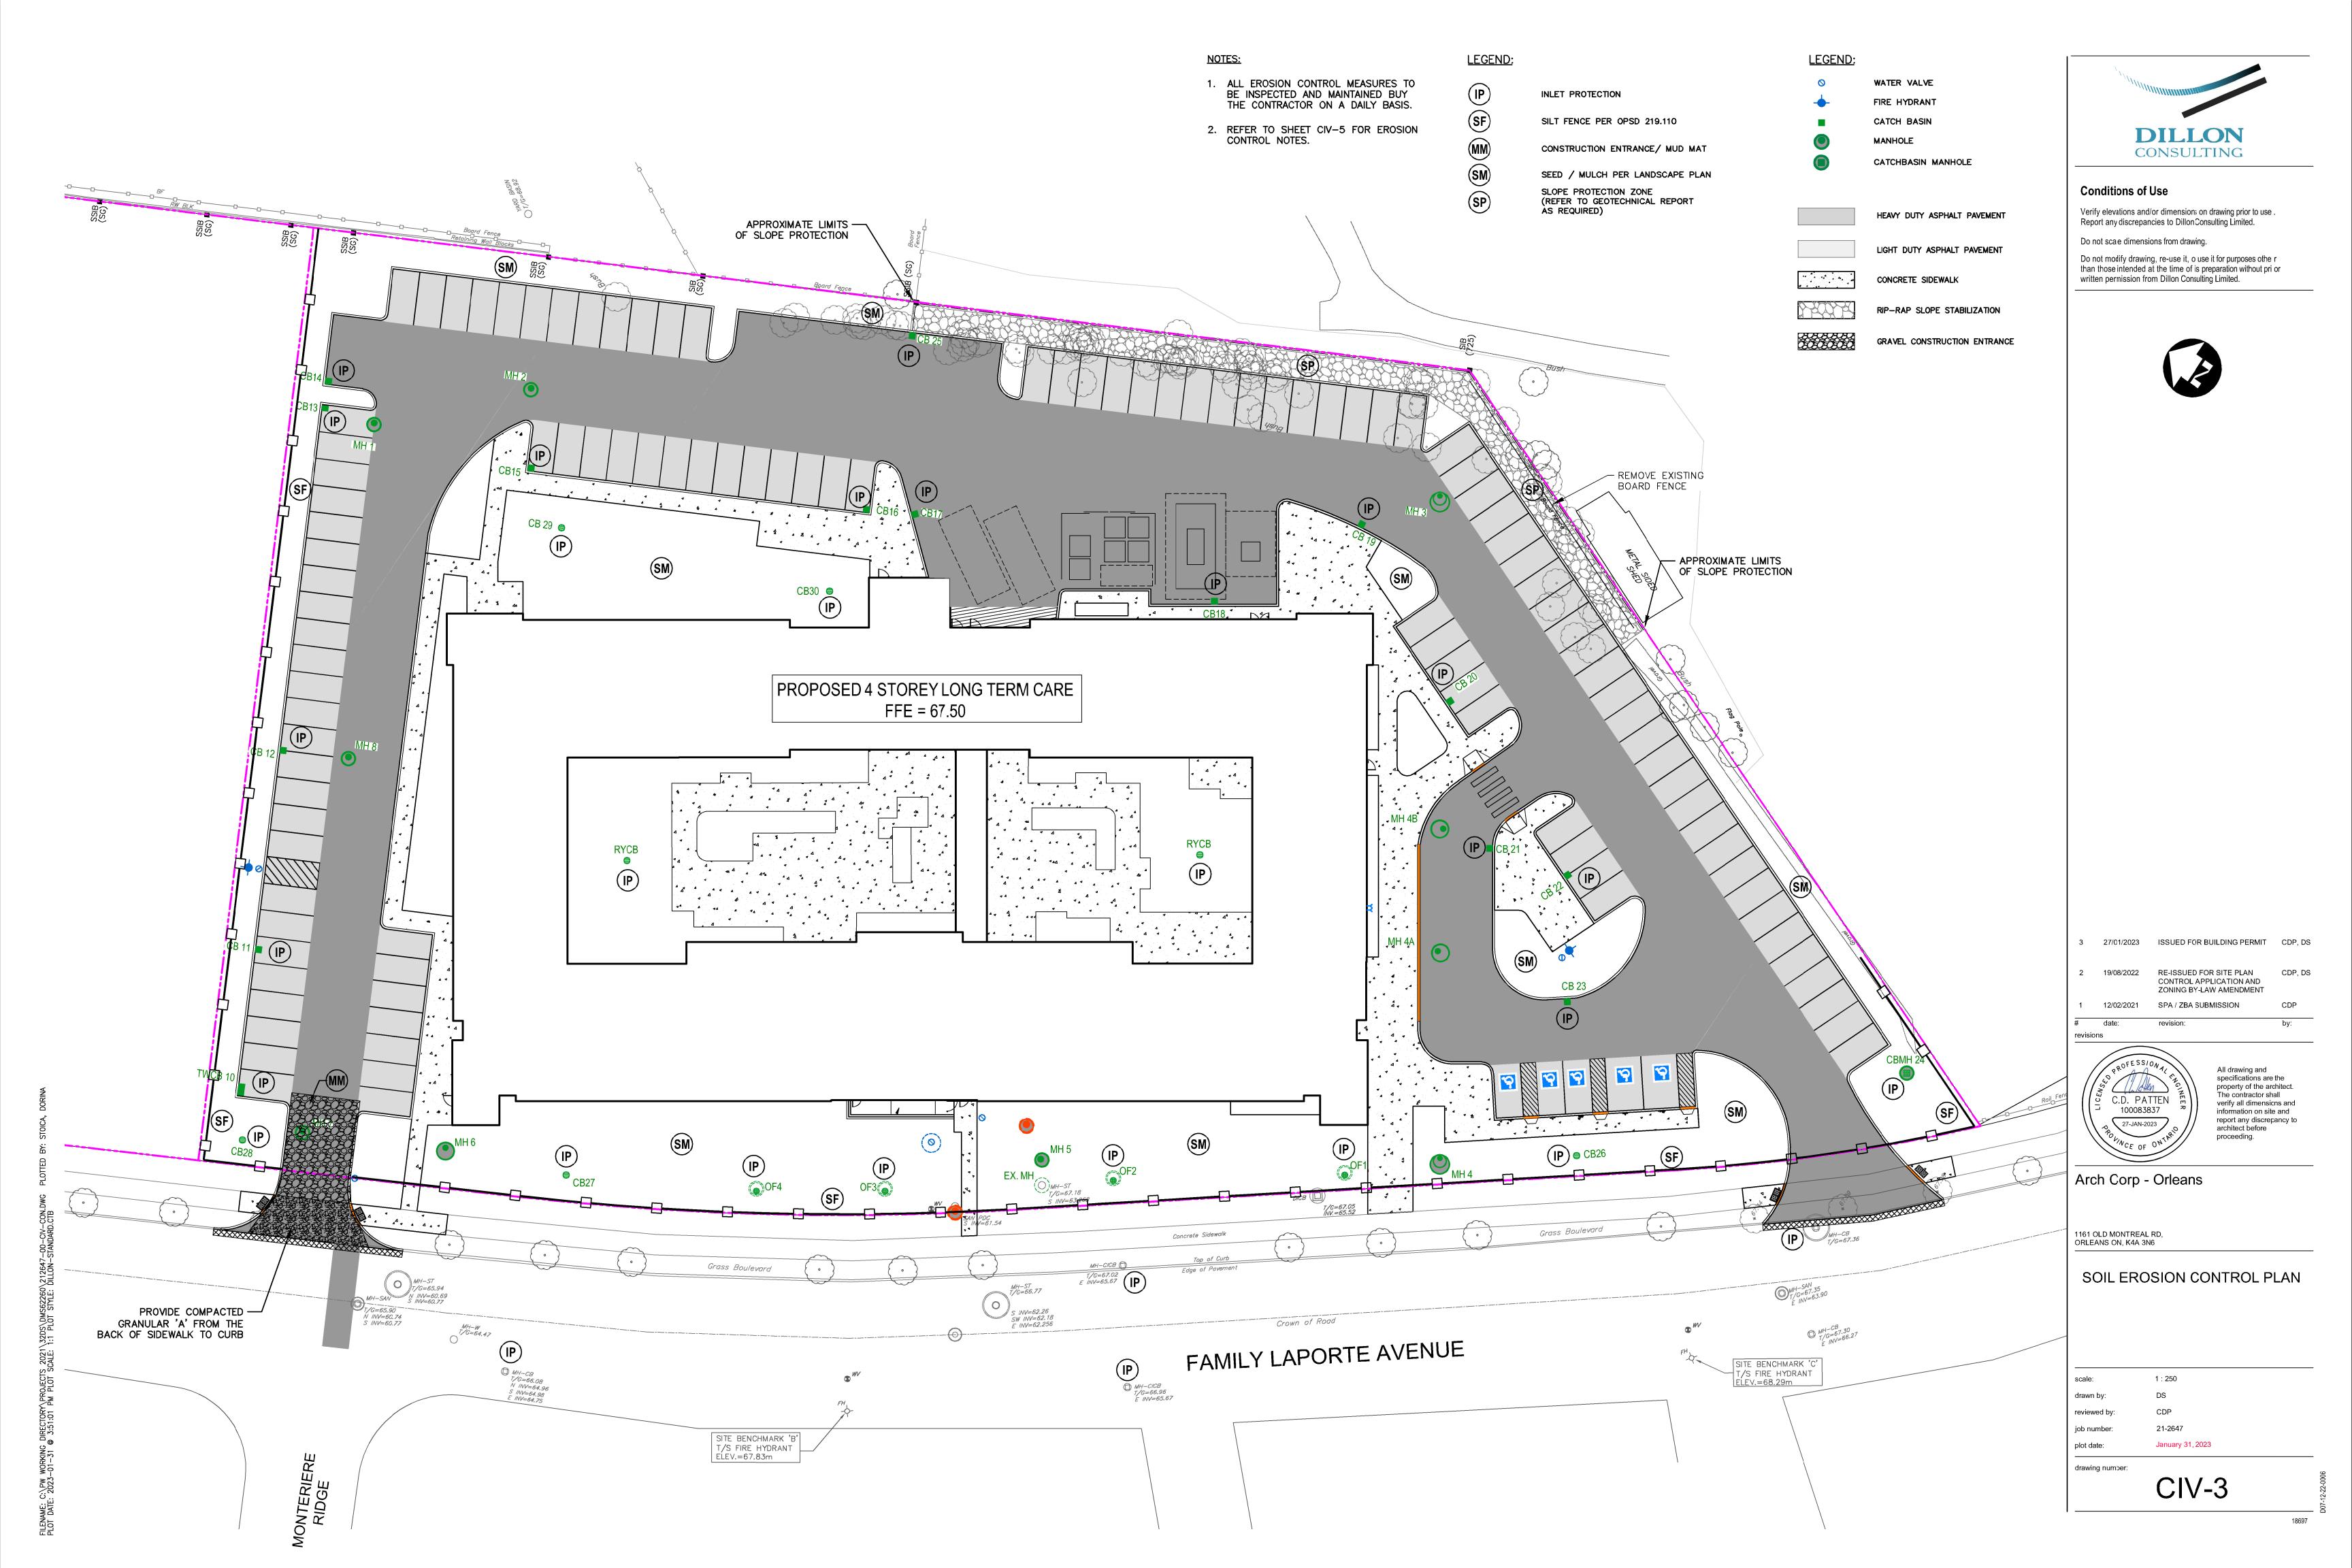


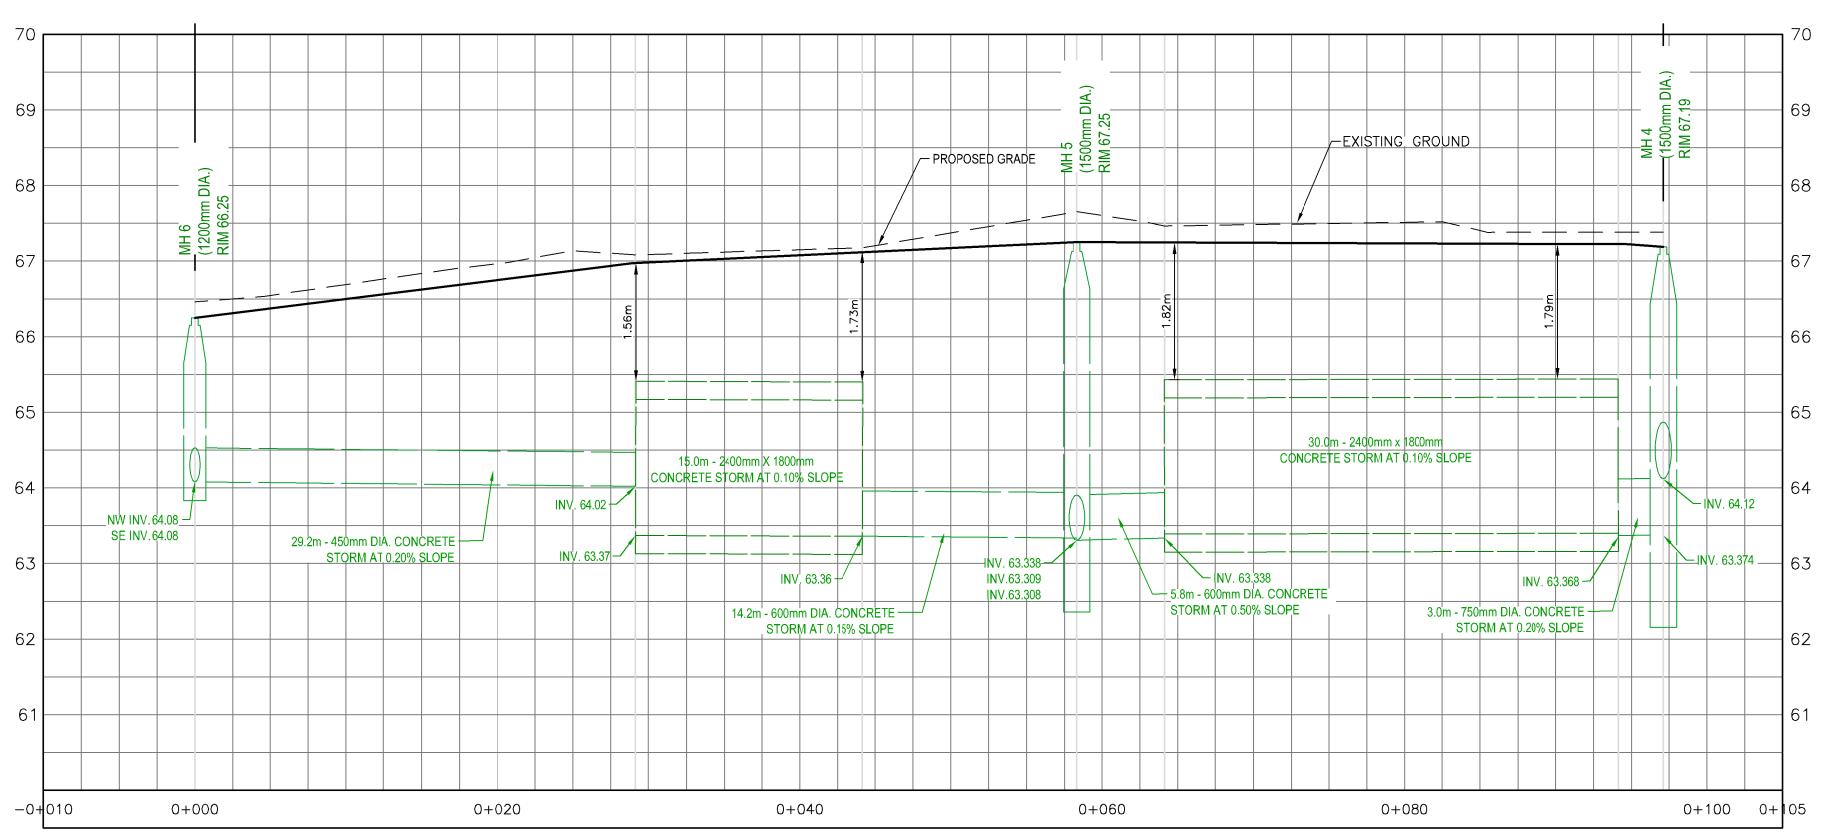

STORM STORAGE CHAMBERS - SECTION C-C HORIZ: 1:250 VERT: 1:50

ALL EXISTING INVERTS TO BE FIELD CHECKED PRIOR TO CONSTRUCTION

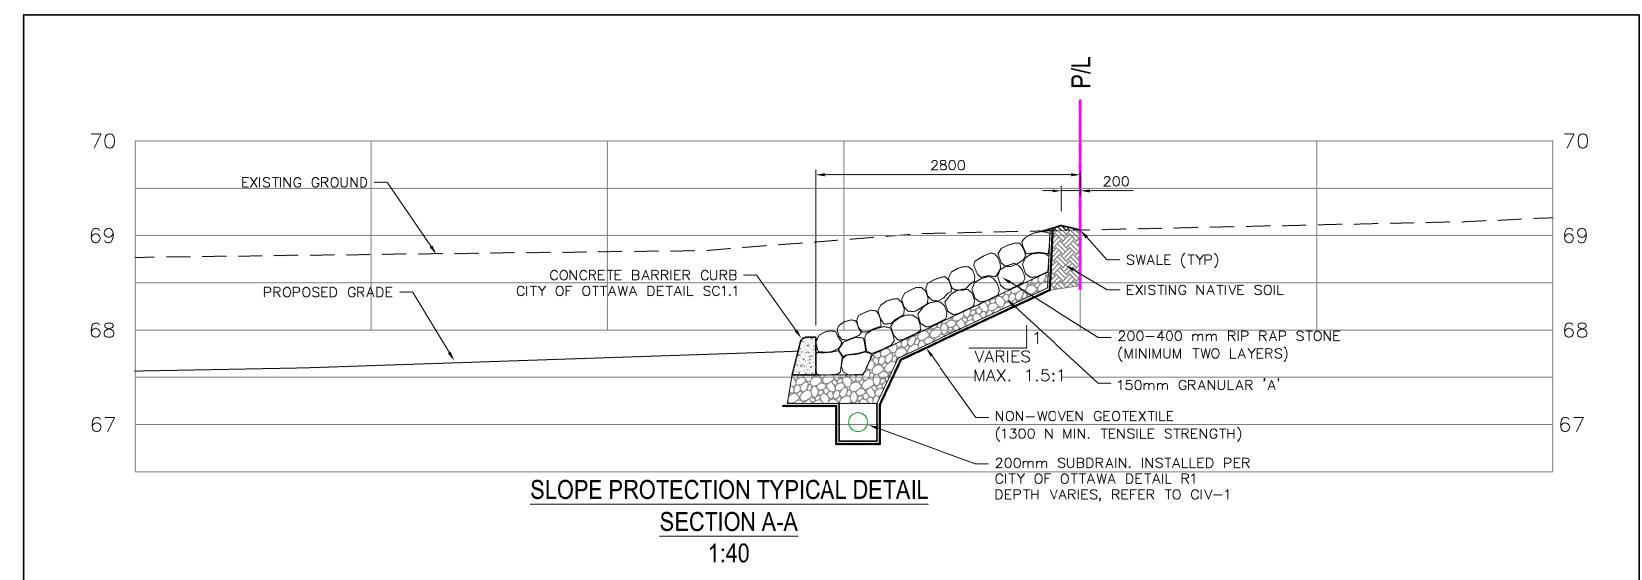

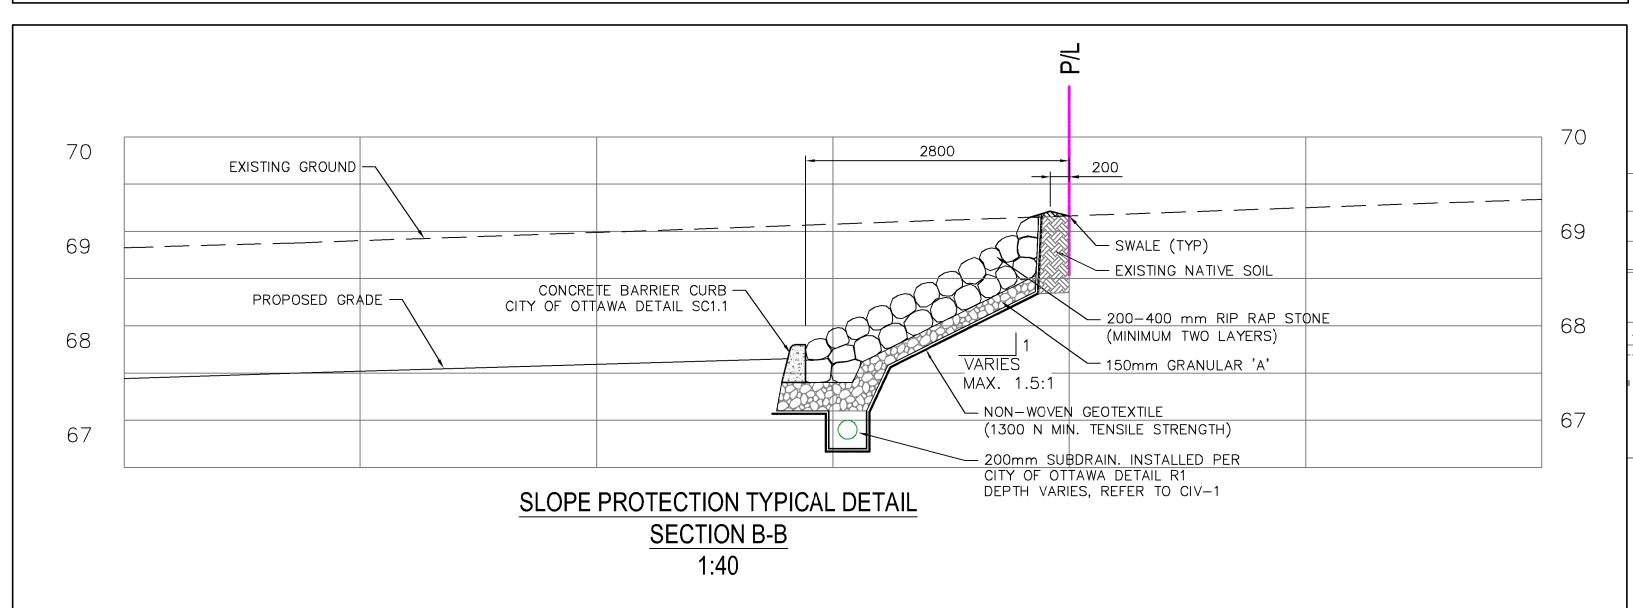

GENERAL UTILITY NOTES:

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- 2. ALL WORKS SHALL COMPLY WITH THE CITY OF OTTAWA STANDARDS.
- 3. DIMENSIONS AND/OR COORDINATES ARE TO BACK OF CURB, OUTSIDE FACE OF BUILDING, EDGE OF PAVEMENT OR CÉNTER OF STRUCTURE.
- 4. ALL NEW WATER, STORM & SANITARY SEWER SERVICES TO BE INSTALLED TO 1.5m FROM THE BUILDING FACE AND CAPPED.
- 5. MINIMUM SLOPE FOR STORM SEWER SERVICES TO BE 2% UNLESS NOTED OTHERWISE.
- 6. CONTRACTOR TO USE "T-WYE" CONNECTIONS WHEN CONNECTING CATCHBASIN LEADS TO THE MAINLINE SEWER.
- 7. ALL WATERMAINS AND SERVICES TO HAVE A MINIMUM OF 2.50m OF COVER.
- 8. INSTALL RAIN CATCHERS ON ALL SANITARY MANHOLES.
- 9. ALL EXISTING TREES AND VEGETATION TO BE REMOVED PRIOR TO CONSTRUCTION.
- 10. ALL WORK WITHIN FAMILY LAPORTE AVENUE RIGHT-OF-WAY AND/OR ON CITY OF OTTAWA. WATERMAINS TO BE COMPLETED IN THE PRESENCE OF MUNICIPAL STAFF OR INSPECTOR.
- 11. ALL DISTURBED AREAS WITHIN FAMILY LAPORTE AVENUE EXISTING RIGHT-OF-WAY TO BE RESTORED TO EXISTING OR BETTER CONDITION.
- 12. ALL RESTORATIONS PER THE LANDSCAPING PLAN.
- 13. ALL WORKS TO BE CONSTRUCTED TO A TOLERANCE OF 5mm±.
- 14. ALL DIMENSIONS AND RADII ATE TO CONSTRUCTION BASELINE OR EDGE OF PAVEMENT.
- 15. SEWER BEDDING PER MANUFACTURER RECOMMENDATIONS AND CITY OF OTTAWA STANDARDS. PIPE BEDDING TO BE A MINIMUM OF 150mm THICK, GRANULAR 'A' SHALL BE USED AS PIPE BEDDING, AT THE SPRINGLINE OF THE PIPE, AND A 300mm THICK LAYER ABOVE THE OBVERT. REFER TO GEOTECHNICAL REPORT BY LRL ASSOCIATES LTD. ALL BEDDING TO BE COMPACTED TO A MINIMUM 95% SMPDD.
- 16. WHERE WET SOIL CONDITIONS ARE ENCOUNTERED, THE USE OF "CLEAR STONE" BEDDING (19mm) MAY BE CONSIDERED AS A SUBSTITUTE IN CONJUNCTION WITH A GEOTEXTILE FILTER (TERRAFIX 270R). REFER TO GEOTECHNICAL REPORT BY LRL ASSOCIATES LTD.
- 17. ALL SANITARY SEWER ARE TO BE PVC DR-35 UNLESS NOTED OTHERWISE.
- 18. ALL STORM SEWERS 375mm DIA. OR SMALLER TO BE PVC DR-35. ALL STORM SEWERS 450mm OR LARGER TO BE CONCRETE A257.2 65-D UNLESS SHOWN OTHERWISE ON PLANS OR SPECIFICATIONS.
- 19. ALL CATCH BASINS LEADS TO BE PVC DR-35 AND DIAMETER OF LEADS:
 - FROM SINGLE TO BE 200mm DIA. - FROM DOUBLE TO BE 250mm DIA.


 - FROM BCB TO BE 200mm DIA. *UNLESS OTHERWISE SHOWN.

23. CONNECTIONS TO PVC PIPE:
THE CONTRACTOR SHALL BE REQUIRED TO USE ONLY PLANT MANUFACTURED TEES WHEN INSTALLING ALL CONNECTION. THE ANGULAR RISE OF THE CONNECTIONS SHALL BE BETWEEN 5' AND 85'. IF THE ANGULAR RISE EXCEED 45', THE CONTRACTOR SHALL PROVIDE AN ADDITIONAL PVC COUPLING WITH STOP IMMEDIATELY BEYOND THE FITTING. A SHORT SECTION OF PVC PIPE IS TO BE USED TO CONNECT THE COUPLING TO THE FITTING. THE COUPLING SHALL REST DIRECTLY UPON THE BELL PORTION OF THE FITTING.

24. CONNECTIONS ON CONCRETE PIPE:

ALL CONNECTIONS GREATER THAN 250mm DIAMETER TO CONCRETE PIPES SHALL BE AMDE WITH PRE-MANUFACTURED CONCRETE TEES. CONNECTIONS FOR 250mm AND SMALLER TO BE MADE WITH PRE-MANUFACTURED BOOTS. THE USE OF WINGED PVC AND COATED BELL WILL NO BE PERMITTED IN

- 25. ALL WATERMAINS INSTALLED VIA OPEN CUT TO BE 100mm DIA. TO 200mm DIA. TO BE PVC AWWA C-900 CLASS 150 DR18.
- 26. ALL WATERMAINS CROSSING MUNICIPAL ROAD TO BE INSTALLED VIA OPEN CUT TRENCH EXCAVATION. CONTRACTOR TO COORDINATE WITH CITY OF OTTAWA FOR REQUIRED ROAD CLOSURE AND PERMITS.
- 27. ALL WATERMAIN WITH LESS THAN 2.50m COVER SHALL HAVE INSULATION PER CITY OF OTTAWA W22 DETAIL.
- 28. AN GREASE AND OIL INTERCEPTOR ON ALL FIXTURES IS REQUIRED FO RFACILITIES WHERE FOOD MAY BE PREPARED AS PER CITY OF OTTAWA SEWER USE PYLAW SECTION 15.
- 29. THE SANITARY AND STORM BACKFOW PREVENTORS TO BE PROVIDED AS PER CITY OF OTTAWA.

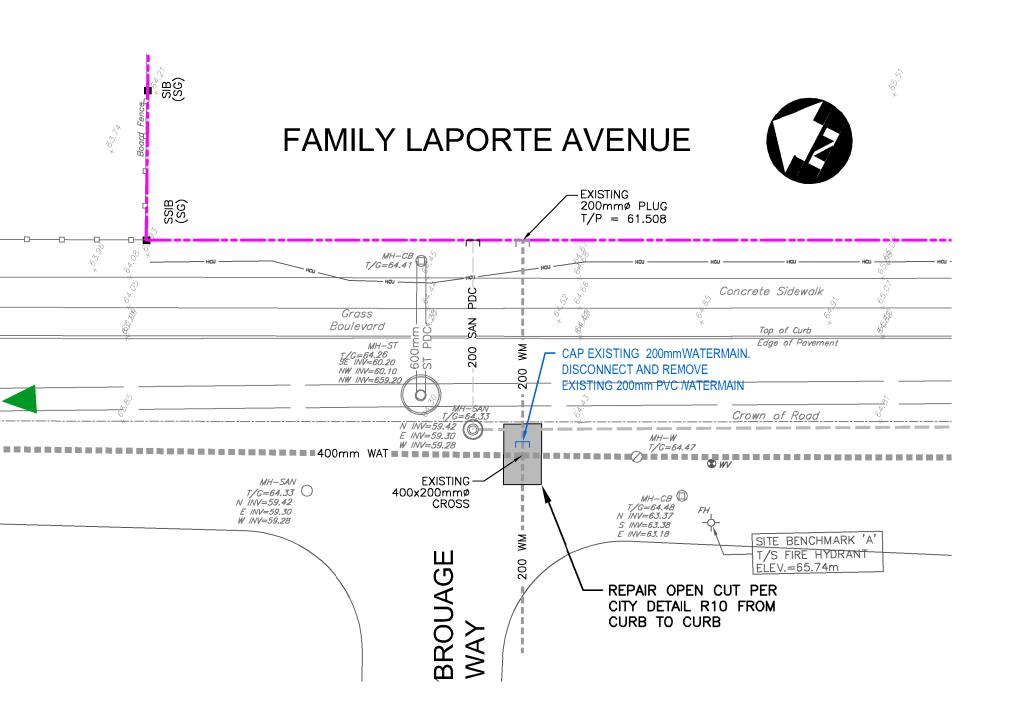




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verify all dimensions and

information on site and report any discrepancy to architect before

proceeding.

Arch Corp - Orleans

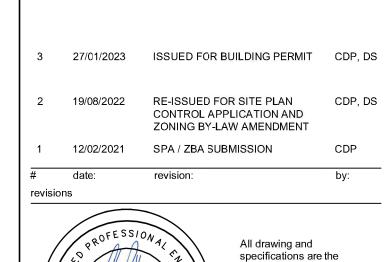C.D. PATTEN

100083837

27-JAN-2023

1161 OLD MONTREAL RD, ORLEANS ON, K4A 3N6

> NOTES, CROSS SECTION AND DETAILS

1:250 drawn by: reviewed by job number: 21-2647 January 31, 2023 plot date:


drawing number:

CIV-4

EROSION AND SEDIMENT CONTROL

GENERAL NOTES:

- 1. PROVIDE TEMPORARY DRAINAGE AND PUMPING AS NECESSARY TO KEEP EXCAVATIONS AND SITE FREE FROM WATER. TEMPORARY PUMPING TO BE COMPLETED IN ACCORDANCE WITH OPSS 518 "CONSTRUCTION SPECIFICATIONS FOR CONTROL OF WATER FROM DEWATERING OPERATIONS". DO NOT DISCHARGE WATER CONTAINING SUSPENDED MATERIALS INTO WATERCOURSES, SEWER OR DRAINAGE SYSTEMS. CONTROLLED DISPOSAL OR RUNOFF OF WATER CONTAINING SUSPENDED MATERIALS OR OTHER HARMFUL SUBSTANCES MUST BE COMPLETED IN ACCORDANCE WITH FEDERAL, PROVINCIAL AND MUNICIPAL REQUIREMENTS. SEE ALSO DEWATERING NOTES
- 2. WORKS AROUND WATERCOURSES AND WETLANDS SHALL BE COMPLETED IN ACCORDANCE WITH THE MOST RECENT VERSION OF THE CONSERVATION AUTHORITY, MUNICIPAL, PROVINCIAL AND FEDERAL BEST MANAGEMENT PRACTICES. FUELING OPERATIONS SHALL NOT BE CONDUCTED AND FUELING TANK SHALL NOT BE LOCATED WITHIN 30.0m OF A ROADSIDE DITCH, MUNICIPAL DRAIN, NATURAL WATERCOURSE, WETLAND OR FIELD TILE.
- 3. INSTALLATION OF TEMPORARY EROSION AND SEDIMENT CONTROL MEASURES SHALL BE COMPLETED IN ACCORDANCE WITH RHE CITY OF OTTAWA STANDARDS AND OPSS 577 "CONSTRUCTION SPECIFICATION FOR TEMPORARY EROSION AND SEDIMENT CONTROL MEASURES", EROSION AND SEDIMENT CONTROL GUIDELINES FOR URBAN CONSTRUCTION (DECEMBER 2006) AND THE CONTRACT DRAWINGS.
- 4. THE CONTRACTOR IS RESPONSIBLE FOR MAINTAINING TEMPORARY EROSION AND POLLUTION CONTROL FEATURES THROUGHOUT THE PROJECT. THE CONTRACTOR IS RESPONSIBLE FOR INSPECTING ALL TEMPORARY EROSION CONTROLS AFTER EACH RAINFALL AND AT LEAST DAILY DURING PROLONGED RAINFALL AND CLEARED OF ACCUMULATED SEDIMENT WHEN 50% OF CAPACITY IS REACHED. SILT FENCES ARE TO BE INSTALLED ALONG THE PROPERTY LINE. STRAW BALES SHALL BE INSTALLED IN ADDITION TO SILT FENCING WHEN FLOW IS CHANNELED IN A PARTICULAR DIRECTION TO THE RECEIVING COURSE OR WHERE WARRANTED. SILT FENCES SHALL NOT BE PERMITTED IN AREAS OF STANDING WATER. ONCE A VIGOROUS GROWTH IS ESTABLISHED IN THE RE-VEGETATED AREAS THE CONTROLS AND ACCUMULATED SEDIMENT SHALL BE REMOVED IN THEIR ENTIRETY WITHIN 30 DAYS OF DIRECTION FROM THE ENGINEER.
- 5. INLET CONTROL DEVICES TO BE INSTALLED ON ALL NEW SITE CATCH BASINS, AND ON ADJACENT ROADWAY CATCHBASINS THAT ARE SUBJECT TO SITE RUNOFF. INLET PROTECTION DEVICES (IP) TO BE CITY OF OTTAWA APPROVED INSERTS SUCH AS STORMSOK, SILTSAK, FLEXSTORM OR SENTINEL. FILTER BAGS ARE TO BE INSPECTED REGULARLY AND CLEANED AFTER EACH RAIN EVENT. INLET FILTERS TO REMAIN IN PLACE UNTIL FINAL RESTORATION HAS ESTABLISHED.
- 6. TEMPORARY CONSTRUCTION ENTRANCE TO FAMILLE—LAPORTE AVENUE.
 CONSTRUCTION ENTRANCE TO CONSIST OF A SOIL STABILIZATION GEOTEXTILE
 FABRIC COVERED WITH MINIMUM 300mm THICK STONE RIP—RAP MAT. RIP—RAP
 TO BE 100mm TO 200mm IN SIZE. IF THE CONSTRUCTION ENTRANCE DOES
 NOT SUFFICIENTLY PREVENT SEDIMENT FROM BEING TRACKED ONTO ADJACENT
 ROADWAYS, A WHEEL WASH MAY BE REQUIRED.

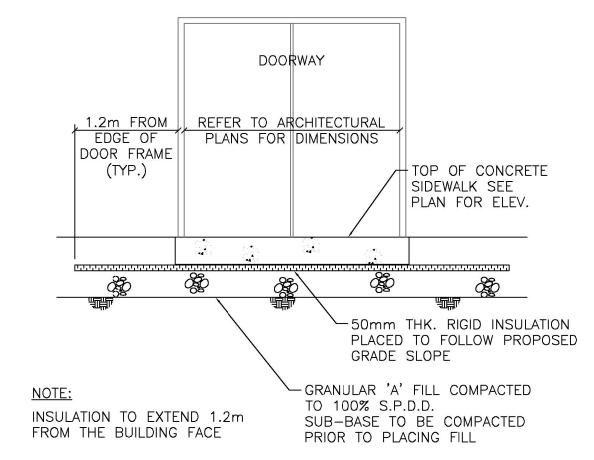

SIDEWALK AT DOORWAY DETAIL NOT TO SCALE

GENERAL NOTES:

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- 2. ALL WORKS SHALL COMPLY WITH THE CITY OF OTTAWA OR OPS STANDARDS.

ALL EXISTING INVERTS TO BE FIELD CHECKED PRIOR TO CONSTRUCTION

SEQUENCING NOTES:

- CONTRACTOR SHALL SUBMIT AN EROSION AND SEDIMENT CONTROL PLAN TO THE ENGINEER FOR APPROVAL.
- 2. INSTALL SILT CONTROL FENCING AROUND PERIMETER OF THE SITE AND CONSTRUCTION ENTRANCE.
- 3. STRIP TOPSOIL FROM WITHIN THE LIMITS OF GENERAL EARTHWORKS AND STORE TEMPORARILY WITHIN THE DESIGNATED AREAS AS DIRECTED BY THE OWNER.
- 4. REDISTRIBUTE TOPSOIL ON SITE AND RESTORE GRASSED AREAS AS PER CONTRACT SPECIFICATIONS.
- 5. ALL EROSION CONTROL MEASURES TO BE MONITORED AS A MINIMUM ON A WEEKLY BASIS AND KEPT IN A FUNCTIONAL STATE.
- 6. ONCE A VIGOROUS GROWTH IS ESTABLISHED IN THE REVEGETATED AREAS, THE CONTROLS AND ACCUMULATED SEDIMENT SHALL BE REMOVED IN THEIR ENTIRETY WITHIN 30 DAYS OF DIRECTION FROM THE ENGINEER.

	STANDARD DETAILS SHALL APPLY TO THIS CONTRACT
SC1.1	CONCRETE BARRIER CURB FOR GRANULAR BASE PAVEMENT (MODIFIED OPSD-600.110)
SC1.4	CONCRETE BARRIER CURB WITH SIDEWALK
SC5	SIDEWALK CONSTRUCTION JOINTS
SC7.3	TWSI (TACTILE WALKING SURFACE INDICATOR) DETAIL
SC7.4	CURB RETURN ENTRANCES
S5	STANDARD TRENCH TERMINOLOGY
S6	SINGLE TRENCH (SEWER AND SEWER SERVICES)
S10	SUPPORT DETAIL FOR EXISTING UTILITY CROSSING OR WATERMAIN TRENCH
S19	HEAVY DUTY "FISH" TYPE SQUARE CATCH BASIN COVER (MODIFIED OPSD-400.07)
S19.1	HEAVY DUTY "FISH" TYPE SQUARE CATCH BASIN COVER
S24.1	STANDARD CIRCULAR STORM MAINTENANCE HOLE COVER
S25	STANDARD CIRCULAR FRAME FOR MAINTENANCE HOLES
S31	CATCH BASIN - ELBOW FOR REAR YARD DITCHED PIPE AND LANDSCAPING APPLICATIONS
R1	SUBDRAIN INSTALLATION DETAIL
R10	STANDARD TRENCH REINSTATEMENT IN PAVED SURFACE
W22	THERMAL INSULATION FOR WATERMAINS IN SHALLOW TRENCHES
W25.2	WATERMAIN CROSSING OVER SEWER
W25.4	THRUST BLOCK DIMENSION TABLES FOR PVC AND DI PIPE 400mm AND UNDER
W25.6	TABLES OF RESTRAINED LENGTHS FOR PVC AND DI PIPE 400mm AND UNDER
W3	CIRCULAR CHAMBER GATE VALVES
W40	PROTECTION FOR PVC WATERMAIN SYSTEM
W55	CONNECTION BETWEEN TRACER WIRE AND FITTING BOLT

THE FOLLOWING CITY OF OTTAWA

	FOLLOWING ONTARIO PROVINCIAL NDARD DETAILS SHALL APPLY TO THIS CONTRACT	
701.010	PRECAST CONCRETE MAINTENANCE HOLE — 1200mm DIAMETER	
705.010	PRECAST CONCRETE CATCH BASIN - 600x600mm	
708.020	SUPPORT FOR PIPE AT CATCH BASIN OR MAINTENANCE HOLE	
708.030	CATCH BASIN CONNECTION FOR FLEXIBLE MAIN PIPE SEWER	
802.010	FLEXIBLE PIPE EMBEDMENT AND BACKFILL EARTH EXCAVATION	
802.030	RIGID PIPE BEDDING, COVER, AND BACKFILL TYPE 1 OR 2 — EARTH EXCAVATION	



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3 27/01/2023 ISSUED FOR BUILDING PERMIT CDP, DS RE-ISSUED FOR SITE PLAN CDP, DS 2 19/08/2022 CONTROL APPLICATION AND ZONING BY-LAW AMENDMENT 1 12/02/2021 SPA / ZBA SUBMISSION revisions All drawing and specifications are the property of the architect. The contractor shall C.D. PATTEN verify all dimensions and 100083837 information on site and report any discrepancy to architect before

proceeding.

Arch Corp - Orleans

1161 OLD MONTREAL RD, ORLEANS ON, K4A 3N6

> NOTES AND MISCELLANEOUS DETAILS

scale: N.T.S.

drawn by: DS

reviewed by: CDP

job number: 21-2647

plot date: January 31, 2023

drawing number:

CIV-5

V-5

| 207-12-2