

PROPOSED ELEVATION

EXISTING ELEVATION

EXISTING ELEVATION

PROPOSED RETAINING WALL(DESIGN BY OTHERS)

EXISTING WATERMAIN

-RUNOFF COEFFICIENT

PROPOSED WATER VALVE

PROPOSED SILT FENCE AS PER OPSD 219.110

→s →s →s → PROPOSED 200mmØ PERFORATED SUBDRAIN

- STM - STM - PROPOSED STORM SEWER

- SAN - SAN - PROPOSED SANITARY SEWER

PROPOSED PIPE INSULATION

PROPOSED 100 YEAR HIGH WATER LEVEL

— WTR — WTR — PROPOSED WATERMAIN
— SAN — SAN — SAN — EXISTING SANITARY SEWER

PROPOSED BOTTOM OF WALL ELEVATION

PROPOSED BOTTOM OF CURB ELEVATION

PROPOSED CATCHBASIN-MANHOLE/MANHOLE/AREA DRAIN

PROPOSSED GRASS AREA. REFER TO LANDSCAPING

PROPOSED CONCRETE FEATURES/SLAB

PROPOSED RIP RAP AS PER OPSD 810.010

PROPOSED HEAVY DUTY ASPHALT

PROPOSED LIGHT DUTY ASPHALT

PROPOSED GRAVEL AREA

PROPOSED WATER METER

PROPOSED TOP OF WALL ELEVATION

PROPOSED TOP OF CURB ELEVATION
PROPOSED ELEVATION MATCH INTO

SWALE ELEVATION

×50.00

×50.00 (SW)

×50.00 (BW)

×50.00 (TW)

×50.00 (BC)

×50.00 (TC)

×50.00 (ME)


× 70.19

## PAVEMENT STRUCTURE

		THICKNESS (mm)	
COURSE	MATERIAL	AUTOMOBILE PARKING	TRUCK ROUTE (HEAVY TRAFFIC)
SURFACE	HL.3 A/C (PG 58-28)	50	40
BINDER	HL.8 A/C (PG 58-28)		50
BASECOURSE	GRANULAR "A"	150	150
SUBBASE	GRANULAR "B" TYPE II	350	450

KEY PLAN - N.T.S.

NOTE: IN PREPARATION FOR PAVEMENT CONSTRUCTION AT THIS SITE, ANY SURFICIAL OR NEAR SURFACE/SUBGRADE LEVEL TOPSOIL AND ANY SOFT, WET OR DELETERIOUS MATERIALS SHOULD BE REMOVED FROM THE PROPOSED PAVED AREAS. THE EXPOSED SUBGRADE SHOULD BE INSPECTED AND APPROVED BY GEOTECHNICAL ENGINEER AND ANY SOFT AREAS EVIDENT SHOULD BE SUBEXCAVATED AND REPLACED WITH SUITABLE EARTH BORROW APPROVED BY THE GEOTECHNICAL ENGINEER. FOLLOWING APPROVAL OF THE PREPARATION OF THE SUBGRADE, THE PAVEMENT GRANULARS MAY BE PLACED.

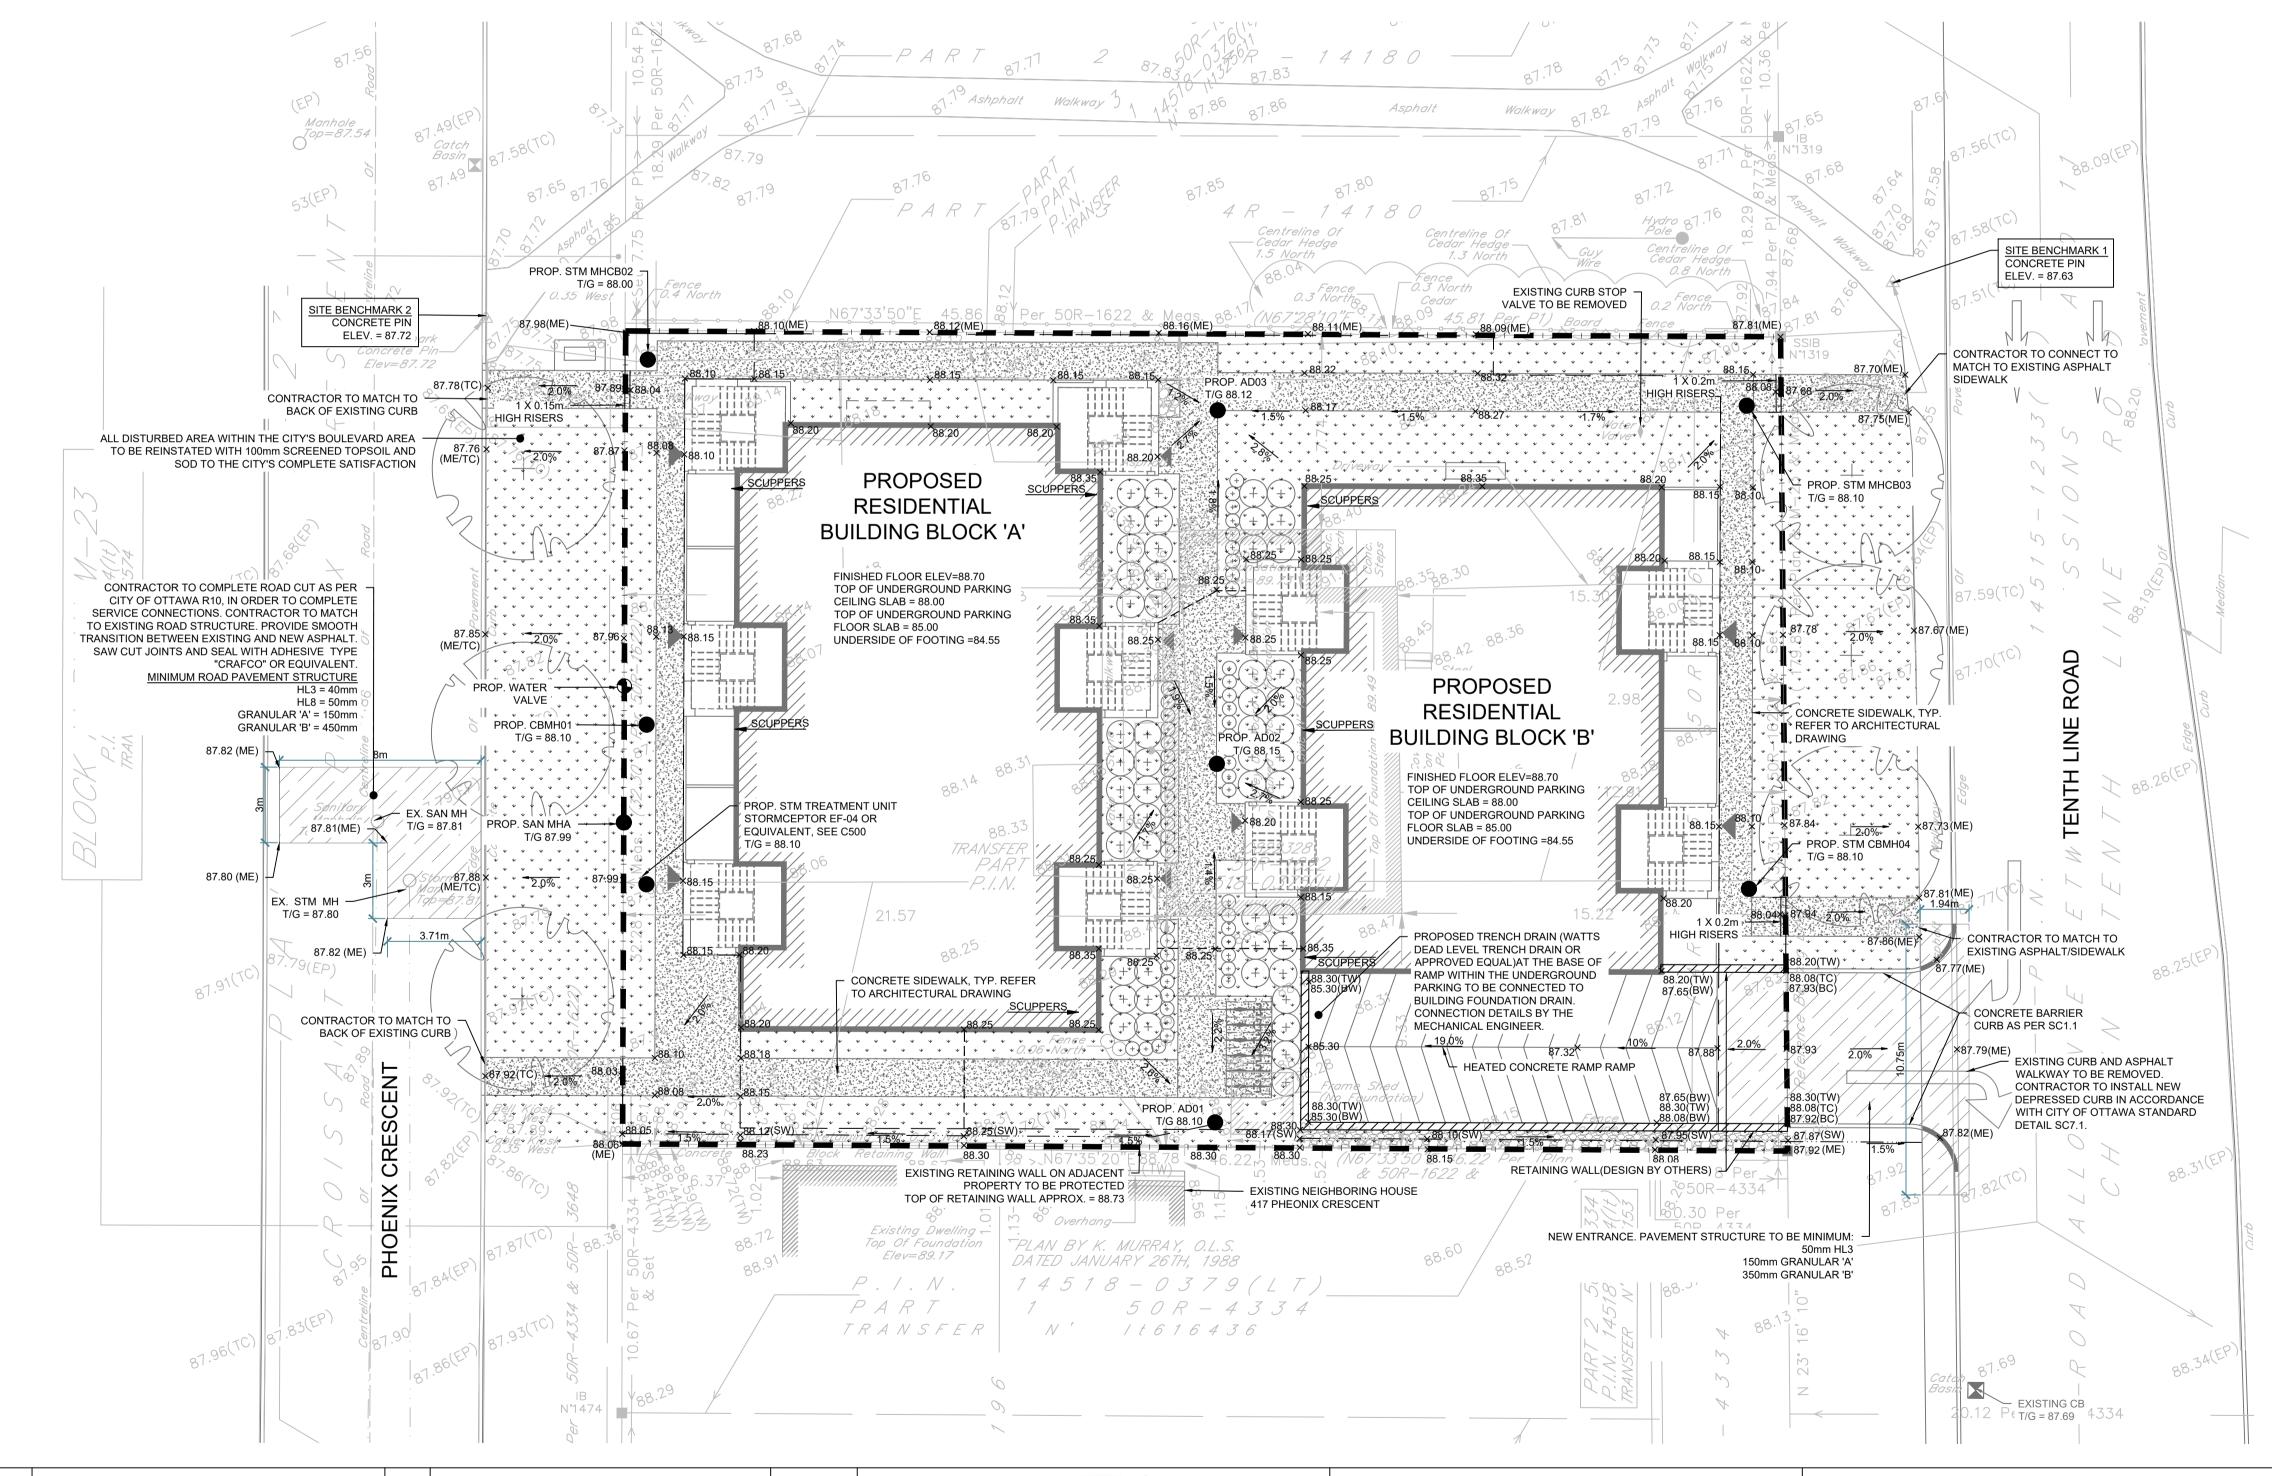

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LEGAL AND TOPOGRAPHIC SURVEY COMPLETED BY ARPENTAGE DUTRISAC SURVEYING INC.

BENCHMARK1: CONCRETE PIN LOCATED ON NORTH EAST CORNER OF THE SITE, ELEVATION: 87.63

BENCHMARK2: CONCRETE PIN LOCATED ON NORTH WEST CORNER OF THE SITE, ELEVATION: 87.72

No. REVISION DESCRIPTION DATE ENGINEER STAMP

1. ISSUED FOR SPA DEC. 2022

2. AS PER ARCHITECT'S COMMENTS DEC. 2022

J. R. ASH 100123062

BRIDOR DEVELOPMENTS
1592 TENTH LINE ROAD
CITY OF OTTAWA

ENGINEERING

SIGN: HY/GC FILE: 522677 DWG:

SITE GRADING PLAN

 DESIGN: HY/GC
 FILE: 522677
 DWG:

 DRAWN: HY
 DATE: NOV 2022
 C200

 CHECK: GC
 SCALE: 1:150