

GROSS BUIDLING AREA (O.B.C.): 259.00 m² 1ST FLOOR: 265.00 m² 2ND FLOOR 256.00 m² 3RD FLOOR 185.00 m² TOTAL: 965.00 m² **EXISTING GROSS FLOOR** AREA (ZONING): 70.50 m^2 1ST FLOOR: 91.30 m² 2ND FLOOR 99.70 m² 3RD FLOOR 62.20 m² **TOTAL EXTG.:** 323.70 m² PROPOSED GROSS FLOOR



BY-law

Provided

Relief

DRAWING LEGEND:

65 Stewart St. Ottawa ON K1N6H9

57.70 m²

100.10 m²

67.40 m²

58.70 m²

Zoning: R4UD S70 **Mature Neighborhood and Heritage Overlays**

Requirement

Provision	Requirement	Provided	BY-law	Relief
Min Front Width	15m	20.4m	Table 162A-R4	-
Min Lot Area	450 m ²	612 m ²	Table 162A-R4	-
Min Front Yard Setback	Neighboring average: 2.65 m	6.75 m	139(3)(a)(i)	-
Min Interior Side Yard	1.5 m	2.78m (West)+ 1.5 m (East)	Table 162A-R4UD	-
Min Rear Yard Setback	30% lot depth including 25% of lot area, in this case 9.05m	3.5 m	161(11)(iii)	✓
Max Height	Backyard (Area D): 10.7 m In all other circumstances (Area A): existing building height, in this case 7.53m	Area A: 9.51m (10.7m fto top of projections above roof surface)	Schedule 70, Section 64	✓
Lanscaped Area	30% of the lot area	30.3% (Hard: 60.2m², Soft: 124.9m²)	161(8)	-
Soft Landscaping	Rear yard: - min. 50% of the rear yard min. 25m² one aggregate rectangular area whose longer dimension is not more than twice its shorter dimesion, for the purpose of tree planting. Side yard: Any part not occupied by accessory buildings and structures, permitted.	9m ² 10.7m ² (partial rear yard and abutting interior side yard)	161(13)(b)(iii) 161(13)(b)(iv)	√ √
	 Any part not occupied by accessory buildings and structures, permitted projections, bicycle parking and Isles, hardscaped paths of travel for waste and recycling management, pedestrian walkways, permitted driveways and parking exclusion fixtures. Front yard: Minimum 20% 	0.7 m ² (west) 22.6m ² (east) 75.4%	161(13)	-
	- Be equiped with solid, permanent fixtures sufficient to prevent motor vechicle parking such as: bicycle parking, benches, bollards, ornamental fences or garden walls, raised planters, trees, wheel chair lifting devices.	Trees&Boulders	(13)(d) & T. 161 (13)(e)	-
Bicycle Parking	0.5/ unit. In this case 12x0.5=6 spaces	6 Vertical (indoors)+3 Horizontal (outside)	Table 111A(b)(i)	-
	Bicycle parking spaces must be located in order to provide convenient access to main entrances or well-used areas. Adjacent to main entrance	111(4)	-	
Car parking	Not required in Area Z on Schedule 1A (TBC)	-	139 (7)(a) & 101(2)	-
Visitor car parking	Not required (0.1/unit required after first 12 units: 0.4)	-	139 (7)(a) & 102(2)	-
Addition	The height of the walls and the height and slope of the roof of the addition do not exceed those of the building	-	60(3)(a)	✓
	The side yard setback of the addition is at least 60 cm. greater than that of the wall of the building located closest to the side lot line	1.5m to side lot line	60(3)(b)(i)	✓
	It is located entirely within the rear yard, or in the interior yard abutting the rear yard and complies with the rear yard setback of the underlying zone	Located in rear yard and interior side yard	60(3)(b)(ii)	✓
		_		I T
	min 25% of total units, in this case 3	6	161(14)(b)	-
2 or more bedroom units Total Amenity Area Communal Amenity Area	min 25% of total units, in this case 3 No minimum	6 155.7m ²	161(14)(b)	-



ZONING MATRIX

NOT TO SCALE



DRAWING NOTES: (#)



CLIENT: SAM ELIAS, 204 BOREALIS CRESCENT OTTWA ON K1K 4V1

03 ISSUED FOR SPC & MZBA APPLICATIONS | 2021-04-08

REVISIONS:

01 ISSUED FOR CLIENT REVIEW DRAWINGS COPYRIGHT ROBERTSON MARTIN ARCHITECTS. DO NOT COPY. DO NOT SCALE DRAWINGS.

ALL DIMENSIONS TO BE CHECKED AND VERIFIED ON SITE

02 ISSUED FOR PRE-CONSULTATION W/ CITY | 2021-03-12

PROJECT:

JARVIS HOUSE

65 STEWART STREET, OTTAWA ON, K1N 6H9


20118

SITE PLAN

DESIGNED BY: APPROVED BY: DRAWN BY: SCALE: DATE: 4/8/2021 AS SHOWN RMA PROJECT NUMBER SHEET NUMBER:


SPC-1

SCALE: 1:100

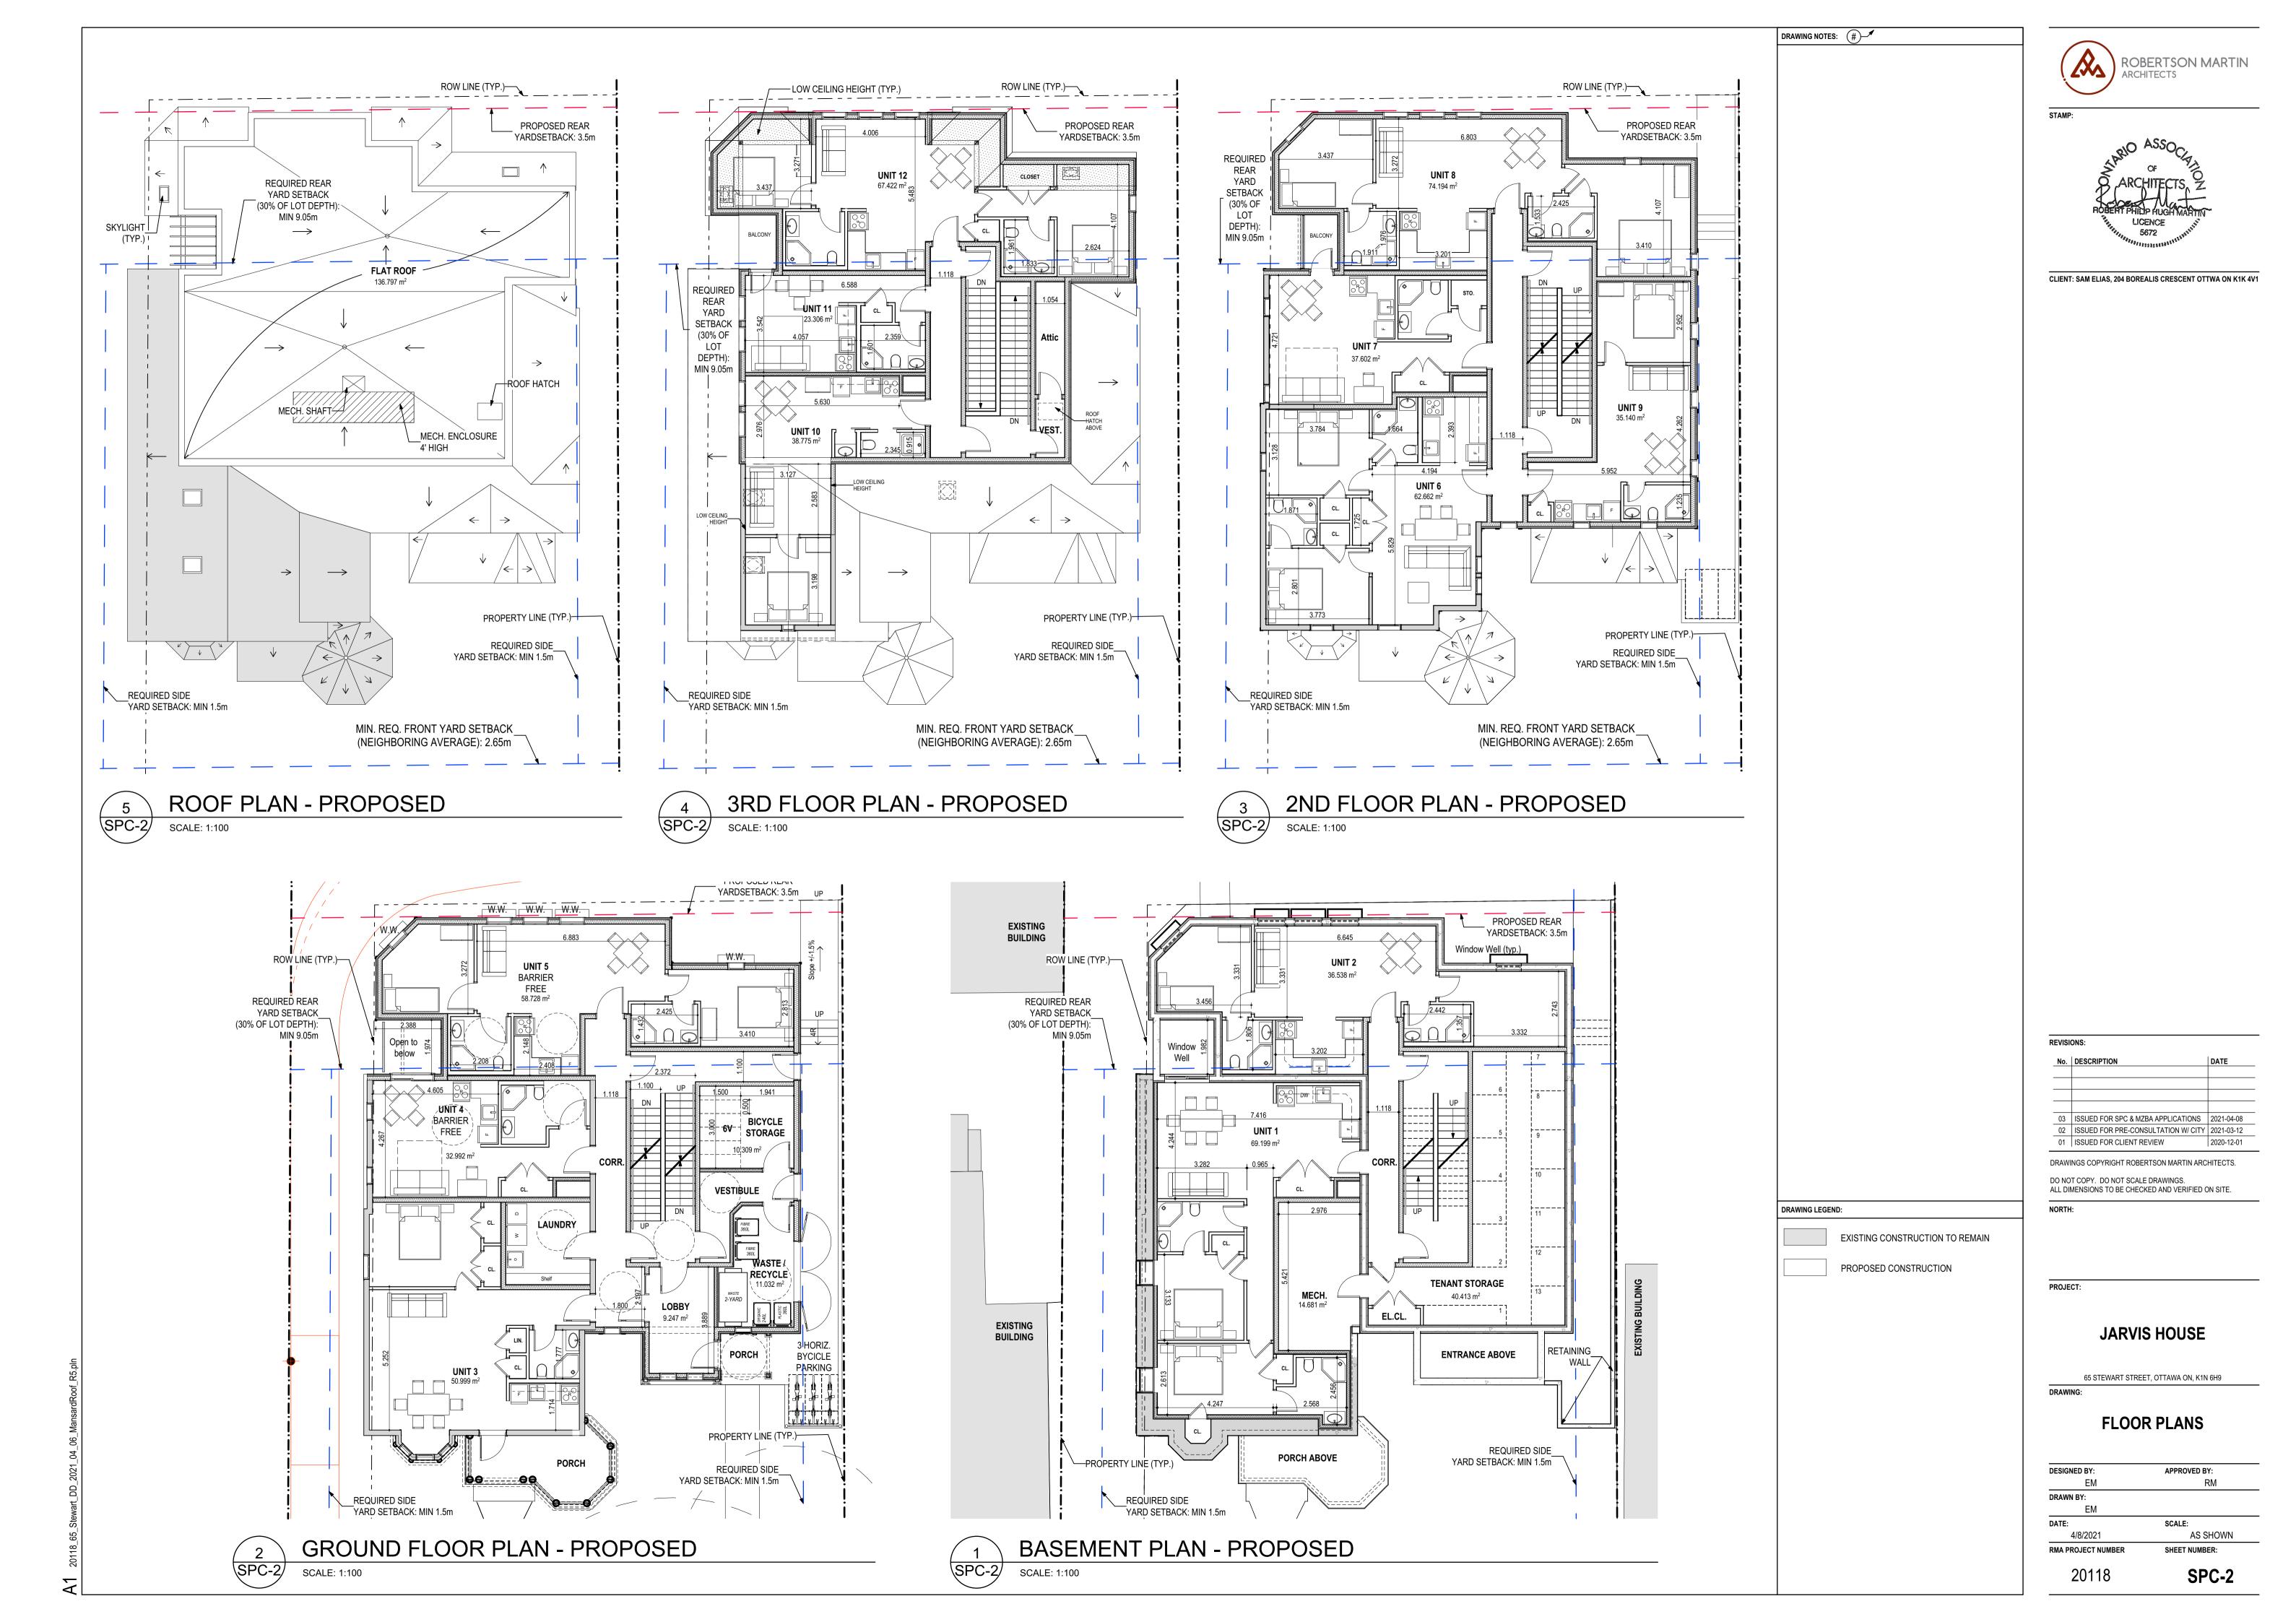





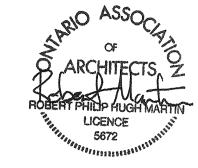

CLIENT: SAM ELIAS, 204 BOREALIS CRESCENT OTTWA ON K1K 4V1

REVISIONS: 03 ISSUED FOR SPC & MZBA APPLICATIONS | 2021-04-08

DRAWINGS COPYRIGHT ROBERTSON MARTIN ARCHITECTS. DO NOT COPY. DO NOT SCALE DRAWINGS. ALL DIMENSIONS TO BE CHECKED AND VERIFIED ON SITE

PROJECT:

JARVIS HOUSE

65 STEWART STREET, OTTAWA ON, K1N 6H9

ELEVATIONS: PROPOSED

DESIGNED BY: APPROVED BY: DRAWN BY: SCALE: 4/8/2021 AS SHOWN RMA PROJECT NUMBER SHEET NUMBER: 20118 SPC-3

DRAWING LEGEND:





CLIENT: SAM ELIAS, 204 BOREALIS CRESCENT OTTWA ON K1K 4V1





NOT TO SCALE



3 NE VIE\
SPC-4 NOT TO SCALE

NE VIEW - PROPOSED









SPC-4

PROPOSED STREET VIEW w/ EXISTING TREES

No.	DESCRIPTION	DATE
03	ISSUED FOR SPC & MZBA APPLICATIONS	2021-04-08
02	ISSUED FOR PRE-CONSULTATION W/ CITY	2021-03-12
01	ISSUED FOR CLIENT REVIEW	2020-12-01

DRAWINGS COPYRIGHT ROBERTSON MARTIN ARCHITECTS.

DO NOT COPY. DO NOT SCALE DRAWINGS. ALL DIMENSIONS TO BE CHECKED AND VERIFIED ON SITE.

PROJECT:

JARVIS HOUSE

65 STEWART STREET, OTTAWA ON, K1N 6H9

RENDERINGS

20118	SPC-4
MA PROJECT NUMBER	SHEET NUMBER:
4/8/2021	AS SHOWN
ATE:	SCALE:
EM	
RAWN BY:	
EM	RM
ESIGNED BY:	APPROVED BY: