


1 TREE CONSERVATION REPORT
TCR SCALE 1:300

KEY	QTY	BOTANICAL NAME	COMMON NAME	SIZE	CONDITION	REMARKS
TREES						
AB	2	Abies balsamea	Balsam Fir	300-350mm DBH	Good	See Plan
AG	1	Acer ginnala	Amur Maple	50mm DBH	Good	See Plan
AN	12	Acer negundo	Manitoba Maple	100-200mm DBH	Good	See Plan
AS	6	Acer saccharum	Sugar Maple	300-500mm DBH	Good	See Plan
BP	3	Betula papyrifera	White Birch	250-300mm DBH	Good	See Plan
CC	2	Carya cordiformis	Bitternut Hickory	300-350mm DBH	Good	See Plan
FR	1	Fraxinus sp.	Ash	100mm DBH	Dead	See Plan
GT	2	Gleditsia triacanthos	Honey Locust	50mm DBH	Good	See Plan
PG	2	Picea glauca	White Spruce	300mm DBH	Good	See Plan
PP	1	Picea pungens	Colorado Spruce	300mm DBH	Good	See Plan
PR	1	Pinus resinosa	Red Pine	50mm DBH	Good	See Plan
PS	3	Prunus pennsylvanica	Pin Cherry	50-100mm DBH	Good	See Plan
QR	2	Quercus robur	English Oak	50mm DBH	Good	See Plan
TA	7	Tilia americana	Basswood	100-550mm DBH	Good	See Plan
TO	*	Thuja occidentalis	Eastern White Cedar	50-350mm DBH	Dead-Poor	See Plan
UA	8	Ulmus americana	American Elm	100-400mm DBH	Dead-Poor	See Plan
UP	2	Ulmus pumila	Siberian Elm	200-400mm DBH	Good	See Plan

*DENOTES NUMEROUS

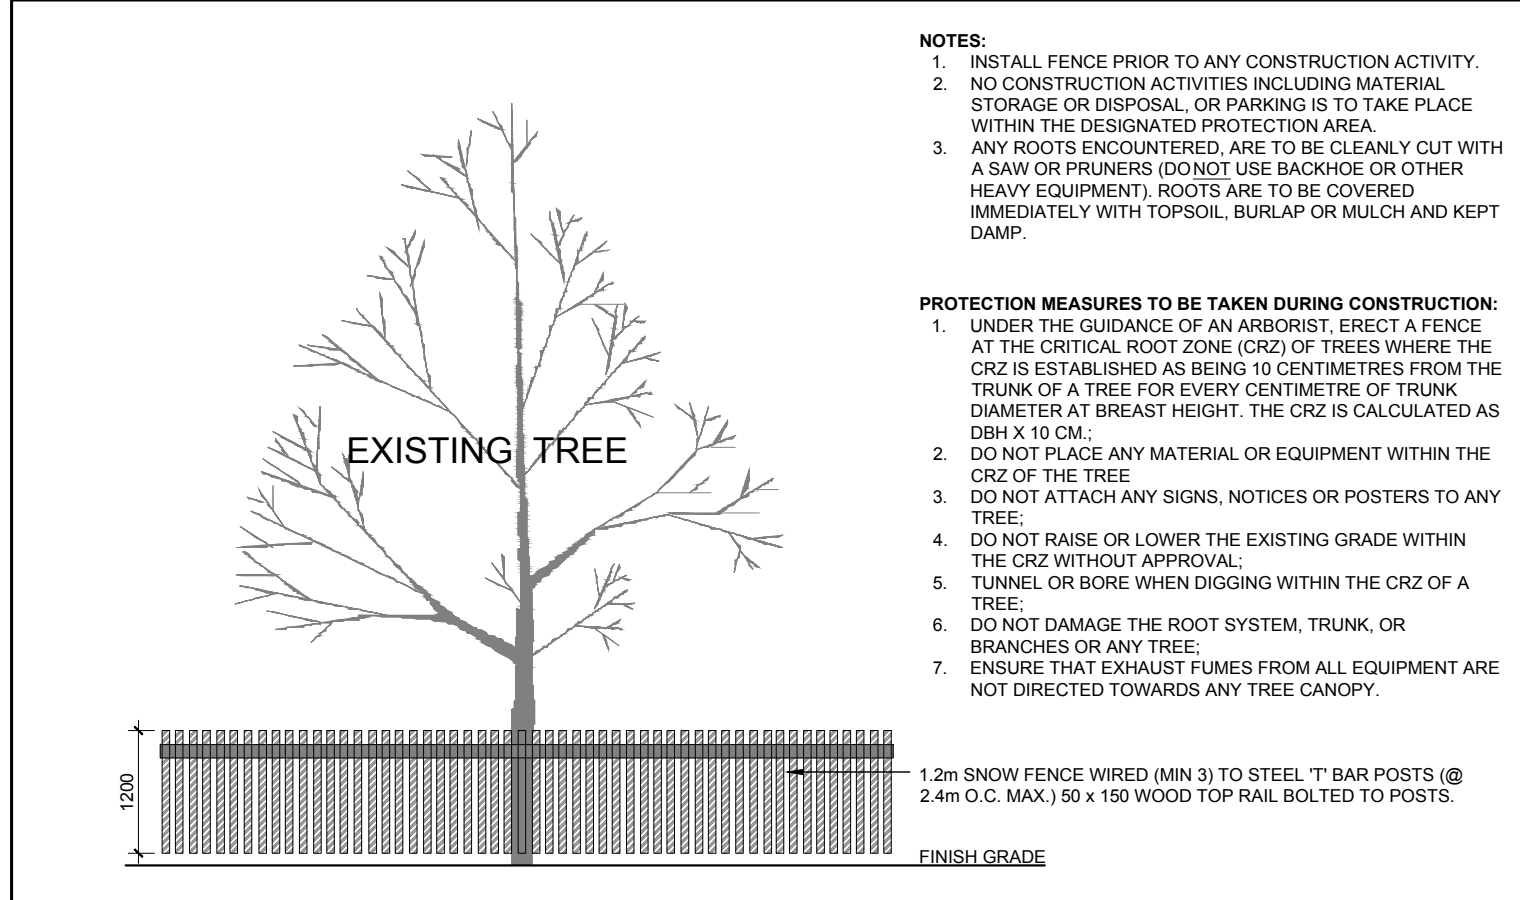

2 TREE PROTECTION FENCE
TCR SCALE 1:300

- NOTES:**
- INSTALL FENCE PRIOR TO ANY CONSTRUCTION ACTIVITY.
 - NO CONSTRUCTION ACTIVITIES INCLUDING MATERIAL STORAGE OR DISPOSAL OR PARKING IS TO TAKE PLACE WITHIN THE DESIGNATED PROTECTION AREA.
 - ANY ROOTS ENCOUNTERED ARE TO BE CLEANLY CUT WITH A SAW OR PRUNERS (DON'T USE BACKHOE OR OTHER HEAVY EQUIPMENT). ROOTS ARE TO BE COVERED IMMEDIATELY WITH TOPSOIL, BURLAP OR MULCH AND KEPT DAMP.
- PROTECTION MEASURES TO BE TAKEN DURING CONSTRUCTION:**
- UNDER THE GUIDANCE OF AN ARBORIST, ERECT A FENCE AT THE CRITICAL ROOT ZONE (CRZ) OF TREES WHERE THE CRZ IS ESTABLISHED AS BEING 10 CENTIMETRES FROM THE TRUNK OF A TREE FOR EVERY CENTIMETRE OF TRUNK DIAMETER AT BREAST HEIGHT. THE CRZ IS CALCULATED AS DBH X 10 CM.
 - DO NOT PLACE ANY MATERIAL OR EQUIPMENT WITHIN THE CRZ OF THE TREE.
 - DO NOT ATTACH ANY SIGNS, NOTICES OR POSTERS TO ANY TREE.
 - DO NOT RAISE OR LOWER THE EXISTING GRADE WITHIN THE CRZ WITHOUT APPROVAL.
 - TUNNEL OR BORE WHEN DIGGING WITHIN THE CRZ OF A TREE.
 - DO NOT DAMAGE THE ROOT SYSTEM, TRUNK, OR BRANCHES OR ANY TREE.
 - ENSURE THAT EXHAUST FUMES FROM ALL EQUIPMENT ARE NOT DIRECTED TOWARDS ANY TREE CANOPY.

CLIENT: **HAZELDEAN CROSSING INC.**

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LEGEND:

- CITY: EXISTING TREE ON CITY OF OTTAWA PROPERTY TO REMAIN
- EXISTING TREE ON PRIVATE PROPERTY TO REMAIN
- EXISTING TREE ON PRIVATE PROPERTY TO BE REMOVED
- CITY: EXISTING TREE ON CITY OF OTTAWA PROPERTY TO BE REMOVED
- EXISTING HEDGE TO REMAIN
- TREE PROTECTION FENCE

4	PRE-CAST PRIVACY WALL ADDED TO PLAN	11/13/2019	ML	JL
3	REVISED PER CITY COMMENTS	11/04/2019	ML	JL
2	RE-ISSUED FOR SITE PLAN CONTROL	05/29/2019	ML	JL
1	ISSUED FOR SITE PLAN CONTROL	05/24/2019	ML	JL

No. Issue Date DR CK

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PROJECT: HAZELDEAN ROAD RESIDENTIAL DEVELOPMENT
5924 & 5938 HAZELDEAN ROAD, OTTAWA ON

DRAWING: TREE CONSERVATION REPORT

STAMP:

SCALE: AS SHOWN

START DATE: MARCH 2019

PROJECT NO.: 19-MIS-1939

PROJECT NORTH:

DRAWING NO.: **TCR**

PLOT SIZE ARCH-D