

29 May 2018 OUR REF: 476001-01000

Colonnade BridgePort 100 Argyle Avenue, Suite 100 Ottawa, ON K2P 1B6

Attention: Kelly Rhodenizer, MCIP, RPP

Dear Kelly:

Re: 5045 Innovation Drive Land Use Revision – Transportation Impact

Colonnade Bridgeport is in the process of developing the lands located at 5045 Innovation Drive. The previously submitted Transportation Impact Assessment and subsequent Addendums have been approved by the City. Since then there has been one revision to a land use for one of the commercial pads. This letter has been prepared to compare the difference in number of site-generated traffic volumes based on this land use revision and to assess whether additional transportation impact analysis is required. The revised Site Plan is attached.

The proposed revision to the land uses involves the removal of one of the drive-through restaurants and the addition of a veterinary clinic. Table 2 summarized the number of vehicle trips generated by a drive-through restaurant and a veterinary clinic of the same land use size. The ITE Trip Generation Manual (10th edition) rates were applied and are summarized in Table 1.

Table 1: ITE Trip Generation Rates

Land Use	Data	Trip Rates			
Land Use	Source	AM Peak	PM Peak		
Fast-Food Restaurant with Drive-Through		T = 40.19(X)	T = 32.67(X)		
Veterinary Clinic	ITE 640	T = 3.64(X)	T = 3.53(X)		
Notes: T = Average Vehicle Trip Ends X = 1000 ft ² Gross Floor Area					

Table 2: Vehicle Trip Generation

Land Haa	Aroo	AM Pe	ak (Person T	rips/h)	PM Peak (Person Trips/h)			
Land Use	Area	In	Out	Total	In	Out	Total	
Fast-Food Restaurant with Drive-Through	1,800 ft ²	18	16	34	13	12	25	
Veterinary Clinic	1,800 ft ²	3	4	7	3	3	6	
Difference in	-15	-12	-27	-10	-9	-19		

As shown in Table 2, the fast-food restaurant is projected to generate more vehicle trips than the veterinary clinic. As such, the vehicle impact to the surrounding transportation network is understood to be less than outlined in the original Transportation Impact Study.



PARSONS

Given the results shown herein, no further transportation impact analysis is required based on the proposed changes in land use and the commercial development located at 5045 Innovation Drive continues to be recommended from a transportation perspective.

Prepared by:


André Sponder, P.Eng. Transportation Engineer Reviewed by:

Christopher Gordon, P.Eng. Senior Project Manager





Revised Site Plan

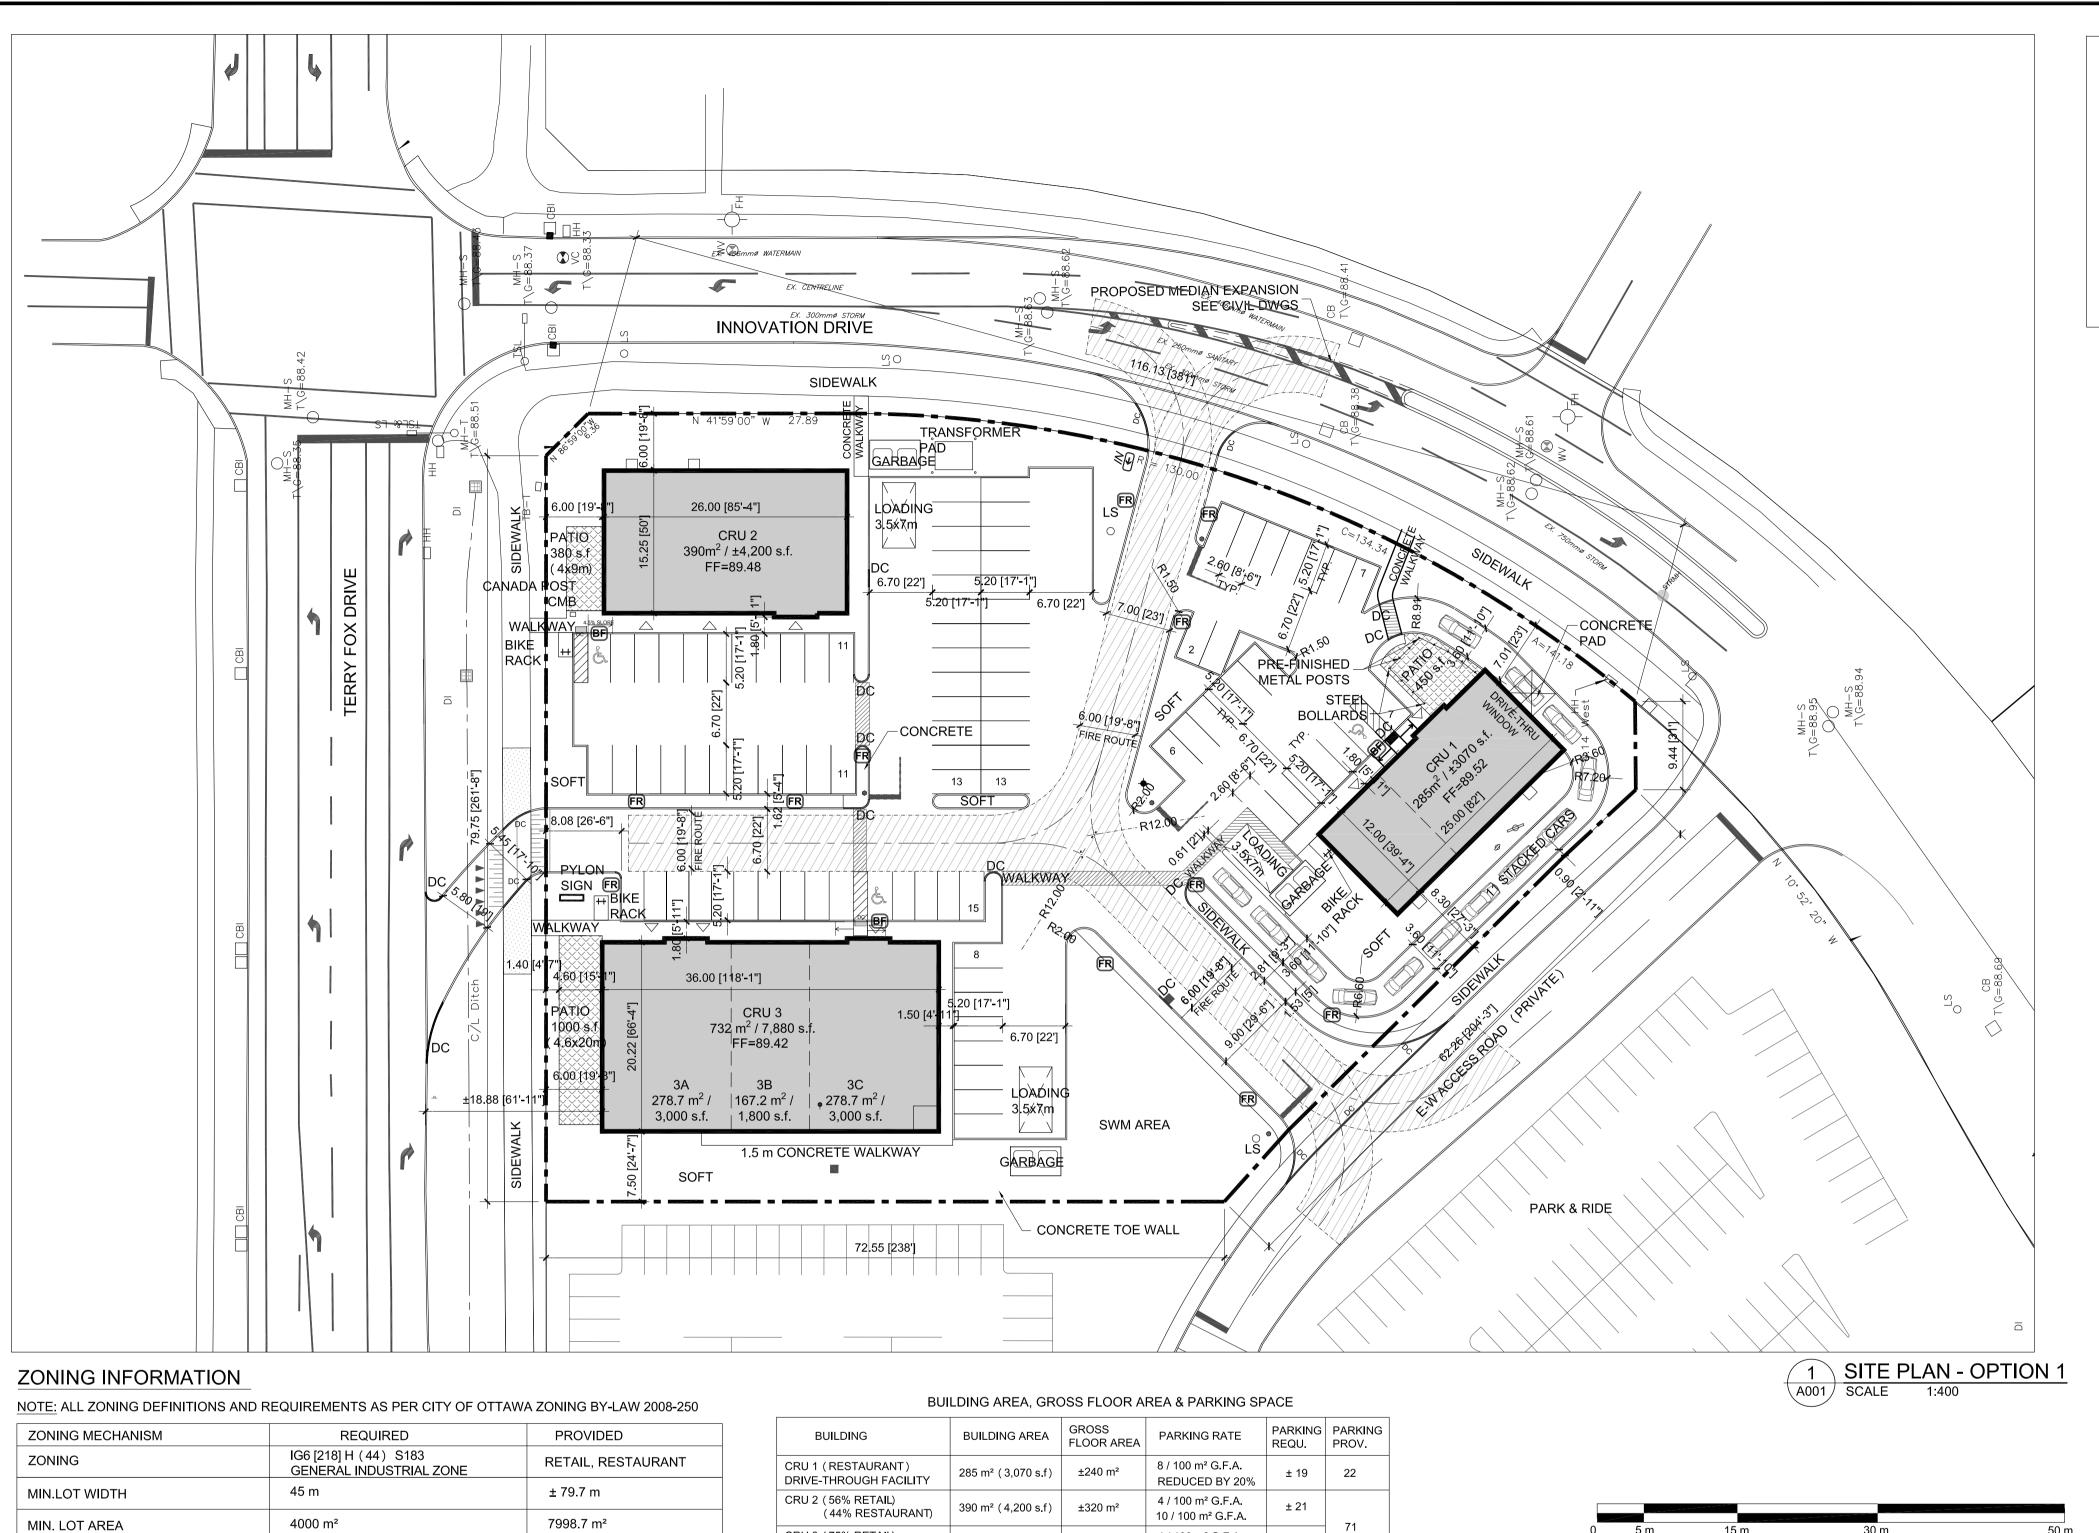

BUILDING	BUILDING AREA	GROSS FLOOR AREA	PARKING RATE	PARKING REQU.	PARKING PROV.
CRU 1 (RESTAURANT) DRIVE-THROUGH FACILITY	285 m² (3,070 s.f)	±240 m²	8 / 100 m ² G.F.A. REDUCED BY 20%	± 19	22
CRU 2 (56% RETAIL) (44% RESTAURANT)	390 m² (4,200 s.f)	±320 m²	4 / 100 m² G.F.A. 10 / 100 m² G.F.A.	± 21	74
CRU 3 (75% RETAIL) (25% RESTAURANT)	732 m² (7,880 s.f)	±575 m²	4 / 100 m ² G.F.A. 8 / 100 m ² G.F.A.	± 32	71
TOTAL	1,407 m² (15,115 s.f)			± 72	93

12 m (TERRY FOX DRIVE)

7.5 m (E-W ACCESS ROAD)

12 m (INNOVATION DRIVE)

ABUTTING A STREET = 3m

ABUTTING A STREET = 3 m

2.6m WIDTH x 5.2m LENGTH

3.66m WIDTH x 5.2m LENGTH

1 SPACE IS REQUIRED

1 BIKE / BUILDING

FOR A PARKING LOT CONTAINING

NOT ABUTTING A STREET = 1.5 m

AS PER BY-LAW 2003-530, ITEM 122

W/ CAPACITY OF 20-99 SPACES,

45 %

11-99 SPACES:

MIN. FRONT YARD SETBACK

MIN. REAR YARD SETBACK

MAX. BUILDING HEIGHT

MAX. LOT COVERAGE (%)

MIN. INTERIOR SIDE YARD SETBACK

MIN. CORNER SIDE YARD SETBACK

MIN. WIDTH OF LANDSCAPED AREA

PARKING LANDSCAPE BUFFER

STANDARD PARKING SPACE

PARKING REQUIREMENTS

LOADING ZONE

BICYCLE PARKING

TOTAL BUILDING AREA

ACCESSIBLE PARKING SPACE

6 m

8.3 m

7.5 m

6 m

±9 m

17.2 %

> 3 m

> 1.5 m

ABUTTING A STREET > 3 m NOT ABUTTING A STREET

2.6m WIDTH x 5.2m LENGTH

3.66m WIDTH x 5.2m LENGTH

3 SPACES PROVIDED

2 BIKES / BUILDING

1407 m² (15,115 s.f)

LE	EGEND		-	5.40 [17'-9"]			
		PROPERTY LINE	3.60 [11'-10"]	CURB 2.5	EARTHBIN [™] GARBAGE BINS	■ DI	BITCH INLET
		PROPOSED BUILDINGS	1.60 [17	- WX	MODEL EB500	□НН	HANDHOLE
			(+)			□ TB-T	TRAFFIC TERMINAL BOX
		PYLON SIGN			STOP SIGN & STOP LINE	□ ТВ−В	BELL TERMINAL BOX
		FIRE ROUTE				O	TRAFFIC LIGHT
			-\rightarrow FH	-\rightarrow FH	FIRE HYDRANT	O AN	ANCHOR
	\rightarrow	SIGNAGE IN/ OUT			NEW FIRE HYDRANT	O LS	LIGHT STANDARD
<u></u> 1	\triangle	BUILDING ENTRANCE	₩ WV	WATER VALVE	SANMH	SANITARY SEWER W/ MANHOLE	
1.22 [4']		PEDESTRIAN WALKWAY /PAINT LINE		○ MH-R	MAINTENANCE HOLE (ROGERS)	STRMH	STORM SEWER W/ MANHOLE
(LOADING SPACE 3.5x7m		MAINTENANCE HOLE (SEWER)		RETAINING WALL	
				\bigcirc MH $-$ T	MAINTENANCE HOLE (TRAFFIC)	□ TB−C	CABLE TERMINAL BOX
	DC	DEPRESSED CURB		СВІ	CATCH BASIN INLET	O P0-W	WOOD POLE
	‡	BIKE RACK		CB	CATCH BASIN		

PLAN 4R- 29559

APPROVED

THIS _____DAY OF______, 20____

DERRICK MOODIE, MANAGER

DEVELOPMENT REVIEW WEST

PLANNING, INFRASTRUCTURE AND ECONOMIC

DEVELOPMENT DEPARTMENT, CITY OF OTTAWA


TOPOGRAPHICAL PLAN OF

PART OF BLOCK 4 REGISTERED PLAN 4M- 1104 CITY OF OTTAWA

Prepared by Brian J. Lynch, Ontario Land Surveyor May 26, 2016

Colonnade BRIDGEPORT



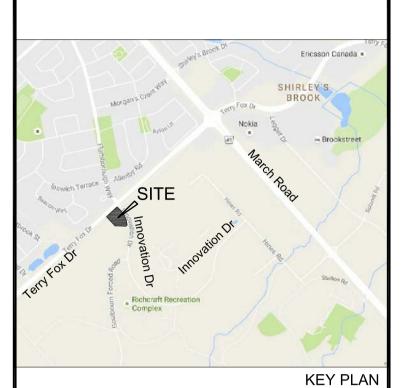

7	ISSUED FOR SITE PLAN REVISIONS	23 June 2017
6	ISSUED FOR MINOR REZONING APPLICATION	14 June 2017
5	REISSUED FOR SITE PLAN CONTROL	2 June 2017
4	REISSUED FOR SITE PLAN CONTROL	15 May 2017
3	REISSUED FOR SITE PLAN CONTROL	26 April 2017
2	REISSUED FOR SITE PLAN CONTROL	13 April 2017
1	ISSUED FOR SITE PLAN CONTROL	30 NOV. 2016

revision


N45 ARCHITECTURE INC.


71 Bank Street, 7th Floor, Ottawa, Ontario, K1R 6S3 tel. 613.224.0095 fax 613.224.9811

project

INNOVATION STATION PHASE 3

5045 INNOVATION DRIVE, KANATA, ON.

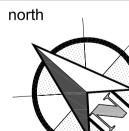

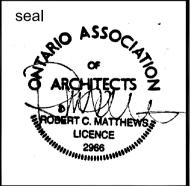

drawing title SITE PLA OPTION 1	•
scale 1:400	drawn by C.L.
date JUNE.01/ 2017	checked by R.M.
project number	drawing number
17-192	A-001

CONTRACTOR TO VERIFY ALL DIMENSIONS AND NOTIFY THE ARCHITECT OF ANY DISCREPANCIES BEFORE WORK COMMENCES. DO NOT SCALE DRAWINGS.

revision