


1 TREE CONSERVATION REPORT  
TCR SCALE 1:300

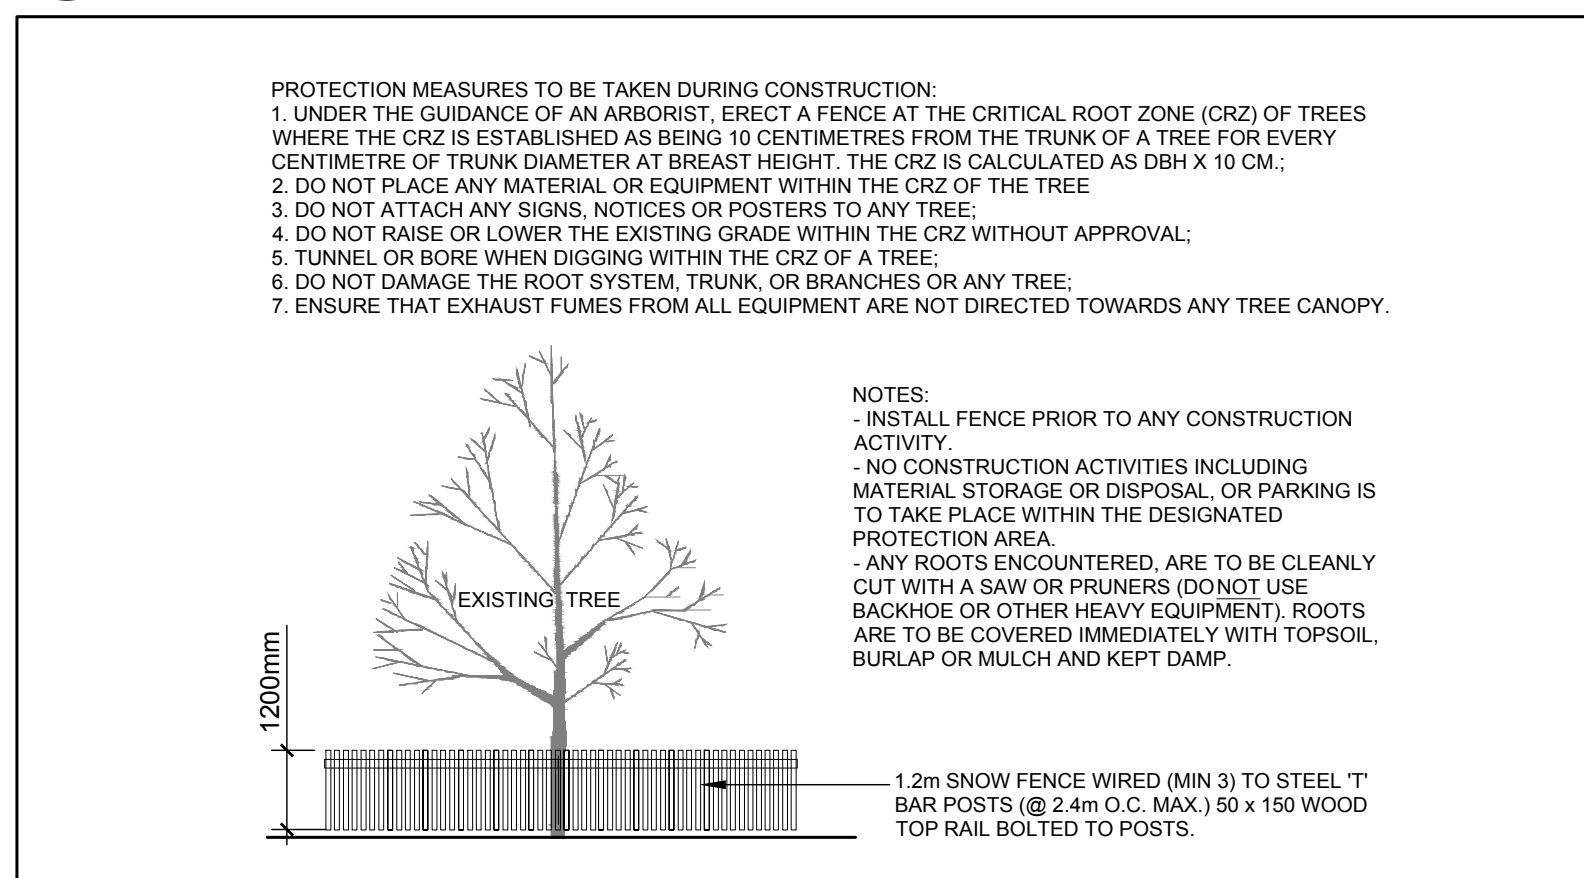

2 TREE PROTECTION FENCE  
TCR SCALE: NTS

KEY	QTY	BOTANICAL NAME	COMMON NAME	SIZE	CONDITION	REMARKS
<b>TREES</b>						
AN	2	Acer nigrum	Black Maple	100-450mm ø	GOOD	See Plan
AS	14	Acer saccharum	Sugar Maple	350-950mm ø	POOR-GOOD	See Plan
CO	4	Celtis occidentalis	Hackberry	150-200mm ø	GOOD	See Plan
PT	1	Populus tremuloides	Trembling Aspen	150mm ø	GOOD	See Plan
QM	3	Quercus macrocarpa	Bur Oak	150-500mm ø	GOOD	See Plan
TA	12	Tilia americana	Basswood	100-400mm ø	POOR-GOOD	See Plan
UA	105	Ulmus americana	White Elm	100-300mm ø	DEAD-POOR	See Plan

**GENERAL NOTES:**

- It is the responsibility of the appropriate contractor or official to report any errors, omissions or discrepancies on this plan with actual site conditions to the Landscape Architect before proceeding with construction.
- The contractor is to notify all utility companies and authorities prior to any excavation and ascertain locations of underground services.
- The contractor is to reinstate all areas and items damaged as a result of construction activity.
- The contractor is to comply with all pertinent codes and by-laws.
- The contractor is to maintain a positive surface run-off throughout the entire construction period.
- The Landscape Architect is not responsible for subsurface conditions.
- The contractor is to identify all existing trees to remain on site with the Landscape Architect prior to construction.
- The contractor is to stake the proposed location of all plant material in conjunction with the Landscape Architect prior to excavation.
- Minimum distances for selected deciduous trees are as follows:
  - Building Foundations 4.5m inside of property line
  - Sidewalks 1.5m
  - Public Streets 2.5m
  - Underground Infrastructure 2.0m
- All trees within 1m of underground utility trenches are to be excavated by hand.
- Remove all protective wrapping from tree trunks after installation.
- Staking of trees shall only be performed if necessary.
- Ensure that mulch is pulled back a min. distance of 75mm from base of tree trunk.

CLIENT: PHOENIX HOMES  
18A Bentley Avenue  
Ottawa, ON  
Tel: (613) 706-5537

CONSULTANTS  
ARCHITECTS: M. David Blakely  
Architect Inc.  
210 Grosvenor St., Suite 200  
Ottawa, ON  
Phone: (613) 226-8811 Fax: (613) 226-7942

CIVIL ENGINEERS: Novatech Engineering Consultants Ltd.  
240 Michael Cowpland Dr., Suite 200  
Ottawa, ON  
Tel: (613) 234-8643

LEGEND

APPROVED  REFUSED   
THIS \_\_\_ DAY OF \_\_\_\_\_, 20\_\_  
JEFF MCEWEN, P. ENG., MANAGER  
DEVELOPMENT REVIEW, SUBURBAN SERVICES

1	ISSUED FOR SITE PLAN APPROVAL	12/14/2017	ML	JL
No.	Issue	Date	ML	DR CK

JAMES B. LENNOX & ASSOCIATES INC.  
LANDSCAPE ARCHITECTS  
3332 CARLING AVE. OTTAWA, ONTARIO K2J 5A8  
Tel: (613) 722-5168 Fax: (866) 343-3942

PROJECT: 241 ERIC CZAPNIK WAY  
OTTAWA, ONTARIO

DRAWING: TREE CONSERVATION REPORT

STAMP: ASSOCIATION OF LANDSCAPE ARCHITECTS OF ONTARIO  
MEMBER

SCALE: AS SHOWN  
START DATE: 23-JUNE-2016  
PROJECT NO.: 16-MIS-1643

PROJECT NORTH: DRAWING NO.: TCR  
PLOT SIZE ARCH-D