
APPROVED By Jamesdo at 2:40 pm, Aug 07, 2019


**DOUGLAS JAMES, MCIP, RPP MANAGER, DEVELOPMENT REVIEW - CENTRAL** PLANNING, INFRASTRUCTURE & ECONOMIC DEVEVELOPMENT DEPARTMENT, CITY OF OTTAWA

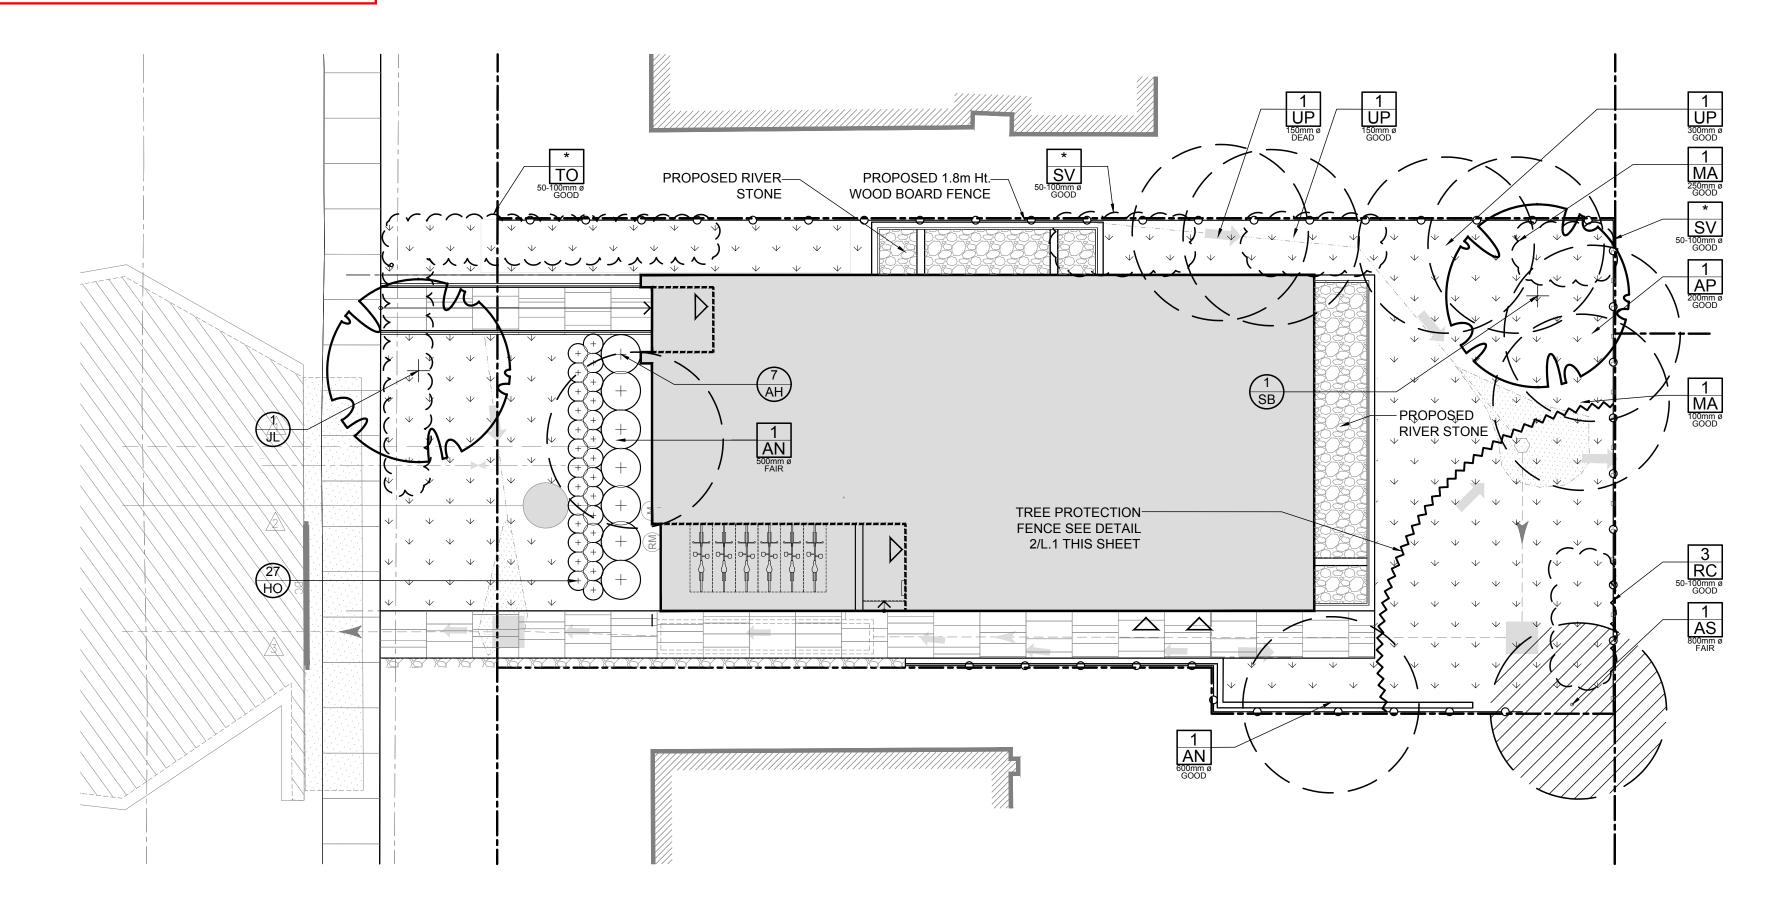




KEY	QTY.	BOTANICAL NAME	COMMON NAME	SIZE	CONDITION	REMARKS
TRE	ES					
AN AP AS UP MA RC SV TO	2 1 1 3 2 3 * *	Acer negundo Acer platanoides Acer saccharinum Ulmus pumila Malus sp. Rhamnus cathartica Syringa vulgaris Thuja occidentalis	Manitoba Maple Norway Maple Silver Maple Siberian Elm Crabapple Common Buckthorn Common Purple Lilac Eastern White Cedar	500-600mm DBH 200mm DBH 800mm DBH 150-300mm DBH 100-250mm DBH 50-100mm DBH 50-100mm DBH 50-100mm DBH	FAIR-GOOD GOOD FAIR DEAD-GOOD GOOD GOOD GOOD	SEE PLAN
*DEN	OTES	A CLUSTER				
		POSED PLANT LIST	ST QTY. KEY  COMMON NAME	SIZE	CONDITION	REMARKS
PR	QTY.	POSED PLANT LIS		SIZE	CONDITION	REMARKS
PR KEY	QTY.	POSED PLANT LIS		SIZE  60mm cal. 60mm cal.	CONDITION  B&B B&B	
PR KEY TRE	<b>ΩΓΥ</b> . <b>ES</b>	POSED PLANT LIST BOTANICAL NAME  Syringa reticulata Amelanchier canadensis	COMMON NAME  Japanese Tree Lilac	60mm cal.	B&B	
PR KEY TRE	QTY.	POSED PLANT LIST BOTANICAL NAME  Syringa reticulata Amelanchier canadensis	COMMON NAME  Japanese Tree Lilac	60mm cal.	B&B	
PR KEY TRE JL SB SHF	ατγ.  EES  1 1 7	POSED PLANT LIST BOTANICAL NAME  Syringa reticulata Amelanchier canadensis	Japanese Tree Lilac Serviceberry	60mm cal. 60mm cal.	B&B B&B	Branching at 1.8m

GENERAL NOTES:
1. It is the responsibility of the appropriate contractor or official to report any errors, omissions or discrepancies on this plan with actual site conditions to the Landscape Architect before proceeding with construction.
2. The contractor is to notify all utility companies and authorities prior to any excavation and ascertain locations of underground services.
3. The contractor is to reinstate all areas and items damaged as a result of construction activity.
4. The contractor is to comply with all pertinent codes and by-laws.
5. The contractor is to maintain a positive surface run-off throughout the entire construction period.
6. The Landscape Architect is not responsible for subsurface conditions.
7. The contractor is to identify all existing trees to remain on site with the Landscape Architect prior to construction.
8. The contractor is to stake the proposed location of all plant material in conjunction with the Landscape Architect prior to excavation.
<ul> <li>9. Minimum distances for selected deciduous trees are as follows:</li> <li>Building Foundations 7.5m</li> <li>Sidewalks 1.5m</li> <li>Public Streets 2.5m</li> <li>Underground Infrastructure 2.0m</li> </ul>
10. All trees within 1m of underground utility trenches are to be excavated by hand.
11. Remove all protective wrapping from tree trunks after installation.
12. Staking of trees shall only be performed if necessary.
13. Ensure that mulch is pulled back a min. distance of 75mm from base of tree trunk.

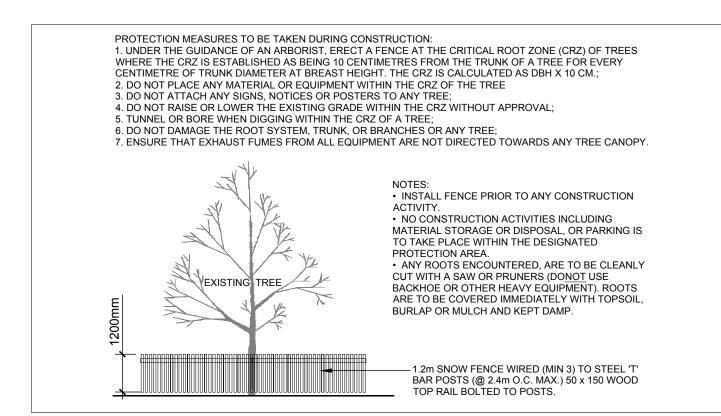


## L.1 SCALE: NTS - PREVAILING WIND

TREE PROTECTION FENCE

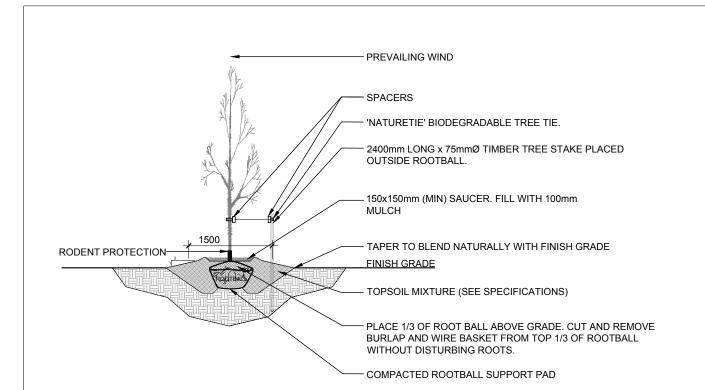


## 3 DECIDUOUS TREE PLANTING L.1 SCALE: NTS

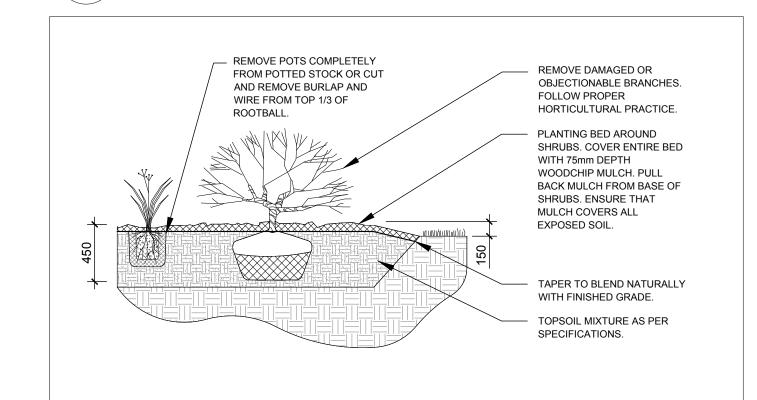

## 4 SHRUB / PERENNIAL PLANTING L.1 SCALE: NTS

L.1 SCALE: NTS

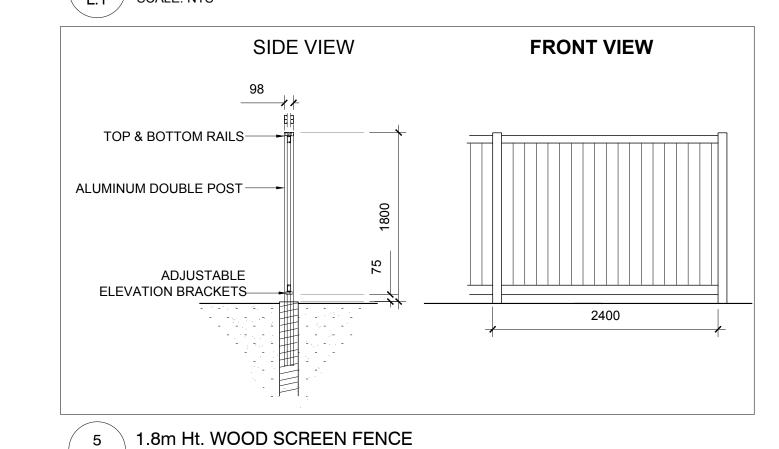

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Land Surveyors

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**LEGEND** 

EXISTING TREE TO BE REMOVED

BE REMOVED

GROUP OF EXISTING TREES TO

EXISTING TREE TO REMAIN

PROPOSED DECIDUOUS TREE

PROPOSED SHRUBS / PERENNIALS

PROPOSED RIVER STONE

PROPOSED SOD

O 1.8m Ht. WOOD BOARD FENCE

TREE PROTECTION FENCE								
6	REVISED PER FORESTRY COMMENTS	05/31/2019	ML	JL				
5	ISSUED FOR MYLARS	03/08/2019	ML	JL				
4	REVISED PER CITY COMMENTS	30/01/2019	ML	JL				
3	REVISED PER NEW SITE PLAN	09/12/2018	ML	JL				
2	REVISED PER NEW SITE PLAN	08/29/2018	ML	JL				
1	ISSUED FOR SITE PLAN CONTROL	04/06/2018	ML	JL				
No.	Issue	Date MM/DD/YY	DR	СК				

JAMES B. LENNOX & ASSOCIATES INC. LANDSCAPE ARCHITECTS 3332 CARLING AVE. OTTAWA, ONTARIO K2H 5A8 Tel. (613) 722-5168 Fax. 1(866) 343-3942

PROJECT

NEW 3 STOREY APARTMENT BUILDING 316 SOMERSET STREET EAST, OTTAWA ON

DRAWING

TREE CONSERVATION REPORT &

LANDSCAPE PLAN

SCALE AS SHOWN START DATE FEBRUARY 2018

PROJECT NO.

DRAWING NO.

18-MIS-1855

