


1 LANDSCAPE PLAN  
L.1  
SCALE 1:250


### PROPOSED PLANT LIST



KEY	QTY.	BOTANICAL NAME	COMMON NAME	SIZE	CONDITION	REMARKS
<b>TREES</b>						
AM	1	Acer ginnale	Amur Maple	60mm Ø	B&B	Single Leader
FM	6	Acer x freemanii	Freeman's Maple	60mm Ø	B&B	See Plan
HB	3	Celtis occidentalis	Hackberry	60mm Ø	B&B	See Plan
HL	3	Gleditsia triacanthos 'Draves'	Street Keeper Honey Locust	60mm Ø	B&B	See Plan
JL	4	Syringa reticulata	Japanese Tree Lilac	60mm Ø	B&B	Single Leader
<b>SHRUBS</b>						
SS	6	Sorbaria sorbifolia 'Sem'	Sem False Spirea	600mm Ht.	Potted	Space 1000mm O.C.
WC	138	Thuja occidentalis 'Clumps'	White Cedar Clumps	1.8m Ht.	Bare Root	3 Trunks or more
<b>PERENNIALS &amp; ORNAMENTAL GRASSES</b>						
KF	44	Calamagrostis x acutiflora 'Karl Foerster'	Feather Reed Grass	250mm pot	Potted	Space 800mm O.C.
MF	12	Hemerocallis 'Moses Fire'	Moses Fire Daylily	800mm Ht.	Potted	Space 400mm O.C.
SD	7	Hemerocallis 'Stella D'Oro'	Stella D'Oro Daylily	100mm pot	Potted	Space 400mm O.C.
SG	24	Panicum virgatum 'Shenandoah'	Shenandoah Switch Grass	250mm pot	Potted	Space 800mm O.C.

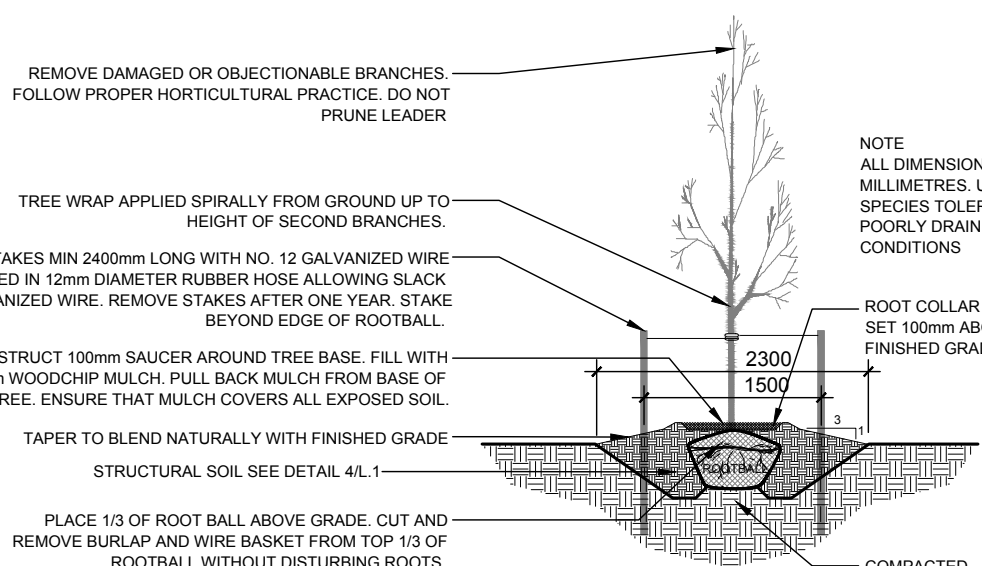

2 DECIDUOUS TREE PLANTING  
L.1  
SCALE: NTS

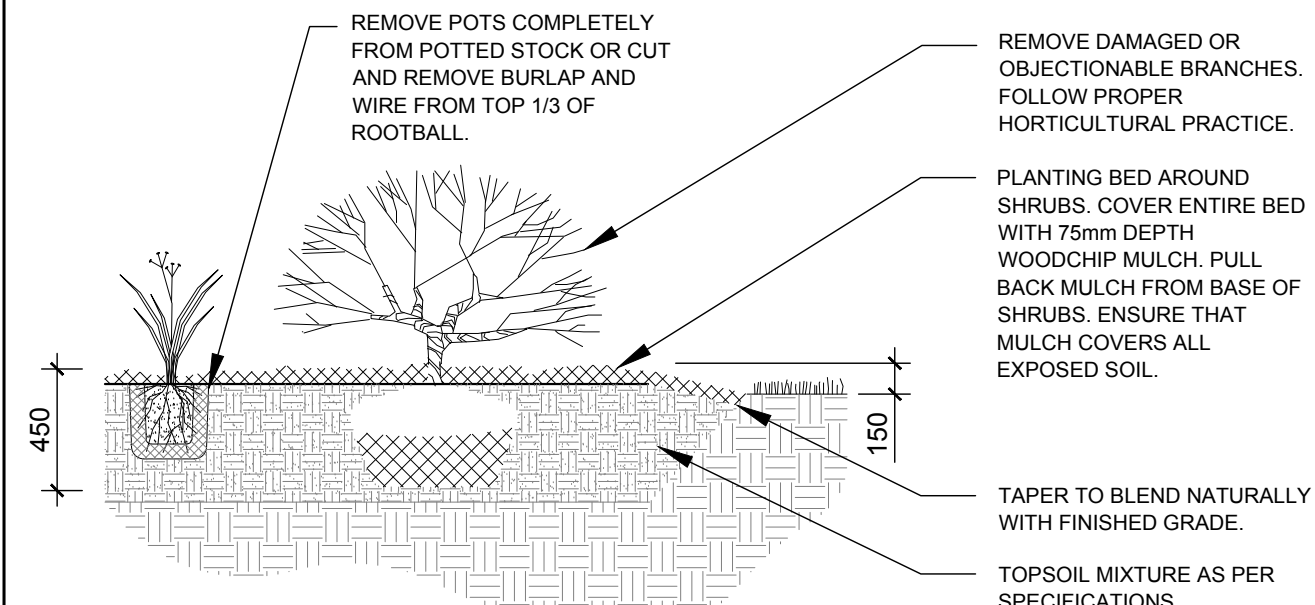

3 SHRUB / PERENNIAL / ORNAMENTAL GRASS PLANTING  
L.1  
SCALE: NTS

### GENERAL NOTES:

- It is the responsibility of the appropriate contractor or official to report any errors, omissions or discrepancies on this plan with actual site conditions to the Landscape Architect before proceeding with construction.
- The contractor is to notify all utility companies and authorities prior to any excavation and ascertain locations of underground services.
- The contractor is to reinstate all areas and items damaged as a result of construction activity.
- The contractor is to comply with all pertinent codes and by-laws.
- The contractor is to maintain a positive surface run-off throughout the entire construction period.
- The Landscape Architect is not responsible for subsurface conditions.
- The contractor is to identify all existing trees to remain on site with the Landscape Architect prior to construction.
- The contractor is to stake the proposed location of all plant material in conjunction with the Landscape Architect prior to excavation.
- Minimum distances for selected deciduous trees are as follows:
  - Building Foundations 7.5m
  - Sidewalks 1.5m
  - Public Streets 2.5m
  - Underground Infrastructure 2.0m
- All trees within 1m of underground utility trenches are to be excavated by hand.
- Remove all protective wrapping from tree trunks after installation.
- Staking of trees shall only be performed if necessary.
- Ensure that mulch is pulled back a min. distance of 75mm from base of tree trunk.

CLIENT:

**Holzman Consultants Inc.**  
Land Development Consultants  
1076 Castle Hill Crescent  
Ottawa, ON K2C 2A8

CONSULTANTS

ARCHITECTS:

**MOORE**  
DESIGN CONSULTANTS  
6104 RIDEAU VALLEY DRIVE  
MANOTICK ON. K4M 1B3  
(613) 692-8445

CIVIL ENGINEERS:

**LRJ**  
ENGINEERING | INGENIERIE  
5430 Canotek Road | Ottawa, ON, K1J 9G2  
www.lrj.ca | (613) 842-3434

LEGEND

- PROPOSED DECIDUOUS TREE
- PROPOSED SHRUBS / PERENNIALS / ORNAMENTAL GRASSES
- PROPOSED RIVERSTONE
- PROPOSED CONCRETE PAVERS
- PROPOSED SOD

1	ISSUED FOR SITE PLAN CONTROL	11/29/2019	ML	JL
No.	Issue	Date	ML	DR

**JAMES B. LENNOX & ASSOCIATES INC.**  
LANDSCAPE ARCHITECTS  
3332 CARLING AVE. OTTAWA, ONTARIO K2H 5A8  
Tel. (613) 722-5168 Fax. (613) 343-3942


PROJECT

MARCELLO'S  
1850 WALKLEY ROAD, OTTAWA ONTARIO


DRAWING

LANDSCAPE PLAN

STAMP

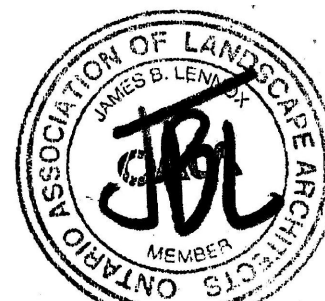

PROJECT NORTH

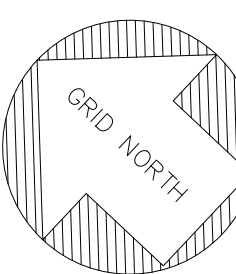

SCALE

AS SHOWN

START DATE

JANUARY 2019

PROJECT NO.

DRAWING NO.

L.1

PLOT SIZE ARCH-D