




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Legend

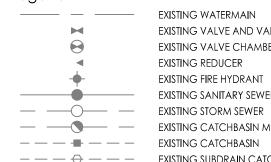

EXISTING WATERMAIN EXISTING VALVE AND VALVE BOX EXISTING VALVE CHAMBER EXISTING REDUCER EXISTING FIRE HYDRANT EXISTING SANITARY SEWER --------- EXISTING CATCHBASIN MANHOLE ---- EXISTING SUBDRAIN CATCHBASIN

Notes

2	REVISED AS PER CITY COMMENTS	 WAJ	PM	25.07.04
1	ISSUED FOR REVIEW	 WAJ	PM	25.04.29
Re	evision	Ву	Appd.	YY.MM.DD
		 		25.03.20

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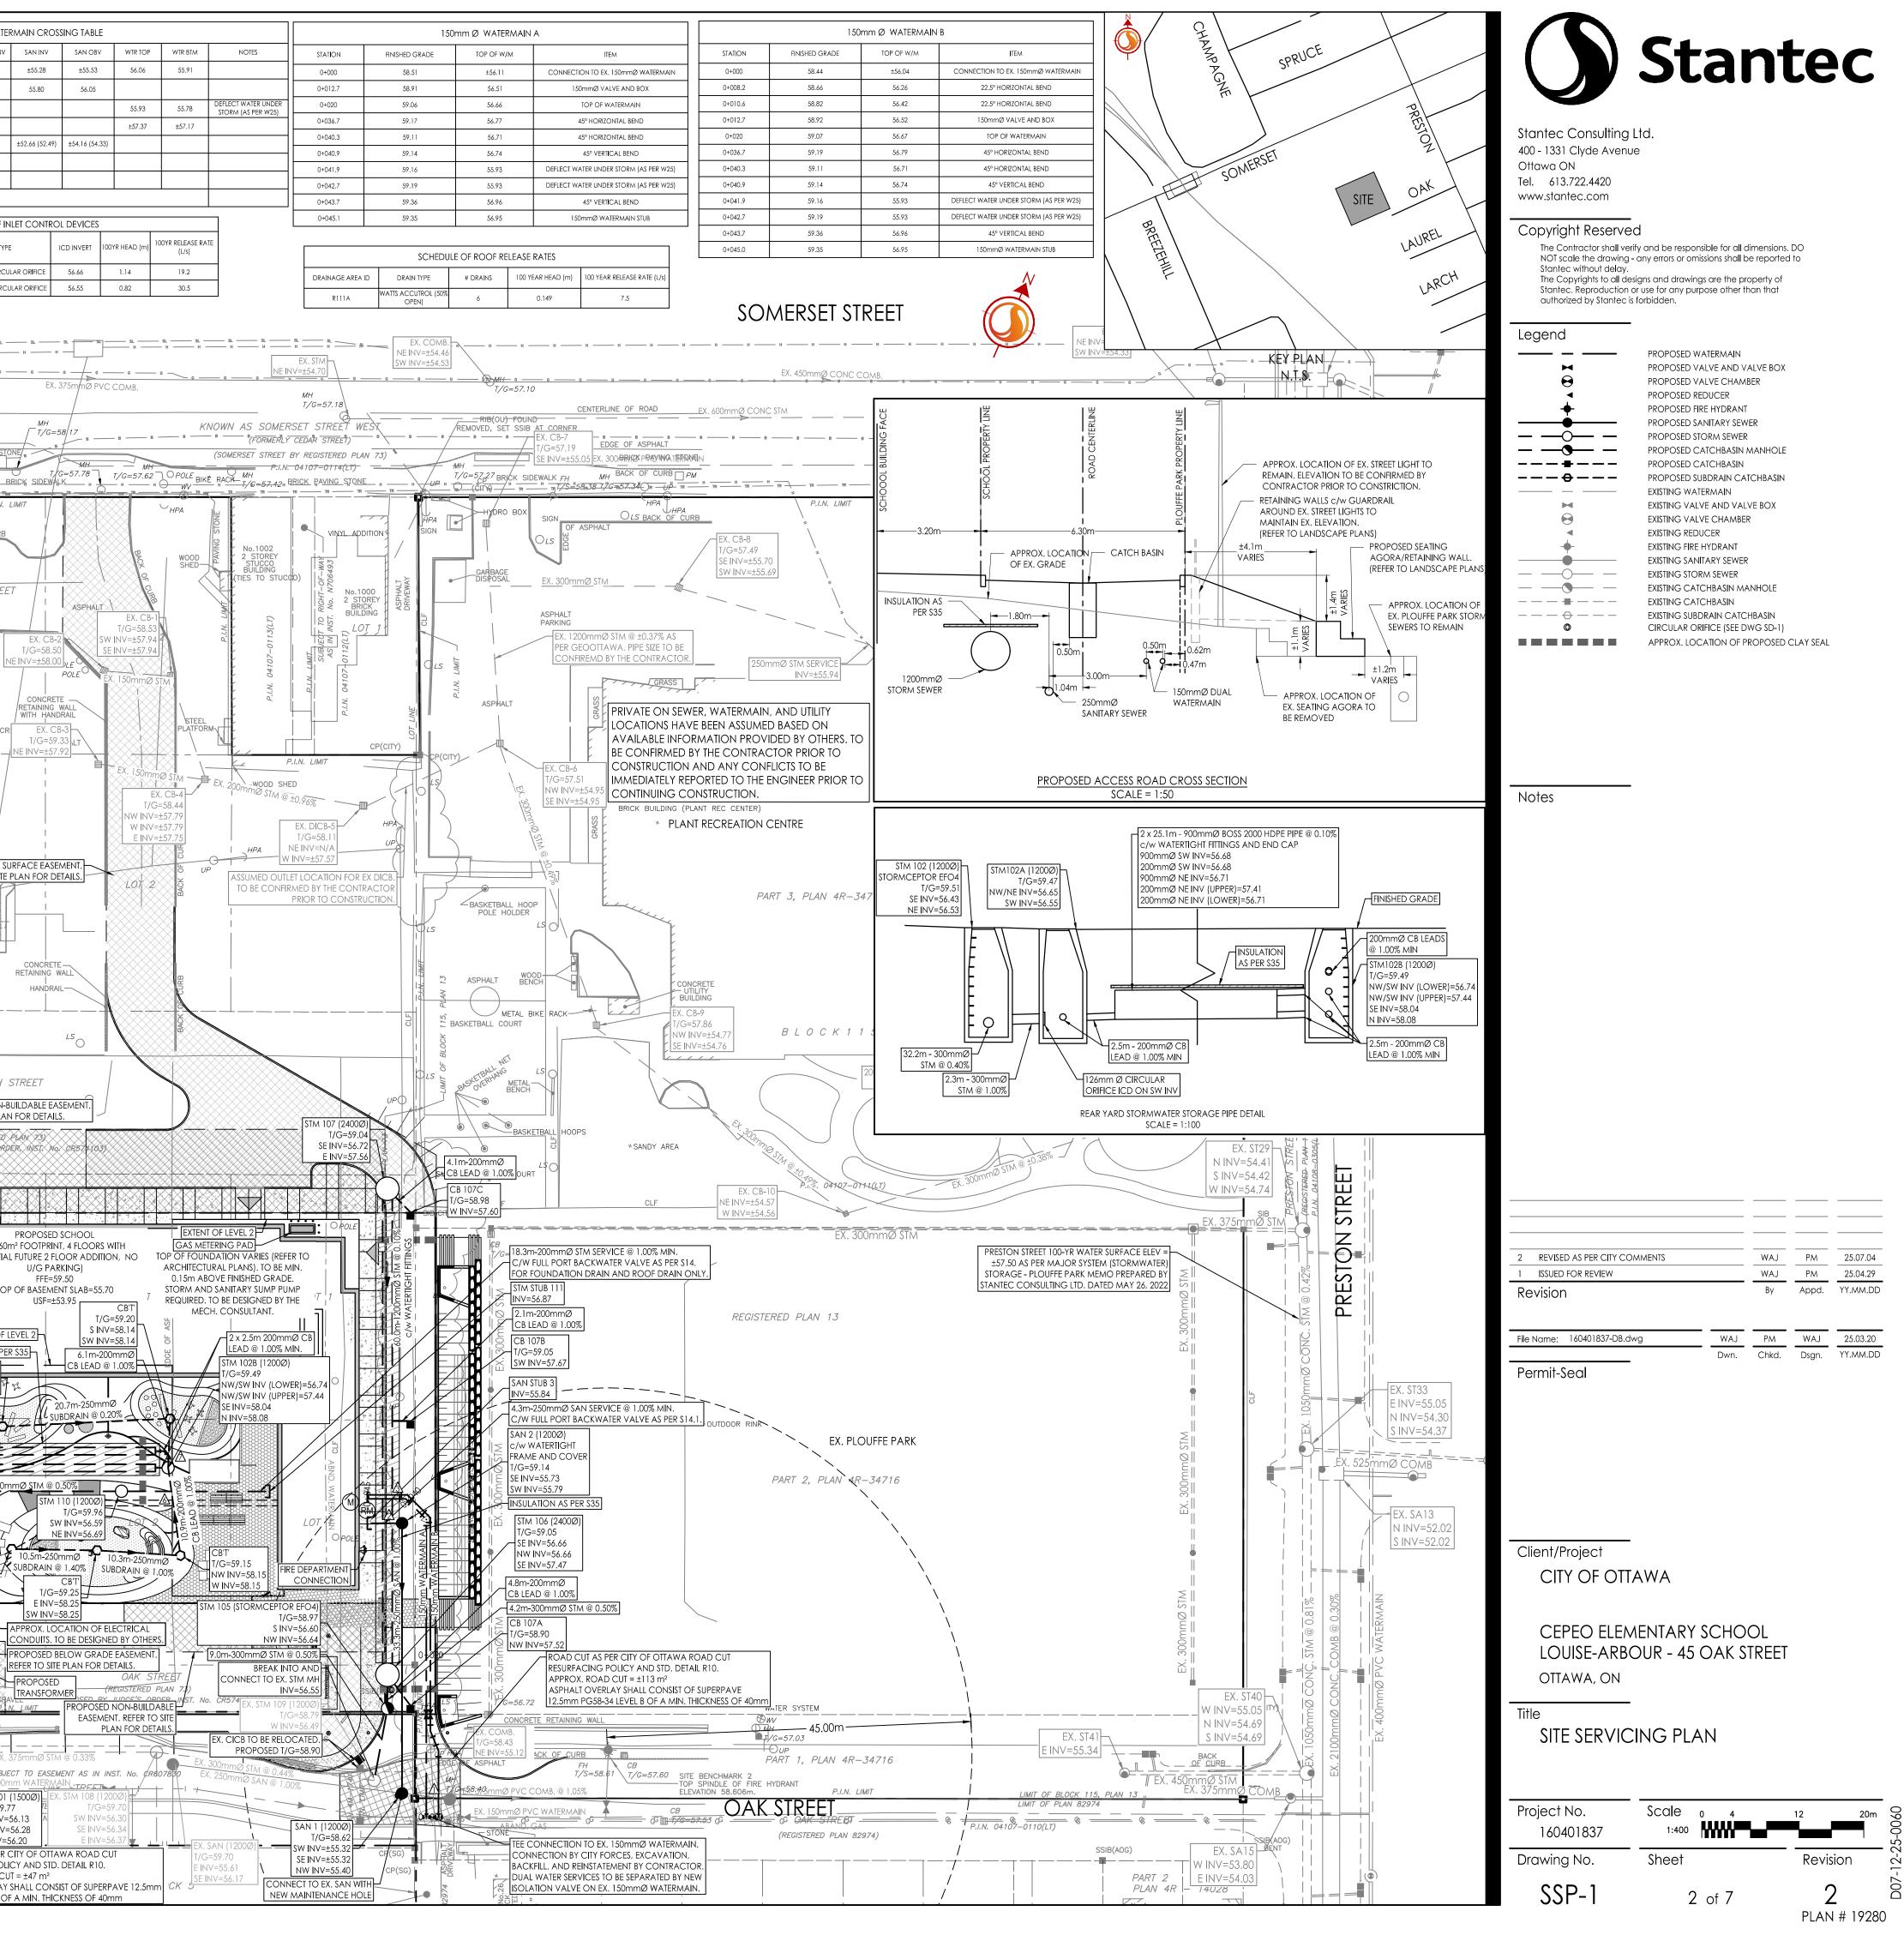
Client/Project CITY OF OTTAWA

> CEPEO ELEMENTARY SCHOOL LOUISE-ARBOUR - 45 OAK STREET OTTAWA, ON

Title EXISTING CONDITIONS AND REMOVALS PLAN

Project No. 160401837	Scale 0 4 1:400	12 20m	25-0060
Drawing No.	Sheet	Revision	-12-2
EX-1	1 of 7	2 PLAN # 19280	
			<i>.</i>

_						
-	NERAL NOTES			1	SE	EWER AND WAT
1. 2.	ALL WORK SHALL BE CARRIED OUT IN COMPLIANCE WITH THE ONTARIO OCCUPATIONAL HEALTH AND SAFETY ACT AND REGULATIONS FOR CONSTRUCTION PROJECTS. ALL WORK AND MATERIALS TO CONFORM WITH CURRENT MINISTRY OF THE ENVIRONMENT & ENERGY OF ONTARIO, CITY OF OTTAWA AND ONTARIO PROVINCIAL	CROSSING	STM INV	STM OBV	STM SUBDRAIN INV	STM SUBDRAIN INV
3.	STANDARDS AND SPECIFICATIONS. LOCAL UTILITY STANDARDS AND MINISTRY OF TRANSPORTATION STANDARDS WILL APPLY WHERE REQUIRED. THE CONTRACTOR IS ADVISED THAT WORKS BY OTHERS MAY BE ONGOING DURING THE PERIOD OF THIS CONTRACT. THE CONTRACTOR SHALL COORDINATE CONSTRUCTION	2	56.68 (56.43)	57.88 (58.03)		
	ACTIVITIES AND COORDINATION WITH ALL OTHER CONTRACTORS AND PREVENT CONSTRUCTION CONFLICTS.	3	56.68 (56.43) 56.12 (56.04)	57.88 (58.03) 56.57 (56.65)		
4.	CONSTRUCTION. ALL EXISTING UTILITIES MUST BE LOCATED AND VERIFIED BY EACH UTILITY PRIOR TO COMMENCEMENT OF WORK. ANY VARIANCE IS TO BE IMMEDIATELY REPORTED TO THE ENGINEER. LOST TIME DUE TO FAILURE OF THE CONTRACTOR TO CONFIRM UTILITY LOCATIONS AND NOTIFY THE ENGINEER OF POSSIBLE CONFLICTS PRIOR	5	56.11 (56.03)	56.56 (56.64)		
5.	TO CONSTRUCTION WILL BE AT THE CONTRACTORS EXPENSE. ALL CONSTRUCTION SHALL BE CARRIED OUT IN ACCORDANCE WITH THE RECOMMENDATIONS MADE IN THE GEOTECHNICAL REPORT.	6 7	56.70 57.44	56.90 57.64	58.07 58.08	58.32 58.33
6.	THE CONTRACTOR IS RESPONSIBLE FOR OBTAINING ALL PERMITS REQUIRED AND TO BEAR THE COST OF SAME INCLUDING WATER PERMIT AND ASSOCIATED COSTS.	* BRACKETS	DENOTE ADJUST	ED VALUE WITH C	ONCRETE PIPE THICK	NESS
7.	ALL DISTURBED AREAS SHALL BE REINSTATED TO EQUAL OR BETTER CONDITION TO THE SATISFACTION THE ENGINEER AND THE CITY OF OTTAWA. PAVEMENT REINSTATEMENT FOR SERVICE AND UTILITY CUTS SHALL BE IN ACCORDANCE WITH CITY OF OTTAWA STANDARD R10, OPSD 509.010 AND OPSS 310.					SCHEDULE OF I
_ 8.	BENCHMARKS: IT IS THE RESPONSIBILITY OF THE CONTRACTOR TO VERIFY THAT THE SITE BENCHMARK(S) HAS NOT BEEN ALTERED OR DISTURBED AND THAT ITS RELATIVE ELEVATION AND DESCRIPTION AGREES WITH THE INFORMATION SHOWN ON DRAWING GP-1.		_	STRUCTURE ID	AREA ID	TY 07C 92mm Ø CIRC
9.	THE CONTRACTOR SHALL PROVIDE TO THE ENGINEER 1 (ONE) SET OF AS CONSTRUCTED SITE SERVICING, GRADING, AND SITE ELECTRICAL DWGS.			STM 102A	L102A	126mm Ø CIRC
10	CONTRACTOR TO LOCATE EXISTING SERVICE LATERALS PRIOR TO CONSTRUCTION. EXISTING STORM AND SANITARY SERVICE LATERALS TO BE ABANDONED PER \$11.4. EXISTING WATER SERVICE TO BE BLANKED AT THE MAIN (TYP.)					
	TOPOGRAPHIC SURVEY SUPPLIED BY CALLON DIETZ INCORPORATED DATED FEBRUARY 26, 2025 FILE No. 25-27060.		SL SI	sL		SL SL
	SITE PLAN PREPARED BY HOBIN ARCHITECTURE DATED JULY 2, 2025, PROJECT NO. 2457. GEOTECHNICAL INVESTIGATION PREPARED BY PATERSON GROUP DATED MARCH 21, 2025, REPORT NO. PG7468-1. GEOTECHNICAL INFORMATION PRESENTED ON THESE	<u> </u>			_	G G
	DRAWINGS MAY BE INTERPOLATED FROM THE ORIGINAL REPORT. REFER TO ORIGINAL GEOTECHNICAL REPORT FOR ADDITIONAL DETAILS AND TO VERIFY ASSUMPTIONS MADE HERE				-	
	REFER TO LANDSCAPE ARCHITECTURE PLAN FOR ALL LANDSCAPING FEATURES (ie. TREES, WALKWAYS, PARK DETAILS, NOISE BARRIERS, FENCES etc.)	RMAIN				
	ALL DIMENSIONS ARE IN METRES UNLESS OTHERWISE STATED. DIMENSIONS SHALL BE CHECKED AND VERIFIED IN THE FIELD BY THE CONTRACTOR PRIOR TO THE START OF CONSTRUCTION. ANY DISCREPANCIES TO BE REPORTED IMMEDIATELY TO ENGINEER.				B	BRICK PAVING S
17	THERE WILL BE NO SUBSTITUTION OF MATERIALS UNLESS PRIOR WRITTEN APPROVAL BY THE CONTRACT ADMINISTRATOR AND PROJECT ENGINEER HAS BEEN	— в — — н — тя —	— B — B · B · H ·	B H	_ 9 — н — 7/G <i>=58</i> тг <u>— НРА</u> гу	- 18 - 1
18	OBTAINED. HERITAGE OPERATIONS UNIT OF THE ONTARIO MINISTRY OF CULTURE TO BE NOTIFIED IF DEEPLY BURRIED ARCHEOLOGICAL REMAINS ARE FOUND ON THE					Р.І.N.) _{НРА}
w	PROPERTY DURING CONSTRUCTION ACTIVITIES.					BACK OF CURE
1.	THE CONTRACTOR SHALL CONSTRUCT WATERMAIN, WATER SERVICES, CONNECTIONS & APPURTENANCES AS PER CITY OF OTTAWA SPECIFICATIONS & SHALL CO-ORDINATE AND PAY ALL RELATED COSTS INCLUDING THE COST OF CONNECTION, INSPECTION & DISINFECTION BY CITY PERSONNEL.					
2.	WATERMAIN PIPE MATERIAL SHALL BE PVC CL. 150 DR 18. DEFLECTION OF WATERMAIN PIPE IS NOT TO EXCEED 1/2 OF THAT SPECIFIED BY THE MANUFACTURER. PVC WATERMAINS TO BE INSTALLED WITH TRACER WIRE IN ACCORDANCE WITH CITY OF OTTAWA STANDARD W36.			l SOL	ITH OF SOM	ERSET STRE
3.		LOT 4				
4.	WATERMAIN TRENCH AND BEDDING SHALL BE IN ACCORDANCE WITH CITY OF OTTAWA STD. W17 UNLESS OTHERWISE SPECIFIED. BEDDING AND COVER MATERIAL TO BE SPECIFIED BY PROJECT GEOTECHNICAL CONSULTANT.					LOT 3
_ 5.	SERVICE CONNECTIONS SHALL BE INSTALLED A MINIMUM OF 2400mm FROM ANY CATCHBASIN, MANHOLE, OR OBJECT THAT MAY CONTRIBUTE TO FREEZING. THERMAL INSULATION SHALL BE INSTALLED ON ALL PROPOSED CB'S ON THE W/M STREET SIDE WHERE 2400mm SEPARATION CANNOT BE ACHIEVED (AS PER CITY OF OTTAWA STD.				GAS METER	
6.	W22 & W23). CATHODIC PROTECTION TO BE SUPPLIED ON METALIC FITTINGS AS PER CITY OF OTTAWA STD. W40 AND W42.				EXISTING	
	ALL WATERMAIN BENDS, JOINTS, TEES AND PLUGS SHALL BE MECHANICALLY RESTRAINED IN ACCORDANCE WITH CITY OF OTTAWA STANDARDS.			віос	СКВ	CONC
8.	WHERE SPECIFIC WATERMAIN ELEVATIONS ARE NOT SHOWN ON THE SERVICING DRAWING, A MINIMUM COVER OF 2.4m FROM PROPOSED GRADES, AS SHOWN ON	REFE	R TO 10	10 SOME	RSET STRE	ET]
	THE GRADING PLAN, MUST BE MAINTAINED AT ALL TIMES. IN PREGRADE AREAS COVER TO BE FROM PREGRADED ELEVATIONS. WHERE WATERMAIN COVER IS LESS THAN 2.4m, INSULATION TO BE SUPPLIED IN ACCORDANCE WITH CITY OF OTTAWA STD. W22.) by stant 160402067	- /
9.	WATERMAINS MUST COMPLY WITH MINIMUM HORIZONTAL AND VERTICAL CLEARANCES IN ACCORDANCE WITH LOCAL PROVINCIAL GUIDELINES AND THE APPLICARLE.	CONC	EPTUAL	design	OF THE FU	TURE
- 10	ALL WATERMAINS SHALL BE HYDROSTATICALLY TESTED IN ACCORDANCE WITH THE CITY OF OTTAWA AND ONTARIO GUIDELINES UNLESS OTHERWISE DIRECTED. PROVISIONS FOR FLUSHING WATER LINE PRIOR TO TESTING, ETC. MUST BE PROVIDED.	1010	SOMERS		T COMPLI	
11	ALL WATERMAINS SHALL BE BACTERIALOGICALLY TESTED IN ACCORDANCE WITH THE CITY OF OTTAWA AND ONTARIO GUIDELINES. ALL CHLORINATED WATER TO BE 🔗	LOT 4			ſ	REFER TO SITE
	DISCHARGED AND PRETREATED TO ACCEPTABLE LEVELS PRIOR TO DISCHARGE. ALL DISCHARGED WATER MUST BE CONTROLLED AND TREATED SO AS NOT TO ADVERSELY EFFECT THE ENVIRONMENT. IT IS THE RESPONSIBILITY OF THE CONTRACTOR TO ENSURE THAT ALL MUNICIPAL AND/OR PROVINCIAL REQUIREMENTS ARE FOLLOWED.	0			NORTH OF	EXISTING BUILDING ASH STREE
12	FIRE HYDRANTS TO BE INSTALLED AS PER CITY OF OTTAWA STANDARDS W18 AND W19.			YUP		
	. WATER VALVES TO BE INSTALLED AS PER CITY OF OTTAWA STANDARD W24. . THRUST BLOCKS TO BE INSTALLED AS PER CITY OF OTTAWA STANDARDS W25.3 AND W25.4.					
15	WATERMAIN CROSSINGS ABOVE AND BELOW SEWERS TO BE INSTALLED AS PER CITY OF OTTAWA STANDARD W25 AND W25.2.					
	. SERVICE SIZES, LOCATIONS, AND ELEVATIONS TO BE CONFIRMED BY THE MECHANICAL ENGINEER. DRM AND SANITARY SEWERS					
1.	STORM AND SANITARY SEWERS 375mm DIA. OR SMALLER SHALL BE PVC SDR35. SEWERS LARGER THAN 375mm SHALL BE CONCRETE CSA A 257.2 CLASS 100D		Uł	~	CLF	
2.	SEWER TRENCH SHALL CONSIST OF CLASS 'B' BEDDING PER CITY OF OTTAWA STANDARDS S6 AND S7. COMPACTION SHALL BE AS PER GEOTECHNICAL CONSULTANT RECOMMENDATIONS, THE BEDDING LAYER THICKNESS SHOULD BE INCREASED TO A MINIMUM OF 300 mm WHERE THE SUBGRADE WILL CONSIST OF GREY SILTY CLAY.		= HF	24	FRAME SHED	ASH
	TRENCH EXCAVATIONS ADVANCED BELOW THE CLAY DEPOSIT AND THROUGHOUT THE UPPER PORTION OF THE LOOSE SILTY CLAY GLACIAL TILL MAY REQUIRE BEDDING THICKNESS IN THE RANGE OF 500 TO 600 mm AND WRAPPED IN GEOGRID TO CONSIDER THE LESSER STIFF NATURE OF THE IN-SITU SOILS AT THOSE DEPTHS. REFER TO GEOTECHNICAL REPORT PREPARED BY PATERSON GROUP DATED MARCH 21, 2025. REPORT NO. PG7468-1 FOR DETAILS.	\rightarrow	. EDGE OF	ASPHALT		ROPOSED NON- EFER TO SITE PLA
3.	FOR CONSTRUCTION DETAILS NOT SHOWN ON PLANS, REFERENCE SHALL BE MADE TO THE ONTARIO PROVINCIAL STANDARDS DRAWINGS AND CITY OF OTTAWA	X	P. V. N. 0	4107 -	0 3 0 3 (LT) CLOSED	(RÉGISTEREL BY JUDGE'S OR
4.	STANDARDS. ——— SERVICES TO BUILDINGS TO BE TERMINATED 1.0m FROM THE FACE OF BUILDING UNLESS OTHERWISE NOTED.					
5.	THE CONTRACTOR IS TO PROVIDE CCTV CAMERA INSPECTIONS OF ALL SANITARY AND STORM SEWERS, INCLUDING PICTORIAL REPORT, ONE (1) CD COPY AND TWO (2) VIDEO TAPES IN A FORMAT SATISFACTORY TO THE ENGINEER, ALL SEWERS ARE TO BE FLUSHED PRIOR TO CAMERA INSPECTION, ASPHALT WEAR COURSE SHALL NOT BE					
6.	PLACED UNTIL THE VIDEO INSPECTION OF SEWERS & NECESSARY REPAIRS HAVE BEEN CARRIED OUT TO THE SATISFACTION OF THE CONSULTANT.		<u>– – – – – – – – – – – – – – – – – – – </u>		\soutii oE	
7.			0.10% c/w M FITTINGS AN 900mmØ SW	D END CAP		POTENTI
8.	CONTRACTOR SHALL PERFORM LEAKAGE TESTING, IN THE PRESENCE OF THE CONSULTANT, FOR SANITARY SEWERS IN ACCORDANCE WITH OPSS 410 AND OPSS 407. A COPY OF THE INSPECTION REPORT SHALL BE SUBMITTED TO THE CONSULTANT FOR REVIEW.		200mmØ SW 900mmØ N Ø NE INV (UF	E NV=56.71		тс
9.	STORM SERVICE CONNECTION AS PER CITY STD DWG \$11.1; SANITARY SERVICE CONNECTION AS PER CITY STD DWG \$11.1. SERVICES TO CONNECT TO THE OBVERT OF					/
10	CONTRACTOR TO VERIFY EXISTING SEWERS AND INVERTS, AND REPORT ANY DISCREPANCIES TO SITE ENGINEER BEFORE PROCEEDING WITH CONSTRUCTION.	L	2.5m 200mm EAD @ 1.00%			EXTENT OF
11	STORM AND SANITARY MANHOLES SHALL BE 1200mm DIAMETER IN ACCORDANCE WITH OPSD-701.01 (UNLESS OTHERWISE NOTED) c/w FRAME AND COVER AS PER CITY OF OTTAWA S24, S24.1, AND S25 WHERE APPLICABLE. CATCH BASIN MANHOLE FRAME AND COVERS PER S19, S28, AND S28.1 WHERE APPLICABLE. ALL STORM MANHOLES WITH SEWERS 000mm DIA SEWERS AND OVER IN SIZE SHALL BE RENCHED ALL OTHER STORM MANHOLES SHALL BE COMPLETED WITH		STM 102A (12 T/G= NW/NE INV=	59.47		CB'T' T/G=59.18
	STORM MANHOLES WITH SEWERS 900mm DIA SEWERS AND OVER IN SIZE SHALL BE BENCHED. ALL OTHER STORM MANHOLES SHALL BE COMPLETED WITH 300mm SUMPS AS PER CITY STANDARDS. SANITARY MANHOLES SHALL NOT HAVE SUMPS.		SW INV=	56.55		NEINV=58.18
12	CATCH BASINS SHALL BE IN ACCORDANCE WITH CITY STANDARDS c/w FRAME AND GRATE. REAR YARD CB'S SHALL BE AS PER S19.1, STREET CB'S AS PER S2		nmØ STM @ 1 STM 102 (120			
10	WITH INLET CONTROL DEVICES (ICD) AS PER ICD SCHEDULE ON STORM DRAINAGE PLAN. STREET CATCH BASINS TO BE INSTALLED c/w SUBDRAINS 3m LONG IN FOUR ORTHOGONAL DIRECTIONS OR LONGITUDINALLY WHEN PLACED ALONG A CURB.		MCEPTOR EF T/G=5	04) <i>RE</i> (9.51 		
	AND AT AN ELEVATION OF 300mm BELOW SUBGRADE LEVEL.	9m-300mr	SE INV=50 NE INV=50 mØ STM @ 0.4	6.53		<u>2</u> 4.8 <u>m-300</u>
	CLAY SEALS TO BE INSTALLED AS PER CITY STANDARD S8. THE SEALS SHOULD BE AT LEAST 1.5m LONG (IN THE TRENCH DIRECTION) AND SHOULD EXTEND FROM TRENCH		101A (1200Ø T/G=59.6	¹⁾] 3		
	WALL TO TRENCH WALL. THE SEALS SHOULD EXTEND FROM THE FROST LINE AND FULLY PENETRATE THE BEDDING, SUBBEDDING AND COVER MATERIAL. THE CLAY SEALS SHOULD CONSIST OF RELATIVELY DRY AND COMPATIBLE BROWN SILTY CLAY PLACED IN MAXIMUM 225mm THICK LOOSE LIFTS AND COMPACTED TO A MINIMUM OF 95% OF THE MATERIALS SPMDD. THE CLAY SEALS SHOULD BE PLACED AT THE SITE BOUNDARIES AND AT STRATEGIC LOCATIONS AT NO MORE THAN 60m INTERVALS IN THE		SE INV=56.4 NW INV=56.4 NE INV=56.4	2		
	SERVICE TRENCHES. FOR DETAILS REFER TO GEOTECHNICAL INVESTIGATION PREPARED BY PATERSON GROUP DATED MARCH 21, 2025, REPORT NO. PG7468-1.	_	EX. COMB n x 2438mm)	1	NOR 4	CB'T' T/G=59.40 IE INV=58.40
			T/G=60.05 W INV=52.55 SE INV=52.60			
			SE INV=52.60		Jmmø SIA	
_	CONSTRUCTION LIMIT	2609352				
	, PLAN 4R-36236 SUBJECT TO EASEMENT AS IN INST. No. 0C2746 90 EX. 1650mm@ STM @ 0.29%	36236				
	LIMIT OF PLAN 4M-1741					2 <u>5 0 m</u>
u l	EXTENT OF PRIVATE PROPERTY (HATCHED)					<u>8=0 uuu</u>
n, Warren	P.I.N. 04107–0312(LT) BREAK INTO AND CONNECT TO EX. MI INV/-54 O		17			EX SUB. EX. 200
, nosnho	BLOCK 4	5		500mm		STM 101 T/G=59
AM By:	۵ NW INV=54.8 SE INV=54.8	9		Ø CON		
2025/07/04 9:55 AM By:	EX. STORM SEWER TO BE REMOVE AND REPLACED WIT	n Z		B @ 0.3	RES	AD CUT AS PER SURFACING PO
025/07/	12.2m-450mmØ STM @ 0.33		0.30%	5%	AS	PROX. ROAD C PHALT OVERLA 558-34 LEVEL B C
ы Г	riginal sheet - arch d					4 LEVEL B (






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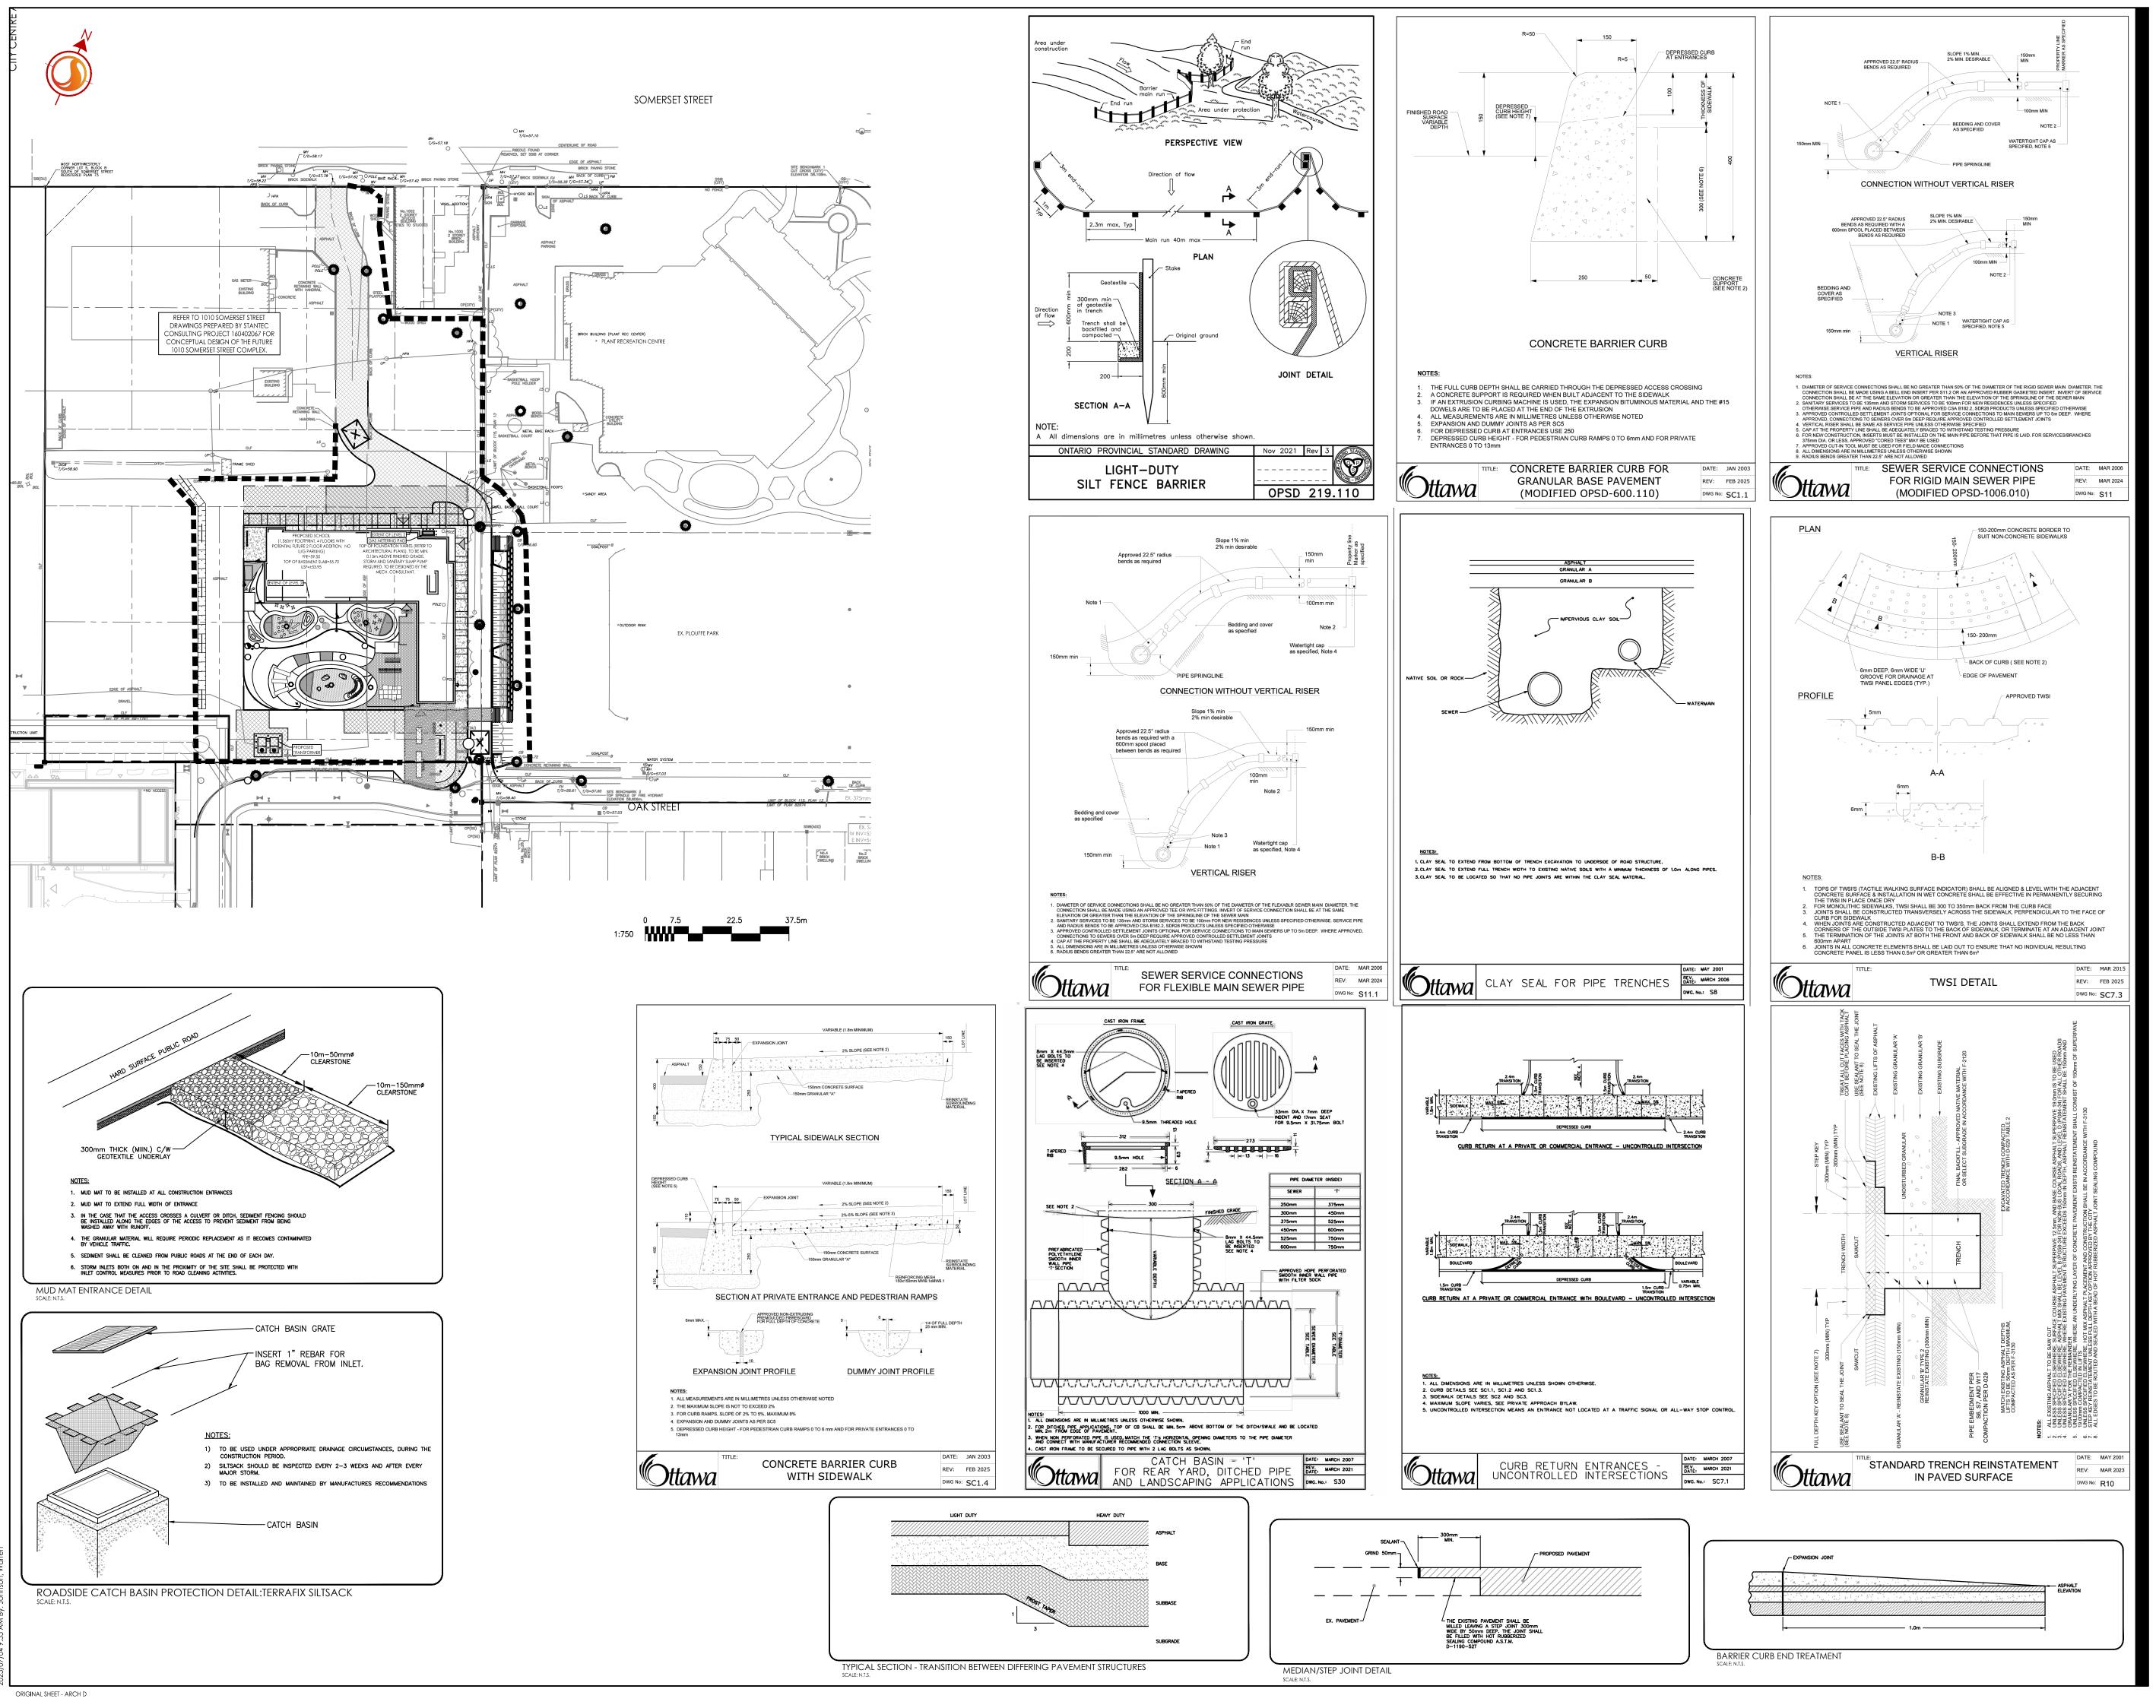
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PLAN # 19280




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Legend

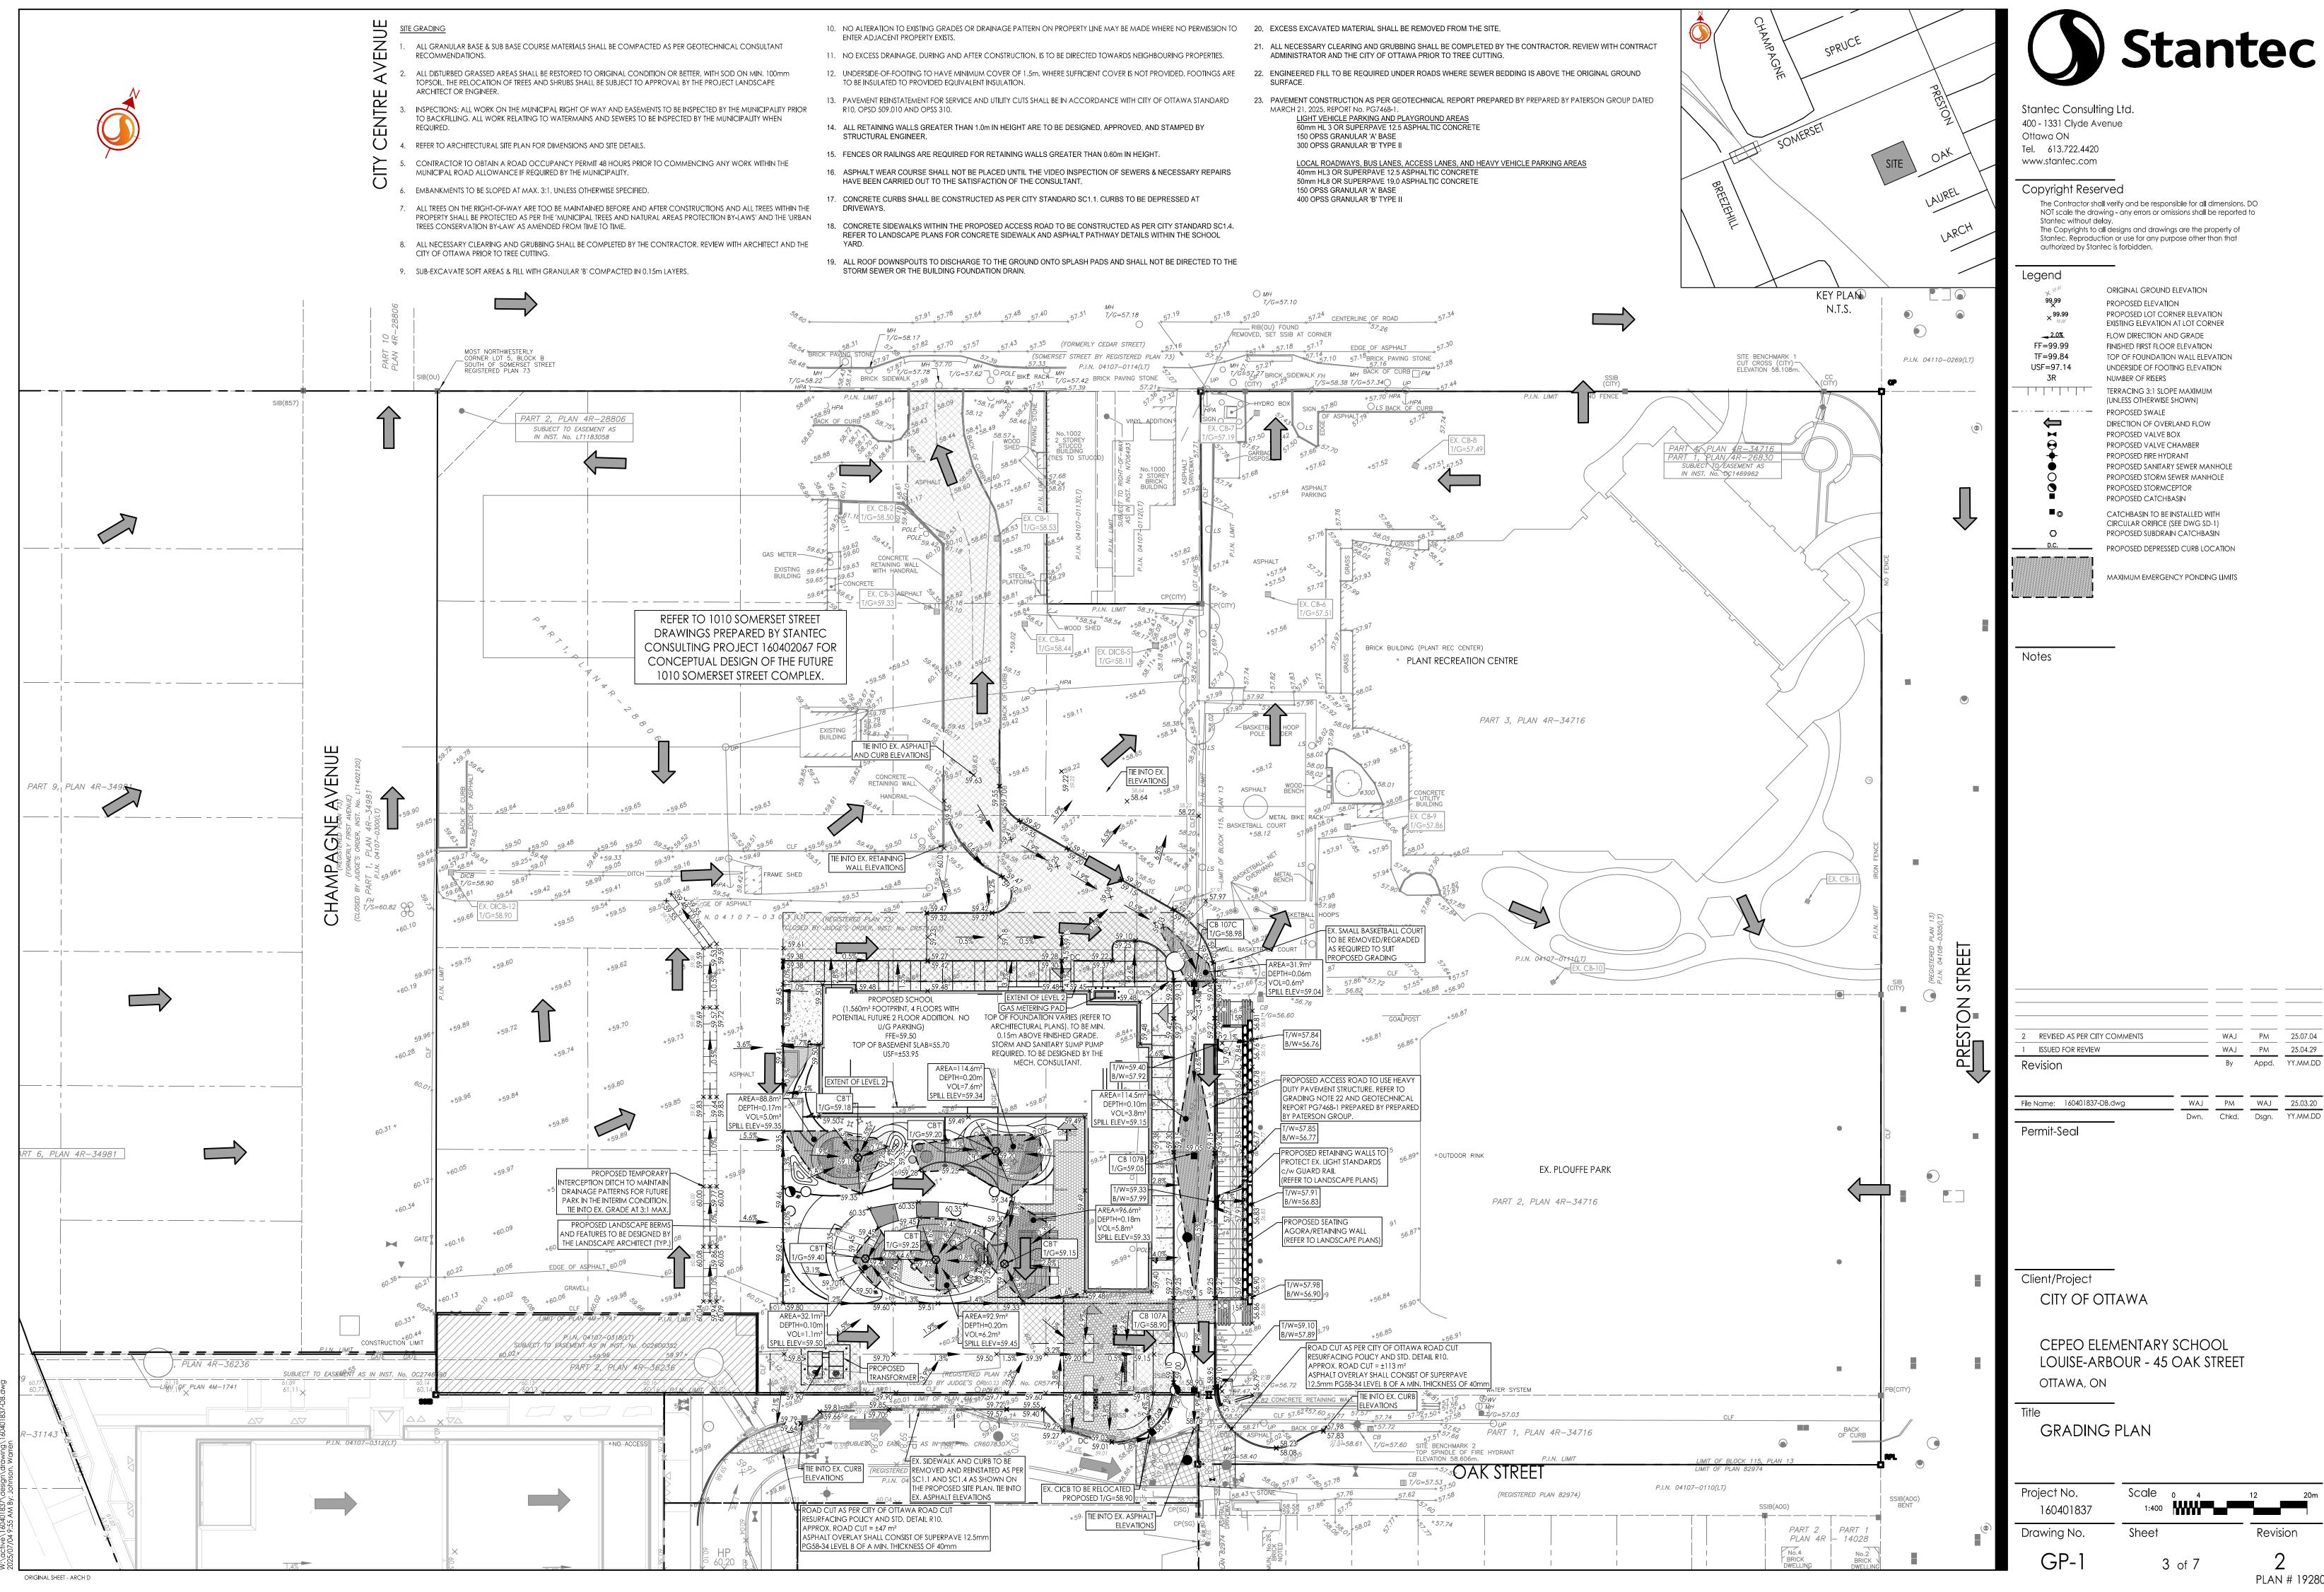

PROPOSED SILT FENCE BOUNDARY AS PER OPSD 219.110

- PROPOSED CATCH BASIN PROTECTION AS PER DETAIL
- PROPOSED MUD MAT LOCATION

Best Management Practices

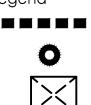CONTRACTOR TO PROVIDE EROSION AND SEDIMENT CONTROLS (BEST MANAGEMENT PRACTICES) DURING CONSTRUCTION OF THIS PROJECT.

EROSION MUST BE MINIMIZED AND SEDIMENTS MUST BE REMOVED FROM CONSTRUCTION SITE RUN-OFF IN ORDER TO PROTECT DOWNSTREAM AREAS. DURING ALL CONSTRUCTION, EROSION AND SEDIMENTATION SHOULD BE CONTROLLED BY THE FOLLOWING TECHNIQUES:

- 1. LIMIT THE EXTENT OF EXPOSED SOILS AT ANY GIVEN TIME.
- REVEGETATE EXPOSED AREAS AND SLOPES AS SOON AS POSSIBLE.
- MINIMIZE AREA TO BE CLEARED AND GRUBBED.
- PROTECT EXPOSED SLOPES WITH PLASTIC OR SYNTHETIC MULCHES.
- INSTALL FILTER CLOTH BETWEEN FRAME AND COVER ON ALL PROPOSED CATCH BASINS AND CATCH BASIN MANHOLES AND ON ALL EXISTING CATCH BASINS THAT WILL RECEIVE RUN-OFF FROM THE SITE.
- A SILT FENCE SHALL BE INSTALLED AROUND THE PERIMETER OF ALL AND ANY STOCKPILES OF MATERIAL TO BE USED OR REMOVED FROM SITE. (LOCATION TO BE DETERMINED)
- A VISUAL INSPECTION SHALL BE DONE DAILY ON SEDIMENT CONTROL MEASURES AND CLEANED OF ANY ACCUMULATED SILT AS REQUIRED. THE DEPOSITS WILL BE DISPOSED OFF SITE AS PER THE REQUIREMENTS OF THE CONTRACT.
- SEDIMENT CONTROL BARRIERS MAY ONLY BE REMOVED TEMPORARILY WITH APPROVAL OF CONTRACT ADMINISTRATOR TO ACCOMMODATE CONSTRUCTION OPERATIONS. ALL AFFECTED BARRIERS MUST BE REINSTATED AT NIGHT WHEN CONSTRUCTION IS COMPLETED. NO REMOVAL WILL OCCUR IF THERE IS A SIGNIFICANT RAINFALL EVENT ANTICIPATED (>10mm) UNLESS A NEW DEVICE HAS BEEN INSTALLED TO PROTECT THE EXISTING STORM AND SANITARY SEWER SYSTEMS.
- NO REFUELING OR CLEANING OF EQUIPMENT IS PERMITTED NEAR ANY EXISTING WATERWAY.
- CONTRACTOR SHALL REMOVE SEDIMENT CONTROL MEASURES WHEN, IN THE OPINION OF THE CONTRACT ADMINISTRATOR, THE MEASURE(S) IS NO LONGER REQUIRED. NO CONTROL MEASURES SHALL BE PERMANENTLEY REMOVED WITHOUT PRIOR WRITTEN AUTHORIZATION FROM THE CONTRACT ADMINISTRATOR.
- THE CONTRACTOR SHALL PERIODICALLY, OR WHEN REQUESTED BY THE CONTRACT ADMINISTRATOR, CLEAN OUT ACCUMULATED SEDIMENTS AS REQUIRED.
- THE CONTRACTOR SHALL IMMEDIATELY REPORT TO THE ENGINEER ANY ACCIDENTAL DISCHARGES OF SEDIMENT MATERIAL INTO THE WATERCOURSE. APPROPRIATE RESPONSE MEASURES, INCLUDING ANY REPAIRS TO EXISTING CONTROL MEASURES OR THE IMPLEMENTATION OF ADDITIONAL CONTROL MEASURES, SHALL BE CARRIED OUT BY THE CONTRACTOR WITHOUT DELAY.
- 13. CONTRACTOR SHALL INSTALL MUD MATS AT ALL ENTRANCES TO THE SITE.
- 14. CONTRACTOR IS RESPONSIBLE TO KEEP THE ROADS FREE AND CLEAN FROM MUD AND DEBRIS.

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Client/Project CITY OF OTTAWA

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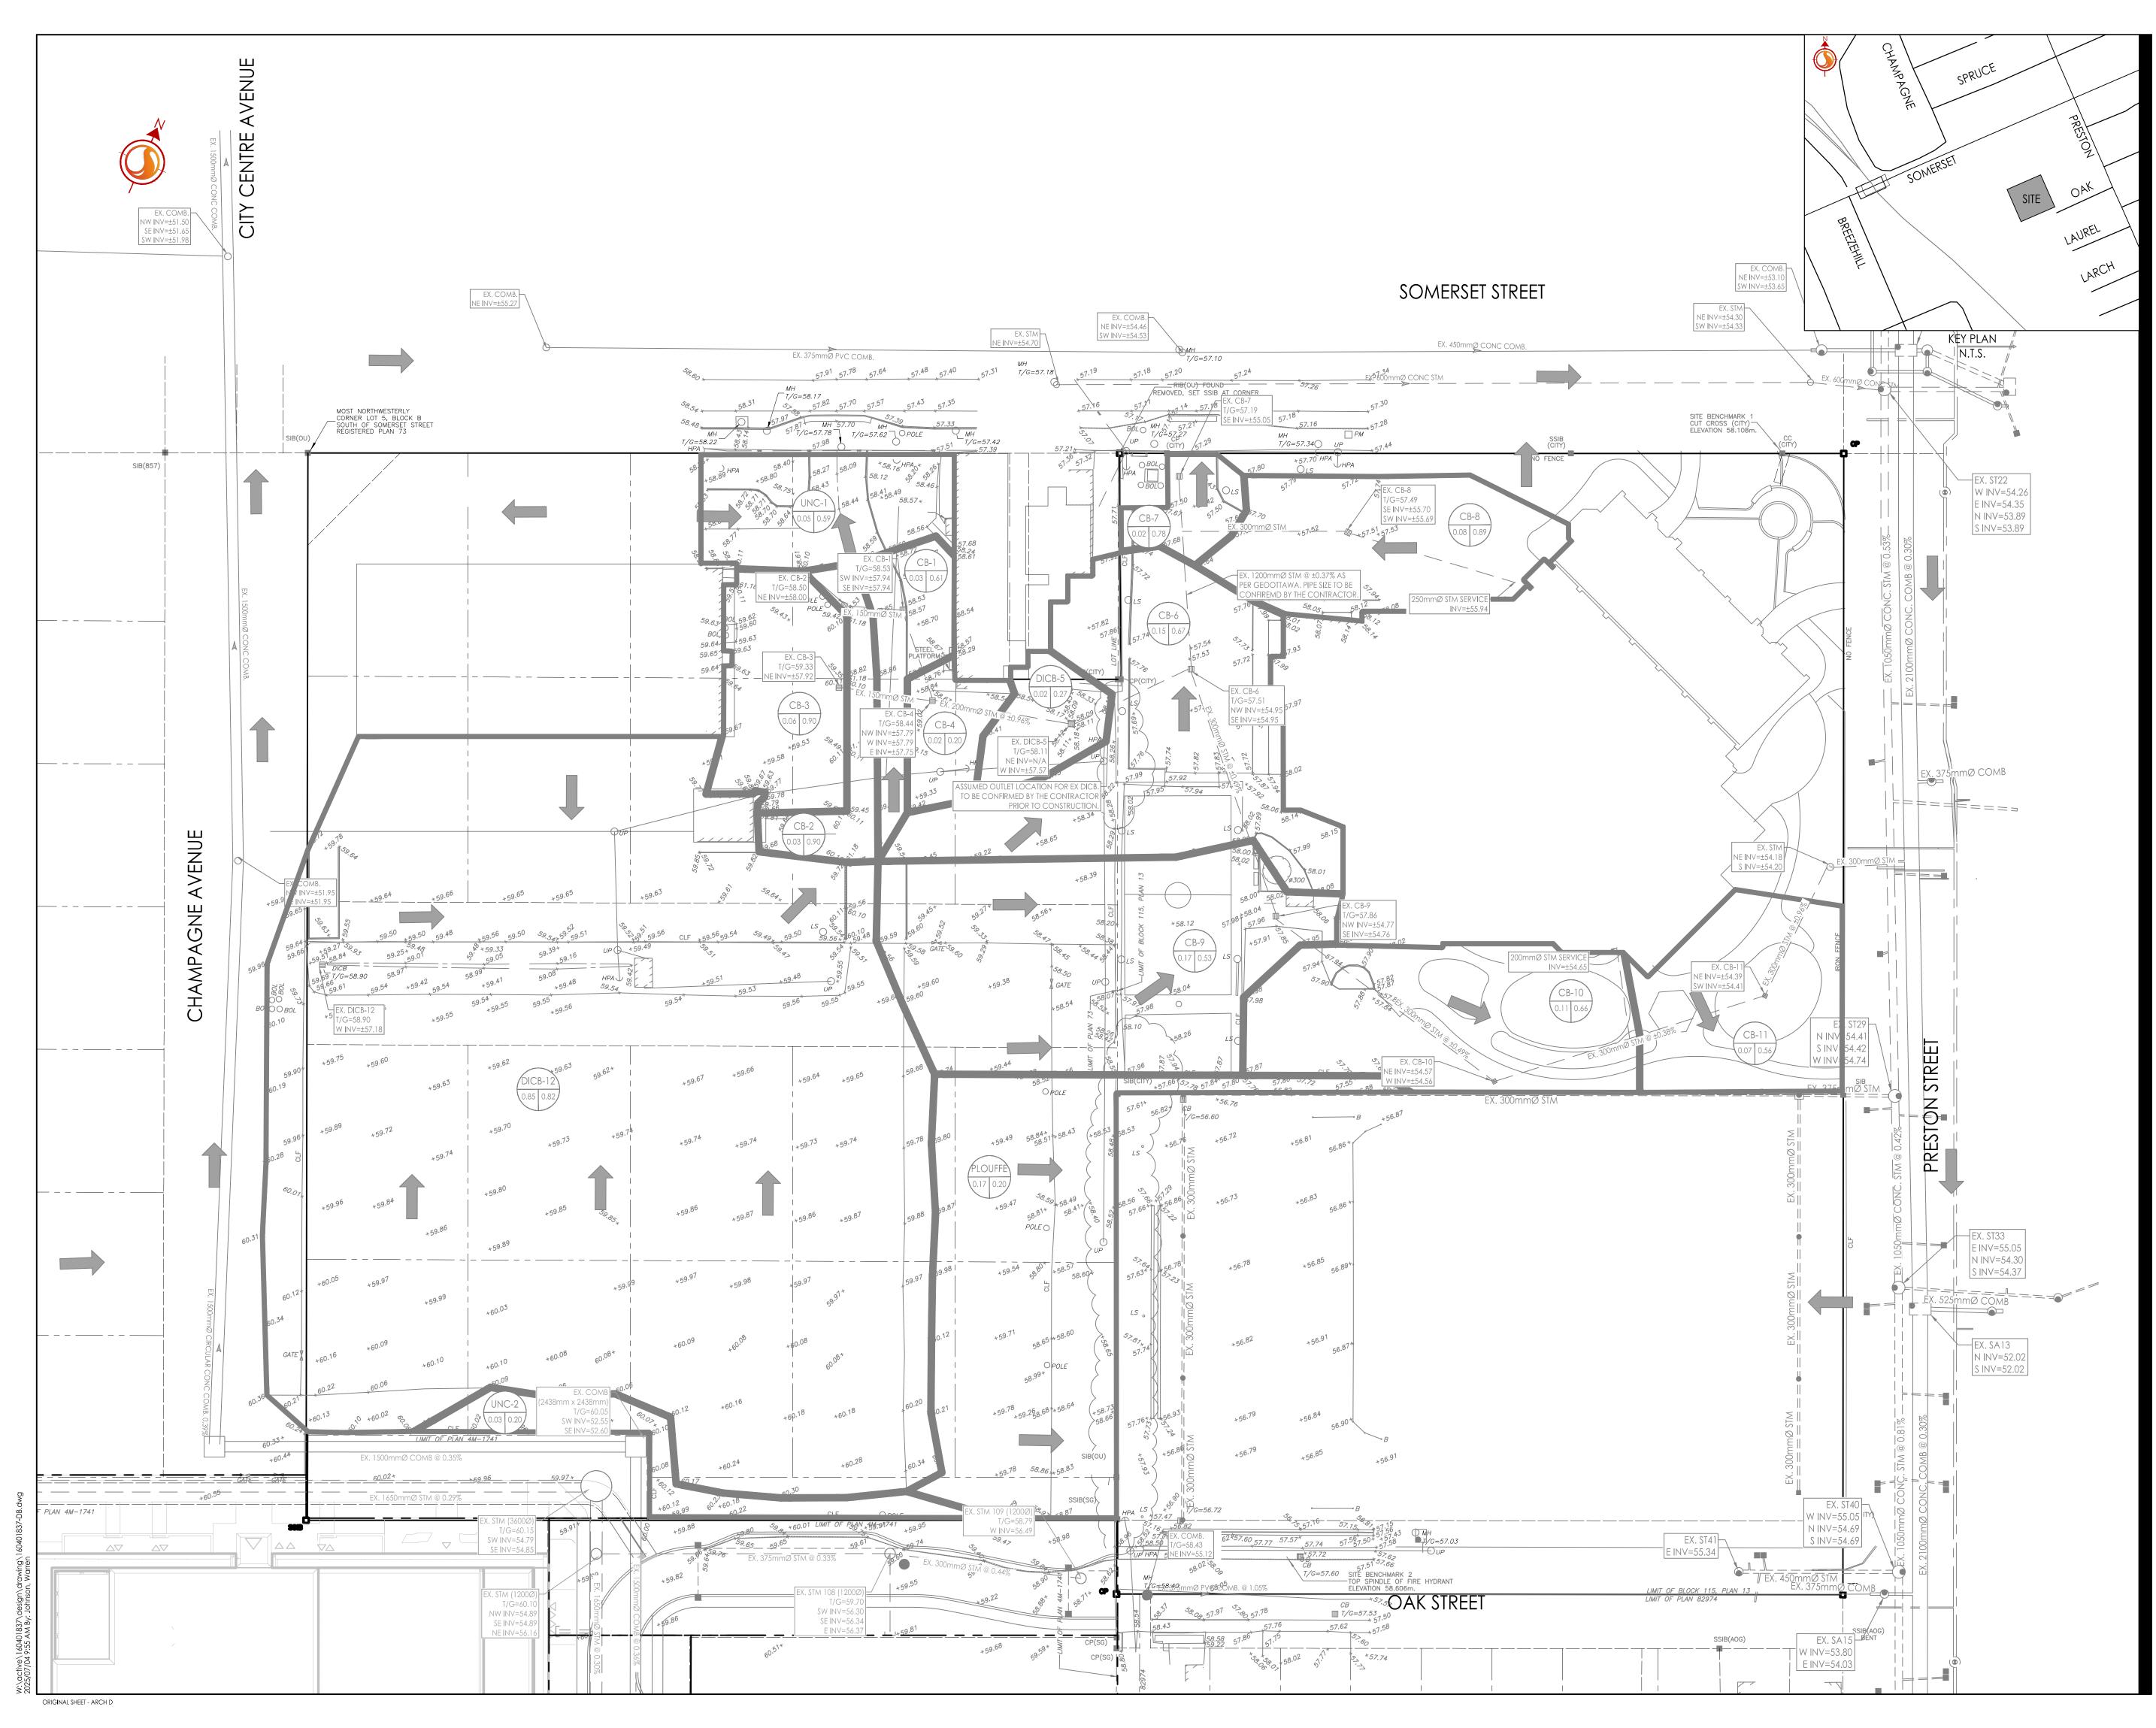
CEPEO ELEMENTARY SCHOOL LOUISE-ARBOUR - 45 OAK STREET OTTAWA, ON

Title EROSION CONTROL PLAN AND DETAIL SHEET Project No. Scale AS NOTED 160401837 Sheet Drawing No. Revision

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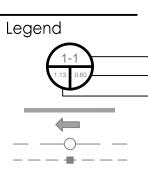
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- EXISTING AREA ID

EXISTING RUNOFF COEFFICIENT
 EXISTING STORM DRAINAGE AREA ha.
 EXISTING STORM DRAINAGE BOUNDARY
 EXISTING DIRECTION OF OVERLAND FLOW
 EXISTING STORM SEWER
 EXISTING CATCHBASIN

Notes

2	REVISED AS PER CITY COMMENTS	 WAJ	PM	25.07.04
1	ISSUED FOR REVIEW	 WAJ	PM	25.04.29
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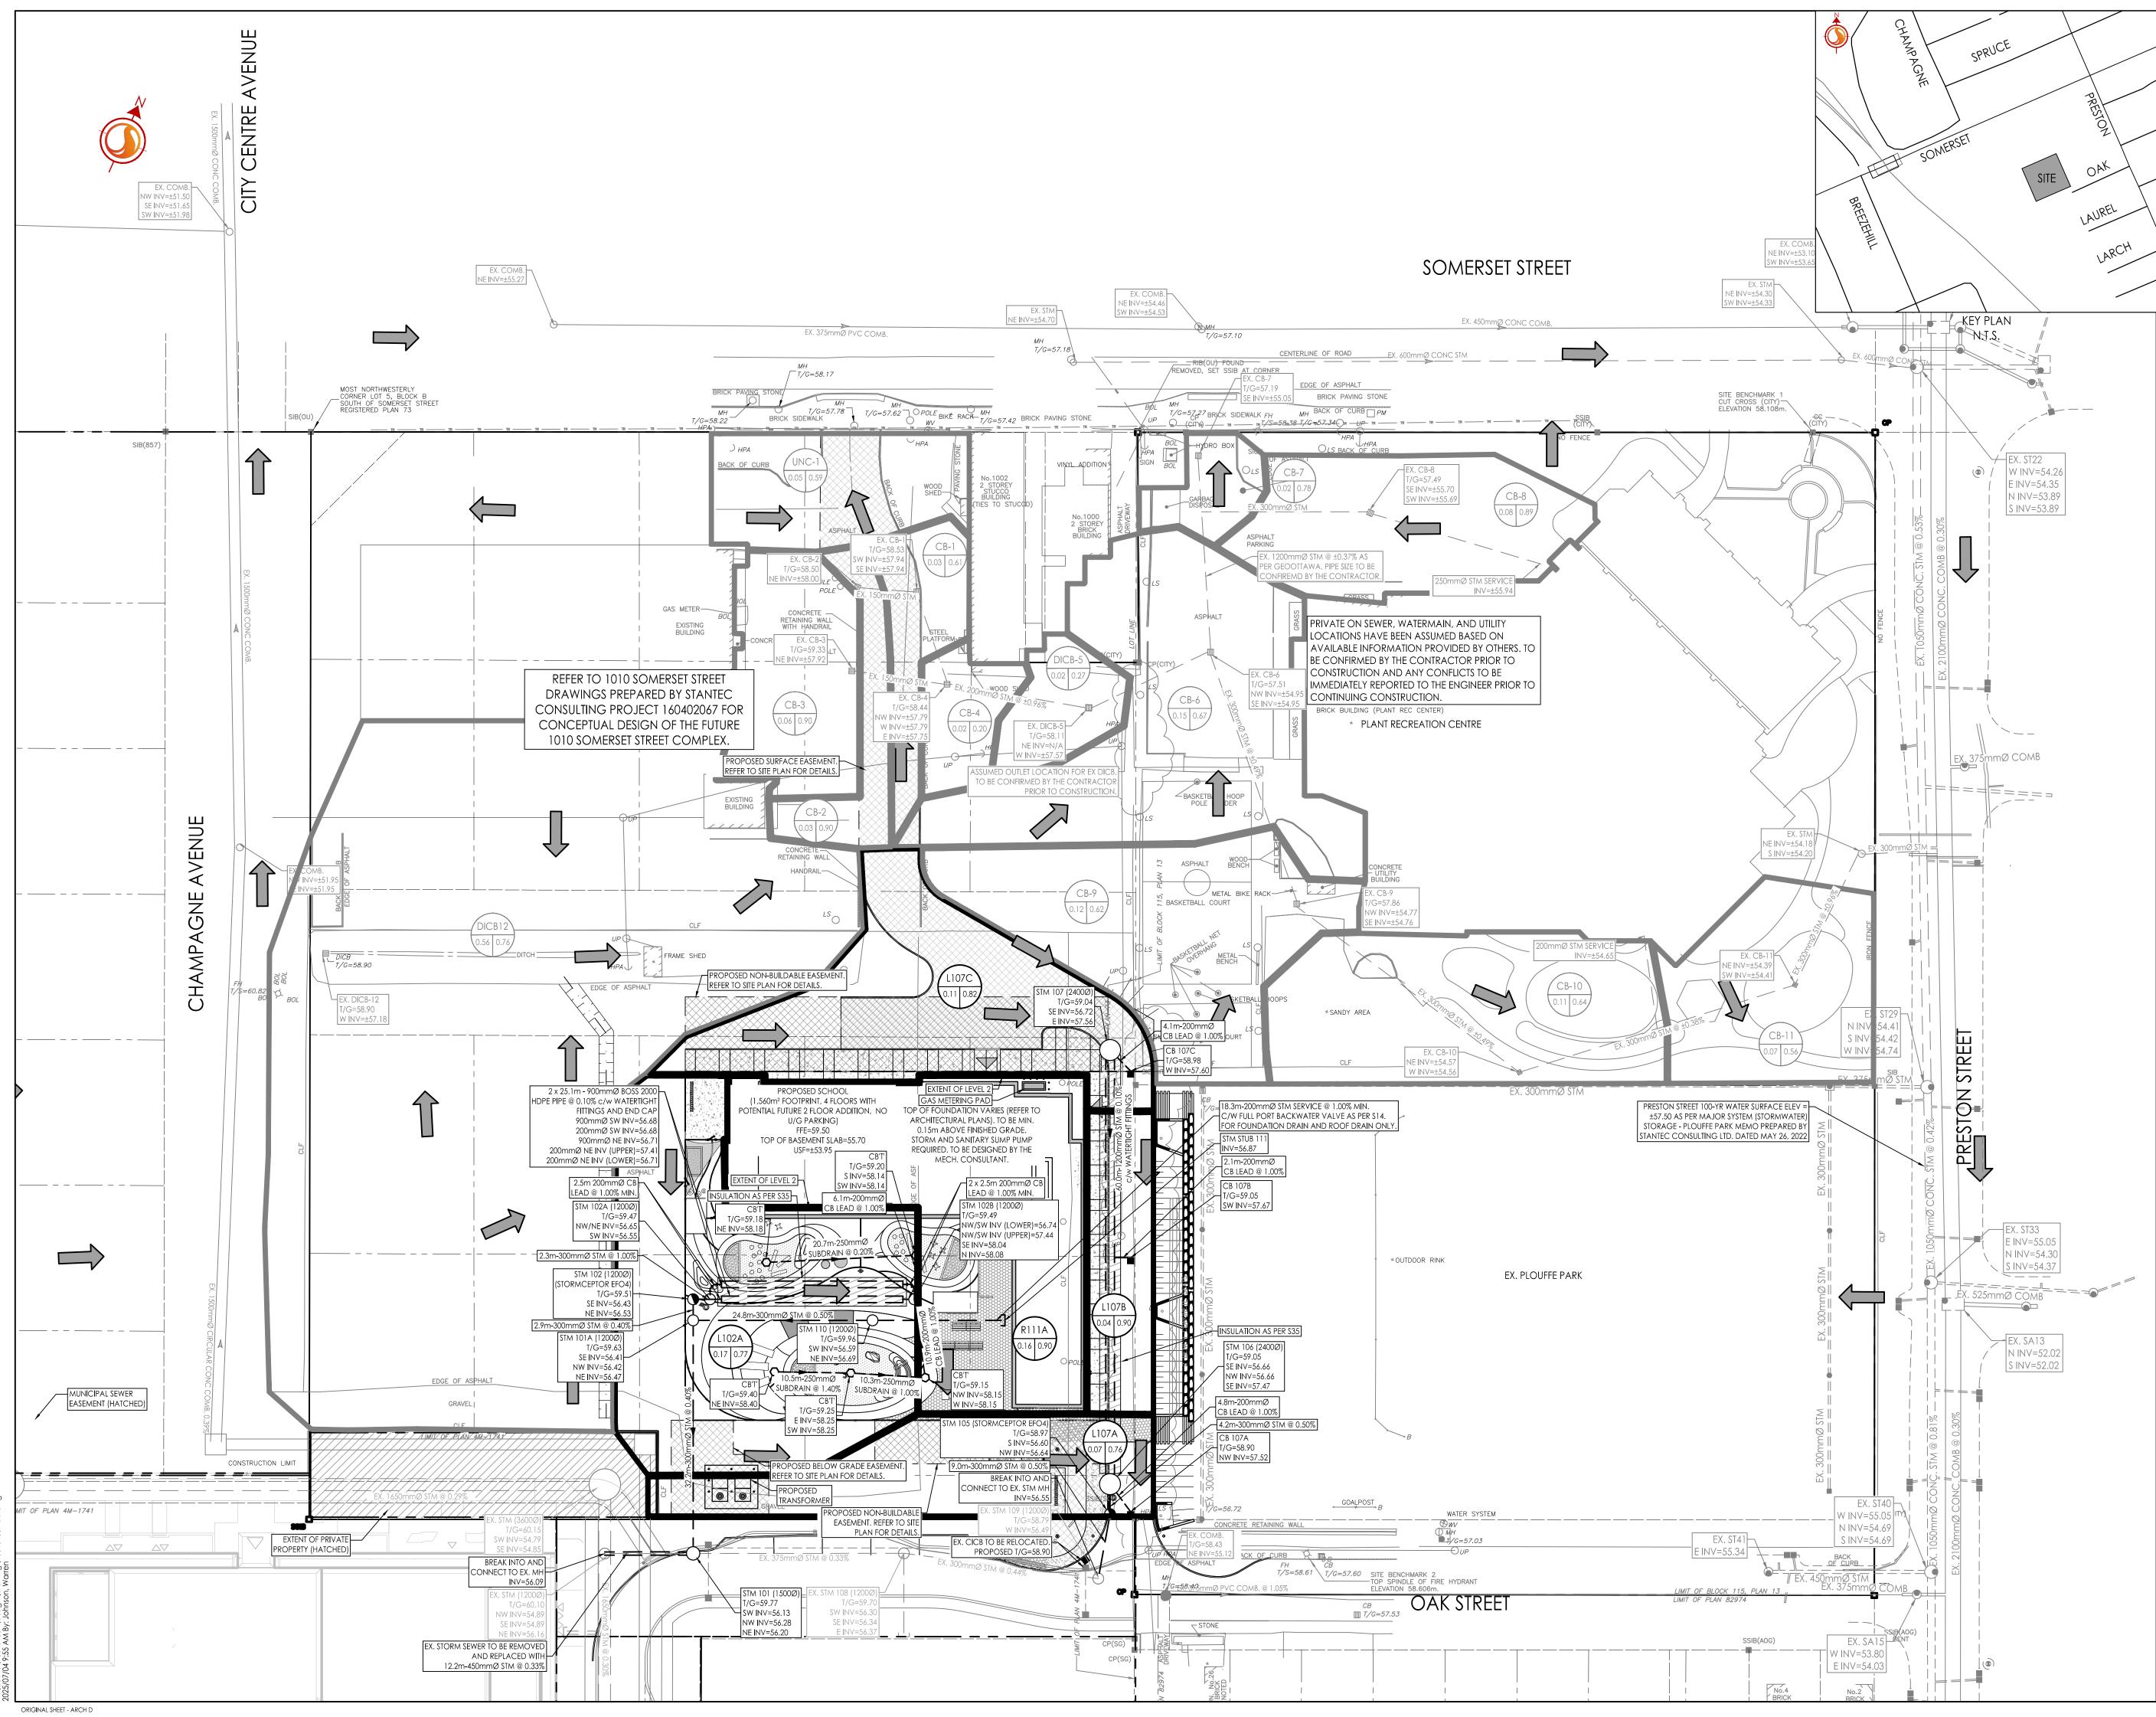
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Client/Project CITY OF OTTAWA

> CEPEO ELEMENTARY SCHOOL LOUISE-ARBOUR - 45 OAK STREET OTTAWA, ON

Title EXISTING CONDITIONS STORM DRAINAGE PLAN

Project No. 160401837	Scale 0 4 1:400	12 20m	5-0060
Drawing No.	Sheet	Revision	-12-2
EXSD-1	5 of 7	2 PLAN # 19280	D07.






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AREA ID

Legend



- RUNOFF COEFFICIENT STORM DRAINAGE AREA ha. STORM DRAINAGE BOUNDARY EXISTING/FUTURE STORM DRAINAGE BOUNDARY DIRECTION OF OVERLAND FLOW PROPOSED STORM SEWER PROPOSED CATCHBASIN MANHOLE PROPOSED CATCHBASIN EXISTING STORM SEWER EXISTING CATCHBASIN CATCHBASINS TO BE INSTALLED C/W CIRCULAR

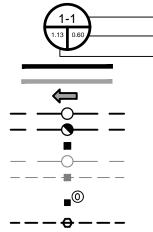ORIFICE (SEE ICD TABLE) PROPOSED SUBDRAIN CATCHBASIN

Notes

	SCHEDULE OF INLET CONTROL DEVICES								
	STRUCTURE ID	AREA ID		TYPE	ICD INVERT	100YR HEAD	(m) 100YR RELEASE RATE (L/s)		
	STM 106	L107A, L107B, L107C	92mm Ø		56.66	1.14	19.2		
	STM 102A	L102A	126mm Ø	Ö CIRCULAR ORIFICE	56.55	0.82	30.5		
	SCHEDULE OF ROOF RELEASE RATES								
			TYPE	# DRAINS	100 YEAR HEAD) (m) 100	YEAR RELEASE RATE (L/s)		
			ITROL (50% N)	6	0.149		7.5		


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Revision		Ву	Appd.	YY.MM.DD
File Name: 160401837-DB.dwg	WAJ	PM	WAJ	25.03.20
	Dwn.	Chkd.	Dsgn.	YY.MM.DD


Permit-Seal

Client/Project CITY OF OTTAWA

> CEPEO ELEMENTARY SCHOOL LOUISE-ARBOUR - 45 OAK STREET OTTAWA, ON

Title STORM DRAINAGE PLAN

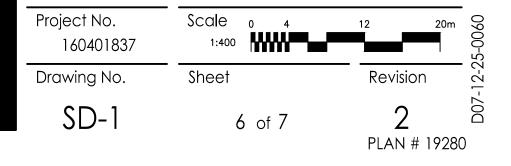

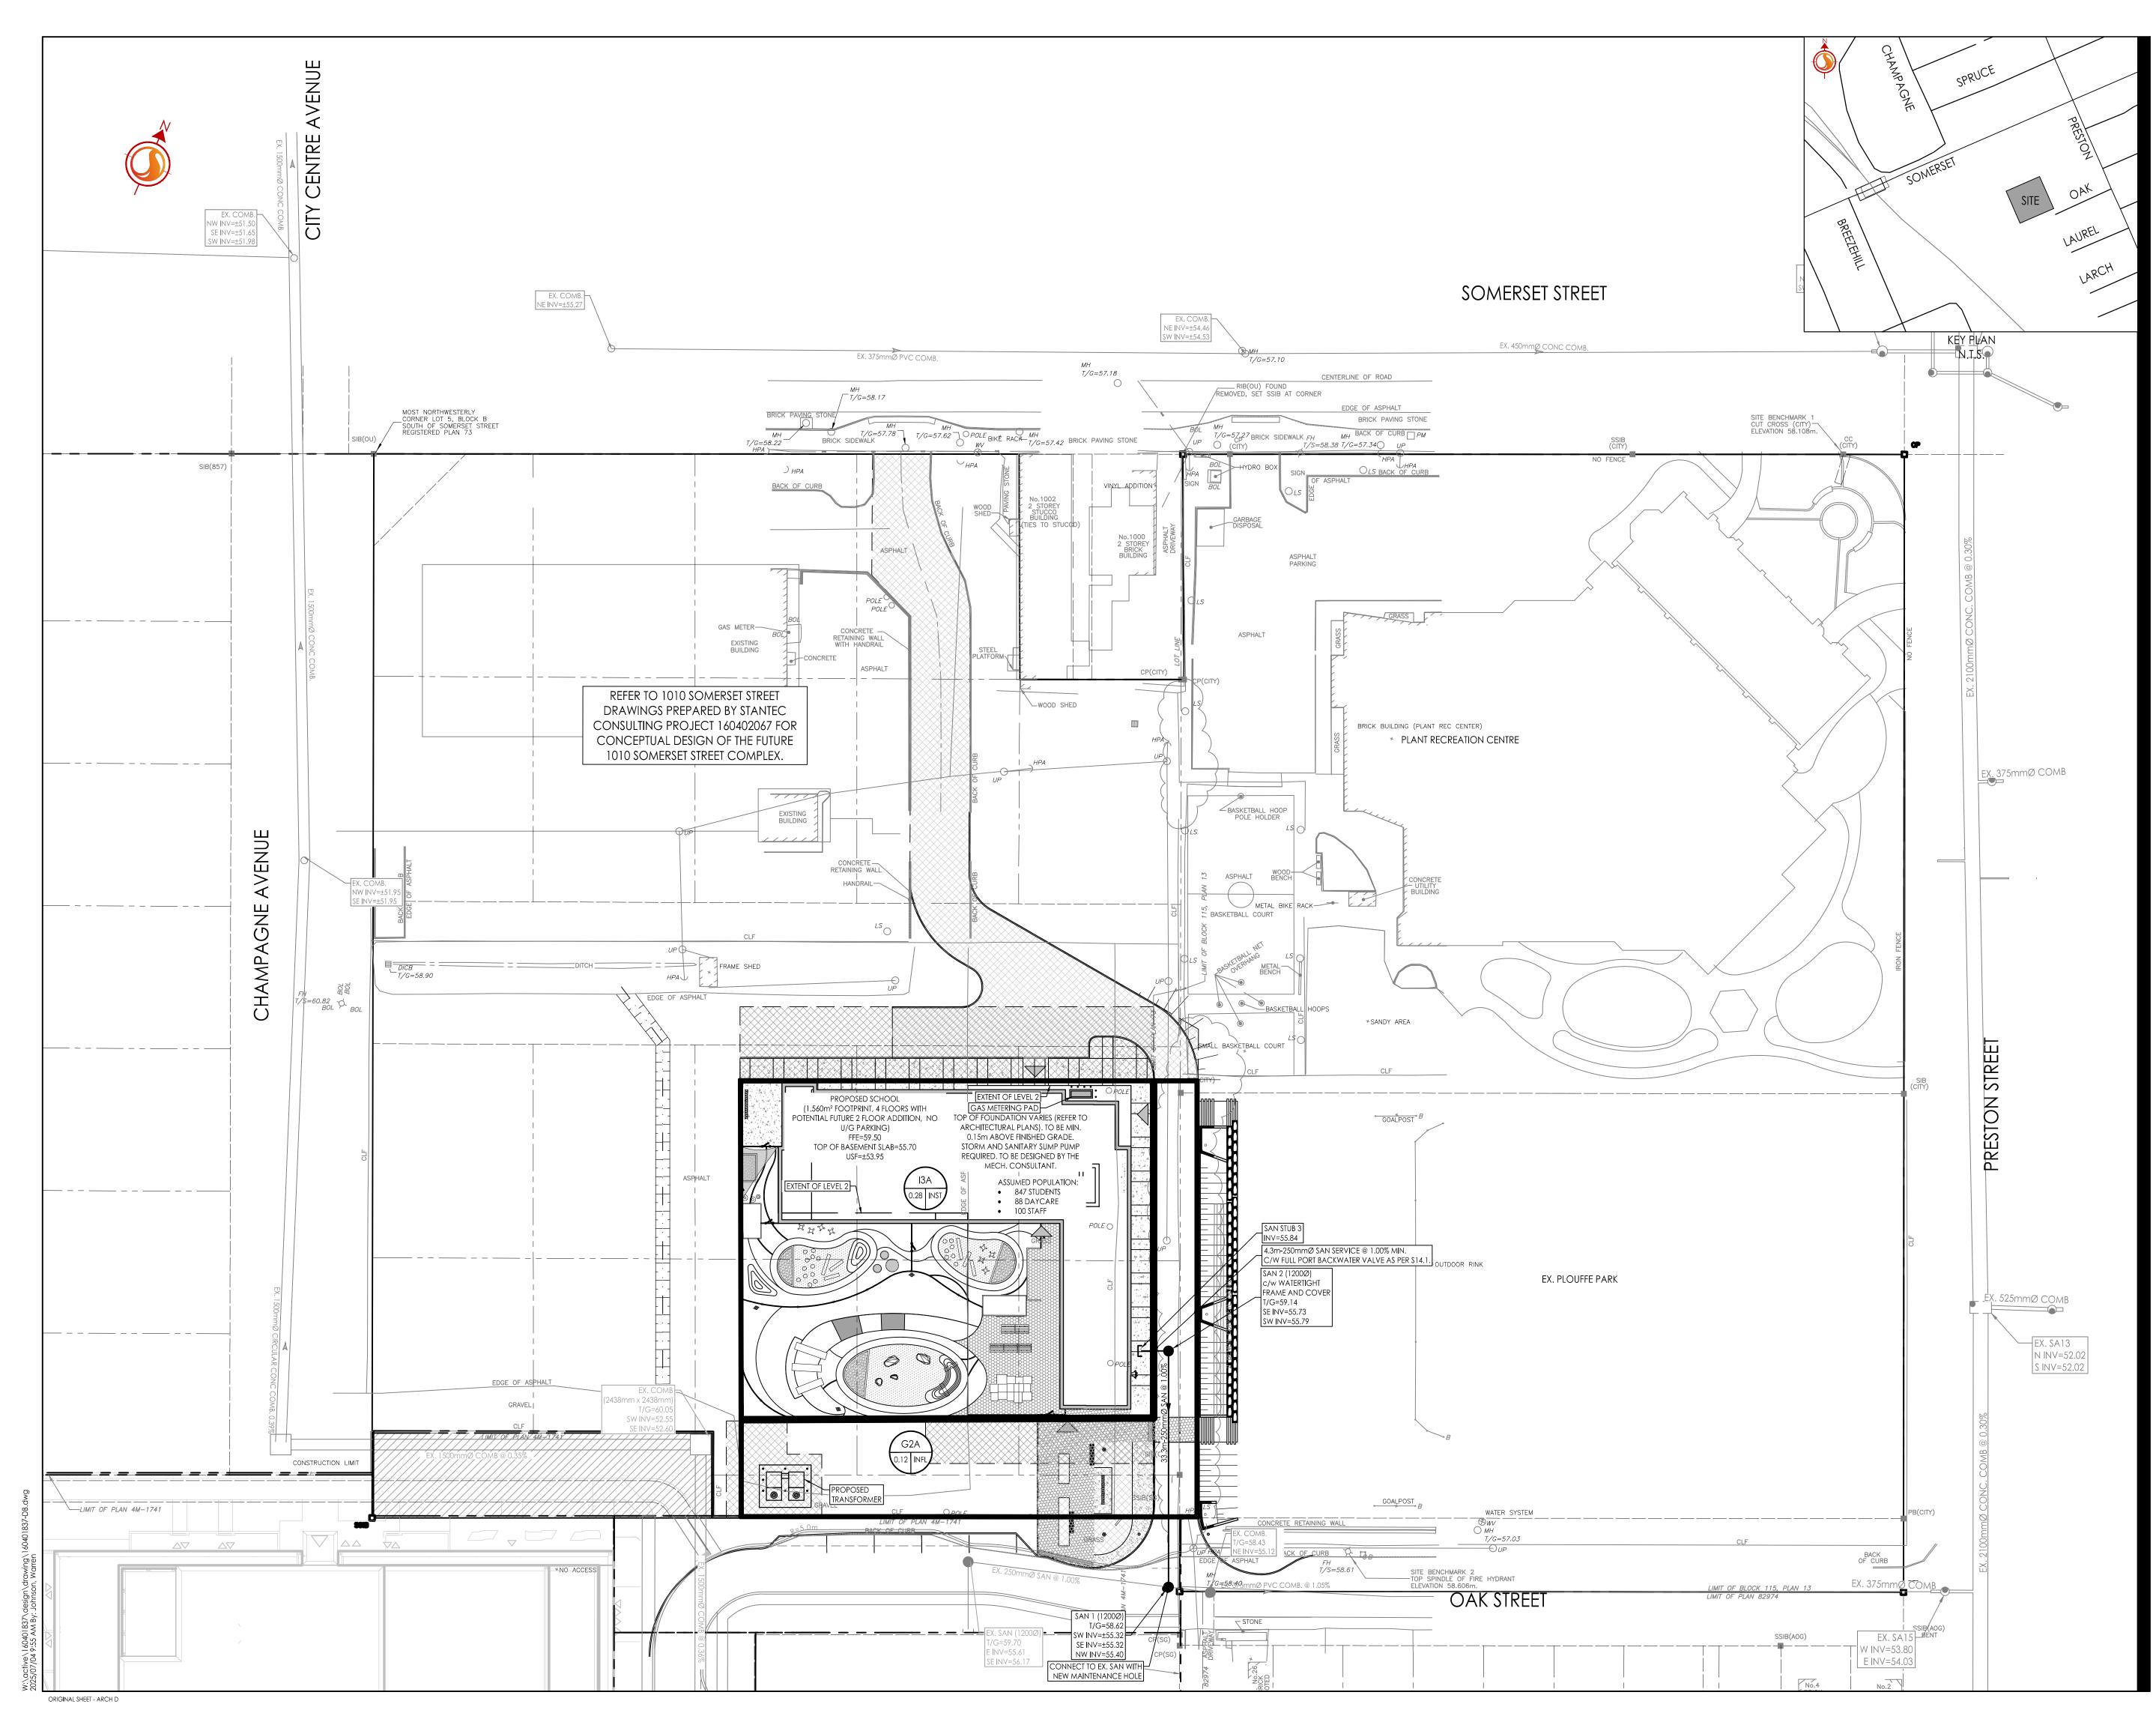




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Legend



SANITARY DRAINAGE AREA ID#
 POPULATION
 SANITARY DRAINAGE AREA ha.

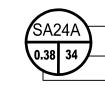SANITARY DRAINAGE AREA PROPOSED SANITARY SEWER

Notes

 2
 REVISED AS PER CITY COMMENTS
 WAJ
 PM
 25.07.04

 1
 ISSUED FOR REVIEW
 WAJ
 PM
 25.04.29

 Revision
 By
 Appd.
 YY.MM.DD

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SANITARY DRAINAGE PLAN

