


TYPICAL PRECAST NOISE WALL ELEVATION
 SCALE NTS

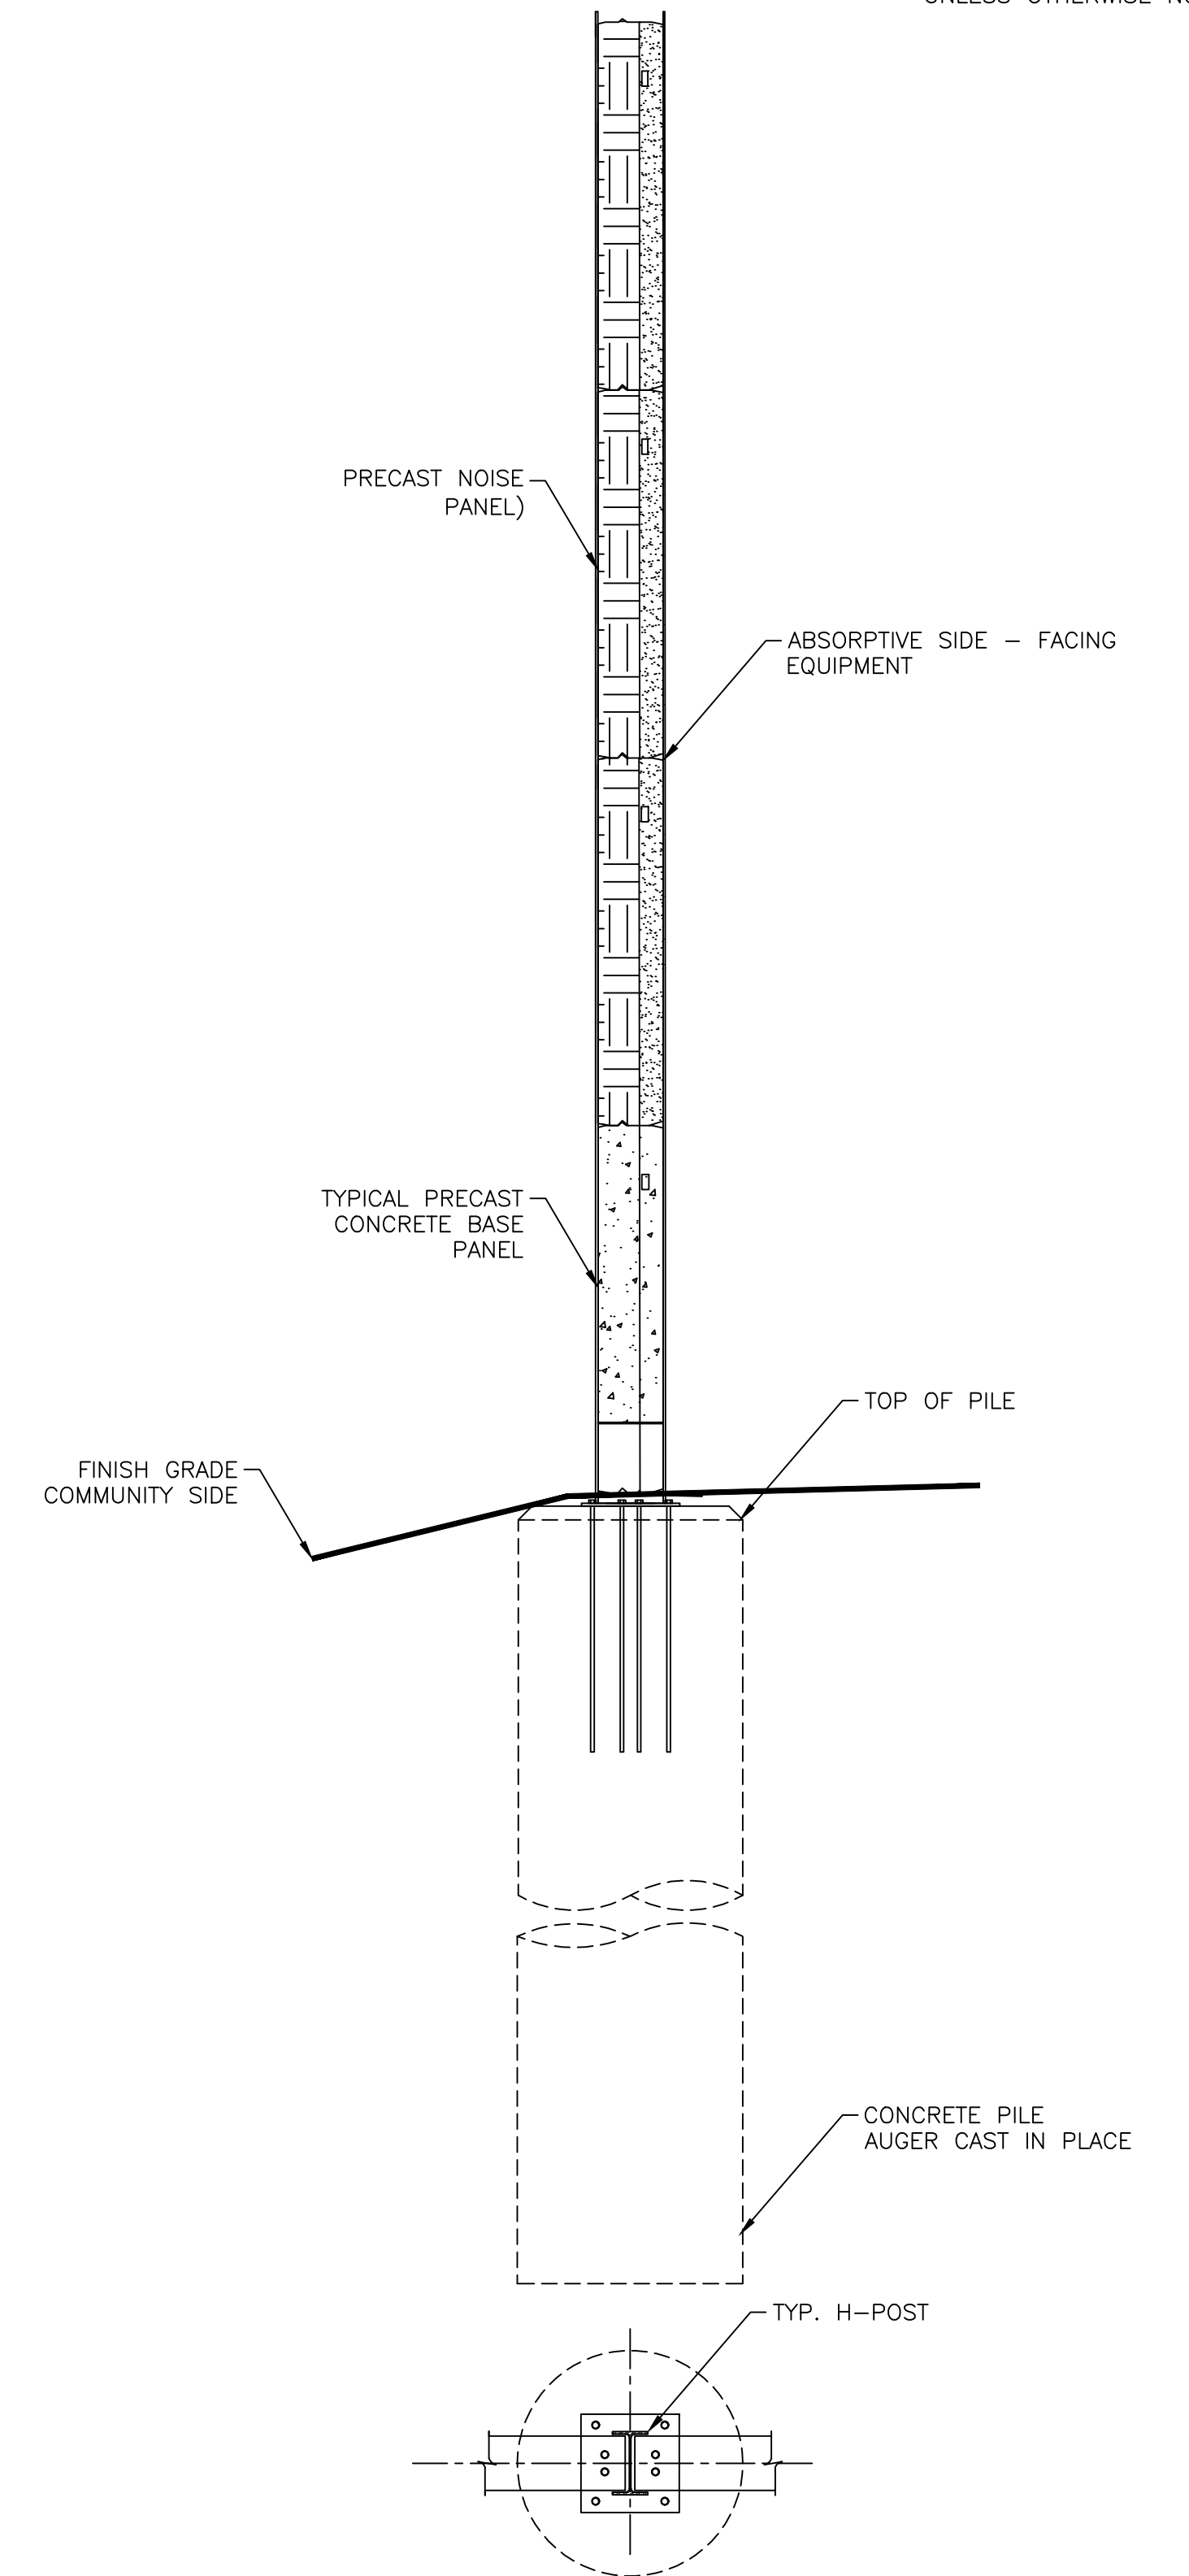

TYPICAL NOISE WALL SECTION
 SCALE NTS

APPROVED
 By Adam Brown at 3:17 pm, May 11, 2026

Adam Brown
ADAM BROWN
 MANAGER, DEVELOPMENT REVIEW RURAL
 PLANNING, DEVELOPMENT & BUILDING SERVICES
 DEPARTMENT, CITY OF OTTAWA

NOTES:

- FOUNDATION DESIGN AS PER LOCAL CONDITIONS IN ACCORDANCE WITH THE ENGINEER OF RECORD
- REFER TO GEOTECH REPORTS FOR LOCAL GROUND CONDITIONS
- REFER TO NOISE ASSESSMENT FOR PROPOSED NOISE BARRIER LAYOUT
- WATER PASSING GRATE OR EQUIVALENT FOR SURFACE RUN-OFF. SHALL BE DESIGNED IN ACCORDANCE WITH DRAINAGE DESIGN CAPACITY AND SURFACE GRADING.
- TYP. MIN. ACOUSTIC PANEL SURFACE DENSITY 20 KG/M2 (REFER TO OPSS 760)
- ALL DIMENSIONS ARE TYPICAL AND SHALL BE REVISED AS PER THE DETAIL DESIGN AND APPROVED BY THE ENGINEER OF RECORD

DWG NO.	TITLE	NO.	DATE	ISSUED FOR	REV.	DATE
		A	2024.07.18	FOR INFORMATION ONLY -- NOT CONSTRUCTION		

REFERENCE DRAWINGS	ISSUE	REVISIONS	DRAWN BY: MC	DESIGNED BY:
			CHECKED BY: MC	APPROVED BY:
			SCALE: AS SHOWN FULL SIZE ONLY	

PRE-CAST NOISE WALL SHEET 1 OF 1			
CONTRACT NO.	DWG. NO.	REV.	SHEET
	H374571-00000-245-292-0001	A	