


TYPICAL PRECAST NOISE WALL ELEVATION
SCALE NTS

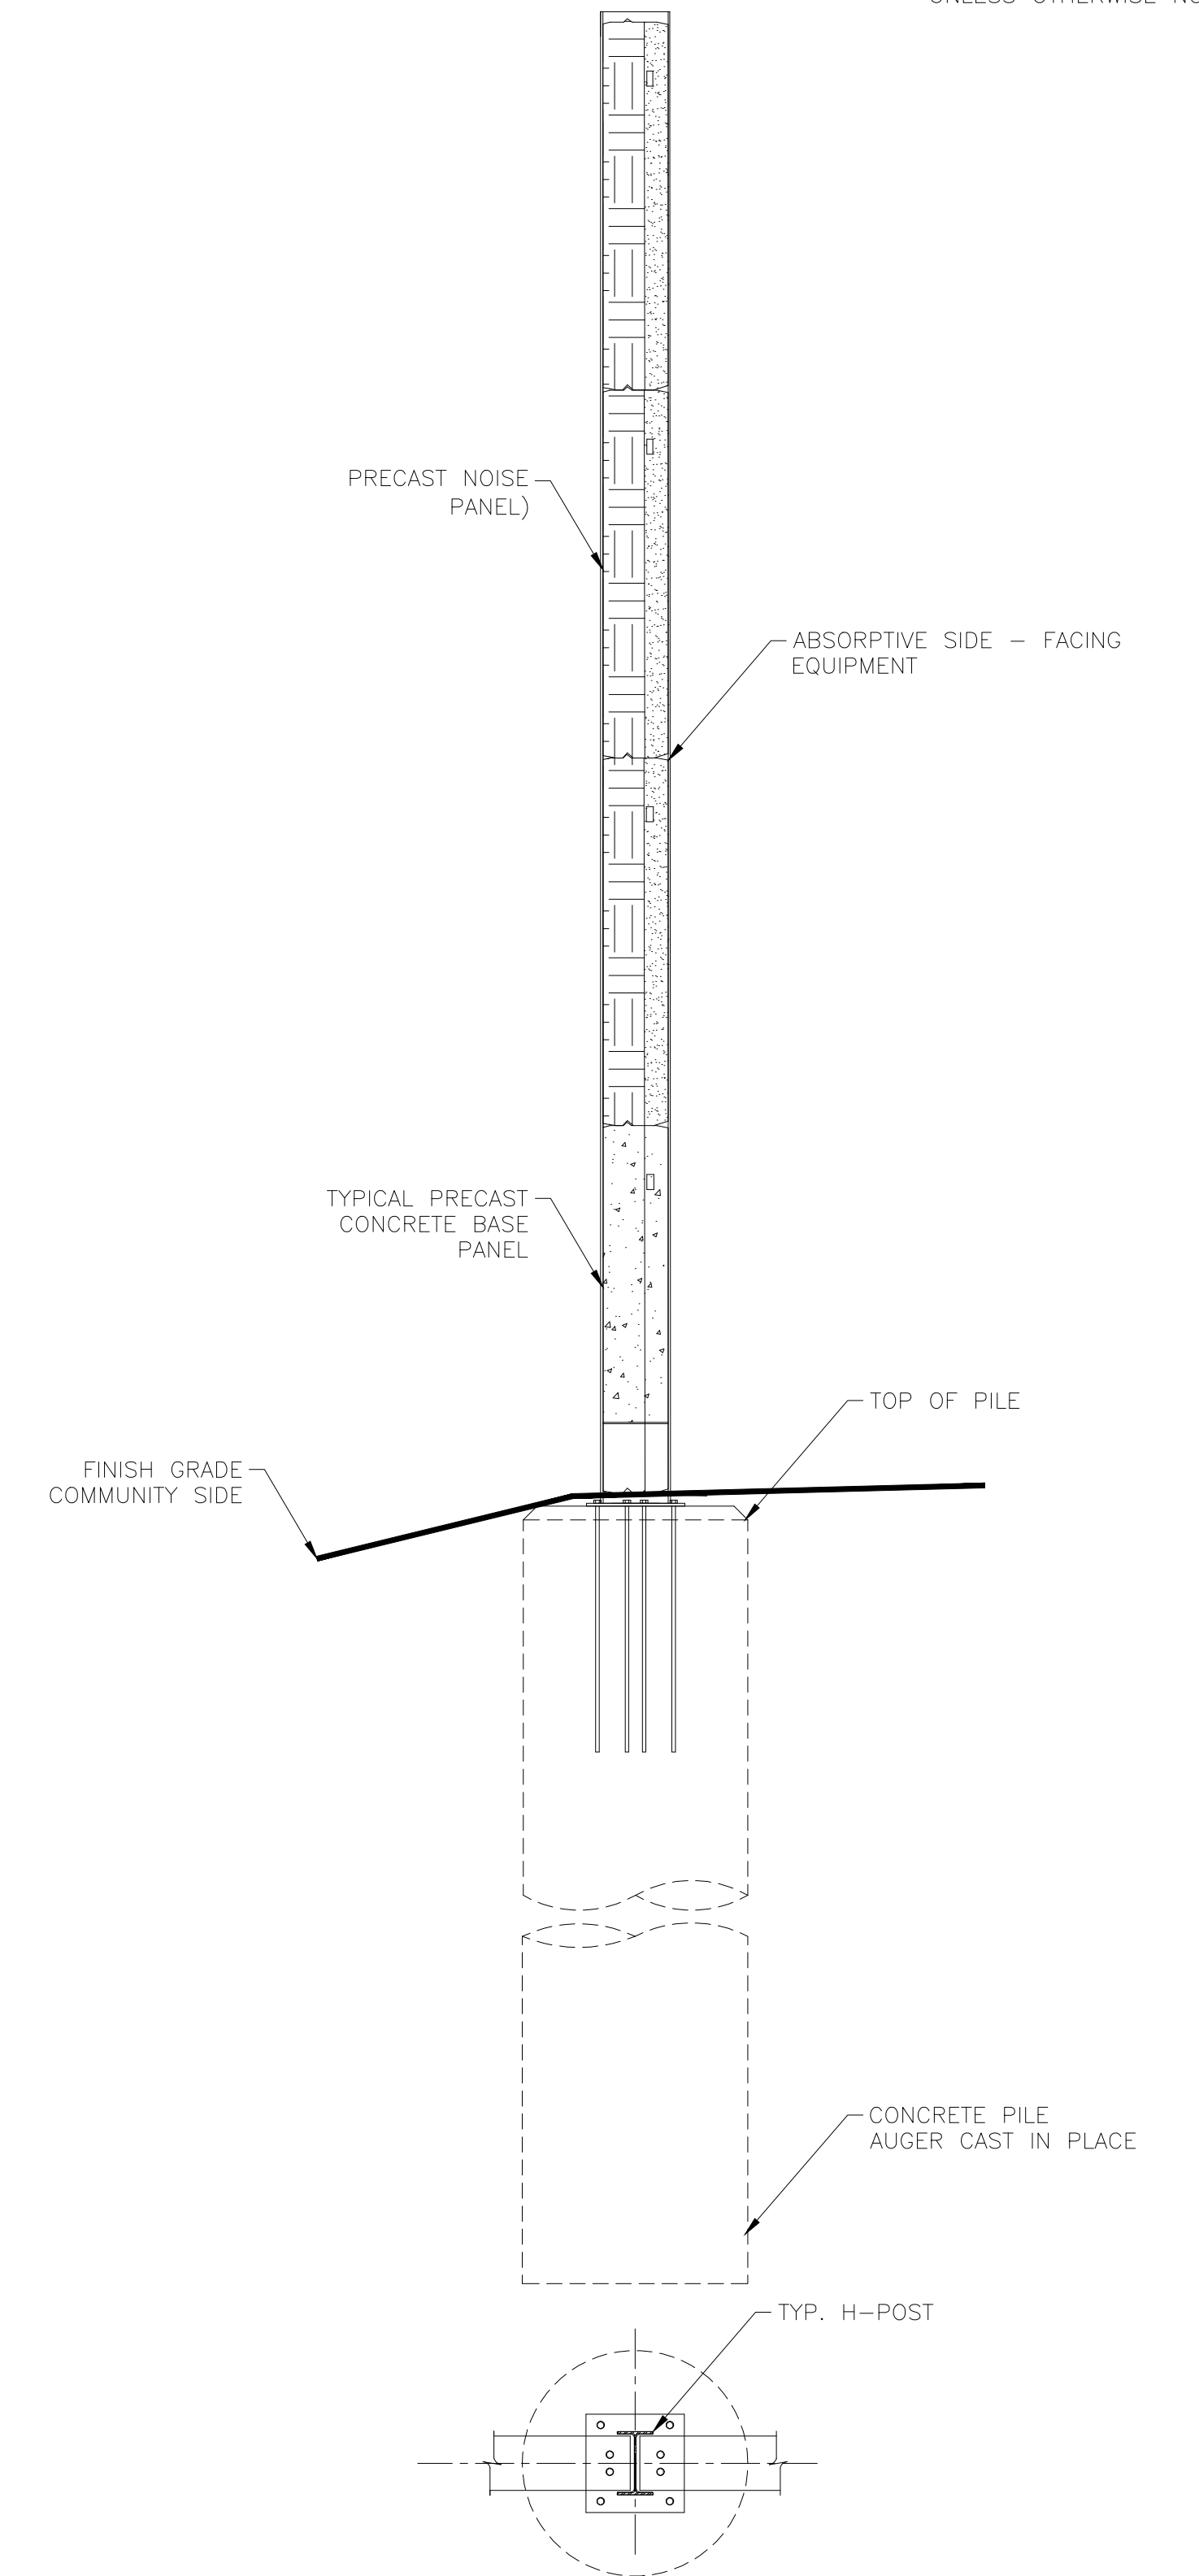

TYPICAL NOISE WALL SECTION
SCALE NTS

**FOR INFORMATION ONLY
NOT FOR CONSTRUCTION**

NOTES:

- FOUNDATION DESIGN AS PER LOCAL CONDITIONS IN ACCORDANCE WITH THE ENGINEER OF RECORD
- REFER TO GEOTECH REPORTS FOR LOCAL GROUND CONDITIONS
- REFER TO NOISE ASSESSMENT FOR PROPOSED NOISE BARRIER LAYOUT
- WATER PASSING GRATE OR EQUIVALENT FOR SURFACE RUN-OFF, SHALL BE DESIGNED IN ACCORDANCE WITH DRAINAGE DESIGN CAPACITY AND SURFACE GRADING.
- TYP. MIN. ACOUSTIC PANEL SURFACE DENSITY 20 KG/M2 (REFER TO OPSS 760)
- ALL DIMENSIONS ARE TYPICAL AND SHALL BE REVISED AS PER THE DETAIL DESIGN AND APPROVED BY THE ENGINEER OF RECORD

| REFERENCE DRAWINGS | ISSUE | REVISIONS | DRAWN BY: | DESIGNED BY: | | |
|--------------------|-------|-----------|--------------------------------|---|------|------|
| | | | MC | | | |
| | | | CHECKED BY: | APPROVED BY: | | |
| | | | MC | | | |
| | | | SCALE: AS SHOWN FULL SIZE ONLY | | | |
| DWG NO. | TITLE | NO. | DATE | ISSUED FOR | REV. | DATE |
| | | B | 2026.03.03 | FOR INFORMATION ONLY - NOT CONSTRUCTION | | |
| | | A | 2024.07.18 | FOR INFORMATION ONLY - NOT CONSTRUCTION | | |



TRAIL ROAD BESS
PRE-CAST NOISE WALL

OTTAWA, ON

| | | | |
|--------------|----------------------------|------|-------|
| CONTRACT NO. | DWG. NO. | REV. | SHEET |
| | H374571-00000-245-292-0001 | B | 1 |