



KEY PLAN

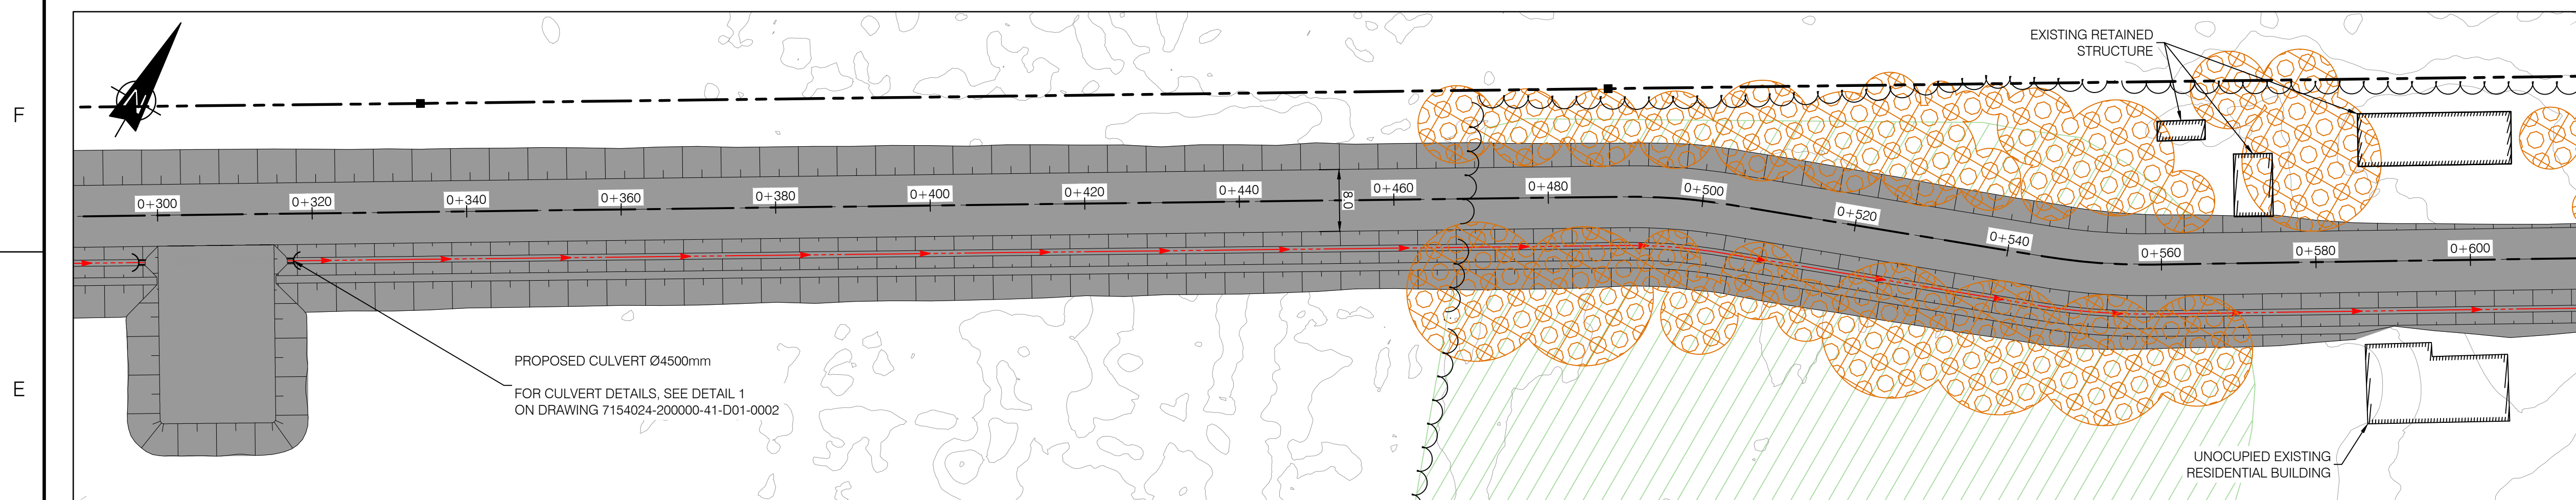

LEGEND

- WATERCOURSE DITCH
- NATURAL RUNOFF CORRIDOR
- DIVERSION DITCH
- PROPOSED FENCE
- PROPERTY LIMIT
- STORMWATER PUMP PIPE, HDPE DR17, 150mm
- VEGETATION SWALE
- MAIN PIPE FIRE PROTECTION 200mm HDPE DR11 PE4710
- PIPE CONNECTION 150mm HDPE DR11 PE4710
- HYDRANT
- HYDRANTS BOLLARDS
- BATTERY CORNERS BOLLARDS
- POST INDICATOR VALVE
- 60m RADIUS PROTECTION
- FLOW DIRECTION PROPOSED GRADE
- PROPOSED CULVERT
- TREE LINE
- CULTIVATED AREA
- ACCESS ROAD
- PROPOSED INSULATING STONE SURFACE AREA
- PROPOSED GRAVEL SURFACE AREA
- PROPOSED GRADE
- EXISTING GRADE ELEVATION
- BATTERY/MVT GROUP
- AUXILIARY TRANSFORMER
- WET POND
- EXISTING POLE
- MONUMENT
- LANDSCAPING

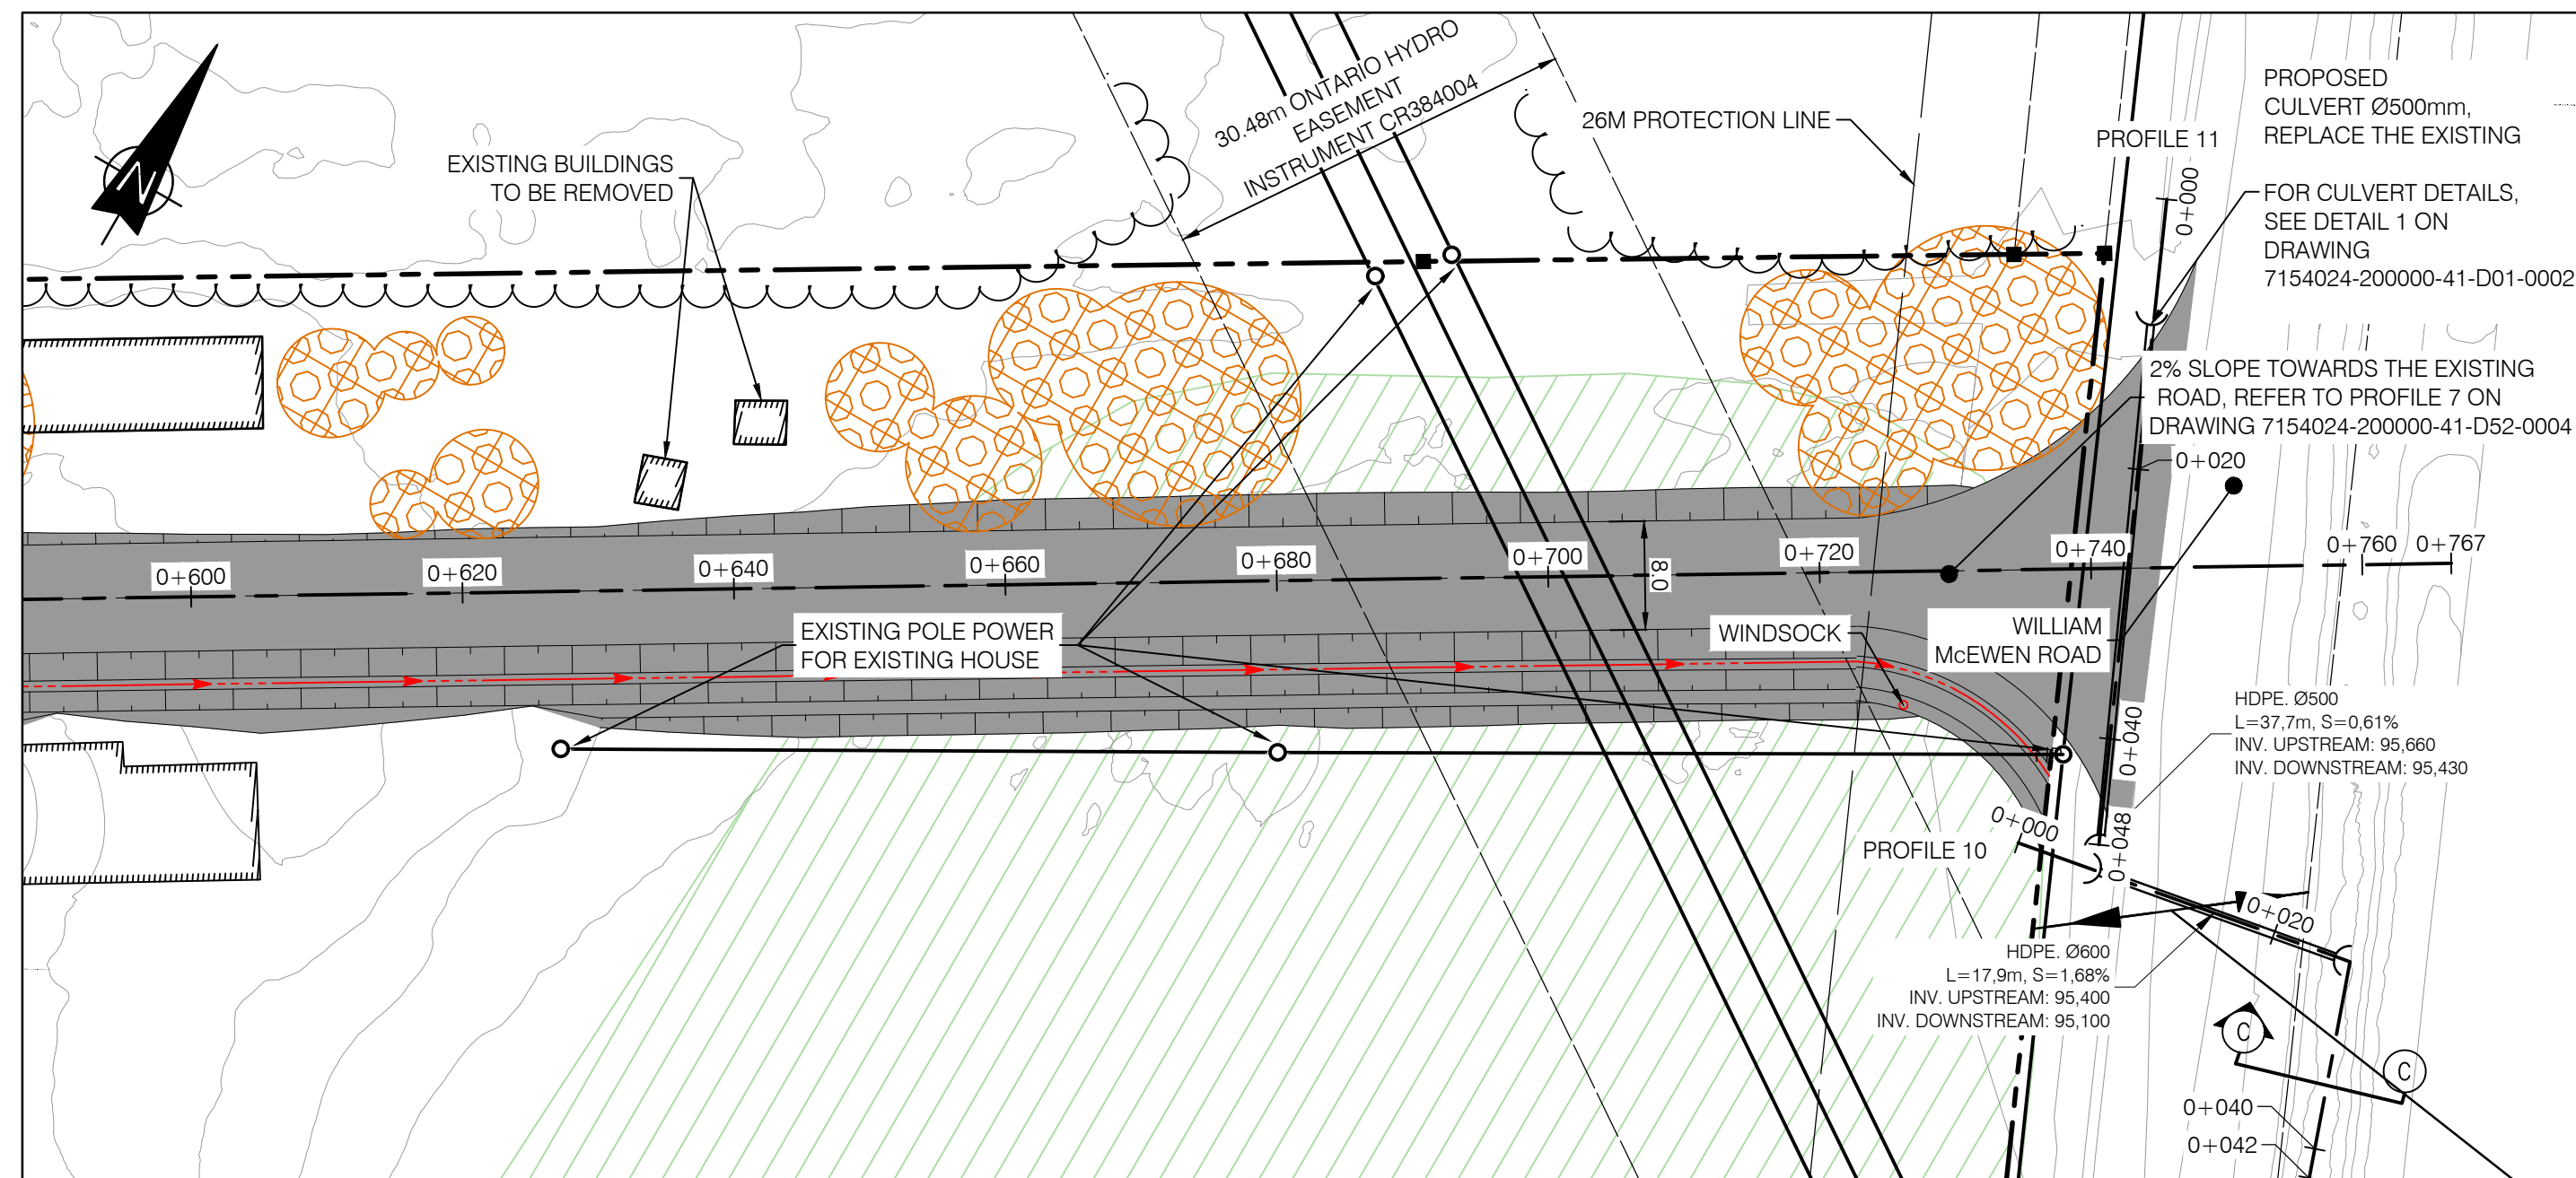

PLAN VIEW
SCALE 1:500

- NOTES:**
- COORDINATES SYSTEM IS:
HORIZONTAL DATUM: MTM_NAD83 (CSRS)_ZONE 9
VERTICAL DATUM: CGVD28
 - ALL UNITS ARE IN METERS UNLESS OTHERWISE INDICATED
 - THIS SITE PLAN HAS BEEN BASED ON THE SURVEYORS TOPOGRAPHY SKETCH PREPARED BY TULLOCH GEOMATICS INC. DATED MARCH 12, 2025
 - LOT ADDRESS: 4186 WILLIAM MCEWEN DR, OTTAWA



FOR PERMITTING
NOT TO BE USED FOR CONSTRUCTION

DRAWING No.	DESCRIPTION	REV	DESCRIPTION	PREPARED BY	CHECKED BY	DATE
241437	TOPOGRAPHIC PLAN OF SURVEY	AD	FOR COMMENTS	B. THOMAS	V. BRUNELLE P. Eng.	2025-09-15
7154024300000-47-D20-0001-02	LIDAR DTM OTTAWA-GATINEAU 2019-20 PACKAGE M	AC	FOR PERMITTING	B. THOMAS	V. BRUNELLE P. Eng.	2025-07-24
	TRAIL BESS - 150 MW - 230 kV - 34.5 kV SUBSTATION	AB	FOR PERMITTING	B. THOMAS	V. BRUNELLE P. Eng.	2025-05-09
		AA	FOR COMMENTS	B. THOMAS	V. BRUNELLE P. Eng.	2025-05-02

REV	DESCRIPTION	PREPARED BY	CHECKED BY	DATE
AH	FOR PERMITTING	B. THOMAS	V. BRUNELLE P. Eng.	2026-03-30
AG	FOR PERMITTING	B. THOMAS	V. BRUNELLE P. Eng.	2026-01-21
AF	FOR PERMITTING	B. THOMAS	V. BRUNELLE P. Eng.	2025-12-04
AE	FOR PERMITTING	B. THOMAS	V. BRUNELLE P. Eng.	2025-10-28

SEAL:

CLIENT: Evolugen by Brookfield Renewable

PROJECT: TRAIL ROAD BESS	
TITLE: CIVIL BESS SITE PLAN VIEW SECTIONS	
DESIGNED BY: B. THOMAS	DRAFTED BY: A. MENeses
PREPARED BY: B. THOMAS	CHECKED BY: V. BRUNELLE P. Eng. P.E.O No. 100617887
SCALE: 1:500	DATE: 2025-04-24
DRAWING No.: 7154024-200000-41-D52-0002	SHEET: 01 SIZE: A1 REV: AH