




DATE: 2024-02-26 10:00 AM

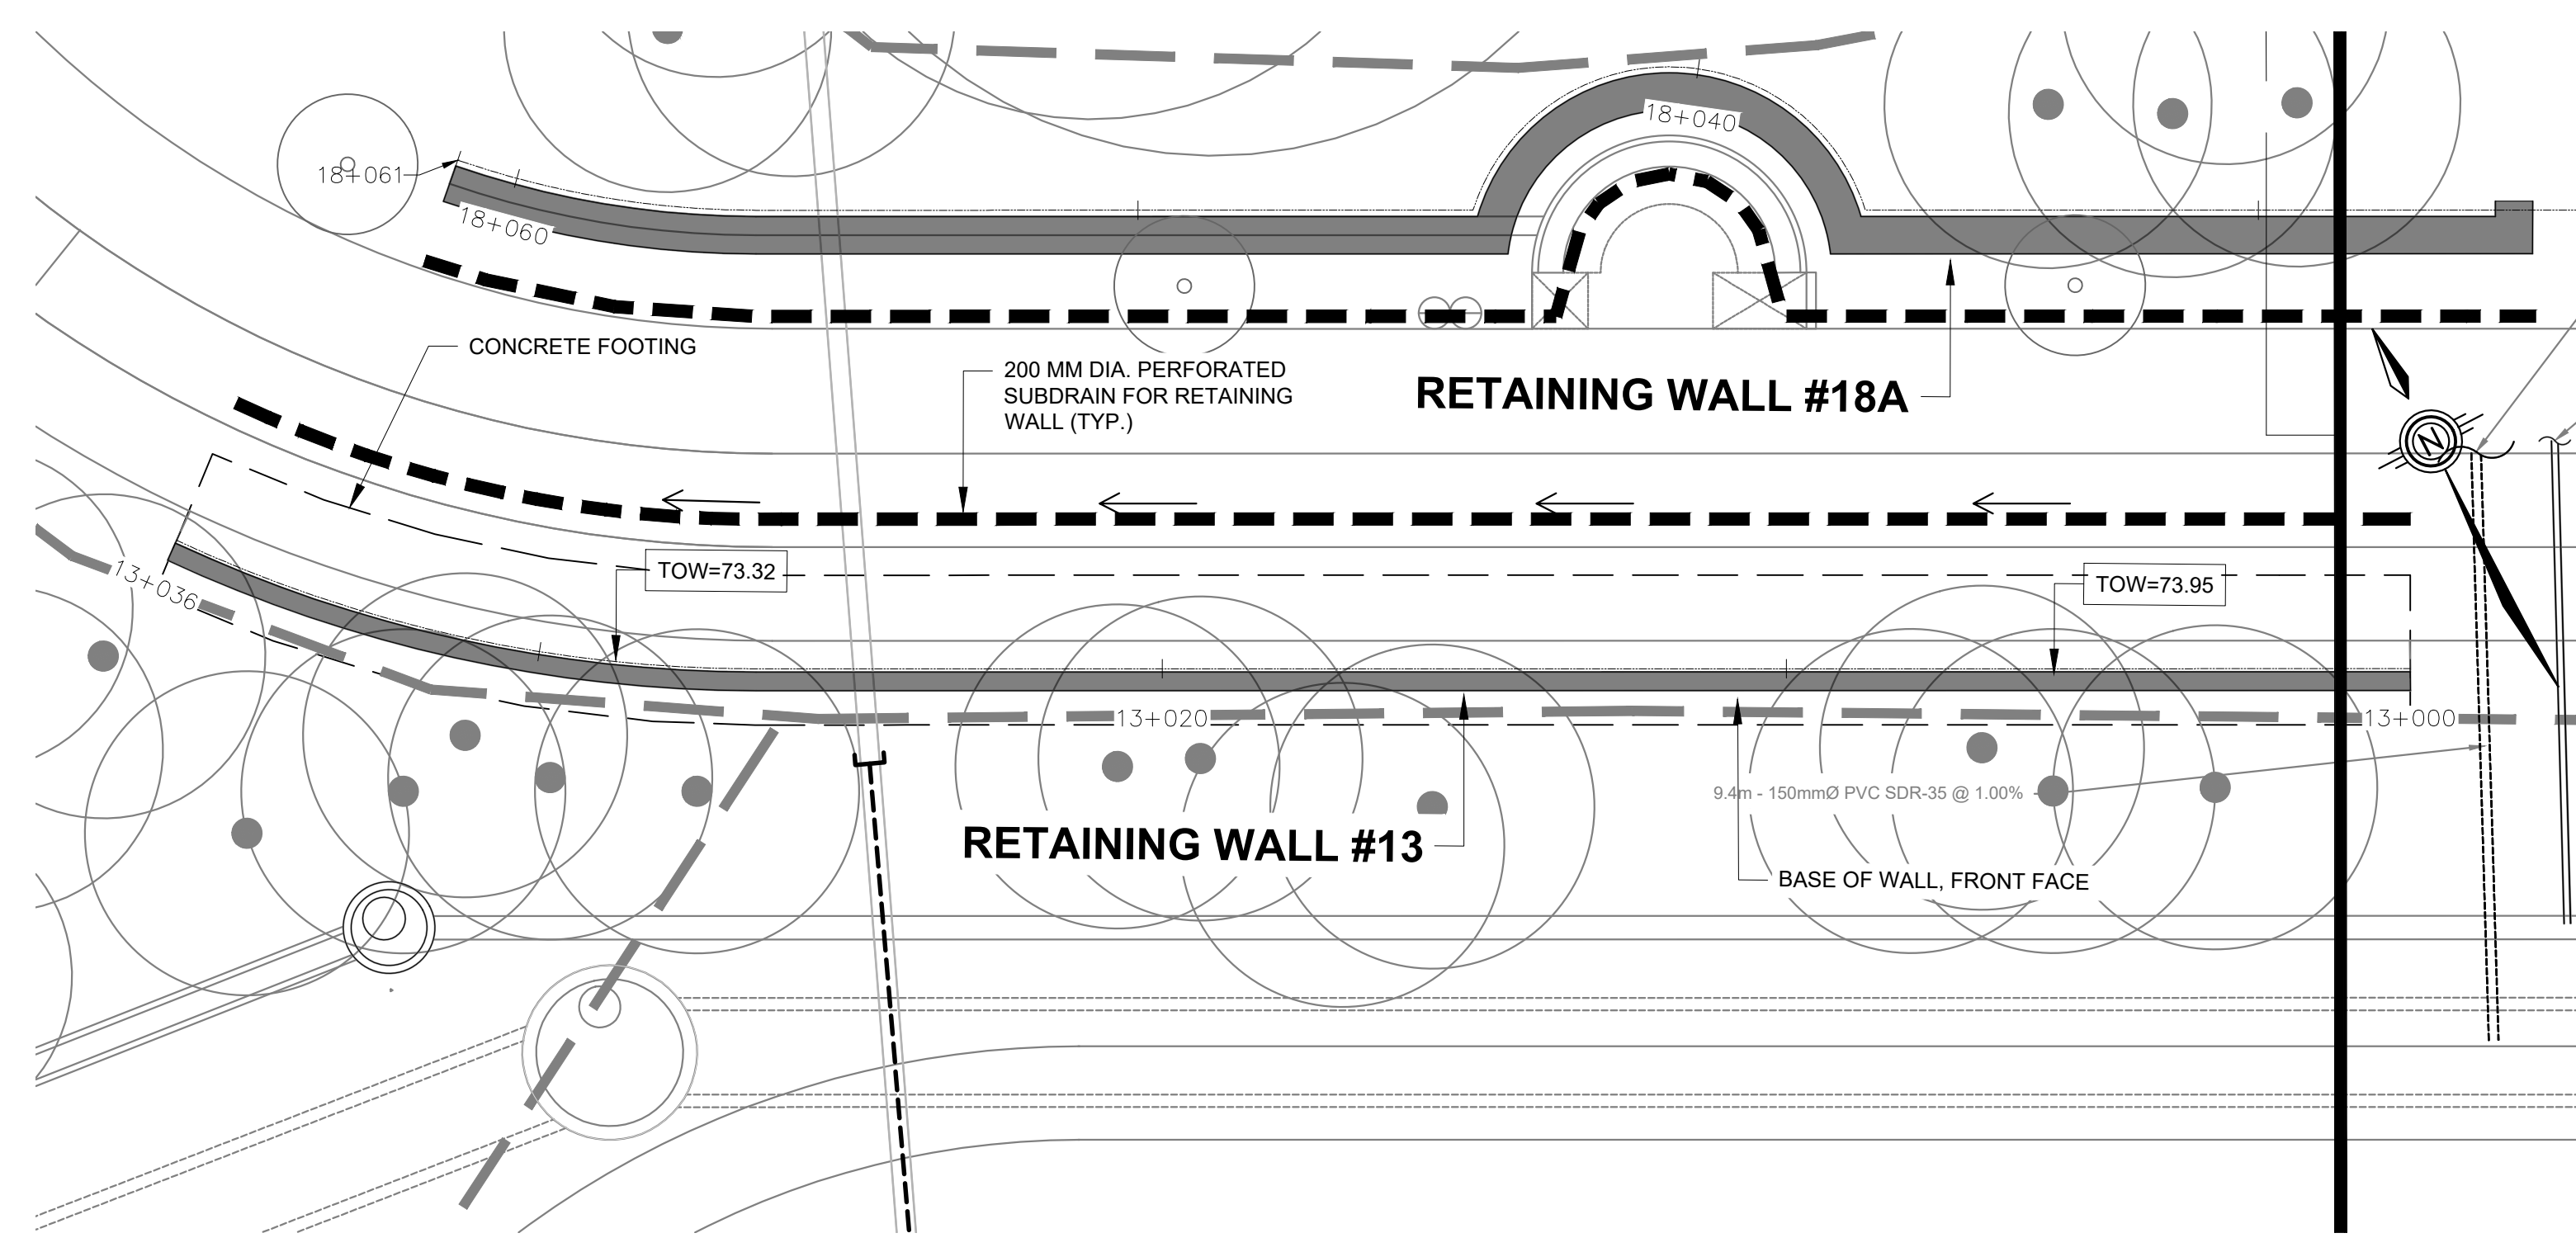


PLAN - RETAINING WALL #13
1:100

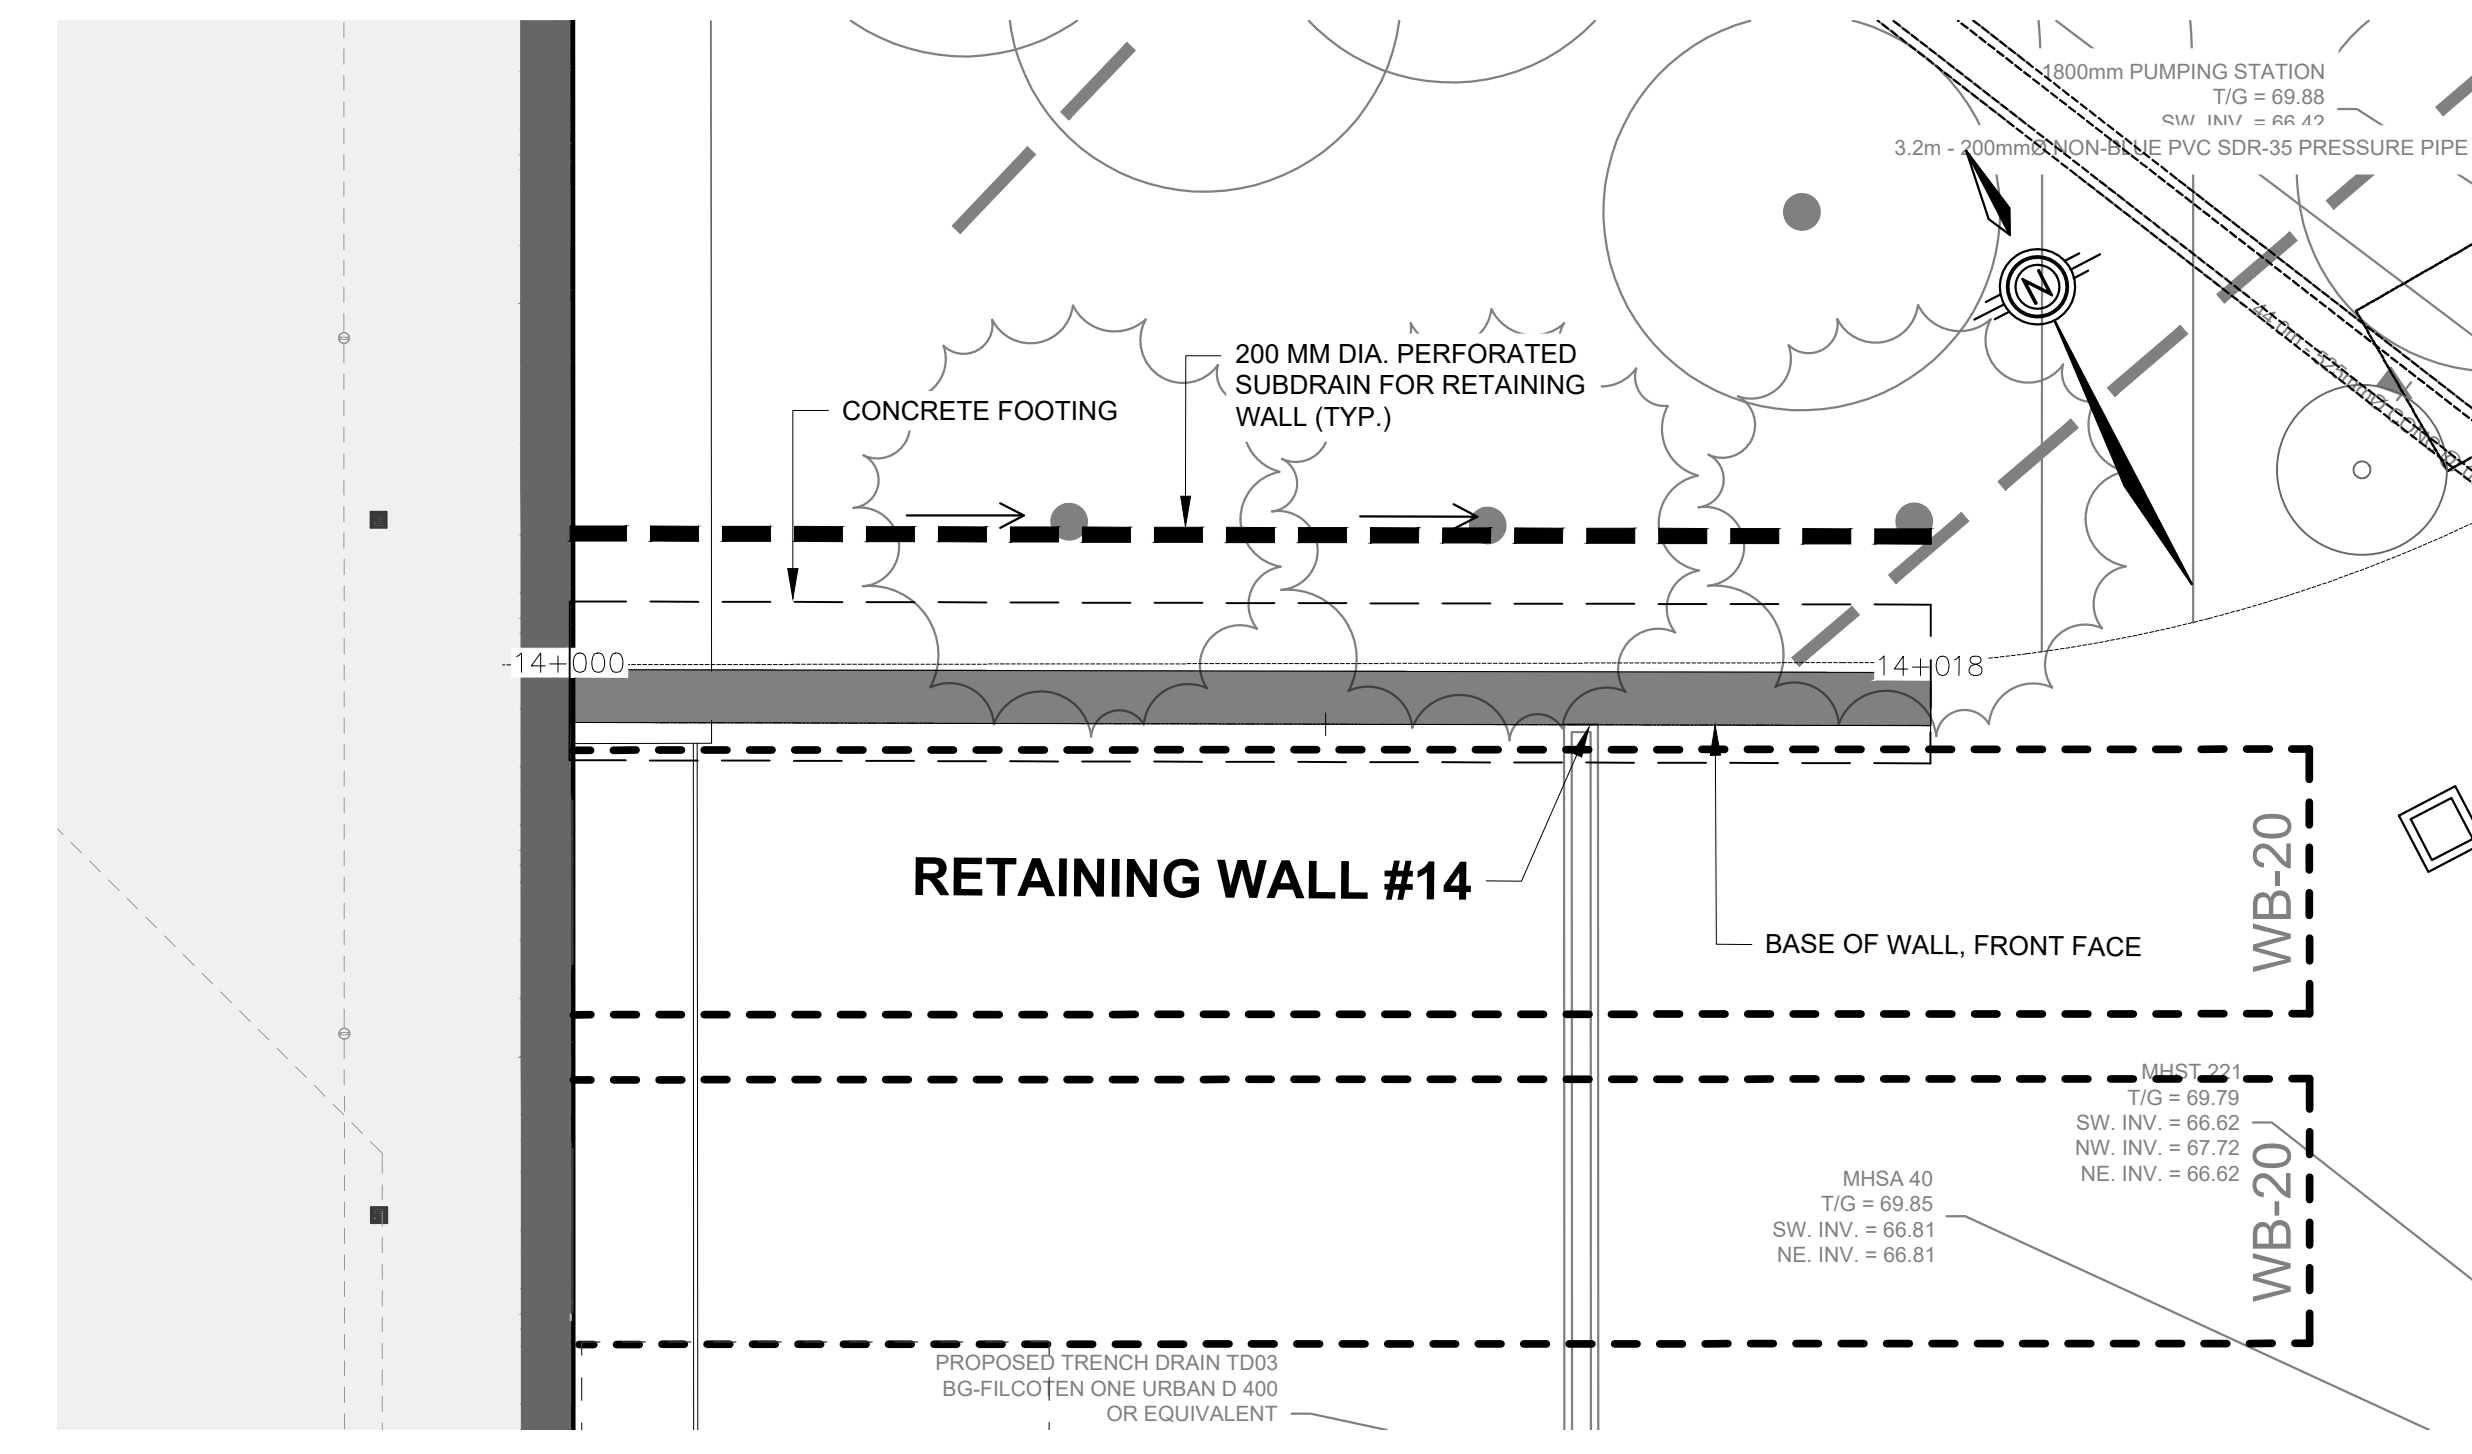


PLAN - RETAINING WALL #14
1:100

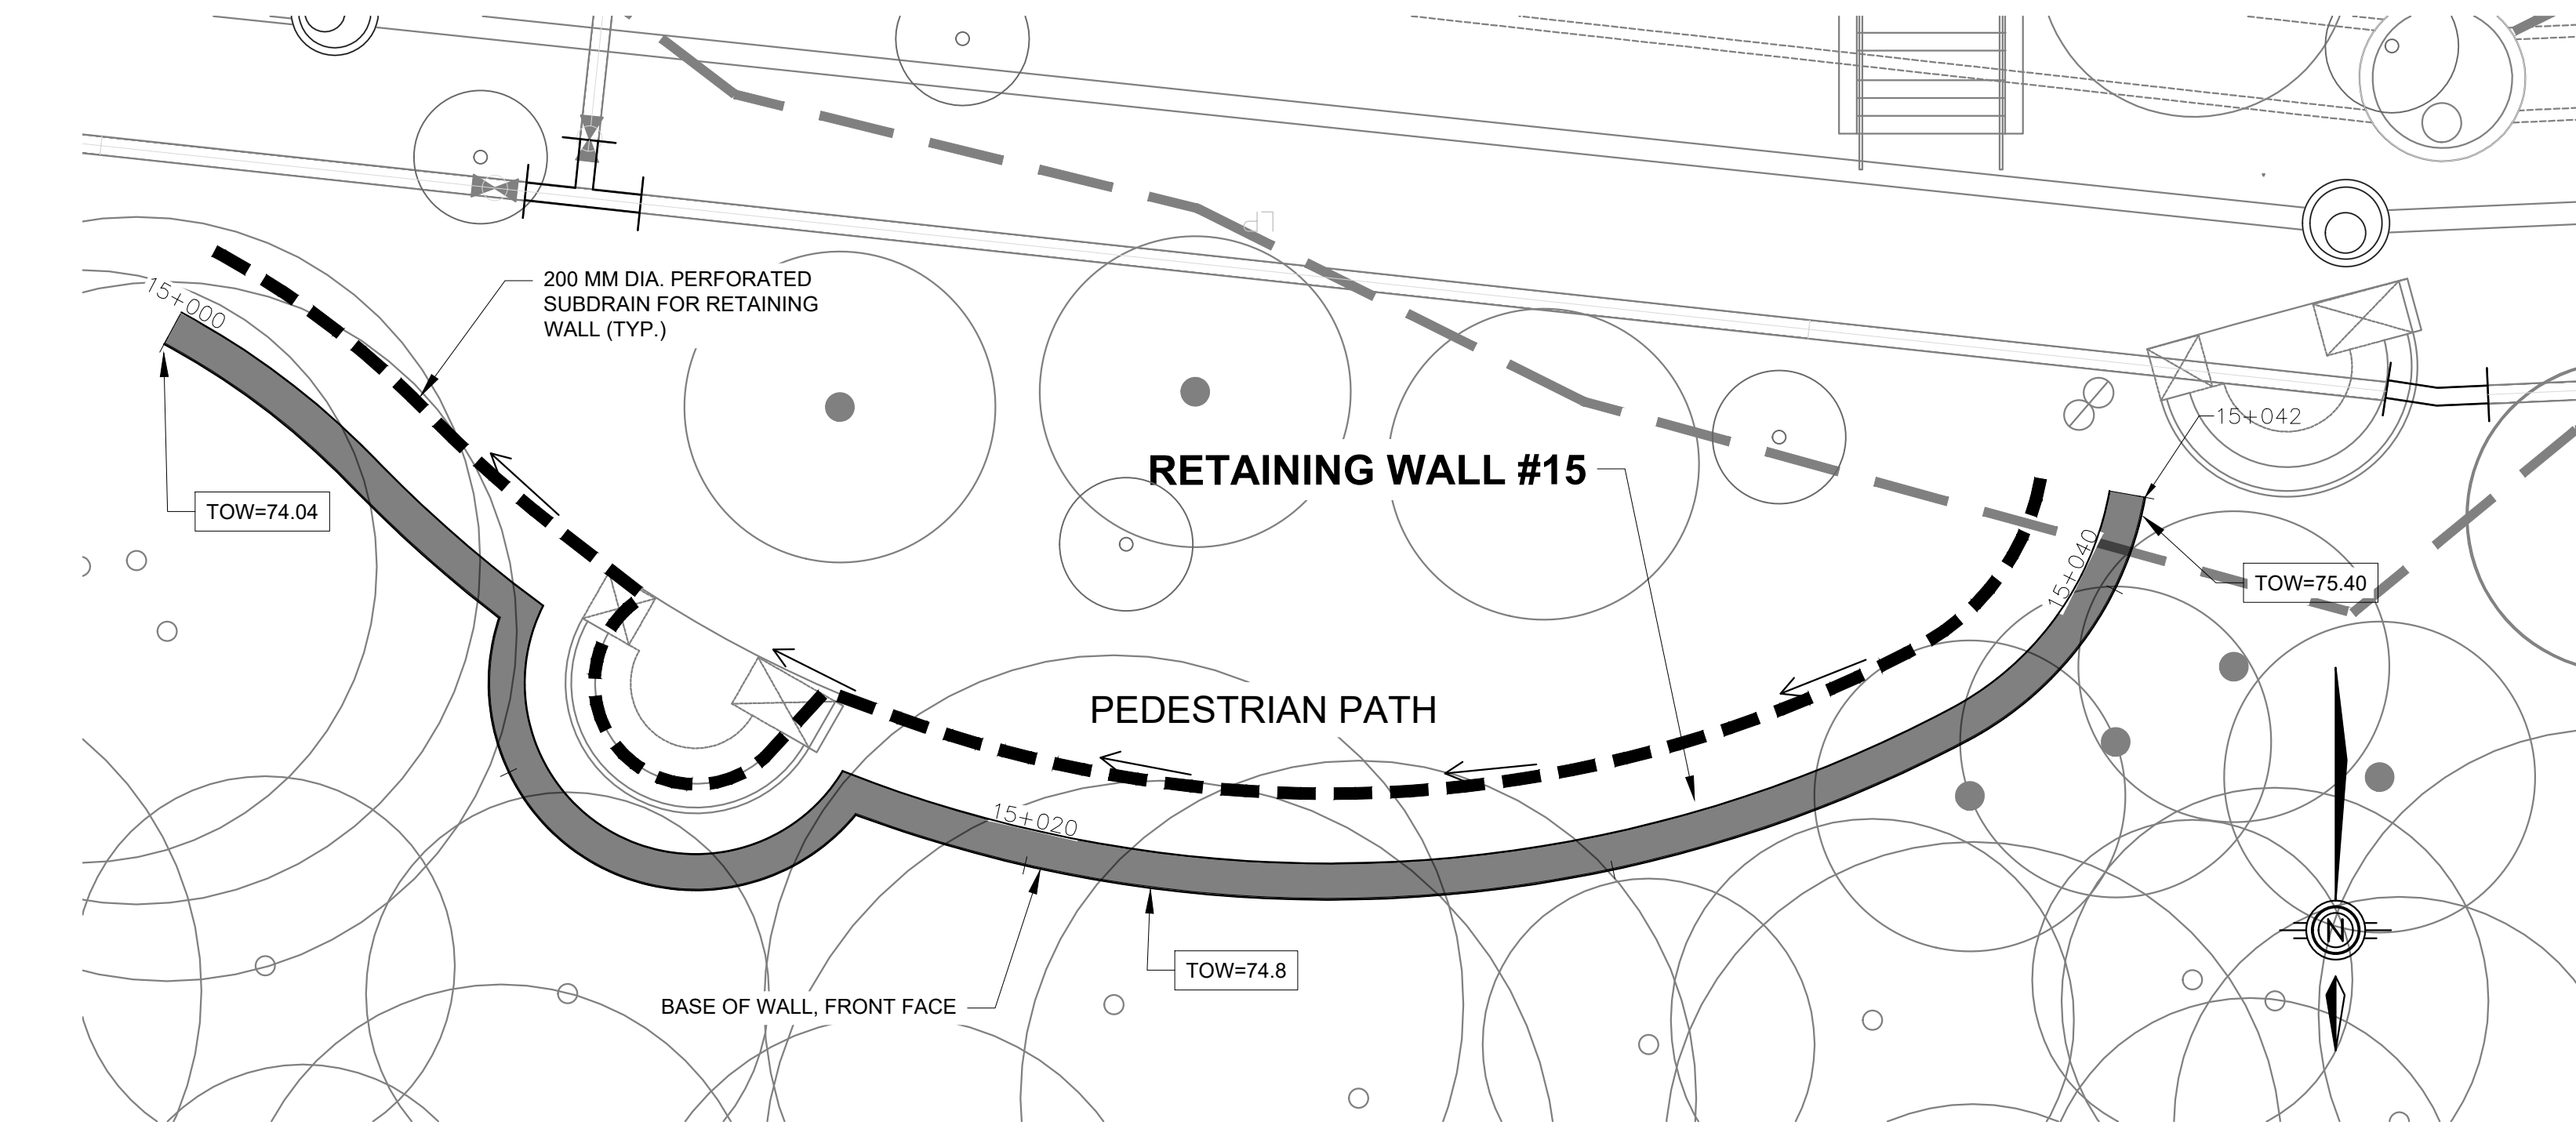


PLAN - RETAINING WALL #15
1:100

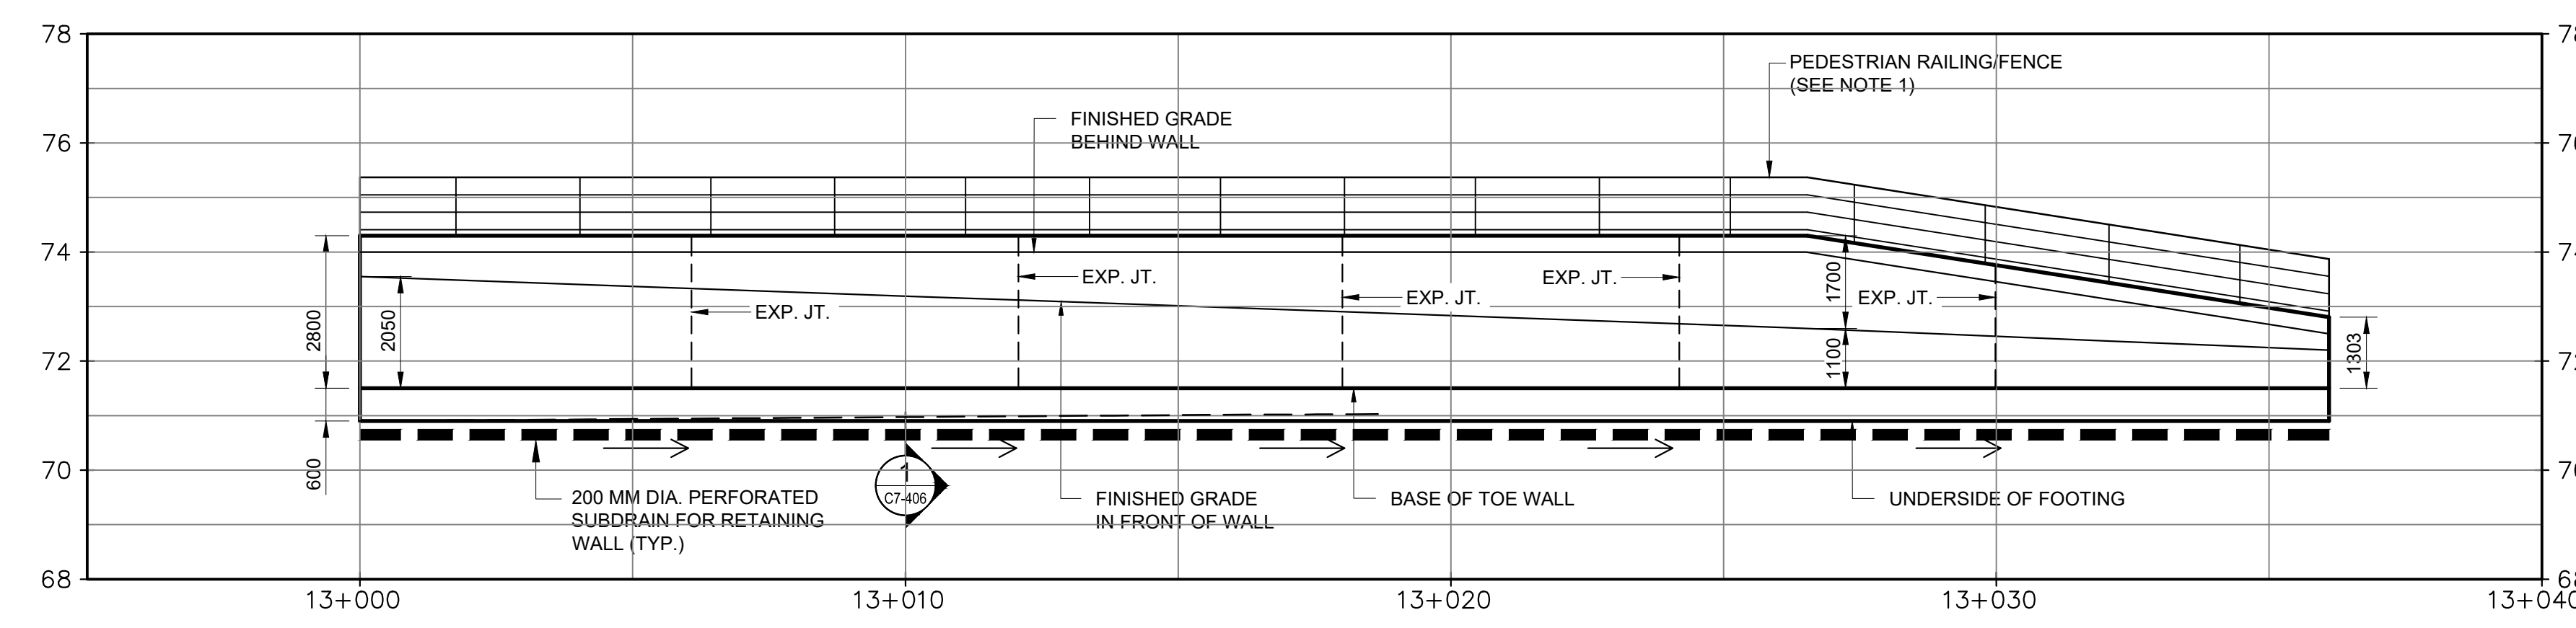

ELEVATION - RETAINING WALL #13
1:100

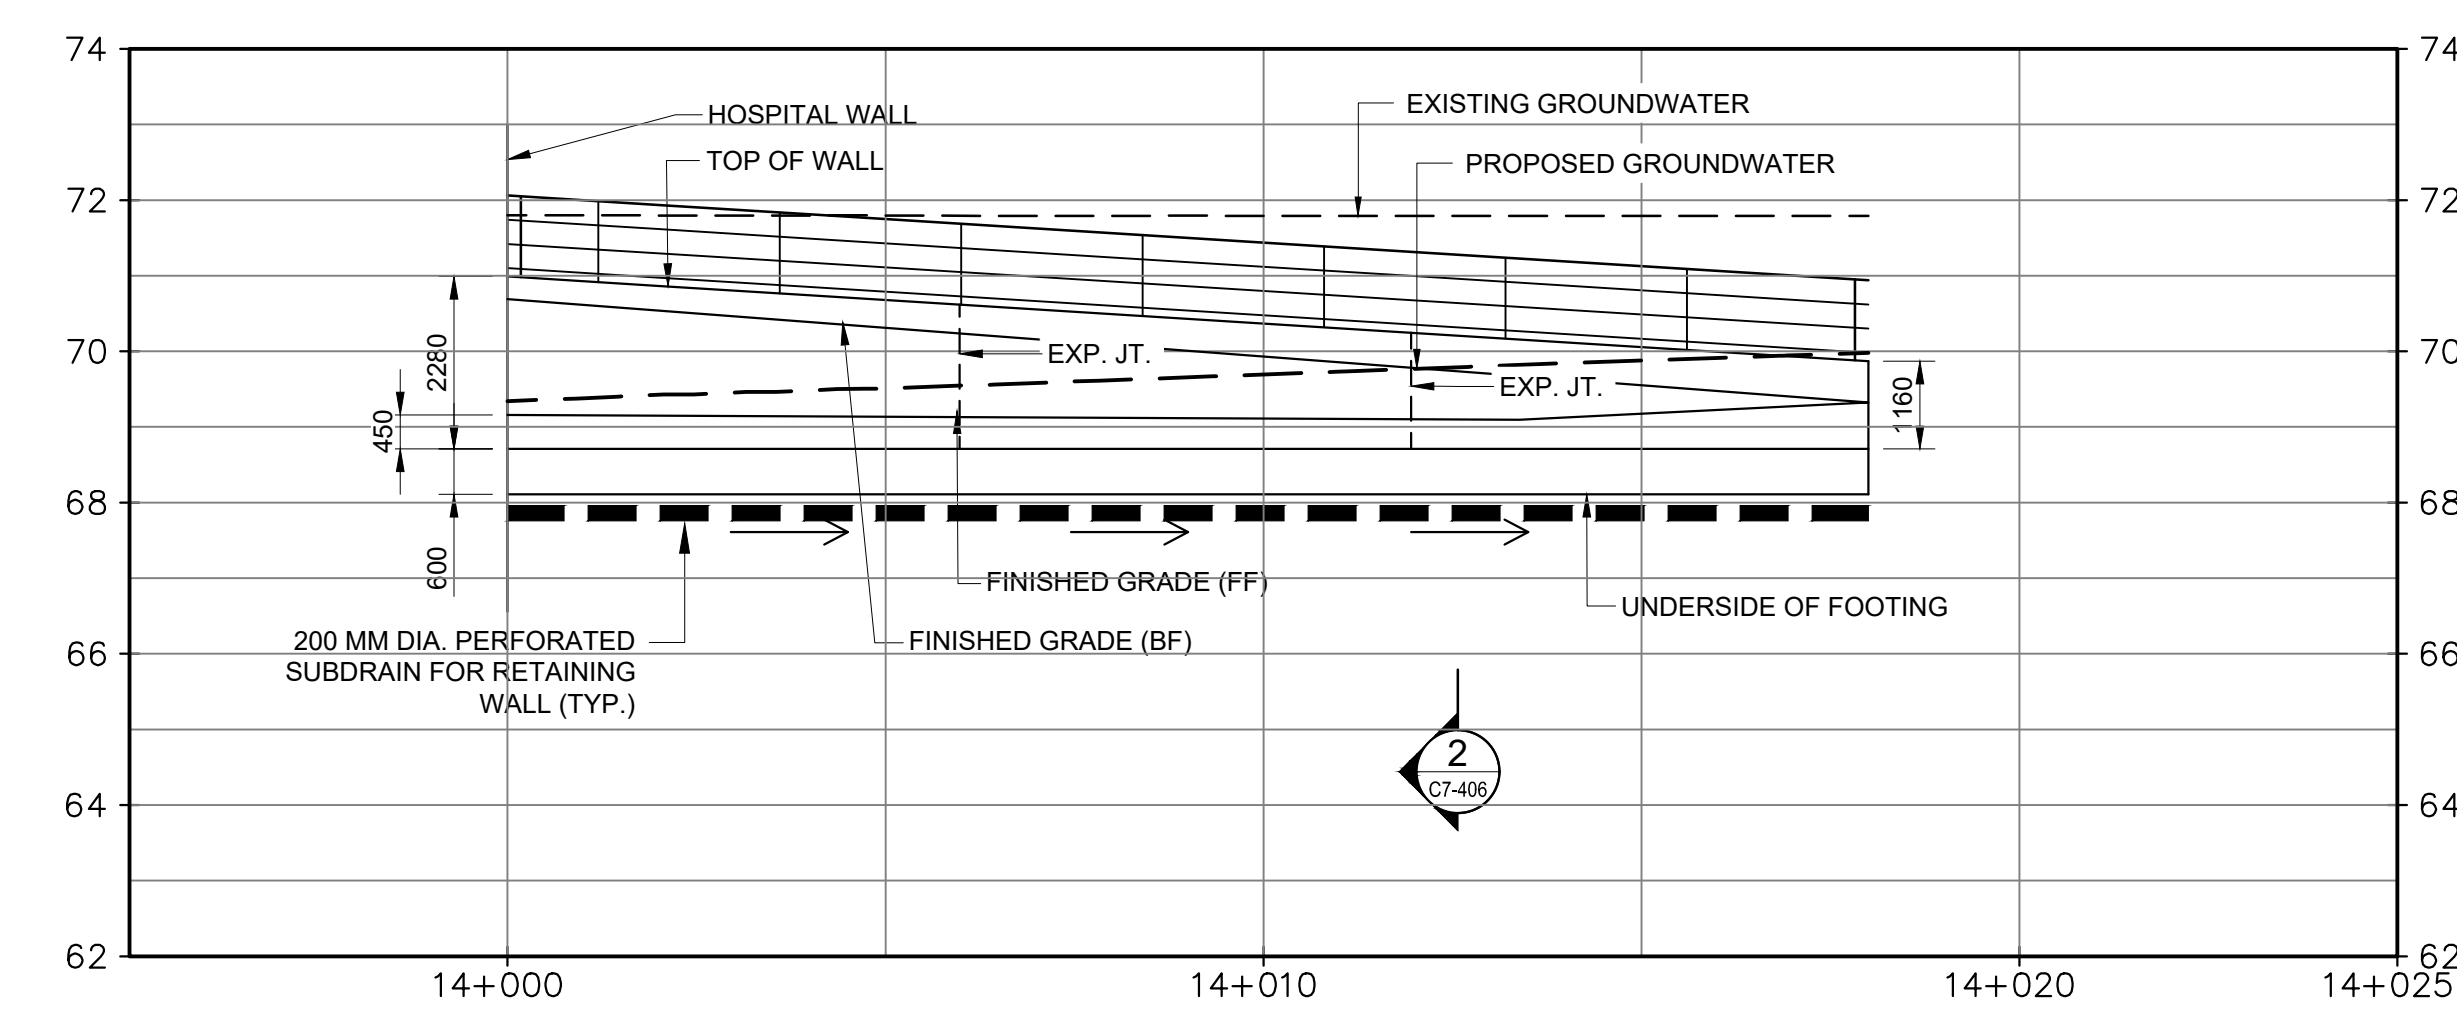


ELEVATION - RETAINING WALL #14
1:100

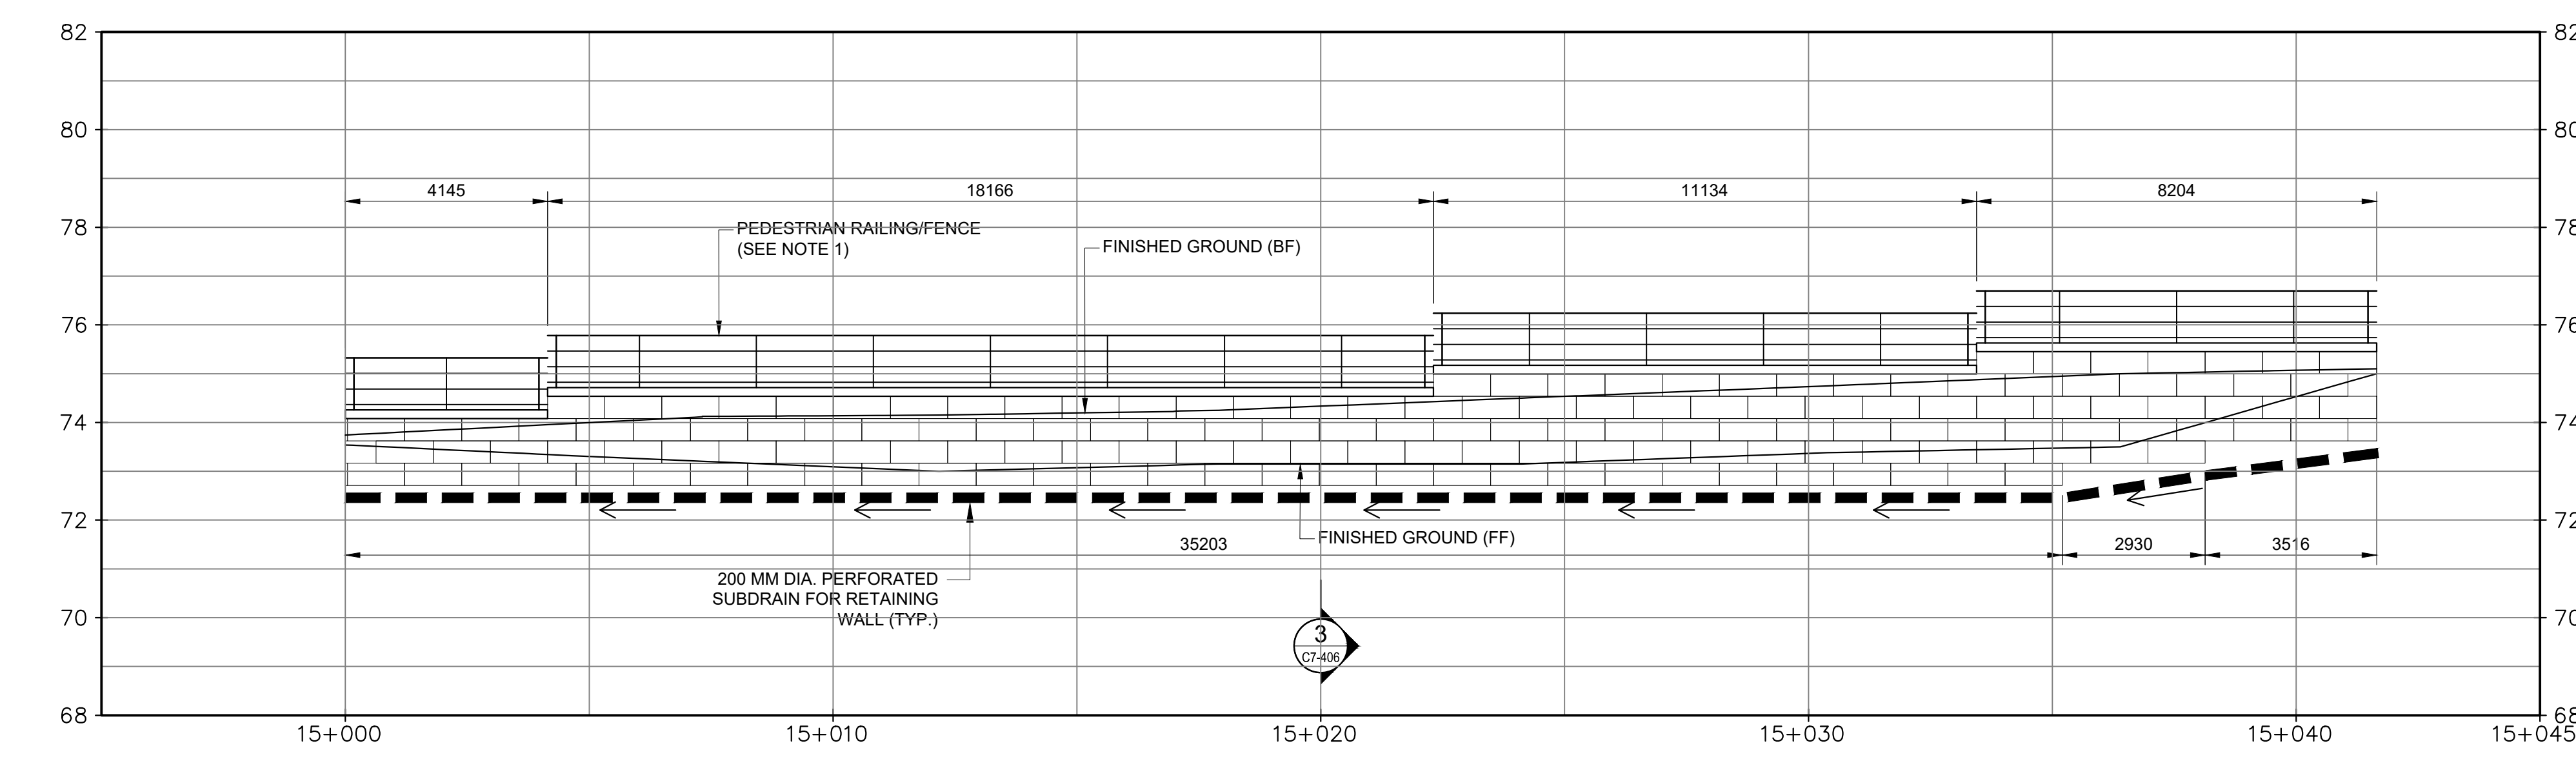


ELEVATION - RETAINING WALL #15
1:100


- NOTES:
- RAILING AND FENCE DETAILS SHOWN ON DRAWING C7-408
 - TREE PLANTING BEHIND RETAINING WALLS IS NOT PERMITTED WITHIN 2.0m OF THE BACK OF THE WALL. ROOT CONTROL MEASURES (BARRIERS AND/OR BAGS) SHALL BE USED FOR ALL TREE PLANTINGS IN THE VICINITY OF WALLS.
 - INSULATION DIRECTLY BELOW FOOTING TO CONSIST OF H-40 RIGID INSULATION. INSULATION BEHIND FOOTING FOOTPRINT MAY CONSIST OF 60 RIGID INSULATION.
 - THE TOP OF WALL ELEVATIONS SPECIFIED FOR PRECAST CONCRETE BLOCKS ARE IDEALIZED AND SUBJECT TO SHOP DRAWING REVIEW. THE SUPPLIER MAY ELECT TO MARK ELEVATIONS MORE STEEP THAN SHOWN WHICH WILL BE REVIEWED BY LANDSCAPE AND CIVIL THROUGH THE SHOP DRAWING REVIEW PROCESS.
 - EXISTING AND POST CONSTRUCTION GROUNDWATER ELEVATIONS ARE SHOWN AS PER THE HYDROLOGICAL REPORT. THE ELEVATIONS ARE NOT INTENDED TO REPRESENT THE GROUNDWATER DIRECTLY BEHIND THE WALLS. THE WALLS ARE TO BE BACKFILLED WITH FREE DRAINING MATERIAL AND DRAINS AS SPECIFIED AND HAVE NOT BEEN CONSIDERED TO HYDROSTATIC BUILDUP BEHIND THE WALLS.

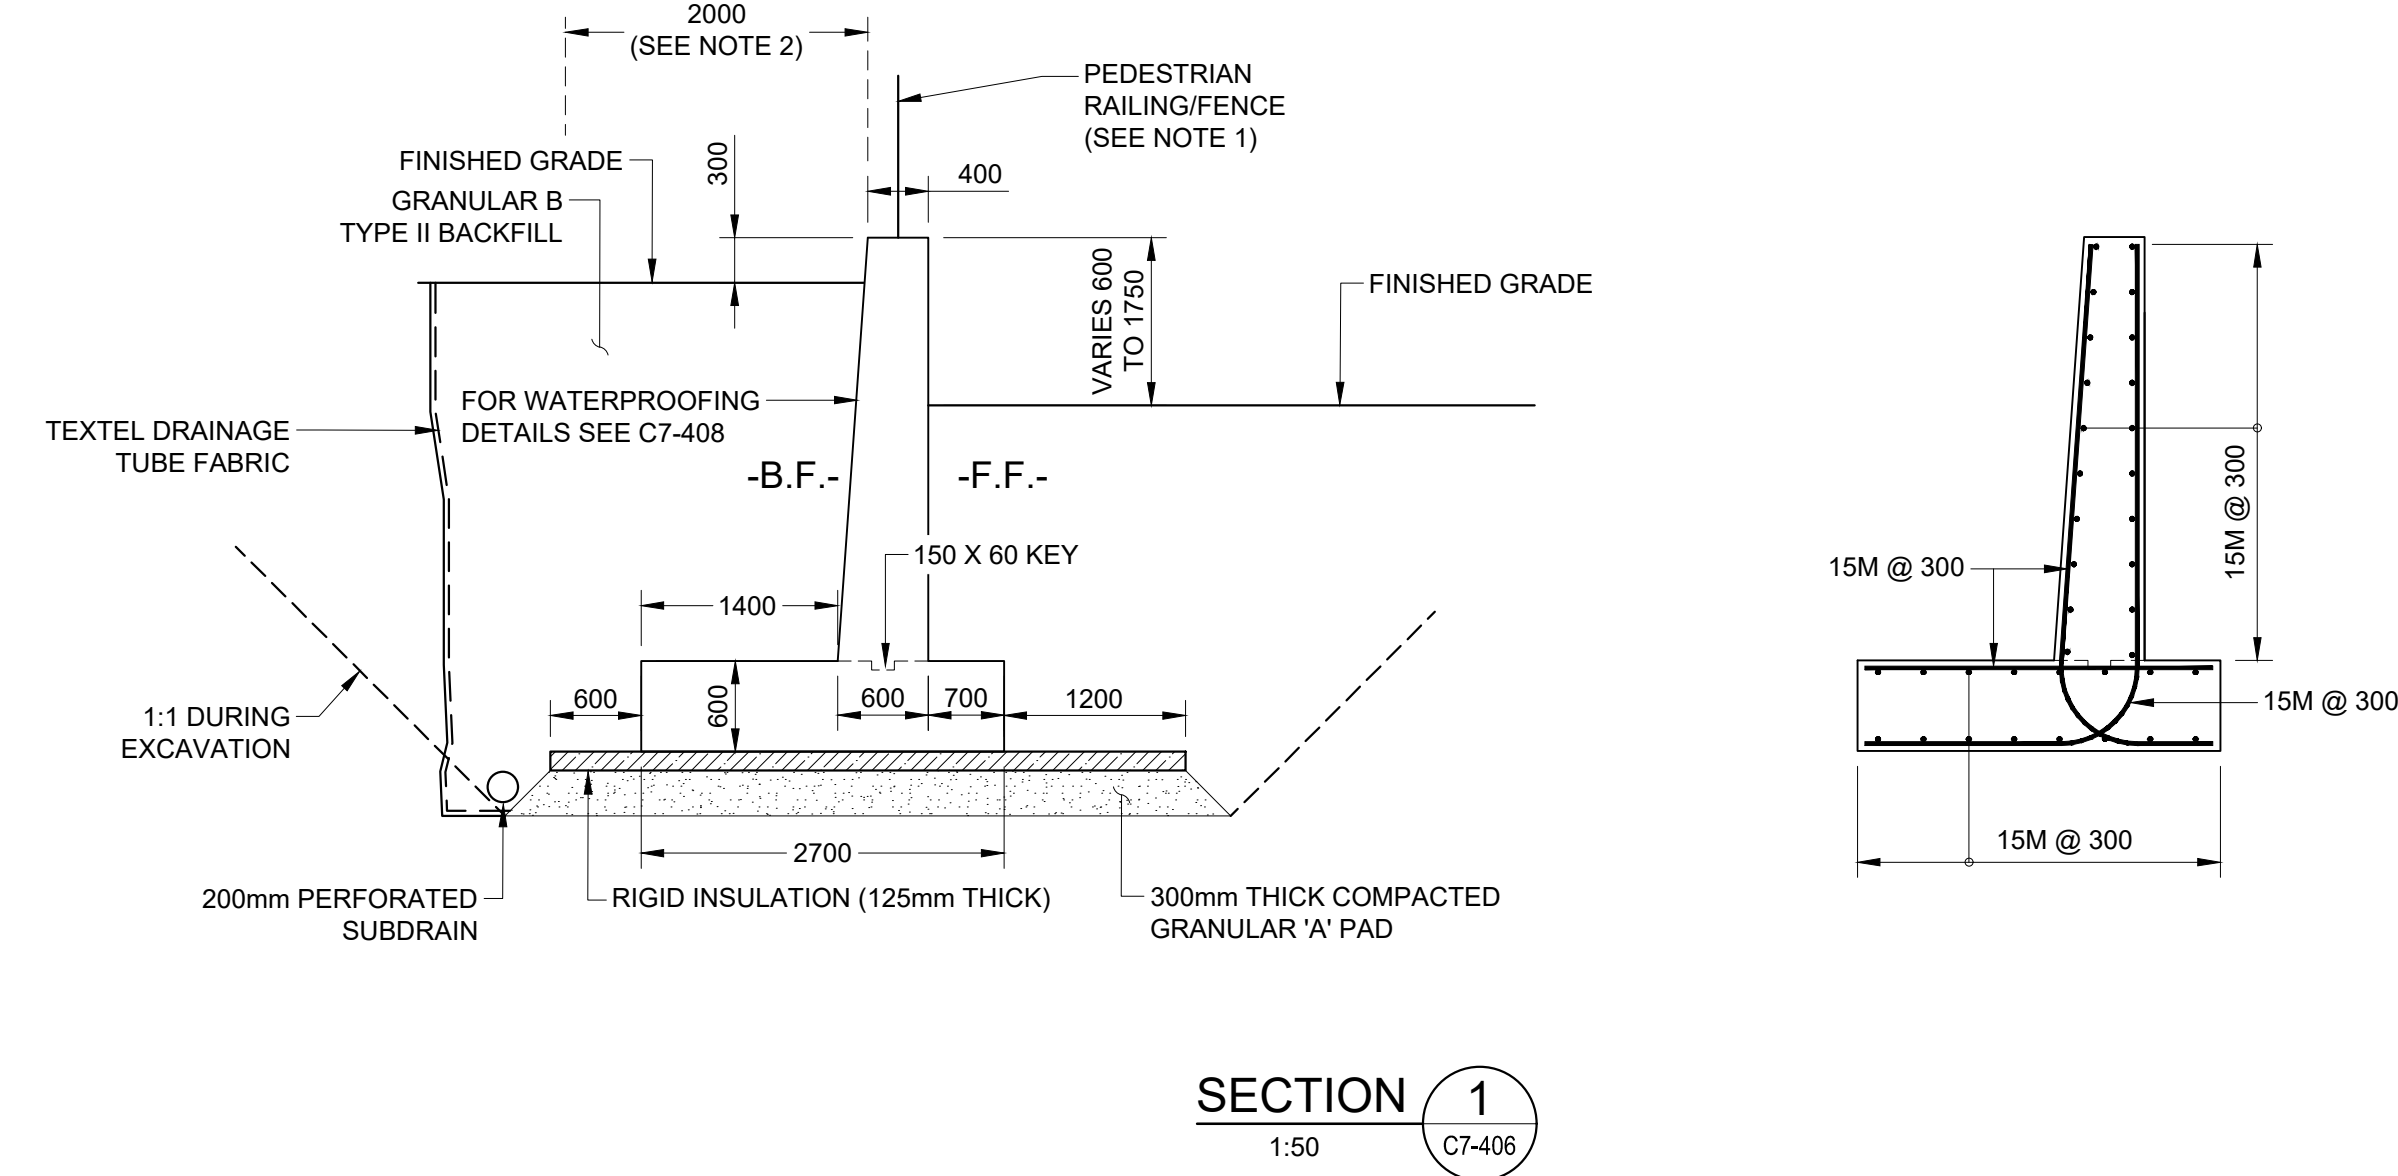


SECTION 1
1:50
C7-408

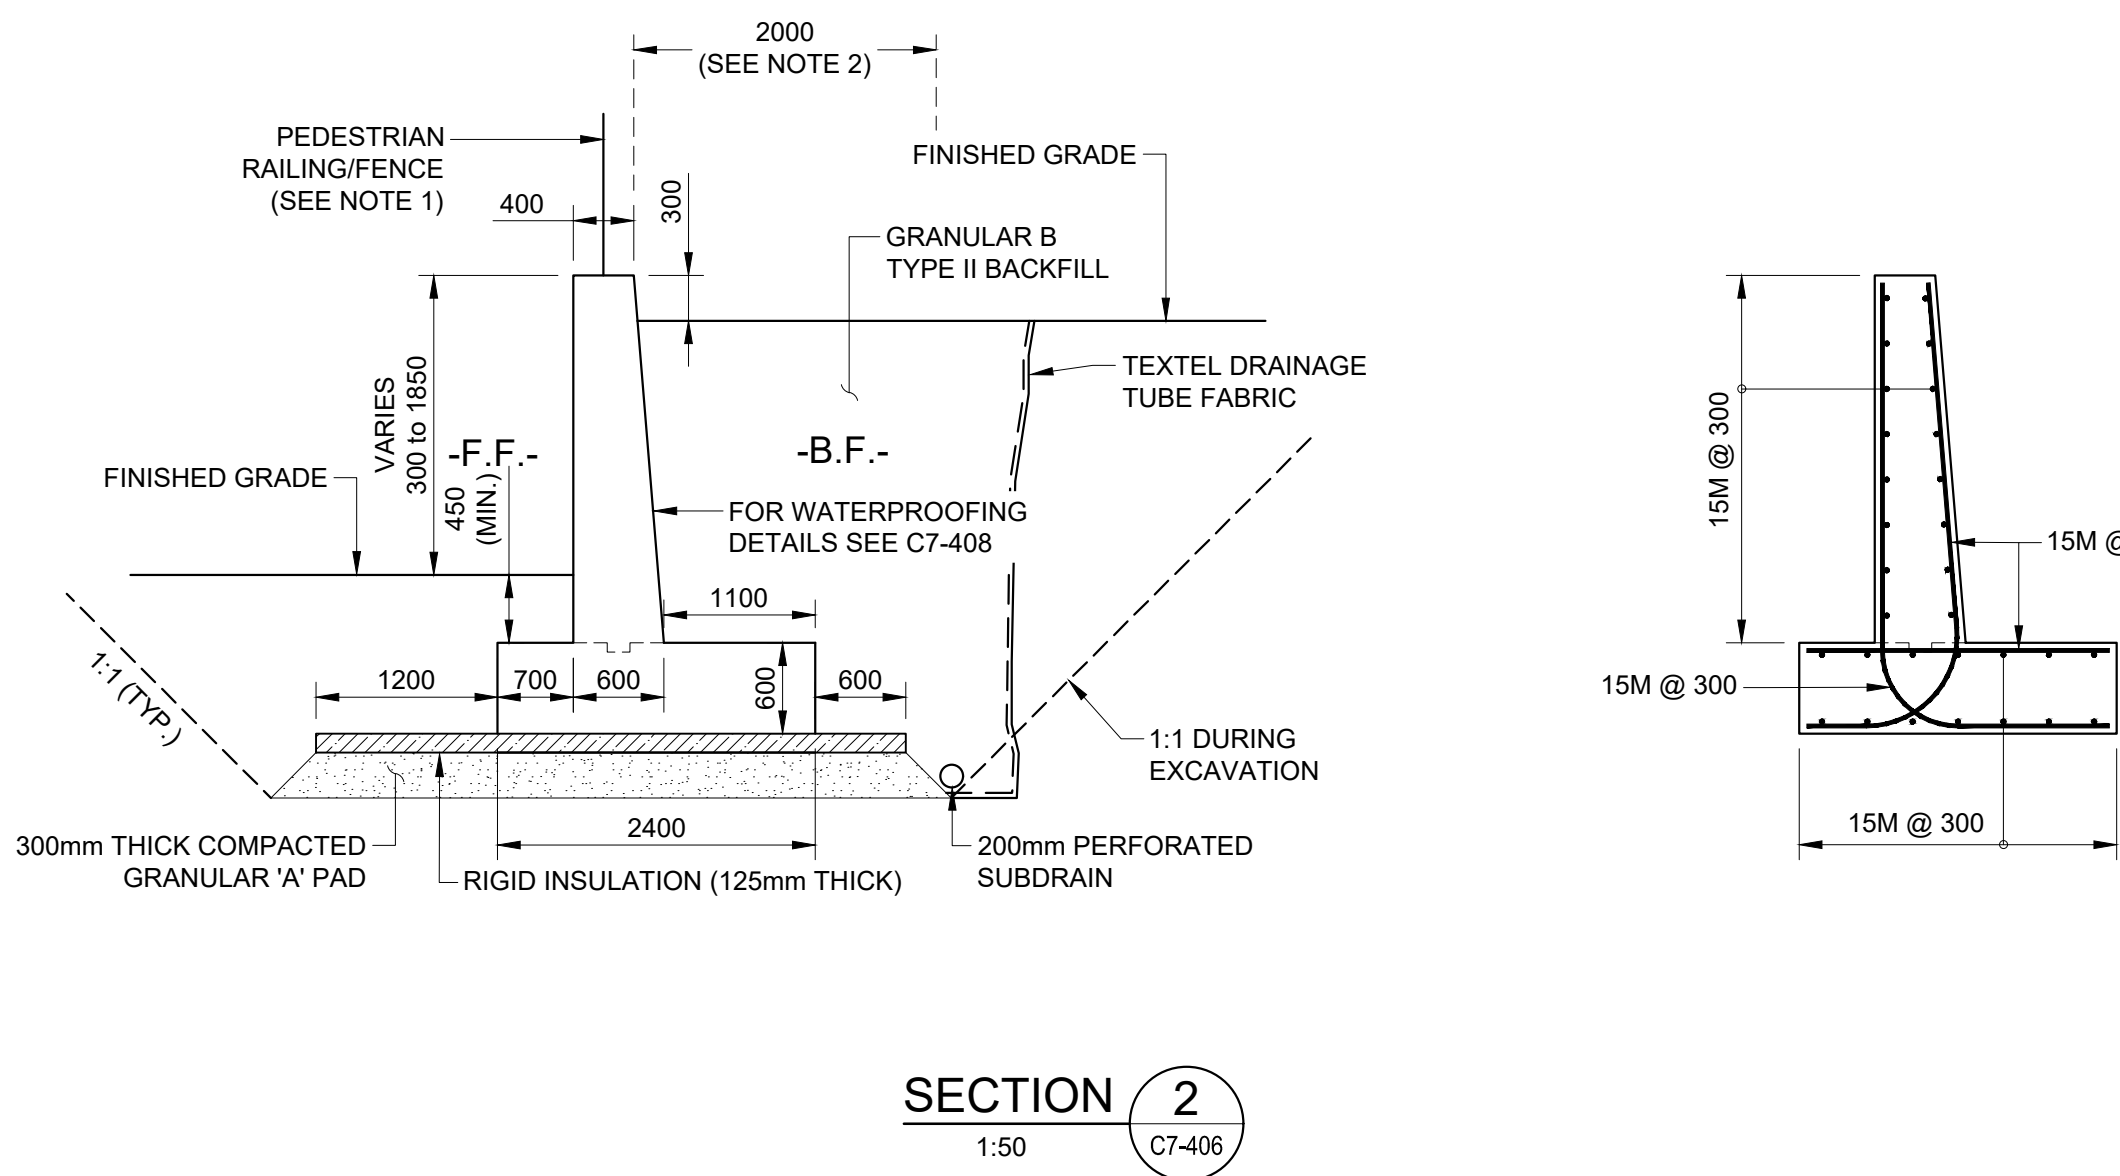

SECTION 2
1:50
C7-408

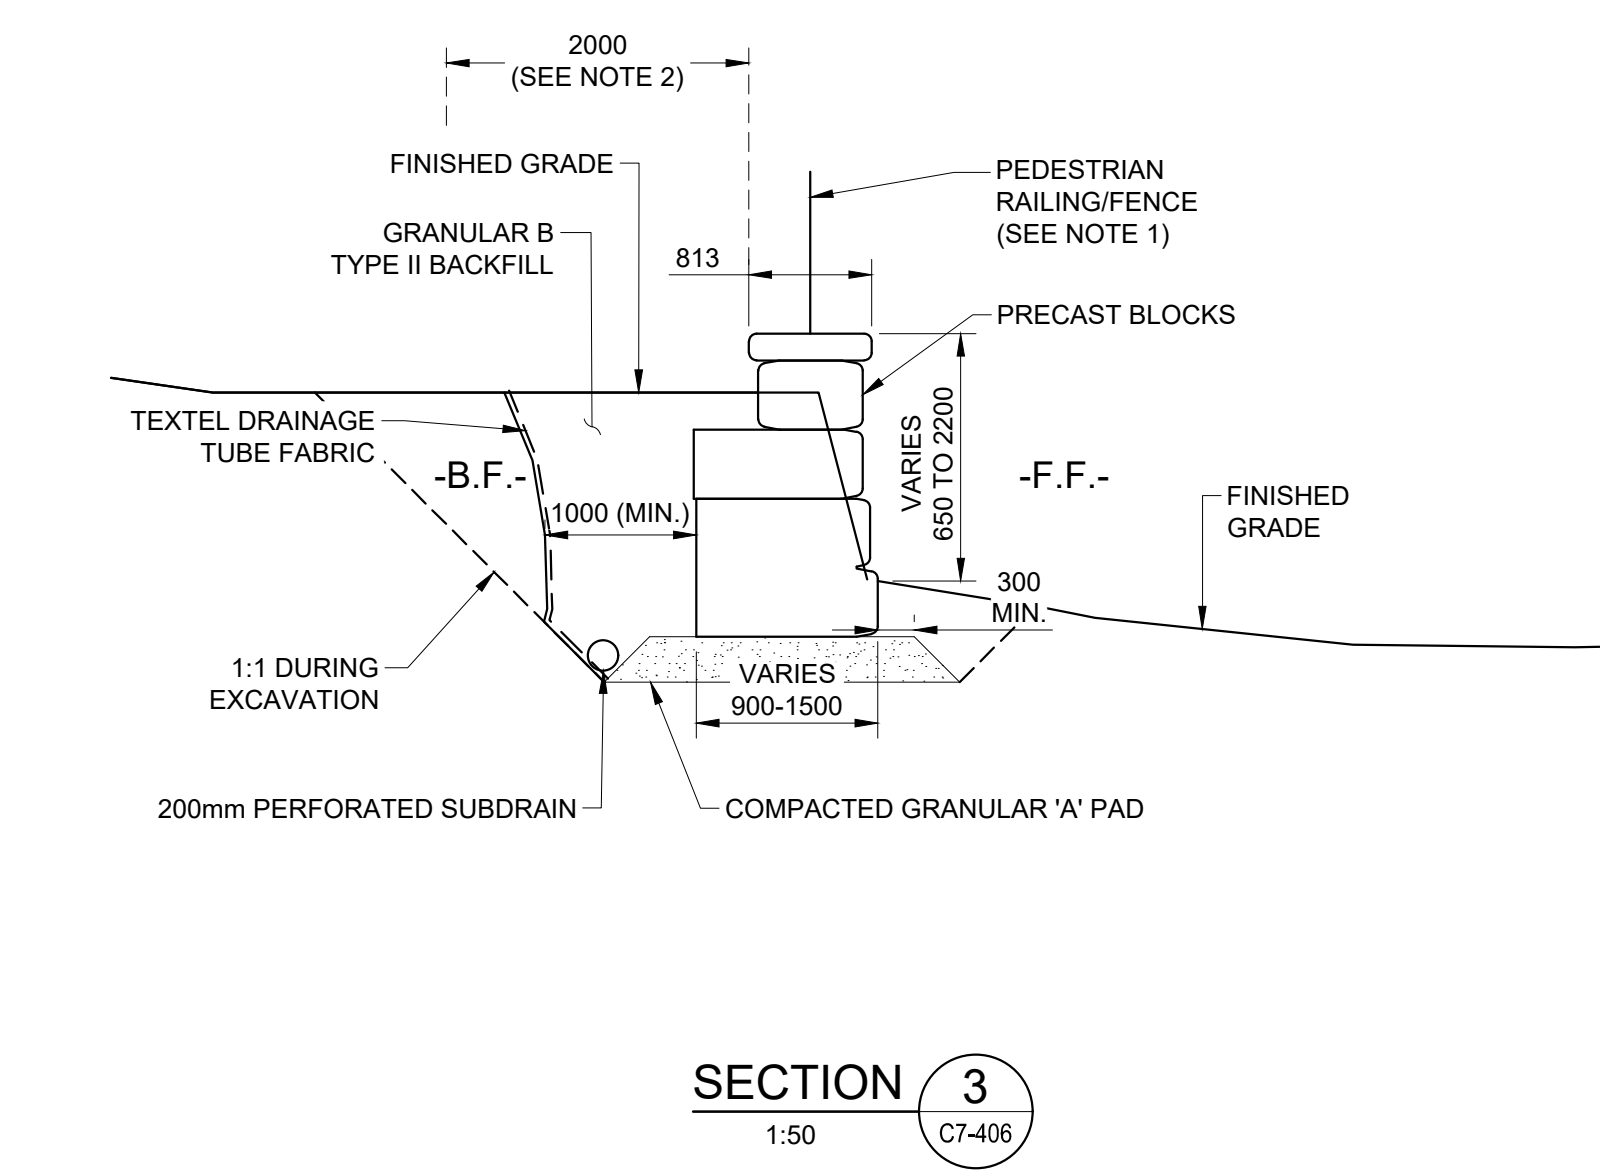

SECTION 3
1:50
C7-408

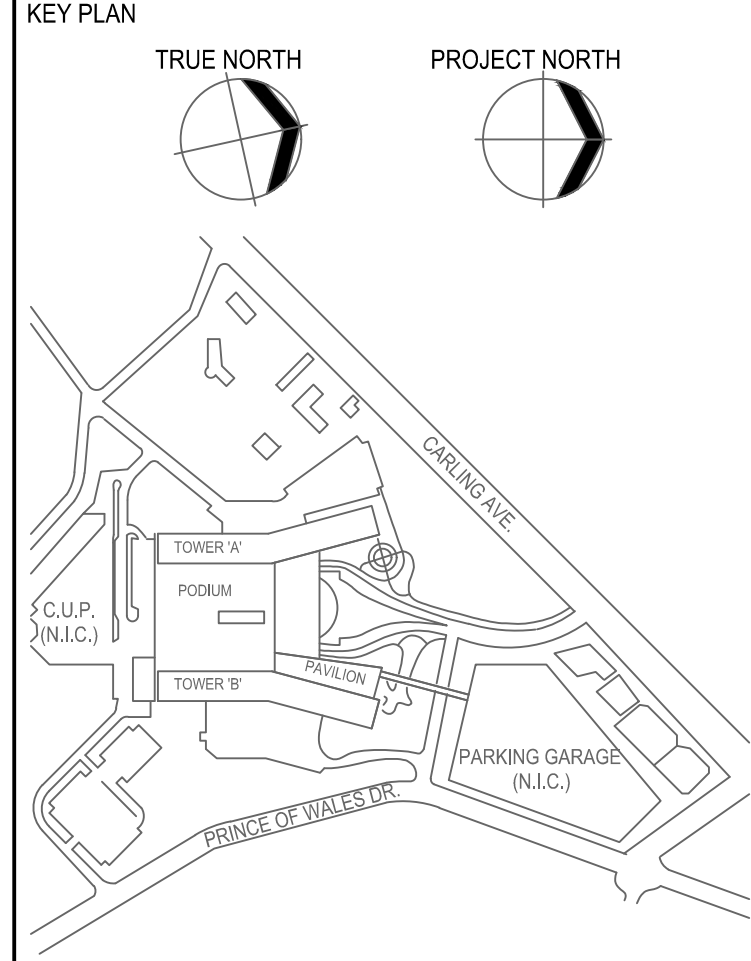


NO.	REVISIONS	DATE
05	SITE PLAN CONTROL RESUBMISSION NO. 2026-03-27	
06	DESIGN BUILD BASELINE SUBMISSION	2026-03-05
07	FOUNDATION PERMIT SUBMISSION	2026-01-12
08	SITE PLAN CONTROL RESUBMISSION	2026-01-12
09	80% DD SUBMISSION	2025-09-19
10	SITE PLAN CONTROL RESUBMISSION	2025-08-05
11	65% DD SUBMISSION	2025-08-05
12	35% DD SUBMISSION	2025-01-28
13	ISSUED FOR ACPOR READINESS	2025-01-08
14	80% SD SUBMISSION	2024-08-15
15	ISSUED	DATE

NOT FOR CONSTRUCTION

DISCREPANCIES MUST BE REPORTED IMMEDIATELY TO THE ARCHITECT BEFORE PROCEEDING. ONLY FIGURED DIMENSIONS ARE TO BE USED. CONTRACTORS MUST CHECK ALL DIMENSIONS ON SITE. THIS DRAWING IS PROTECTED BY COPYRIGHT.

ALL DIMENSIONS ARE SHOWN IN METRIC.

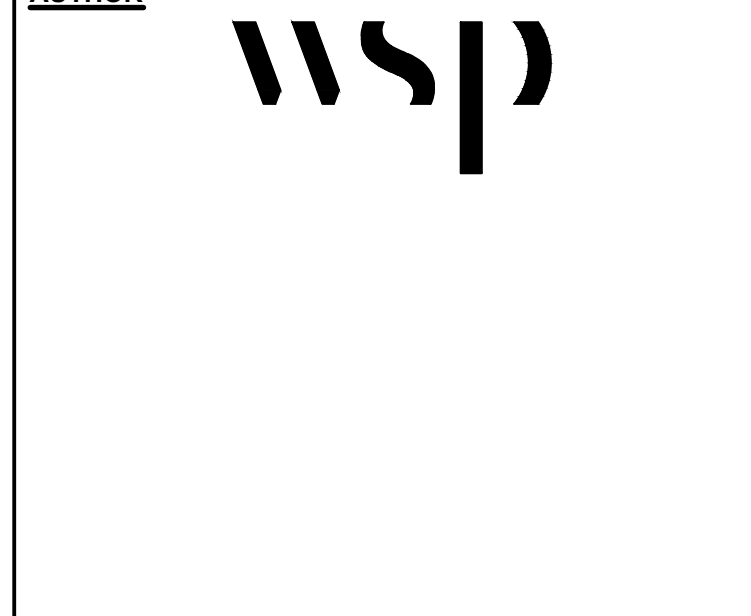

PROJECT TEAM
DESIGN BUILDER: PCL/ED JOINT VENTURE
ARCHITECTURAL: PARKIN ARCHITECTS LIMITED, JOSHUA LAMARIE PRATTE ARCHITECTS, ADAMSON ASSOCIATES ARCHITECTS, 888 ARCHITECTS OTTAWA INC.
STRUCTURAL: SALAS OBREN CANADA INC., BOUTHELLETT PARISBAU INC.
MECHANICAL: HJ ANGLUS & ASSOCIATES LTD., SALAS OBREN CANADA INC.
ELECTRICAL: HOF CHANG INC., MELVEY & BARNAN INTERNATIONAL INC.
CIVIL: HOF CHANG INC., HOF CHANG DESIGN INC.
LANDSCAPE: PJP LANDSCAPE ARCHITECTURE

BUILDING CODE: UMG BUILDING CODE CONSULTANTS LTD.
AUTHOR PROJECT NO.: **CA0027758.0-51**

DRAWING TITLE
**RETAINING WALLS
#13, #14 & #15**

DRAWN: K. MARTIN
CHECKED: M. THOM

SCALE: AS SHOWN
DATE: 2024-02-26

GRAPHIC SCALE
1:250

DRAWING NO.: **C7-406**
REV. NO.: 10

File Number:
D07-12-26-0008 (Revision)
D07-12-22-0108 (Original)
Plan Number: 19424