

1670 TENTH LINE ROAD

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L1.3 LANDSCAPE PLAN

L2.0 LANDSCAPE DETAILS 1


CONSULTANTS

project studio PROJECT 1 STUDIO 300 - 260 St. PATRICK STREET, OTTAWA, ON, CANADA, K1N 5K5 PH: 613. 884. 3939

Urbantypology

UNIT 101 - 45 SPENCER STREET OTTAWA, ON, CANADA, K1Y 2P5 PH: 613 .867 .3042 / 613 .897 .1237



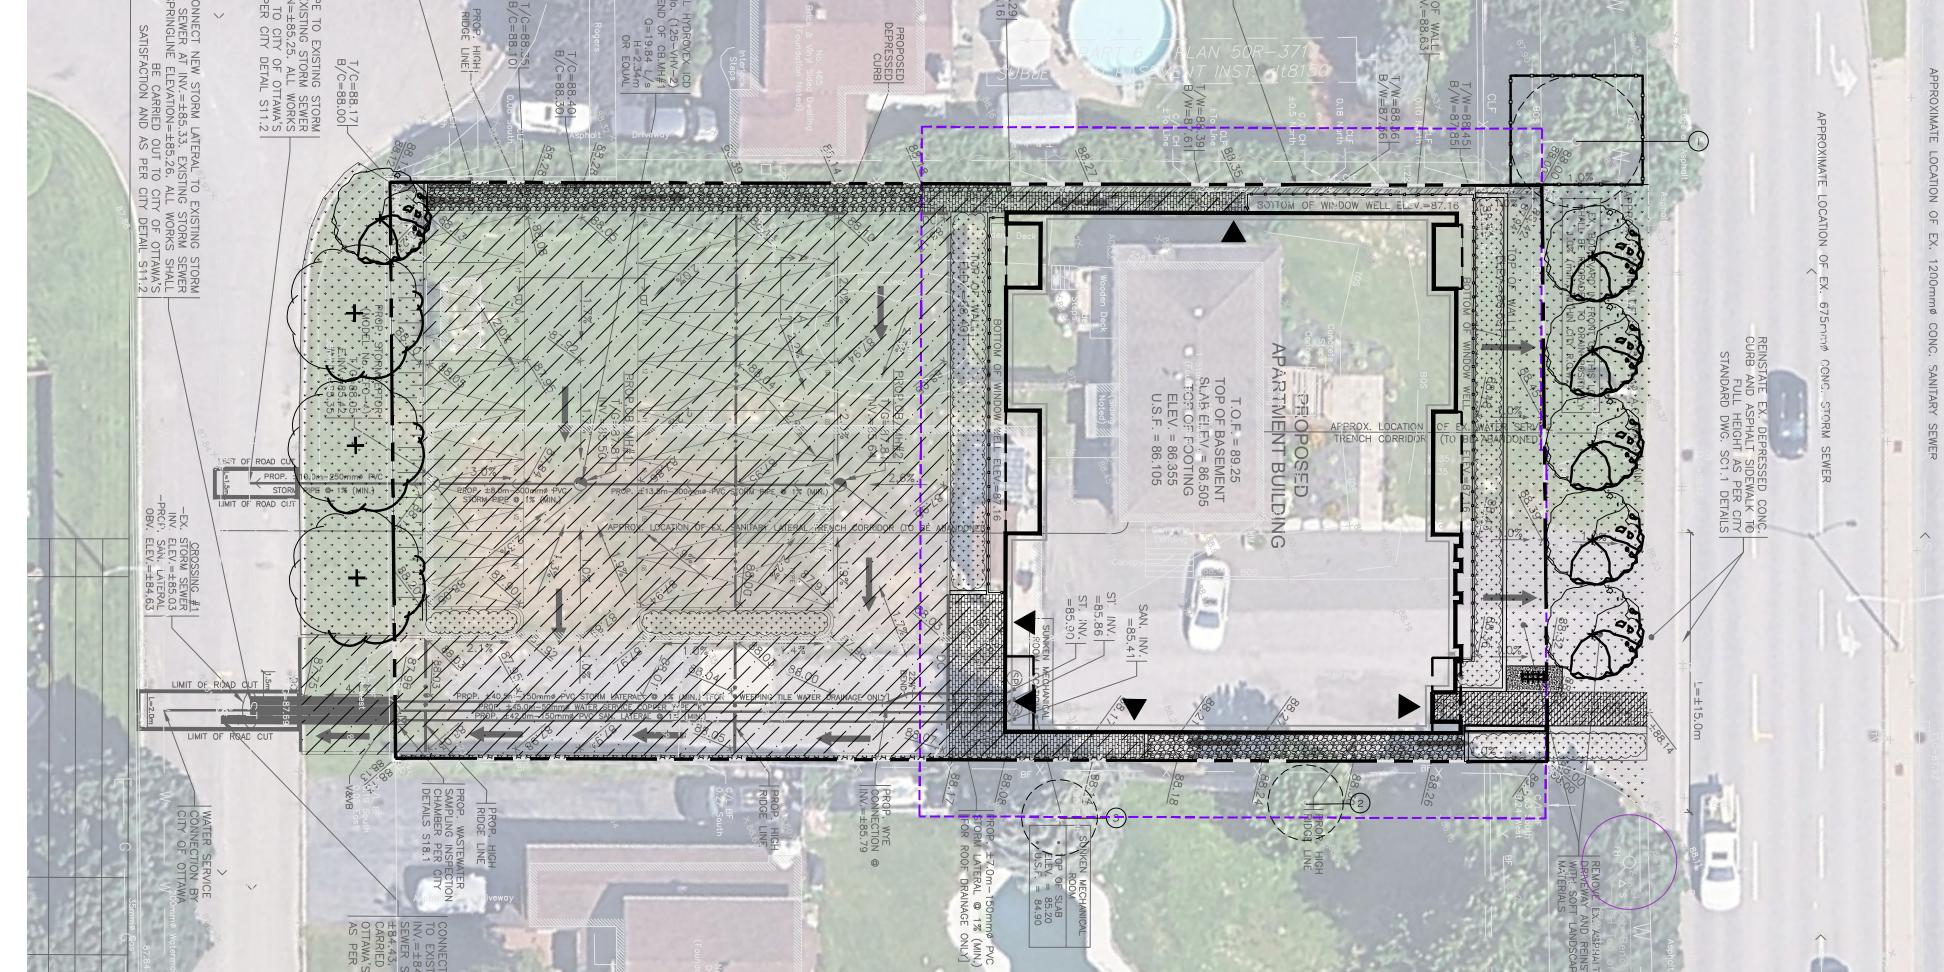

MAP 2 - PROPOSED DEVELOPMENT

TREE CONSERVATION REPORT:

TREE NO.	BOTANICAL NAME	COMMON NAME	DBH (cm)	OWNERSHIP	CONDITION	COMMENTS	ARBORIST RECOMMENDATION	REMOVAL REASON
1	ACER PLATANOIDES	NORWAY MAPLE	40	MUNICIPAL	GOOD	SYMMETRICAL CANOPY, 10% DIE BACK AT CANOPY, SINGLE STEM	RETAIN	
2	ACER NEGUNDO	MANITOBA MAPLE	30	PRIVATE	GOOD	SYMMETRICAL CANOPY, SINGLE STEM WITH 2 CO-DOMINANT LEADERS @0.3M HEIGHT	RETAIN	
3	PICEA PUNGENS	COLORADO SPRUCE	45	PRIVATE	GOOD	SYMMETRICAL CANOPY, PRUNED AT LOWER LIMBS, SINGLE STEM	RETAIN	



UNIT 10-163 STERLING ROAD
TORONTO, ON, CANADA, M6R 2B2
PH: 437 . 700 . 5446
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PH: 613 .867 .3042 / 613 .897 .1237

2	ISSUED FOR SITE PLAN CONTROL	29, OCT., 20
1	ISSUED FOR SITE PLAN CONTROL	08, AUG., 20
NO.:	REVISION:	DATE:
SCALE	SUREMENTS ARE IN MILLIMETERS UNLESS SPECIFIED O' THE DRAWING(S). ALL DRAWINGS TO BE READ IN (CT SPECIFICATIONS.	

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• VERIFY ALL DIMENSIONS AND CONDITIONS ON SITE;

• REPORT ALL ERRORS AND/OR OMISSIONS TO THE CONTRACT ADMINISTRATOR;

• COMPLY WITH ALL PERTINENT CODES, BY-LAWS AND LAWS;

• VERIFY LOCATION OF ALL UNDERGROUND SERVICES AND UTILITIES WITH RESPECTIVE AUTHORITIES PRIOR TO COMMENCEMENT OF WORK.

||1670 TENTH LINE RD| PART OF LOT B

1670 TENTH LINE RD OTTAWA, ON

DRAWN:	SS	START DATE:
CHECKED:	SM	15 JULY, 2025

MAPS

SCALE: 1:150 PAGE SIZE: 24X36 PROJECT NUMBER:

Scale: 1:200

LEGEND:

SITE BOUNDARY

┌── → 4.5m SETBACK FOR SMALL & MEDIUM TREE, PER GEOTECHNICAL REPORT

PERMEABLE SURFACING
(SOIL VOLUME AREAS WITH OUTLINE)

BUILDING/STRUCTURE

BUILDING OVERHANG

TREE CONSERVATION REPORT NUM.

CRITICAL ROOT ZONE (CRZ)

EXISTING DECIDUOUS TREE

EXISTING CONIFEROUS TREE

MEDIUM DECIDUOUS TREE WITH 40YR

LARGE DECIDUOUS TREE WITH 40YR

TREE TO BE REMOVED

CANOPY OFFSET

CANOPY OFFSET

SHRUB PLANTING

EXISTING FIRE HYDRANT

EXISTING CATCH BASIN

EXISTING LIGHT POST

EXISTING SEWER

EXISTING GAS

EXISTING TELEPHONE BOX

EXISTING STORM WATER

EXISTING OVERHEAD WIRE


EXISTING WATERMAIN

IMPERVIOUS SURFACES


EXISTING MANHOLE

TREE PROTECTION

BIKE RACK ON CONCRETE PAD (G/L2.0 \$

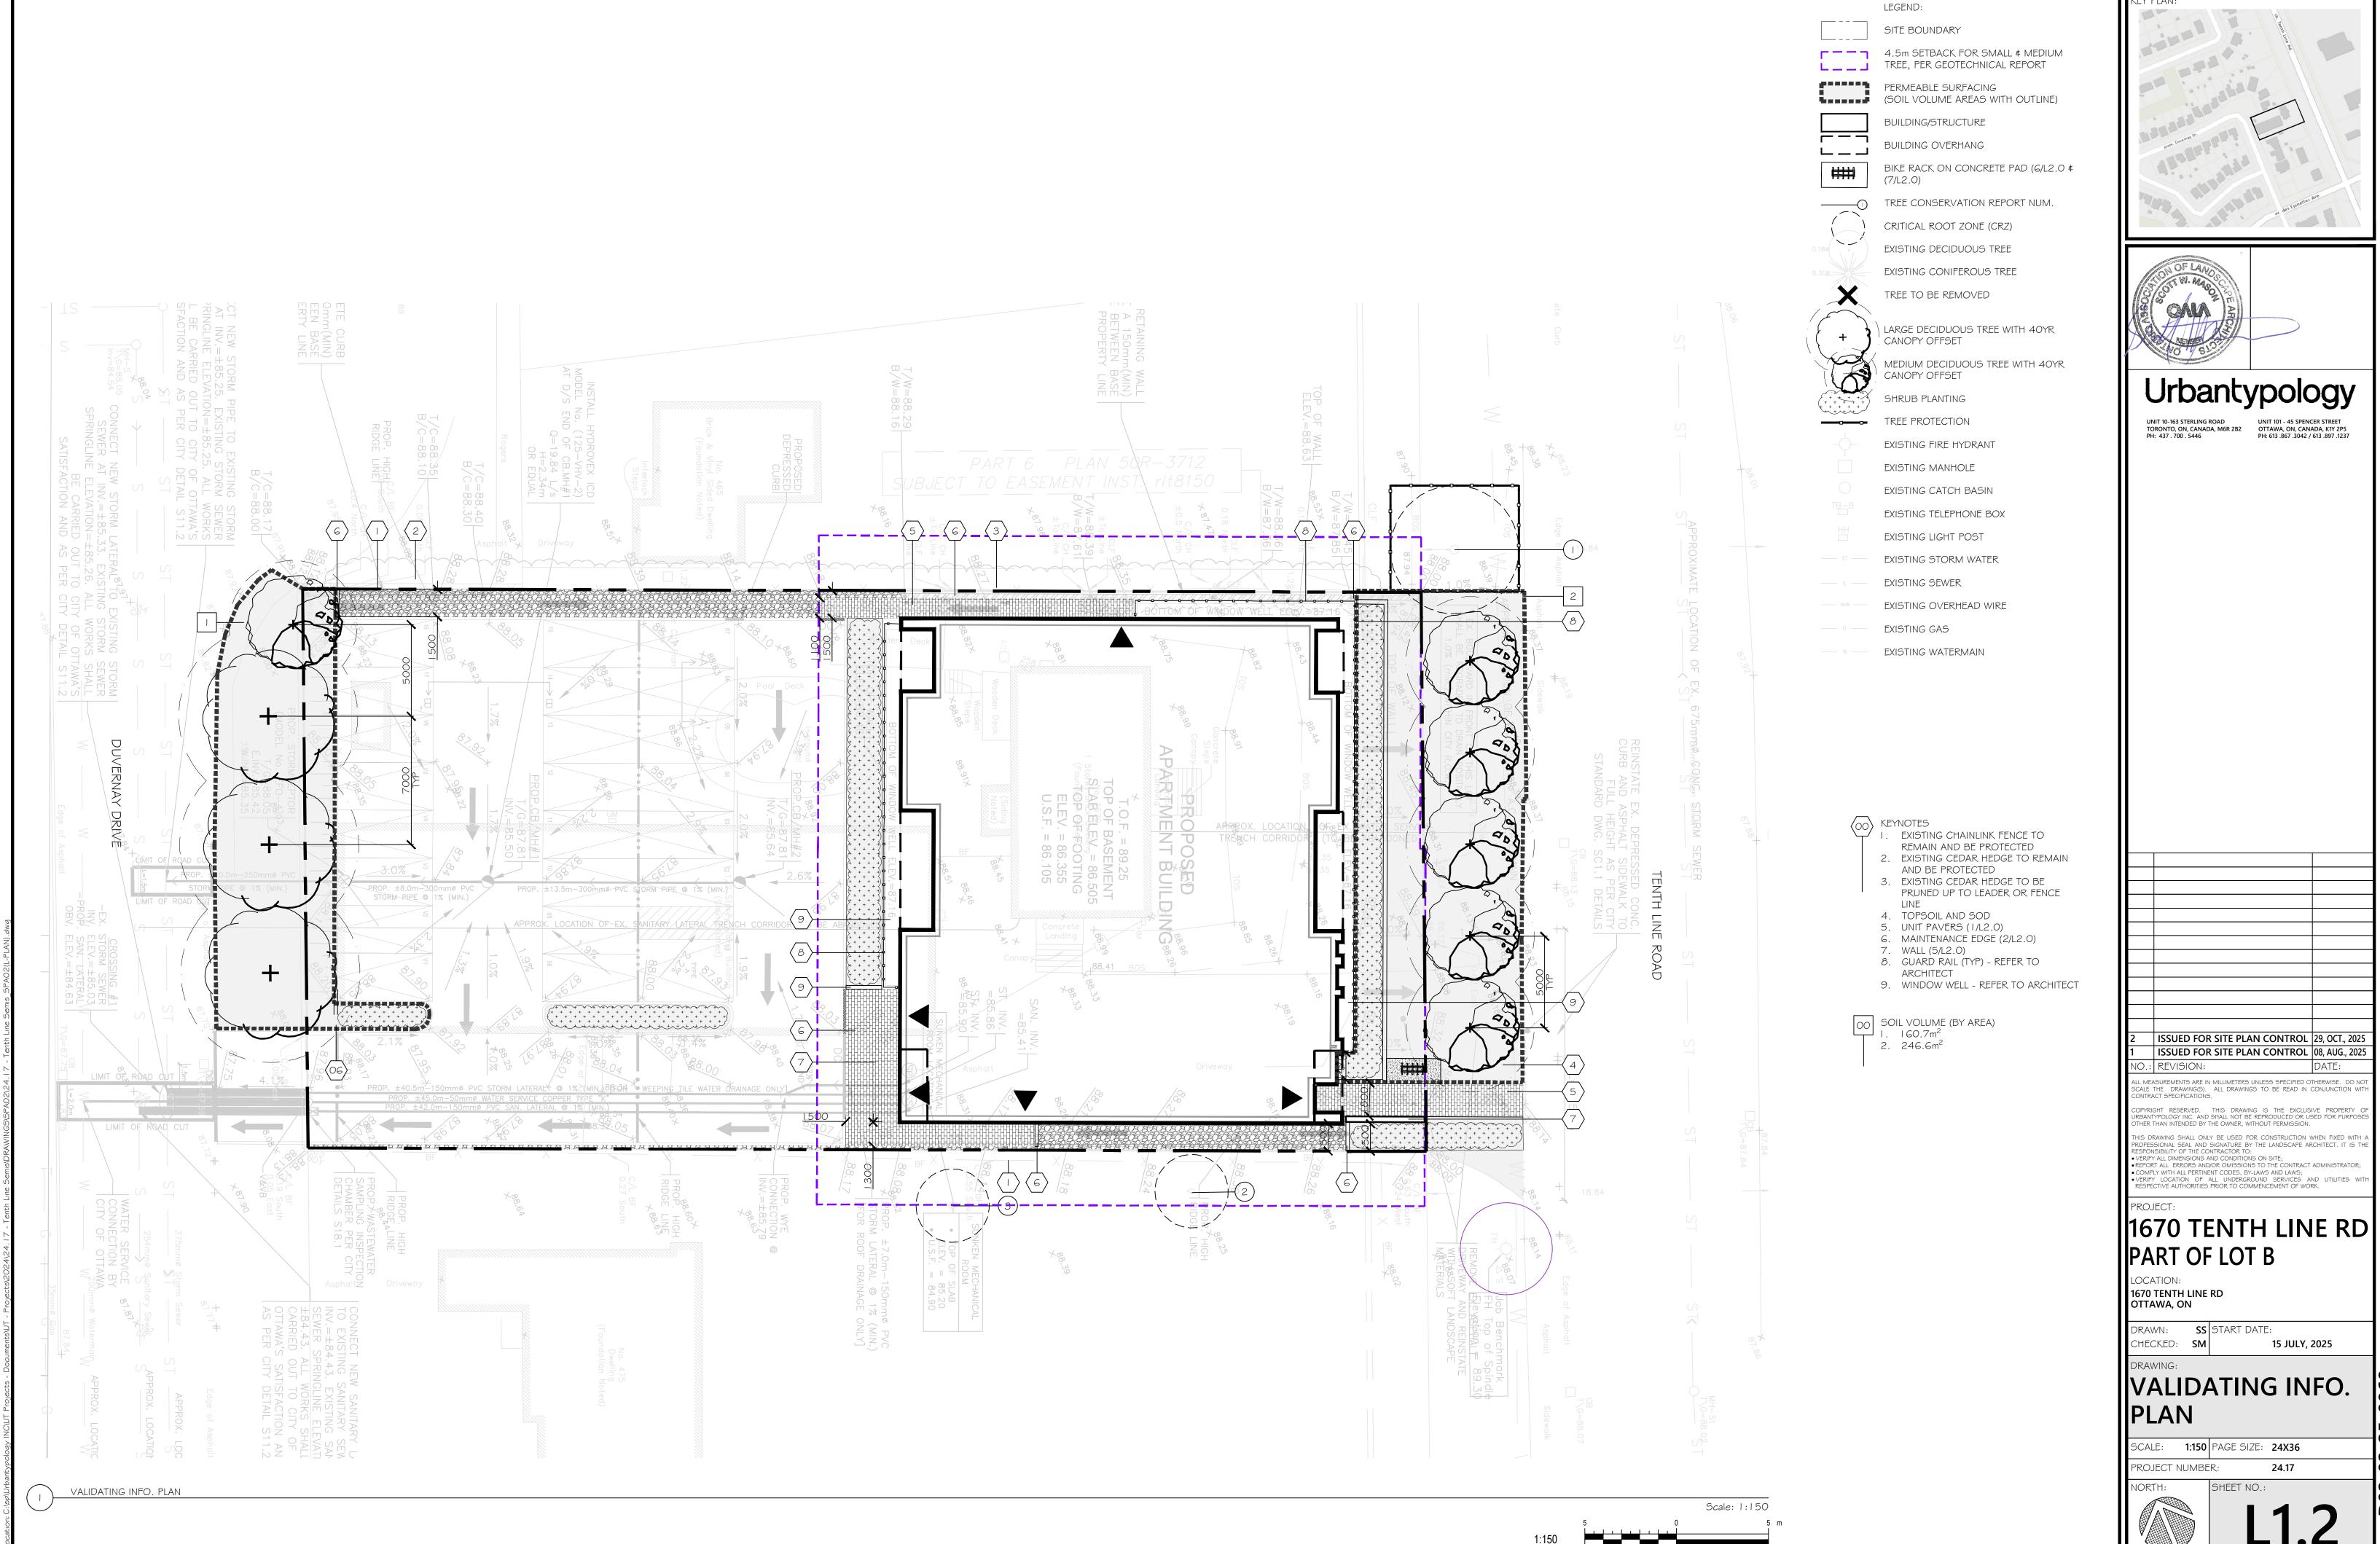



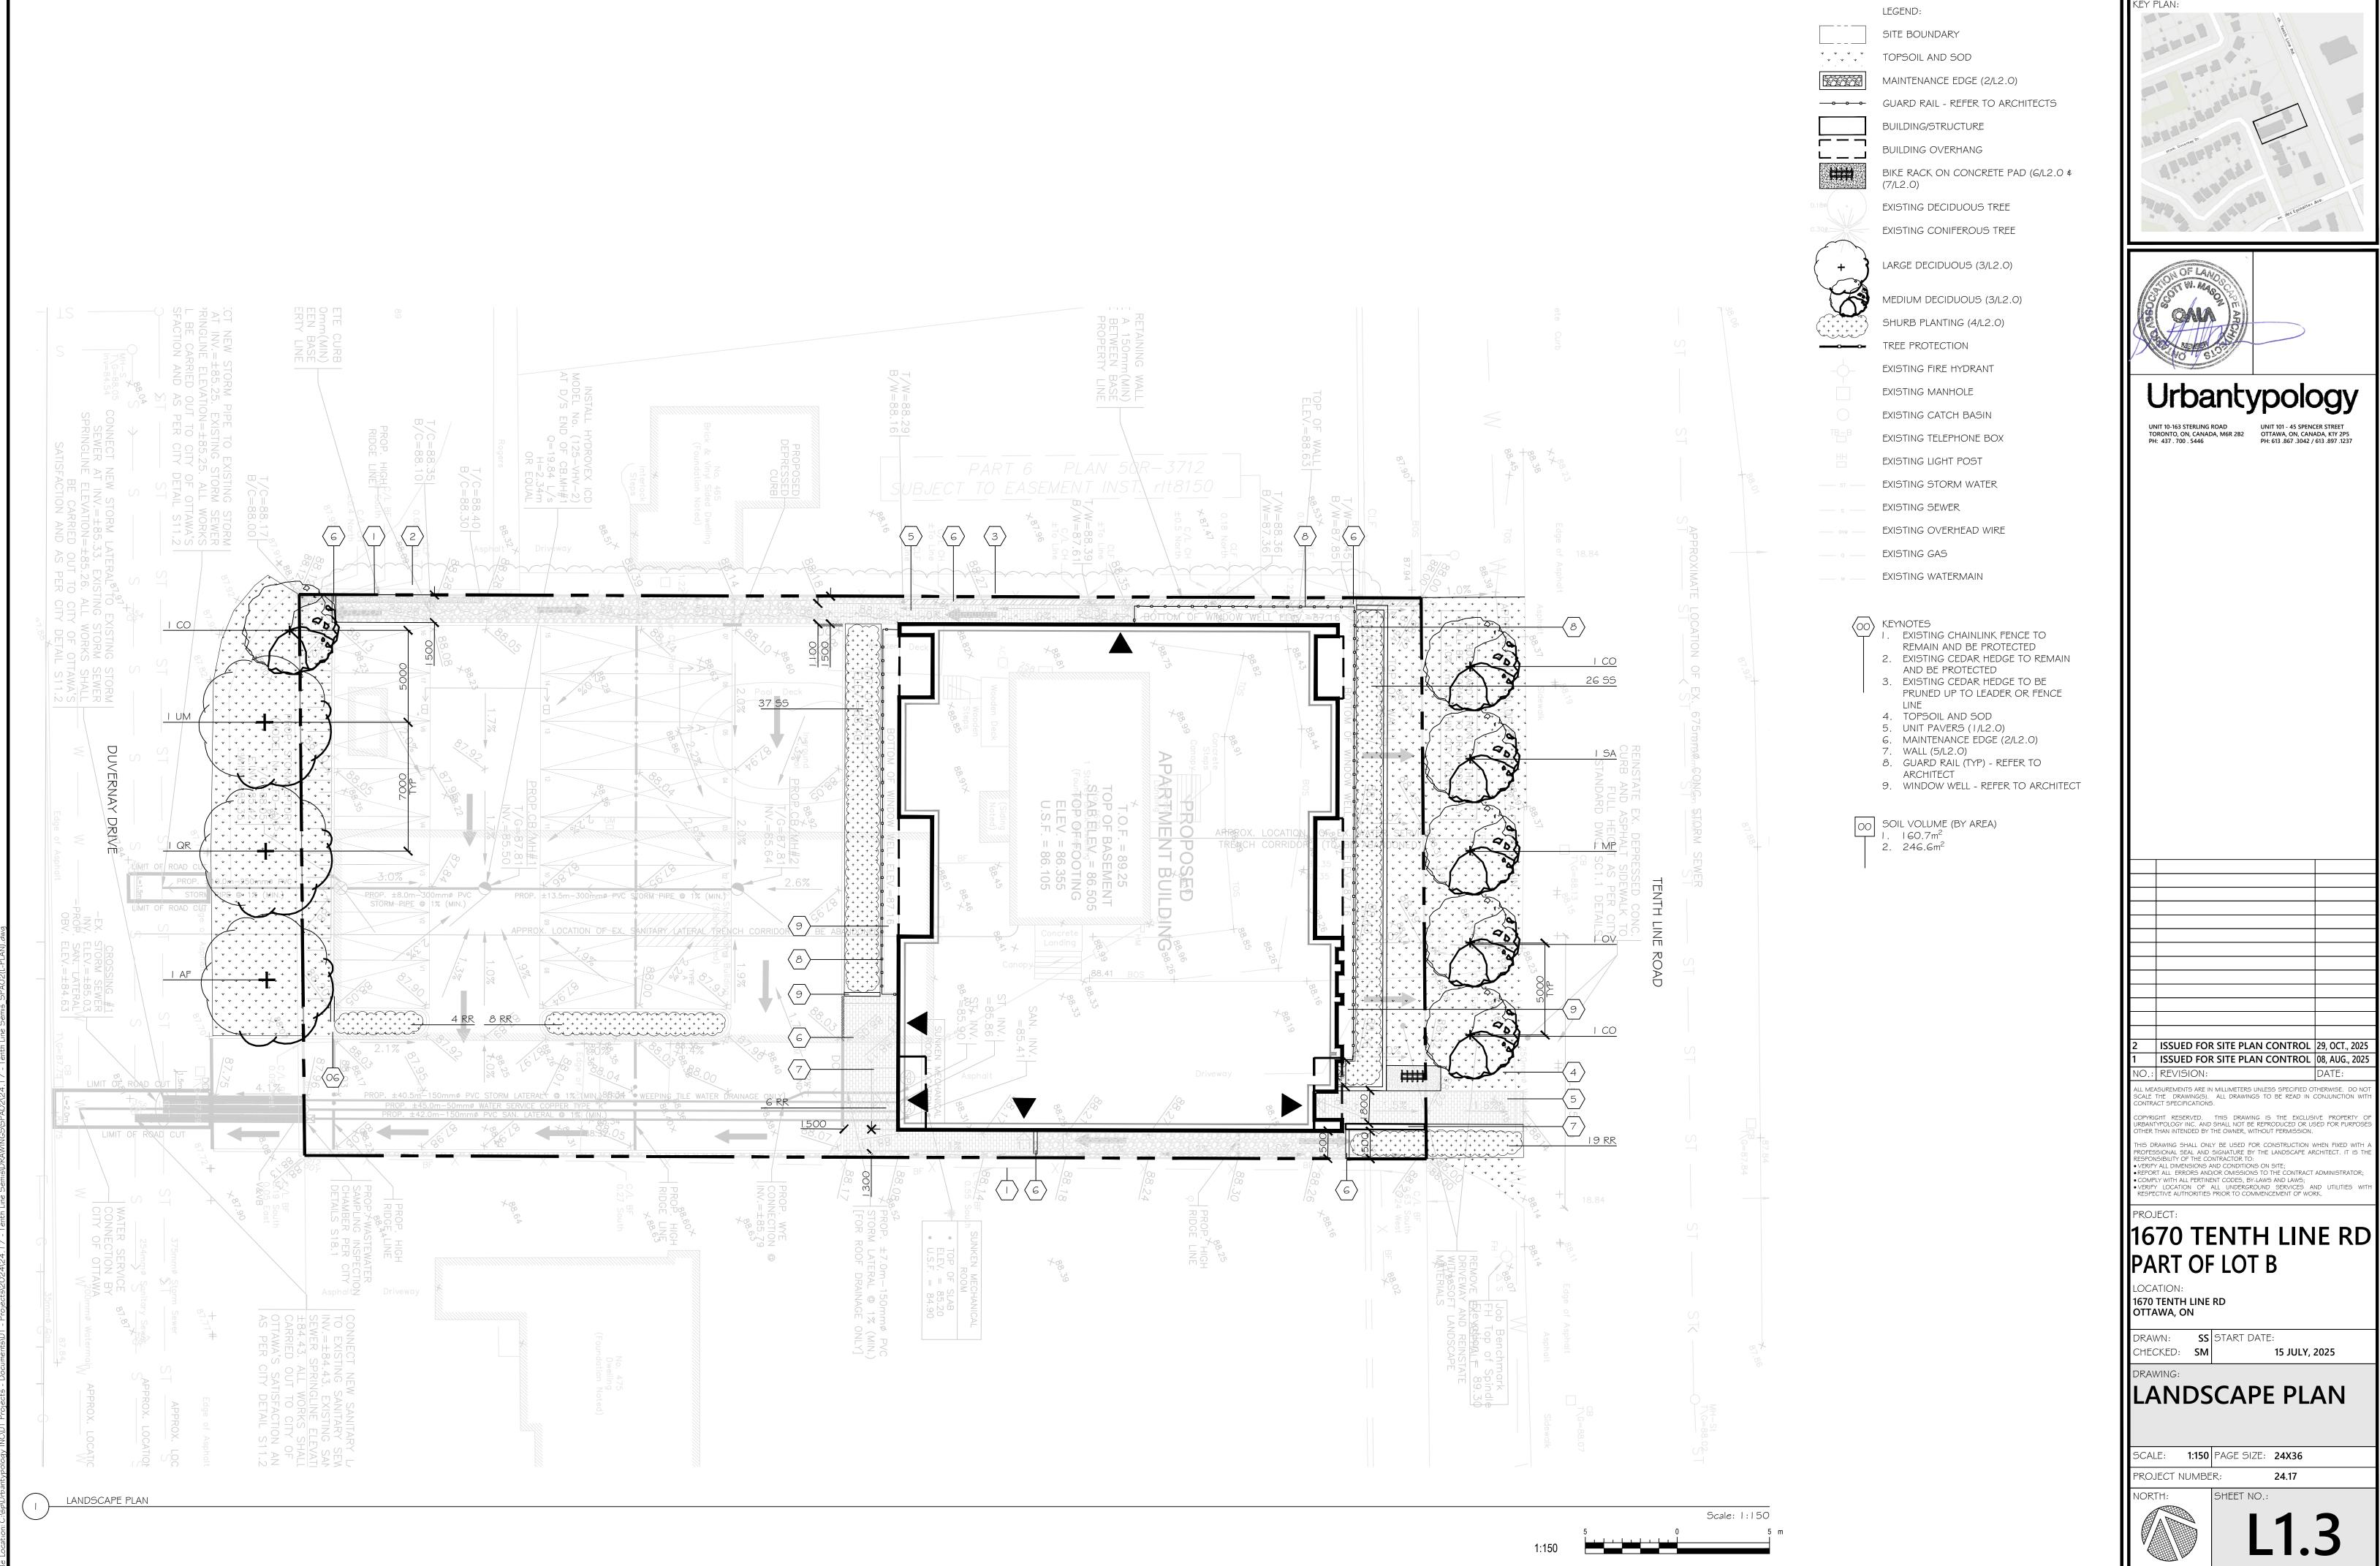



ISSUED FOR SITE PLAN CONTROL 29, OCT., 2025 ISSUED FOR SITE PLAN CONTROL 08, AUG., 2025

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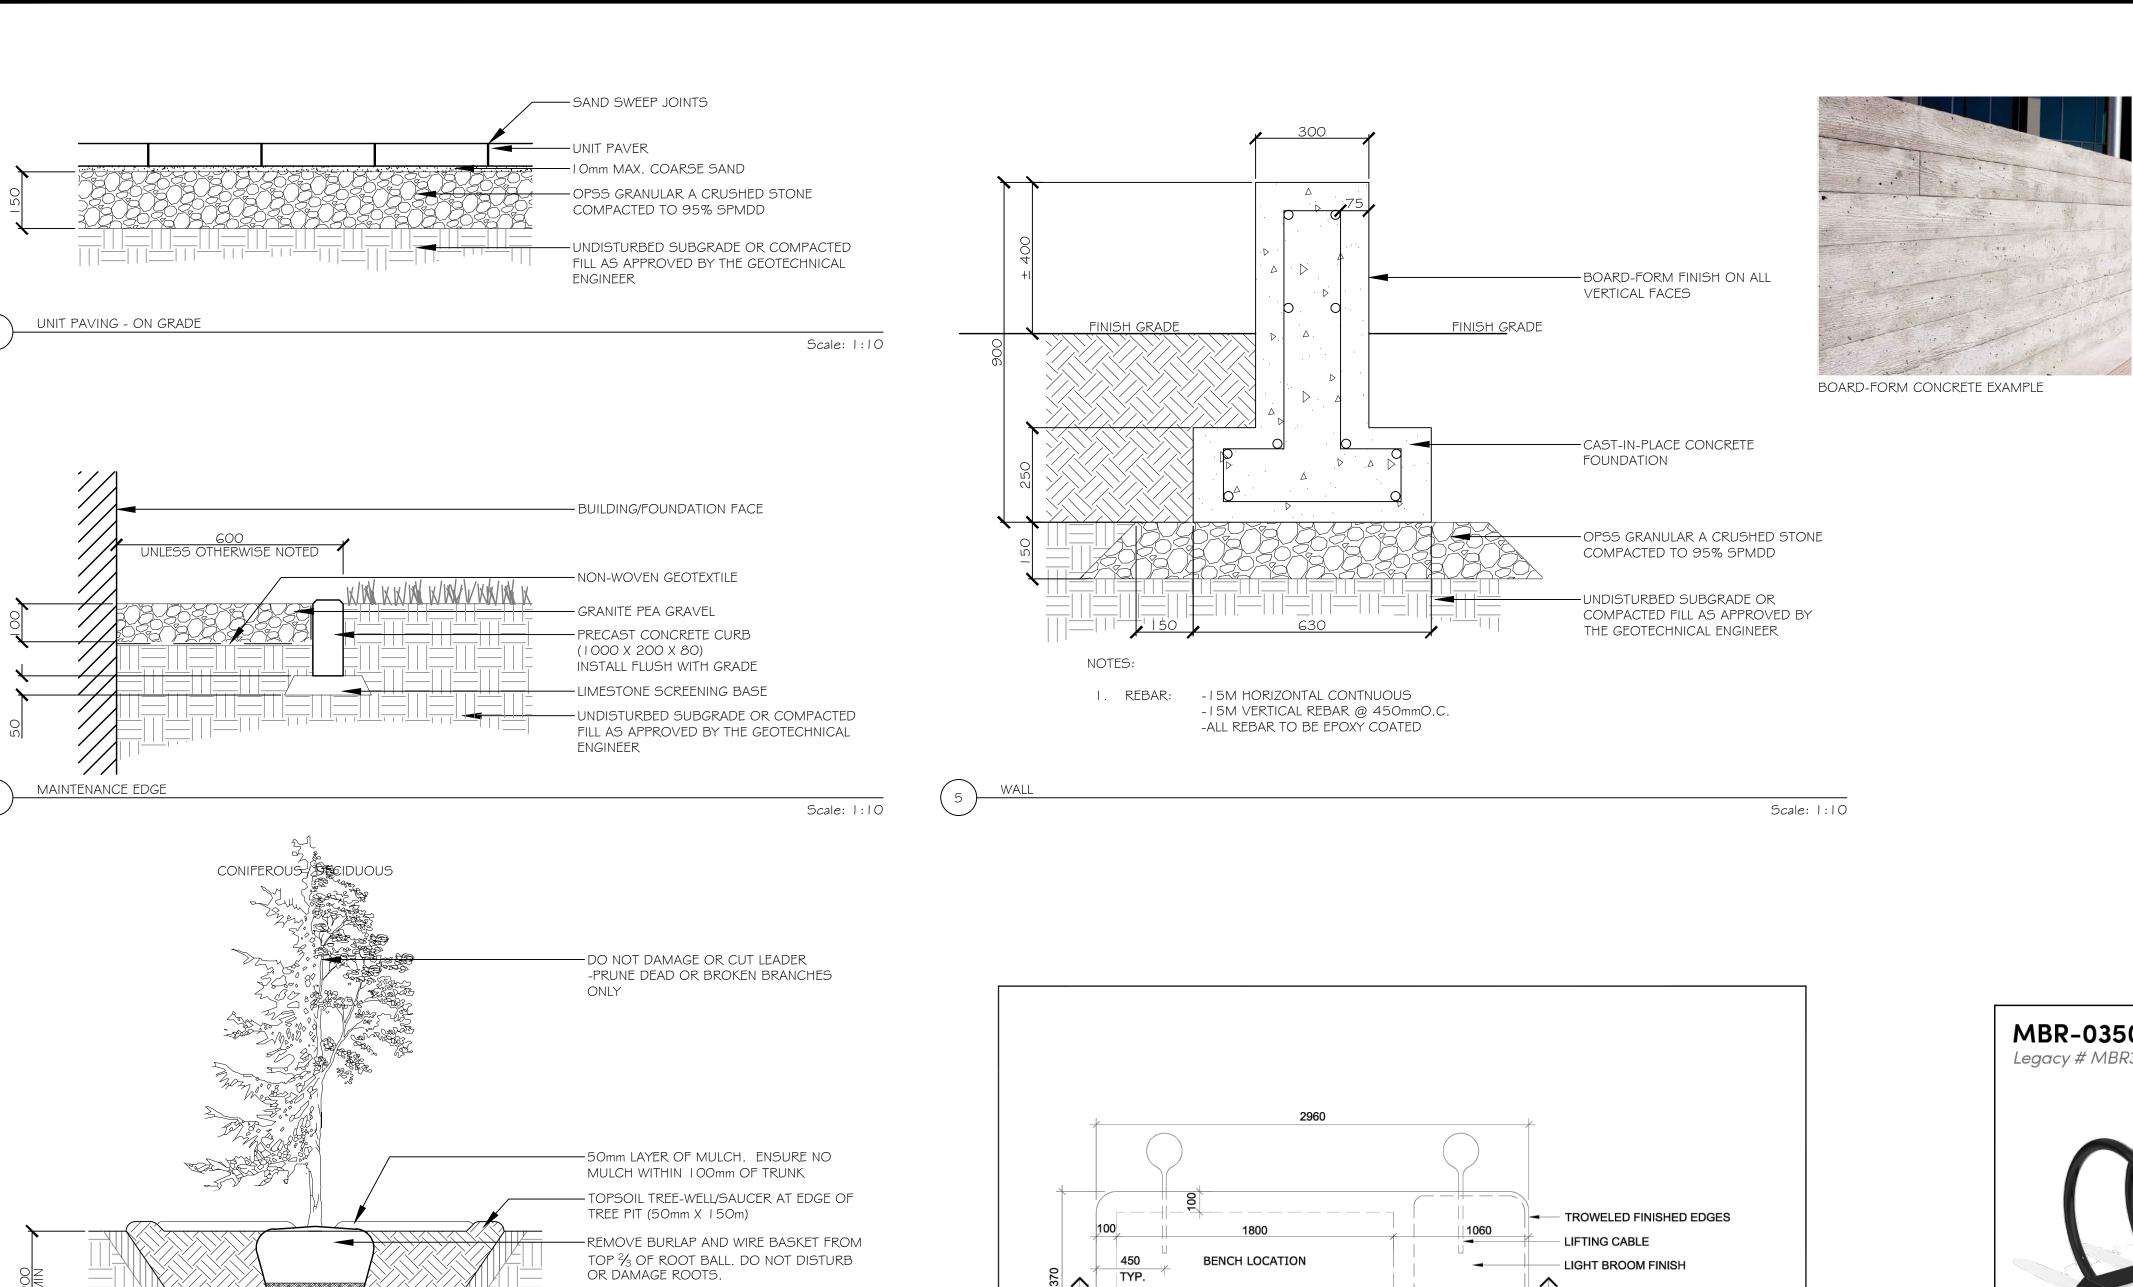
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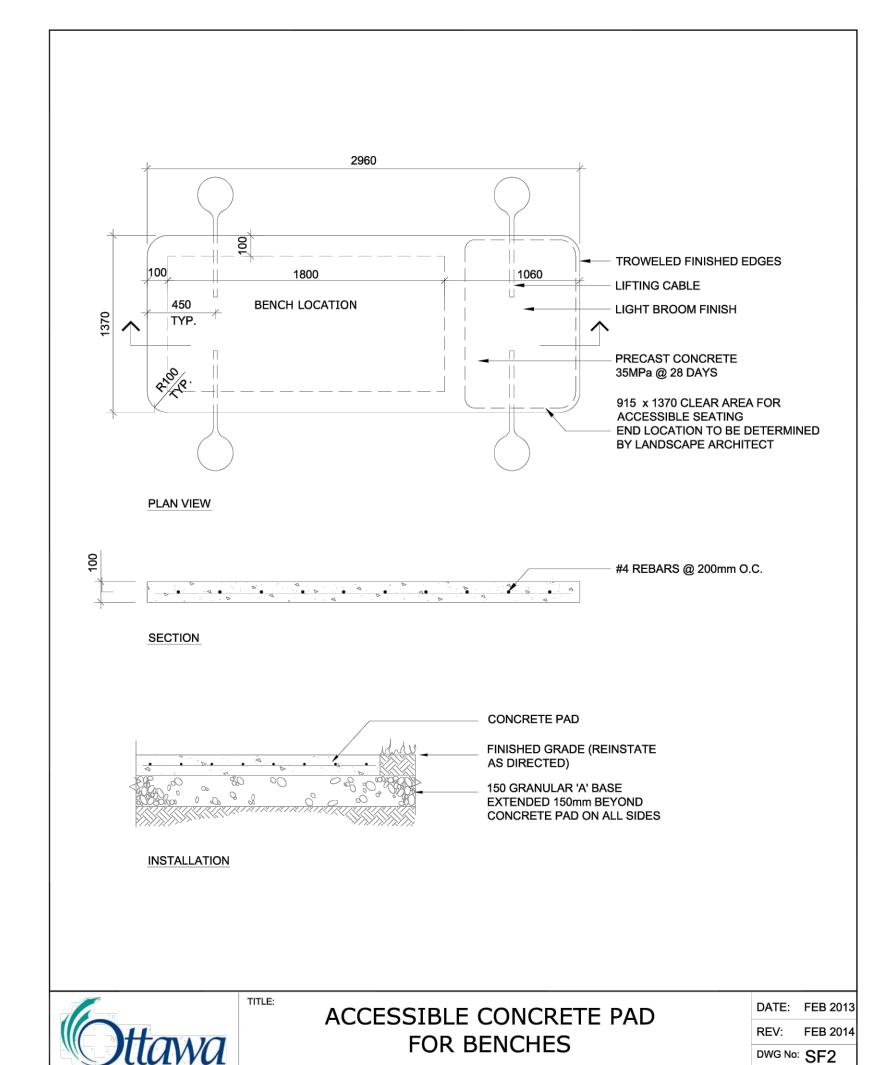
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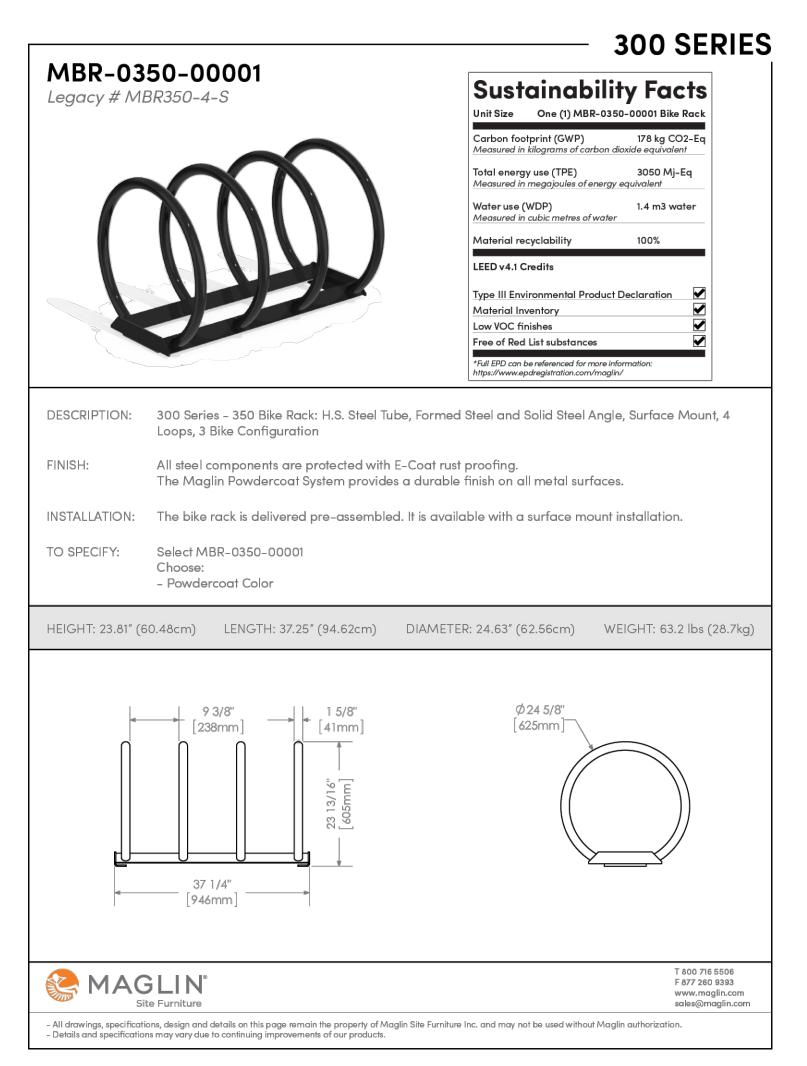
• COMPLY WITH ALL PERTINENT CODES, BY-LAWS AND LAWS;

• VERIFY LOCATION OF ALL UNDERGROUND SERVICES AND UTILITIES WITH RESPECTIVE AUTHORITIES PRIOR TO COMMENCEMENT OF WORK.

LANDSCAPE PLAN











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DRAWING:

NTS

1670 TENTH LINE RD PART OF LOT B

LOCATION: 1670 TENTH LINE RD OTTAWA, ON

DRAWN: SS START DATE: CHECKED: SM 16 JUNE, 2025

NOTES AND SCHEDULES

BCALE: AS NOTED PAGE SIZE: 24X36 PROJECT NUMBER: 24.17 NORTH:

SHRUB PLANTING Scale: 1:30

TOP OF ROOT BALL TO RETAIN SAME ELEVATION AS GROWING CONDITIONS

TOP OF ROOT BALL TO RETAIN SAME ELEVATION AS GROWING CONDITIONS

TREE PLANTING

- COMPACTED TOPSOIL MIX

-UNDISTURBED SUBGRADE

DEEP SCARIFY SUBGRADE MINIMUM

- PRUNE DEAD OR BROKEN BRANCHES

-50mm LAYER OF MULCH. ENSURE NO

MULCH WITHIN 50mm OF STEMS

BED (50mm X 150m)

- TOPSOIL SAUCER AT EDGE OF PLANTING

- SPREAD ROOTS AS REQUIRED TO UNSURE

NO ROOTS ARE GIRDLING THE STEMS

- DEEP SCARIFY SUBGRADE MINIMUM

300mm TO ENSURE PERMEABLITY

-UNDISTURBED SUBGRADE

Scale: 1:30

300mm TO ENSURE PERMEABLITY

CONCRETE PAD

NTS