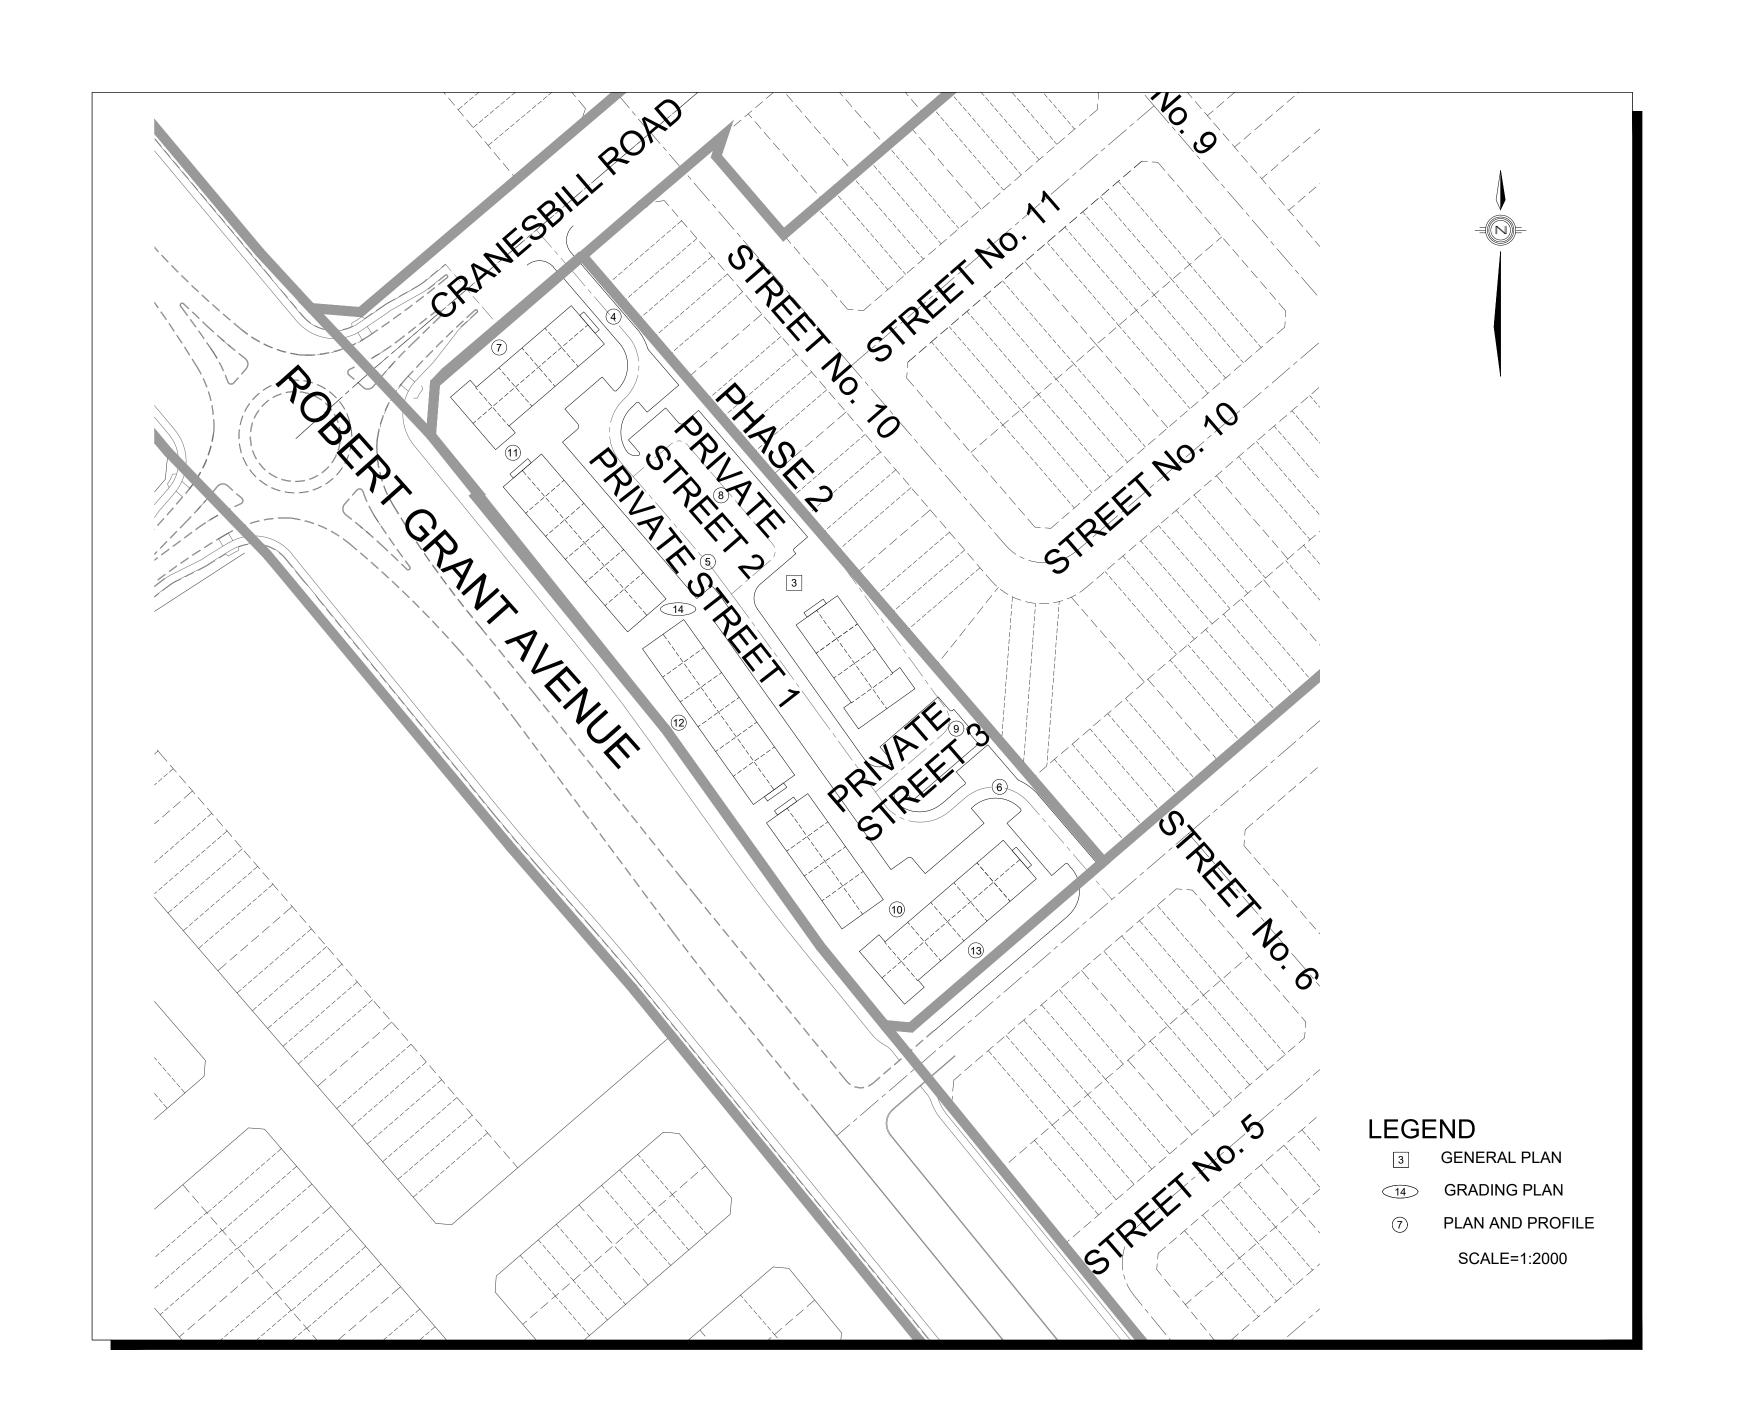
ABBOTT'S RUN BLOCK 13 SITE PLAN

			Sheet List Table	
No.	REVISION No.	REVISION DATE	DRAWINGS	DESCRIPTION
0	01	2025-06-20	TITLE PAGE	
1	01	2025-06-20	GENERAL NOTES	
2	01	2025-06-20	DETAILS AND TABLE	
3	01	2025-06-20	GENERAL PLAN	
4	01	2025-06-20	Private Street 1	STA. 0+-10.000 TO STA. 0+75.21
5	01	2025-06-20	Private Street 1	STA. 0+75.216 TO STA. 0+189.408
6	01	2025-06-20	Private Street 1	STA. 0+189.408 TO STA. 0+275.85
7	01	2025-06-20	Servicing Block 2	STA. 0+-10.000 TO STA. 0+84.53
8	01	2025-06-20	Private Street 2	STA. 0+-10.000 TO STA. 0+81.17
9	01	2025-06-20	Private Street 3	STA. 0+-10.000 TO STA. 0+89.27
10	01	2025-06-20	Servicing Block 3	STA. 0+-10.000 TO STA. 0+54.83
11	01	2025-06-20	Servicing Block 1	STA. 0+-10.000 TO STA. 0+78.73
12	01	2025-06-20	Servicing Block 1	STA. 0+78.739 TO STA. 0+218.75
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14	01	2025-06-20	GRADING PLAN	
15	01	2025-06-20	SANITARY DRAINAGE PLAN	
16	01	2025-06-20	STORM DRAINAGE PLAN	
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CITY OF OTTAWA

MINTO GROUP

GENERAL NOTES:

- 1. ALL WORKS AND MATERIALS SHALL CONFORM TO THE LATEST REVISIONS OF THE STANDARDS AND SPECIFICATIONS OF THE CITY OF OTTAWA, AND ONTARIO PROVINCIAL STANDARD DRAWINGS (OPSD) AND SPECIFICATIONS (OPSS), AS AMENDED BY THE CITY OF OTTAWA.
- 2. THE CONTRACTOR SHALL CONFIRM THE LOCATION OF ALL EXISTING UTILITIES WITHIN THE SITE AND ADJACENT WORK AREAS. THE CONTRACTOR SHALL BE RESPONSIBLE FOR PROTECTING ALL EXISTING UTILITIES TO THE SATISFACTION OF THE AUTHORITY HAVING JURISDICTION. THE CONTRACTOR SHALL BE RESPONSIBLE FOR REPAIR OR REPLACEMENT OF ANY SERVICES OR UTILITIES DISTURBED DURING CONSTRUCTION, TO THE SATISFACTION OF THE AUTHORITY HAVING
- 3. ALL DIMENSIONS SHALL BE CHECKED AND VERIFIED IN THE FIELD BY THE CONTRACTOR PRIOR TO THE START OF CONSTRUCTION. ANY DISCREPANCIES SHALL BE REPORTED IMMEDIATELY TO THE
- 4. ANY AREAS BEYOND THE LIMIT OF THE SITE DISTURBED DURING CONSTRUCTION SHALL BE RESTORED TO ORIGINAL CONDITION OR BETTER TO THE SATISFACTION OF THE AUTHORITY HAVING JURISDICTION AT THE CONTRACTOR'S EXPENSE.
- 5. RELOCATION OF EXISTING SERVICES AND/OR UTILITIES SHALL BE AS SHOWN ON THE DRAWINGS OR AS DIRECTED BY THE ENGINEER AT THE EXPENSE OF THE DEVELOPER.
- 6. ALL WORK SHALL BE COMPLETED IN ACCORDANCE WITH THE "OCCUPATIONAL HEALTH AND SAFETY ACT AND REGULATIONS FOR CONSTRUCTION PROJECTS". THE GENERAL CONTRACTOR SHALL BE DEEMED TO BE THE CONSTRUCTOR AS DEFINED IN THE ACT.
- 7. ALL CONSTRUCTION SIGNING MUST CONFORM TO THE M.T.O. MANUAL OF UNIFORM TRAFFIC CONTROL DEVICES (LATEST AMENDMENT).
- 8. ALL DIMENSIONS ARE IN METERS UNLESS OTHERWISE SPECIFIED.
- 9. THE SUPPORT OF ALL UTILITIES SHALL BE IN ACCORDANCE WITH THE REQUIREMENTS OF THE AUTHORITY HAVING JURISDICTION.
- 10. THERE WILL BE NO SUBSTITUTION OF MATERIALS UNLESS PRIOR WRITTEN APPROVAL BY THE DIRECTOR OF ENGINEERING HAS BEEN OBTAINED.
- 11. ALL SEWERS CONSTRUCTED WITH GRADES 0.50% OR LESS, SHALL BE INSTALLED WITH LASER AND CHECKED WITH LEVEL INSTRUMENT PRIOR TO BACKFILLING.
- 12. THE CONTRACTOR WILL BE RESPONSIBLE FOR ADDITIONAL BEDDING OR ADDITIONAL STRENGTH
- PIPE IF THE MAXIMUM TRENCH WIDTH, AS SPECIFIED BY OPSD, IS EXCEEDED.
- 13. ALL PIPE / CULVERT / SECTION SIZES REFER TO INSIDE DIMENSIONS. 14. SHOULD DEEPLY BURIED ARCHAEOLOGICAL REMAINS BE FOUND ON THE PROPERTY DURING
- CULTURE MUST BE NOTIFIED IMMEDIATELY. 15. STREET LIGHTING TO CITY OF OTTAWA STANDARDS.
- 16. ALL NECESSARY CLEARING AND GRUBBING SHALL BE COMPLETED BY THE CONTRACTOR. REVIEW WITH CONTRACT ADMINISTRATOR AND THE CITY OF OTTAWA PRIOR TO ANY TREE CUTTING.

CONSTRUCTION ACTIVITIES, THE HERITAGE OPERATIONS UNIT OF THE ONTARIO MINISTRY OF

- 17. CONTRACTOR SHALL PERFORM LEAKAGE TESTING, IN THE PRESENCE OF THE CONSULTANT, FOR SANITARY SEWERS IN ACCORDANCE WITH OPSS 410 AND OPSS 407. CONTRACTOR SHALL PERFORM VIDEO INSPECTION OF ALL STORM AND SANITARY SEWERS. A COPY OF THE VIDEO AND INSPECTION REPORT SHALL BE SUBMITTED TO THE CONSULTANT FOR REVIEW.
- 18. THE CLAY SEALS TO BE INSTALLED AS PER CITY STANDARD DRAWING NO. S8. THE SEALS SHOULD BE AT LEAST 1.5m LONG (IN THE TRENCH DIRECTION) AND SHOULD EXTEND FROM TRENCH WALL TO TRENCH WALL. GENERALLY, THE SEALS SHOULD EXTEND FROM THE FROST LINE AND FULLY PENETRATE THE BEDDING, SUBBEDDING AND COVER MATERIAL. THE BARRIERS SHOULD CONSIST OF RELATIVELY DRY AND COMPACTABLE BROWN SILTY CLAY PLACED IN MAXIMUM 225mm THICK LOOSE LAYERS COMPACTED TO A MINIMUM OF 98% OF THE MATERIAL'S SPMDD. THE CLAY SEALS SHOULD BE PLACED AT THE SITE BOUNDARIES AND AT STRATEGIC LOCATIONS AT NO MORE THAN 60m INTERVALS IN THE SERVICE TRENCHES.
- 19. ALL CONSTRUCTION SHALL BE CARRIED OUT IN ACCORDANCE WITH THE RECOMMENDATIONS MADE IN THE GEOTECHNICAL REPORT PG6165-1, REVISION 1, DATED OCTOBER 7, 2022, PREPARED BY
- 20. SLEEVES SHALL BE USED FOR HOUSE CONNECTIONS INSTALLED UNDER GARAGES. HOUSE CONNECTIONS UNDER GARAGES ARE ON AN EXCEPTION BASIS ONLY.

STORM NOTES:

- 1. ALL REINFORCED CONCRETE STORM SEWER PIPE SHALL BE IN ACCORDANCE WITH CSA A257.2 (LATEST AMENDMENT). ALL NON-REINFORCED CONCRETE STORM SEWER PIPE SHALL BE IN ACCORDANCE WITH CSA A257.1 (LATEST AMENDMENT). PIPE SHALL BE JOINTED WITH STD. RUBBER GASKETS AS PER CSA A257.3 (LATEST AMENDMENT).
- 2. ALL STORM SEWER TRENCH AND BEDDING SHALL BE IN ACCORDANCE WITH CITY OF OTTAWA STD. S6 AND S7 CLASS 'B' UNLESS OTHERWISE SPECIFIED. BEDDING AND COVER MATERIAL SHALL BE SPECIFIED
- 3. ALL PVC STORM SEWERS ARE TO BE SDR 35 APPROVED PER C.S.A. B182.2 OR LATEST AMENDMENT, UNLESS OTHERWISE SPECIFIED.
- 4. ALL STORM LATERALS SHALL BE PVC SDR 28, WHITE IN COLOR AND MARKED WITH A 50mm x 100mm WOODEN MARKER EXTENDING FROM THE INVERT TO 1.0m ABOVE GRADE PAINTED GREEN. HOUSE CONNECTIONS SHALL BE 2.0 m MIN. BELOW FINISHED GRADE AT STREET LINE WHERE POSSIBLE. SINGLE CONNECTIONS SHALL BE 100mm DIA..
- 5. STORM MANHOLE FRAME AND COVERS SHALL BE AS PER CITY OF OTTAWA STD. S24.1 AND S25.
- 6. SAFETY PLATFORMS SHALL BE IN ACCORDANCE WITH OPSD 404.02.
- 7. DROP STRUCTURES SHALL BE IN ACCORDANCE WITH CITY OF OTTAWA SPECIFICATIONS AND OPSD
- 8. STORM SEWER MANHOLES SERVING LOCAL SEWERS LESS THAN 900mm SHALL BE CONSTRUCTED WITH A 300mm SUMP. FOR STORM SEWERS 900mm AND OVER USE BENCHING IN ACCORDANCE WITH OPSD
- 9. SINGLE AND DOUBLE CATCHBASINS SHALL BE IN ACCORDANCE WITH CITY OF OTTAWA STD. S1. AND OPSD 705.020, RESPECTIVELY. FRAMES AND GRATE SHALL BE AS PER CITY OF OTTAWA STD. S19.1 FOR REAR LOT CATCHBASINS AND STREET CATCHBASINS.
- 10. CURB INLET TYPE CATCH BASIN (CICB) SHALL BE IN ACCORDANCE WITH CITY OF OTTAWA STD. S3. FRAME AND GRATE SHALL BE AS PER CITY OF OTTAWA STD. S22 AND S23, UNLESS OTHERWISE
- 11. SINGLE AND DOUBLE CATCHBASIN LEADS SHALL BE 200mm AND 250mm DIA (MIN.), RESPECTIVELY, AT 1.0% SLOPE (MIN.) UNLESS OTHERWISE NOTED. CB LEAD OUT INVERT TO BE SET 1.38m BELOW TOP OF GRATE ELEVATION UNLESS OTHERWISE NOTED.
- 12. ALL STREET CATCHBASINS/CATCHBASIN MANHOLES SHALL HAVE 600mm SUMPS, AND ALL REAR YARD CATCHBASINS (OPSD 705.010) SHALL HAVE 300mm SUMPS UNLESS OTHERWISE NOTED. REAR YARD LANDSCAPE CATCHBASINS TO BE SUMPLESS.
- 13. CONTRACTOR SHALL ENSURE THAT CATCHBASINS ARE INSTALLED AT THE LOW POINT OF SAG CURB WORKS.
- 14. THE STORM SEWER CLASSES HAVE BEEN DESIGNED BASED ON BEDDING CONDITIONS SPECIFIED ABOVE. WHERE THE SPECIFIED TRENCH WIDTH IS EXCEEDED, THE CONTRACTOR SHALL BE REQUIRED TO PROVIDE ADDITIONAL BEDDING, A DIFFERENT TYPE OF BEDDING OR A HIGHER PIPE STRENGTH AT HIS OWN EXPENSE AND SHALL ALSO BE RESPONSIBLE FOR EXTRA TEMPORARY AND/OR PERMANENT REPAIRS MADE NECESSARY BY THE WIDENED TRENCH.
- 15. THE MINIMUM DIAMETER FOR REAR LOT PERFORATED PIPE IS 250mm, REFER TO CITY STD. S29 FOR DETAIL, UNLESS OTHERWISE NOTED.
- 16. FOR TWO OR MORE REAR LOT CATCH BASINS CONNECTED IN SERIES, THE LEAD FROM THE LAST REAR LOT CB TO THE STORM SEWER SHALL BE SOLID PIPE.

SANITARY NOTES:

- ALL SANITARY SEWER INSTALLATION SHALL CONFORM TO THE LATEST REVISIONS OF THE CITY OF OTTAWA AND THE ONTARIO PROVINCIAL STANDARD DRAWINGS (OPSD) AND SPECIFICATIONS (OPSS) AS AMENDED BY THE CITY
- 2. ALL SANITARY SEWERS SHALL BE PVC SDR 35, IPEX "RING-TITE" (OR EQUIVALENT), AS PER CSA STANDARD B182.2 OR LATEST AMENDMENT, UNLESS OTHERWISE NOTED.
- 3. SANITARY SEWER TRENCH AND BEDDING SHALL BE AS PER CITY OF OTTAWA STD. S6 AND S7, CLASS 'B' BEDDING UNLESS OTHERWISE NOTED.BEDDING AND COVER MATERIAL SHALL BE SPECIFIED BY PROJECT GEOTECHNICAL
- 4. ALL SANITARY LATERALS ARE TO BE PVC SDR 28, IPEX "RING-TITE" (OR EQUIVALENT), AND MARKED WITH A 50mm x 100mm WOODEN MARKER, EXTENDING FROM THE INVERT TO 1.0 m ABOVE GRADE PAINTED RED. HOUSE CONNECTIONS SHALL BE 2.75m BELOW FINISHED GRADE AT STREET LINE WHERE POSSIBLE. SINGLE CONNECTIONS
- 5. SANITARY MANHOLE FRAME AND COVERS SHALL BE AS PER CITY OF OTTAWA STD. S24 AND S25.
- 6. SAFETY PLATFORMS SHALL BE AS PER OPSD 404.02.
- 7. DROP STRUCTURES SHALL BE IN ACCORDANCE WITH CITY OF OTTAWA SPECIFICATIONS AND OPSD 1003.01.
- 8. SANITARY SEWER MANHOLES SHALL BE BENCHED AS PER OPSD 701.021.
- 9. SANITARY MANHOLE FRAME AND COVERS SHALL BE AS PER CITY OF OTTAWA STD. S24 AND S25, EXCEPT FOR WHERE IN PONDING AREAS, WHERE WATERTIGHT FRAME AND COVERS SHALL BE EAST JORDAN CAMPRESSION 41420049W01 AS PER CITY OF OTTAWA MS-22.15 (OR APPROVED EQUIVALENT)

- 1. ALL WATERMAIN INSTALLATION SHALL CONFORM TO THE LATEST REVISIONS OF THE CITY OF OTTAWA AND THE ONTARIO PROVINCIAL STANDARD DRAWINGS (OPSD) AND SPECIFICATIONS (OPSS) AS AMENDED BY THE CITY OF
- 2. ALL PVC WATERMAINS SHALL BE EQUAL TO AWWA C-900 CLASS 150, SDR 18.
- 3. WATERMAIN TRENCH AND BEDDING SHALL BE IN ACCORDANCE WITH CITY OF OTTAWA STANDARD W17, UNLESS OTHERWISE SPECIFIED. BEDDING AND COVER MATERIAL SHALL BE SPECIFIED BY PROJECT
- 4. ALL PVC WATERMAINS SHALL BE INSTALLED WITH A 10 GAUGE STRANDED COPPER TWU OR RWU TRACER WIRE IN ACCORDANCE WITH CITY OF OTTAWA STD. W36.
- 5. WATER SERVICES ARE TO BE TYPE K SOFT COPPER OR PEX AS PER CITY OF OTTAWA STD. W26 UNLESS OTHERWISE SPECIFIED. SINGLE SERVICES SHALL BE 19mm DIA.. 50mm DIA. COPPER SHALL BE USED FOR PARK SERVICES. WATER SERVICES SHALL BE MARKED WITH A "50mm x 100mm", EXTENDING FROM THE INVERT TO 1.0m ABOVE GRADE PAINTED BLUE. CURB STOPS SHALL BE INSTALLED AT THE PROPERTY LINE.
- 6. CATHODIC PROTECTION IS REQUIRED ON ALL METALLIC FITTINGS AS PER CITY OF OTTAWA STD. W40 AND W42.
- ENSURE FLANGE IS ABOVE FINISHED GRADE PER CITY STD W19.

CONTRACTOR TO SUPPLY HYDRANT EXTENSION TO ADJUST THE LENGTH OF HYDRANT BARREL AS REQUIRED TO

- 8. FIRE HYDRANTS SHALL BE INSTALLED AS PER CITY OF OTTAWA STD. W19, AND LOCATED AS PER CITY STD. W18.
- 9. VALVE IN BOXES SHALL BE INSTALLED AS PER CITY OF OTTAWA STD. W24.
- 10. 50mm DIAMETER WATERMAINS SHALL BE TYPE 'K' COPPER TUBING. WATERMAIN INSTALLATION IN CUL-DE-SAC TO BE INSTALLED AS PER CITY OF OTTAWA STD.W37
- 11. WATERMAIN IN FILL AREAS TO BE INSTALLED WITH RESTRAINED JOINTS AS PER CITY OF OTTAWA STD. W25.5
- 12. THRUST BLOCKING OF WATERMAIN TO BE INSTALLED AS PER CITY OF OTTAWA STD. W25.3 AND W25.4.
- 13. THE CONTRACTOR SHALL PROVIDE ALL TEMPORARY CAPS, PLUGS AND BLOW-OFFS AND NOZZLES REQUIRED FOR TESTING AND DISINFECTION OF THE WATERMAIN.
- 14. INSULATION FOR WATERMAIN CROSSING OVER AND BELOW SEWER SHOULD BE IN ACCORDANCE WITH CITY OF OTTAWA STD. W25.2 AND W25, RESPECTIVELY, WHERE WATERMAIN COVER IS LESS THAN 2.4m.
- 15. WHERE THE SEPARATION BETWEEN SERVICES AND MANHOLES IS LESS THAN 1.2m, WATER SERVICES ARE TO BE INSULATED AS PER CITY STD. W23.
- 16. AS PER MECP GUIDELINES, THE MINIMUM VERTICAL CLEARANCE BETWEEN WATERMAIN AND SEWER / UTILITY IS 0.50m. FOR CROSSING UNDER SEWER, ADEQUATE STRUCTURAL SUPPORT FOR THE SEWERS IS REQUIRED TO PREVENT EXCESSIVE DEFLECTION OF JOINTS AND SETTLING. THE LENGTH OF WATER PIPE SHALL BE CENTRED AT THE POINT OF CROSSING SO THAT THE JOINTS WILL BE EQUIDISTANT AND AS FAR AS POSSIBLE FROM THE
- 17. FOR FIRE HYDRANT LATERALS WITH DEPTH OF 2.4m OR LESS, THERMAL INSULATION SHALL BE APPLIED AS PER CITY STANDARD DRAWING W23.
- 18. CATCH BASIN LEADS CROSSING ABOVE WATERMAINS SHALL HAVE A MINIMUM CLEARANCE OF 0.50m.
- 19. MINIMUM HORIZONTAL DISTANCE BETWEEN WATERMAINS AND SEWERS IS 2.5M (BARREL TO BARREL)

ROADWORK NOTES:

- 1. ALL TOPSOIL AND ORGANIC MATERIAL SHALL BE STRIPPED WITHIN THE ROAD ALLOWANCE PRIOR TO THE COMMENCEMENT OF CONSTRUCTION.
- 2. CONCRETE CURB SHALL BE IN ACCORDANCE WITH CITY OF OTTAWA STD. SC1.1 (BARRIER CURB) AND SC1.3 (MOUNTABLE CURB). PROVISION SHALL BE MADE FOR CURB DEPRESSIONS AT SIDEWALKS AND
- DRIVEWAYS. 3. ROAD SUBDRAINS SHALL BE REFERENCE TO R1, AS SUGGESTED IN RG4683-2, SUBDRAIN INVERTS TO BE
- APPROXIMATELY 300mm BELOW SUBGRADE LEVEL
- 4. CONCRETE SIDEWALK SHALL BE IN ACCORDANCE WITH CITY OF OTTAWA STD. SC3 AND SC1.4. 5. PAVEMENT REINSTATEMENT FOR SERVICE AND UTILITY CUTS SHALL BE IN ACCORDANCE WITH CITY OF
- OTTAWA STD. R10 AND OPSD 509.010, OPSS 310. 6. GRANULAR "A" SHALL BE PLACED TO A MINIMUM THICKNESS OF 300mm AROUND ALL STRUCTURES WITHIN
- PAVEMENT AREA.
- 7. ALL GRANULAR FOR ROADS SHALL BE COMPACTED TO A MINIMUM OF 98% STANDARD PROCTOR DENSITY.
- 8. ASPHALT WEAR COURSE SHALL NOT BE PLACED UNTIL THE VIDEO INSPECTION OF SEWERS & NECESSARY REPAIRS HAVE BEEN CARRIED OUT TO THE SATISFACTION OF THE CONSULTANT.
- 9. SUB-EXCAVATE SOFT AREAS AND FILL WITH GRANULAR 'B' COMPACTED IN MAXIMUM 300
- mm LIFTS.
- 10. PEDESTRIAN CURB RAMP WITH BOULEVARD SHALL BE IN ACCORDANCE WITH CITY OF OTTAWA STD. SC7. 11. PAVEMENT DESIGN TYPE
- ACCESS LANES & HEAVY DUTY TRUCK PARKING
- 40mm SUPERPAVE 12.5 ASPHALTIC CONCRETE - 50mm SUPERPAVE 19.0 ASPHALTIC CONCRETE
- 150mm OPSS GRANULAR A CRUSHED STONE
- 450mm OPSS GRANULAR B TYPE II SUBGRADE

DRIVEWAYS AND PARKING AREAS

- 50mm HL-3 OR SUPERPAVE 12.5 ASPHALTIC CONCRETE
- 150mm OPSS GRANULAR A CRUSHED STONE
- 300mm GRANULAR B TYPE II SUBGRADE

GRADING NOTES:

- 1. A FLAT AREA HAVING A WIDTH OF 0.6m SHALL BE PROVIDED AT THE BOUNDARY LIMITS ADJACENT DEVELOPED PROPERTIES IN ORDER THAT THE EXISTING BOUNDARY ELEVATIONS SHALL BE MAINTAINED.
- 2. ALL ROOF DOWNSPOUTS SHALL DISCHARGE TO THE GROUND ONTO SPLASH PADS AND SHALL NOT BE CONNECTED TO THE STORM SEWER, OR THE BUILDING FOUNDATION DRAIN.
- ALL WORK SHALL BE COMPLETED IN ACCORDANCE WITH THE "OCCUPATIONAL HEALTH AND SAFETY ACT AND REGULATIONS FOR CONSTRUCTION PROJECTS." THE GENERAL CONTRACTOR SHALL BE DESIGNATED AS THE CONSTRUCTOR AS DEFINED IN THE ACT.
- 4. PRIOR TO THE COMMENCEMENT OF THE SITE GRADING WORKS, ALL SILTATION CONTROL DEVICES SHALL BE INSTALLED AND OPERATIONAL. THE CONTRACTOR SHALL MAINTAIN ALL WORKS UNTIL SERVICING CONSTRUCTION IS COMPLETED TO THE SATISFACTION OF THE ENGINEER AND THE CITY OF OTTAWA.
- ALL SWALES SHALL BE 0.15m DEEP WITH 3:1 SIDE SLOPES UNLESS OTHERWISE INDICATED. THE MINIMUM LONGITUDINAL SLOPE IS 1% AND 1.5% WITH INSTALLATION OF SUBDRAIN OR WITHOUT, RESPECTIVELY.
- 6. TOP OF GRATE (T/G) ELEVATIONS FOR ALL STREET CATCHBASINS SHOWN ON PLANS, REFER TO THE ELEVATIONS AT GUTTER OR EDGE OF PAVEMENT, WHERE APPLICABLE.

EROSION AND SEDIMENT CONTROL NOTES:

- 1. PRIOR TO TOPSOIL STRIPPING, EARTHWORKS, OR UNDERGROUND CONSTRUCTION, EROSION AND SEDIMENT CONTROLS SHALL BE IMPLEMENTED TO THE SATISFACTION OF THE AUTHORITY HAVING JURISDICTION.
- 2. SEDIMENT CONTROL FENCE SHALL BE CLEANED AND MAINTAINED IN GOOD REPAIR BY CONTRACTOR.
- 3. SEDIMENT CONTROL FENCE TO REMAIN IN PLACE UNTIL THE WORKING AREA HAS BEEN STABILIZED AND
- 4. ACCUMULATED SEDIMENT TO BE REMOVED OFF SITE PRIOR TO THE REMOVAL OF SEDIMENT CONTROL FENCE.
- CONTRACTOR TO INSTALL AND MAINTAIN MUD MAT AT CONSTRUCTION ACCESS IN ORDER TO PREVENT MUD TRACKING ONTO ADJACENT ROADS. MUD MAT TO BE MINIMUM 30m LONG AND 10.0m WIDE AND SHALL CONSIST OF 0.3m OF 50mm CLEAR STONE.

SPILLS CONTROL NOTES:

GEOTECHNICAL REPORT/MEMO:

CROSS

STORM

CONTOUR


- 1. ALL CONSTRUCTION EQUIPMENT SHALL BE REFUELED, MAINTAINED AND STORED NO LESS THAN 30 METERS FROM THE WATERCOURSES, STREAMS, CREEKS, WOODLOTS AND ANY ENVIRONMENTALLY SENSITIVE AREAS, OR AS
- 2. THE CONTRACTOR MUST IMPLEMENT ALL NECESSARY MEASURES IN ORDER TO PREVENT LEAKS, DISCHARGES OR SPILLS OF POLLUTANTS, DELETERIOUS MATERIALS, OR OTHER SUCH MATERIALS OR SUBSTANCES WHICH WOULD OR COULD CAUSE AN ADVERSE IMPACT TO THE NATURAL ENVIRONMENT.
- 3. IN THE EVENT OF A LEAK, DISCHARGE OR SPILL OF A POLLUTANT, DELETERIOUS MATERIAL OR OTHER SUCH MATERIAL OR SUBSTANCE WHICH WOULD OR COULD CAUSE AN ADVERSE IMPACT TO THE NATURAL ENVIRONMENT, THE CONTRACTOR SHALL:
- a) IMMEDIATELY NOTIFY THE APPROPRIATE FEDERAL, PROVINCIAL AND LOCAL GOVERNMENT MINISTRIES, DEPARTMENTS, AGENCIES AND AUTHORITIES OF THE INCIDENT IN ACCORDANCE WITH ALL CURRENT LAWS, LEGISLATION, ACTS, BY-LAWS, PERMITS, APPROVALS, ETC.
- b) TAKE IMMEDIATE MEASURES TO CONTAIN THE MATERIAL OR SUBSTANCE, AND TO TAKE SUCH MEASURES AS THEY DEEM APPROPRIATE TO MITIGATE AGAINST THE ANY ADVERSE IMPACTS TO THE NATURAL ENVIRONMENT.


c) THE CONTRACT SHALL RESTORE THE AFFECTED AREA TO ORIGINAL CONDITION OR BETTER, ALL TO THE SATISFACTION OF THE AUTHORITIES HAVING JURISDICTION.

- GEOTECHNICAL INVESTIGATION REPORT NO. PG6165-1, REVISION 1, DATED OCTOBER 7, 2022, PREPARED BY PATERSON

INFORMATION PRESENTED ON THESE DRAWINGS HAS BEEN INTERPOLATED FROM THE GEOTECHNICAL REPORTS AND ACCURACY IS

NOT GUARANTEED. CONTRACTORS ARE ADVISED TO READ THE GEOTECHNICAL REPORTS AND ASSUME THEIR OWN CONCLUSIONS. **BUILDING ENVELOPE** LEGEND WATERMAIN TOP OF FOUNDATION ELEVATION : 90.55 FINISHED FLOOR ELEVATION -90.85 UNDERSIDE OF FOOTING ELEVATION -88.03 NUMBER OF RISERS -UNITS REQUIRING PRESSURE REDUCING VALVES-HYDRANT, VALVE & VB —— WALKOUT UNITS SLAB ON GRADE -VALVE & VC ----SANITARY DRAINAGE BOUNDARY 22.5° BEND ---/43A - 44A UPSTREAM MH TO DOWNSTREAM MH --AREA IN HECTARES RFDUCFR ---CAP — POPULATION ---SANITARY STORM DRAINAGE BOUNDARY WATERTIGHT MAINTENANCE HOLE ----MAINTENANCE HOLE UPSTREAM MH TO DOWNSTREAM MH ---- / 43 - 44 CAP -----0.37 0.51 AREA IN HECTARES STREET CATCHBASIN & LEAD -----RUNOFF COEFFICIENT ----Ů МН202 PONDING AREA ____ CURB INLET CATCHBASIN & LEAD CATCHBASIN/ MAINTENANCE HOLE ----Ф свмн201 PA-1 PONDING AREA ID INTERCONNECTED CATCH BASIN & LEADS ---------PROPOSED SILT FENCE \leq SINGLE SERVICE LOCATION (ST, SAN & WM) _____ PROPOSED SNOW FENCE < SINGLE SERVICE LOCATION (SAN & WM) PROPOSED ROCK FLOW CHECK DAM SINGLE SERVICE LOCATION (ST, SAN & WM) ____ 777 PROPOSED STRAW BALE BARRIER TEE CATCHBASIN -----PROPOSED STRAW BALE BARRIER WITH FILTER CLOTH PERFORATED PIPE ELBOW CATCHBASIN FILTER CLOTH FOR EXISTING STRUCTURE 600¢ CSP DITCH AND CULVERT PROPOSED RIP RAP TREATMENT CONCRETE SIDEWALK 1.8m. CONC. SIDEWALK TACTILE WALKING SURFACE JOINT UTILITY TRENCH (HYDRO, BELL, CABLE) ——H,B,C—— (AS PER CITY OF OTTAWA STD. SC6) DC BARRIER MOUNTABLE CURB & DEPRESSED CURB DENOTES NUMBER OF UTILITY DUCTS 2H,1B,1C ASPHALT SIDEWALK 1.8m ASPH. SIDEWALK CONCRETE ENCASED DUCT CHAINLINK FENCE (1.5m UNLESS OTHERWISE NOTED) NOISE BARRIER (3.0m UNLESS OTHERWISE NOTED) STREET LIGHT CABLE ----- SL -----DECORATIVE FENCE NATURAL GAS LINE ____ G ____ (SEE LANDSCAPE DRAWINGS FOR DETAIL) WOOD PRIVACY BARRIER SERVICE ENTRANCE HYDRO, BELL, CABLE POST AND RAIL FENCE END WALL BOX PHASING LIMITS ------------PROPERTY BOUNDARY CABLE PEDESTAL BOREHOLE (BH) CGLB CABLE GRADE LEVEL BOX TEST PIT (TP) AS PER AUGER HOLE (AH) **GEOTECHNICAL** BELL PEDESTAL MONITORING WELL LOCATION REPORT CONCEPTUAL WELL LOCATION BGLB BELL GRADE LEVEL BOX FOR SPLICING 91.00 BELL CENTRAL SPLITTING POINT PROPOSED ELEVATION $\times^{92.52}_{92.49}$ EXISTING ELEVATION HYDRO TRANSFORMER T/G 92.55 TOP OF GRATE ELEVATION Θ HYDRO MAINTENANCE HOLE HYDRO POLE PROPOSED TERRACING 2.0% SURFACE SLOPE HYDRO POLE c/w GUY WIRE FLOW DIRECTION STREET LIGHT DISCONNECT MAJOR OVERLAND FLOW DIRECTION STREET LIGHT STANDARD TACTILE WALKING SURFACE INDICATOR ____ (AS PER CITY OF OTTAWA STD. SC6) CMB COMMUNITY MAILBOX BUS BUS STOP LOCATION c/w ASPHALT BOULEVARD TREE

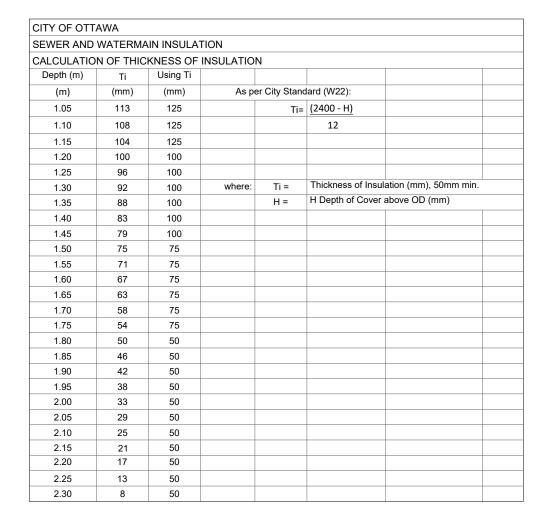

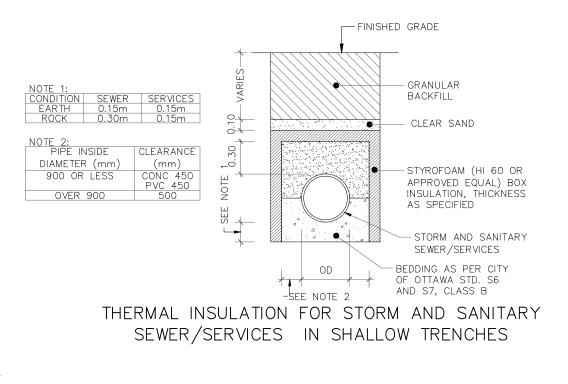

NOT FOR CONSTRUCTION


TOPOGRAPHIC INFORMATION

TOPOGRAPHIC INFORMATION PROVIDED BY ANNIS, O'SULLIVAN, VOLLEBEKK LTD. PROJECT NO. 21942-22 DATED SEPTEMBER 1, 2022


SITE PLAN INFORMATION

SITE PLAN PROVIDED BY SRN ARCHITECTS, DATED ON JUNE 10, 2025.

ELEVATION NOTE ELEVATIONS ARE GEODETIC AND ARE REFERRED TO THE CGVD28 GEODETIC DATUM, DERIVED FROM VERTICAL CONTROL MONUMENT NO. BM88U502. ELEVATION = 106.039 m

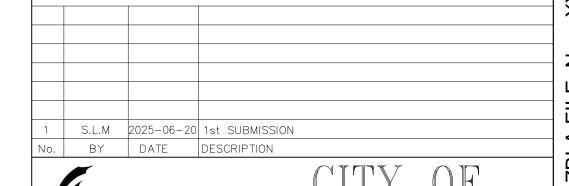



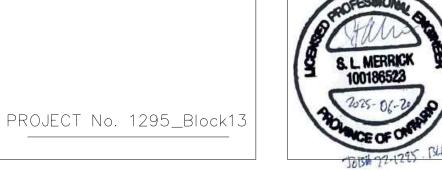

Minto Group

DRAWN BY: E.D.

DESIGNED BY: E.D.

SCALE:

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www.DSEL.ca

GENERAL NOTES

CHECKED BY: S.L.M.

DATE: JUNE 2025

ABBOTT'S RUN


BLOCK 13


CHECKED BY: S.L.M. SHEET NO.


© DSEL


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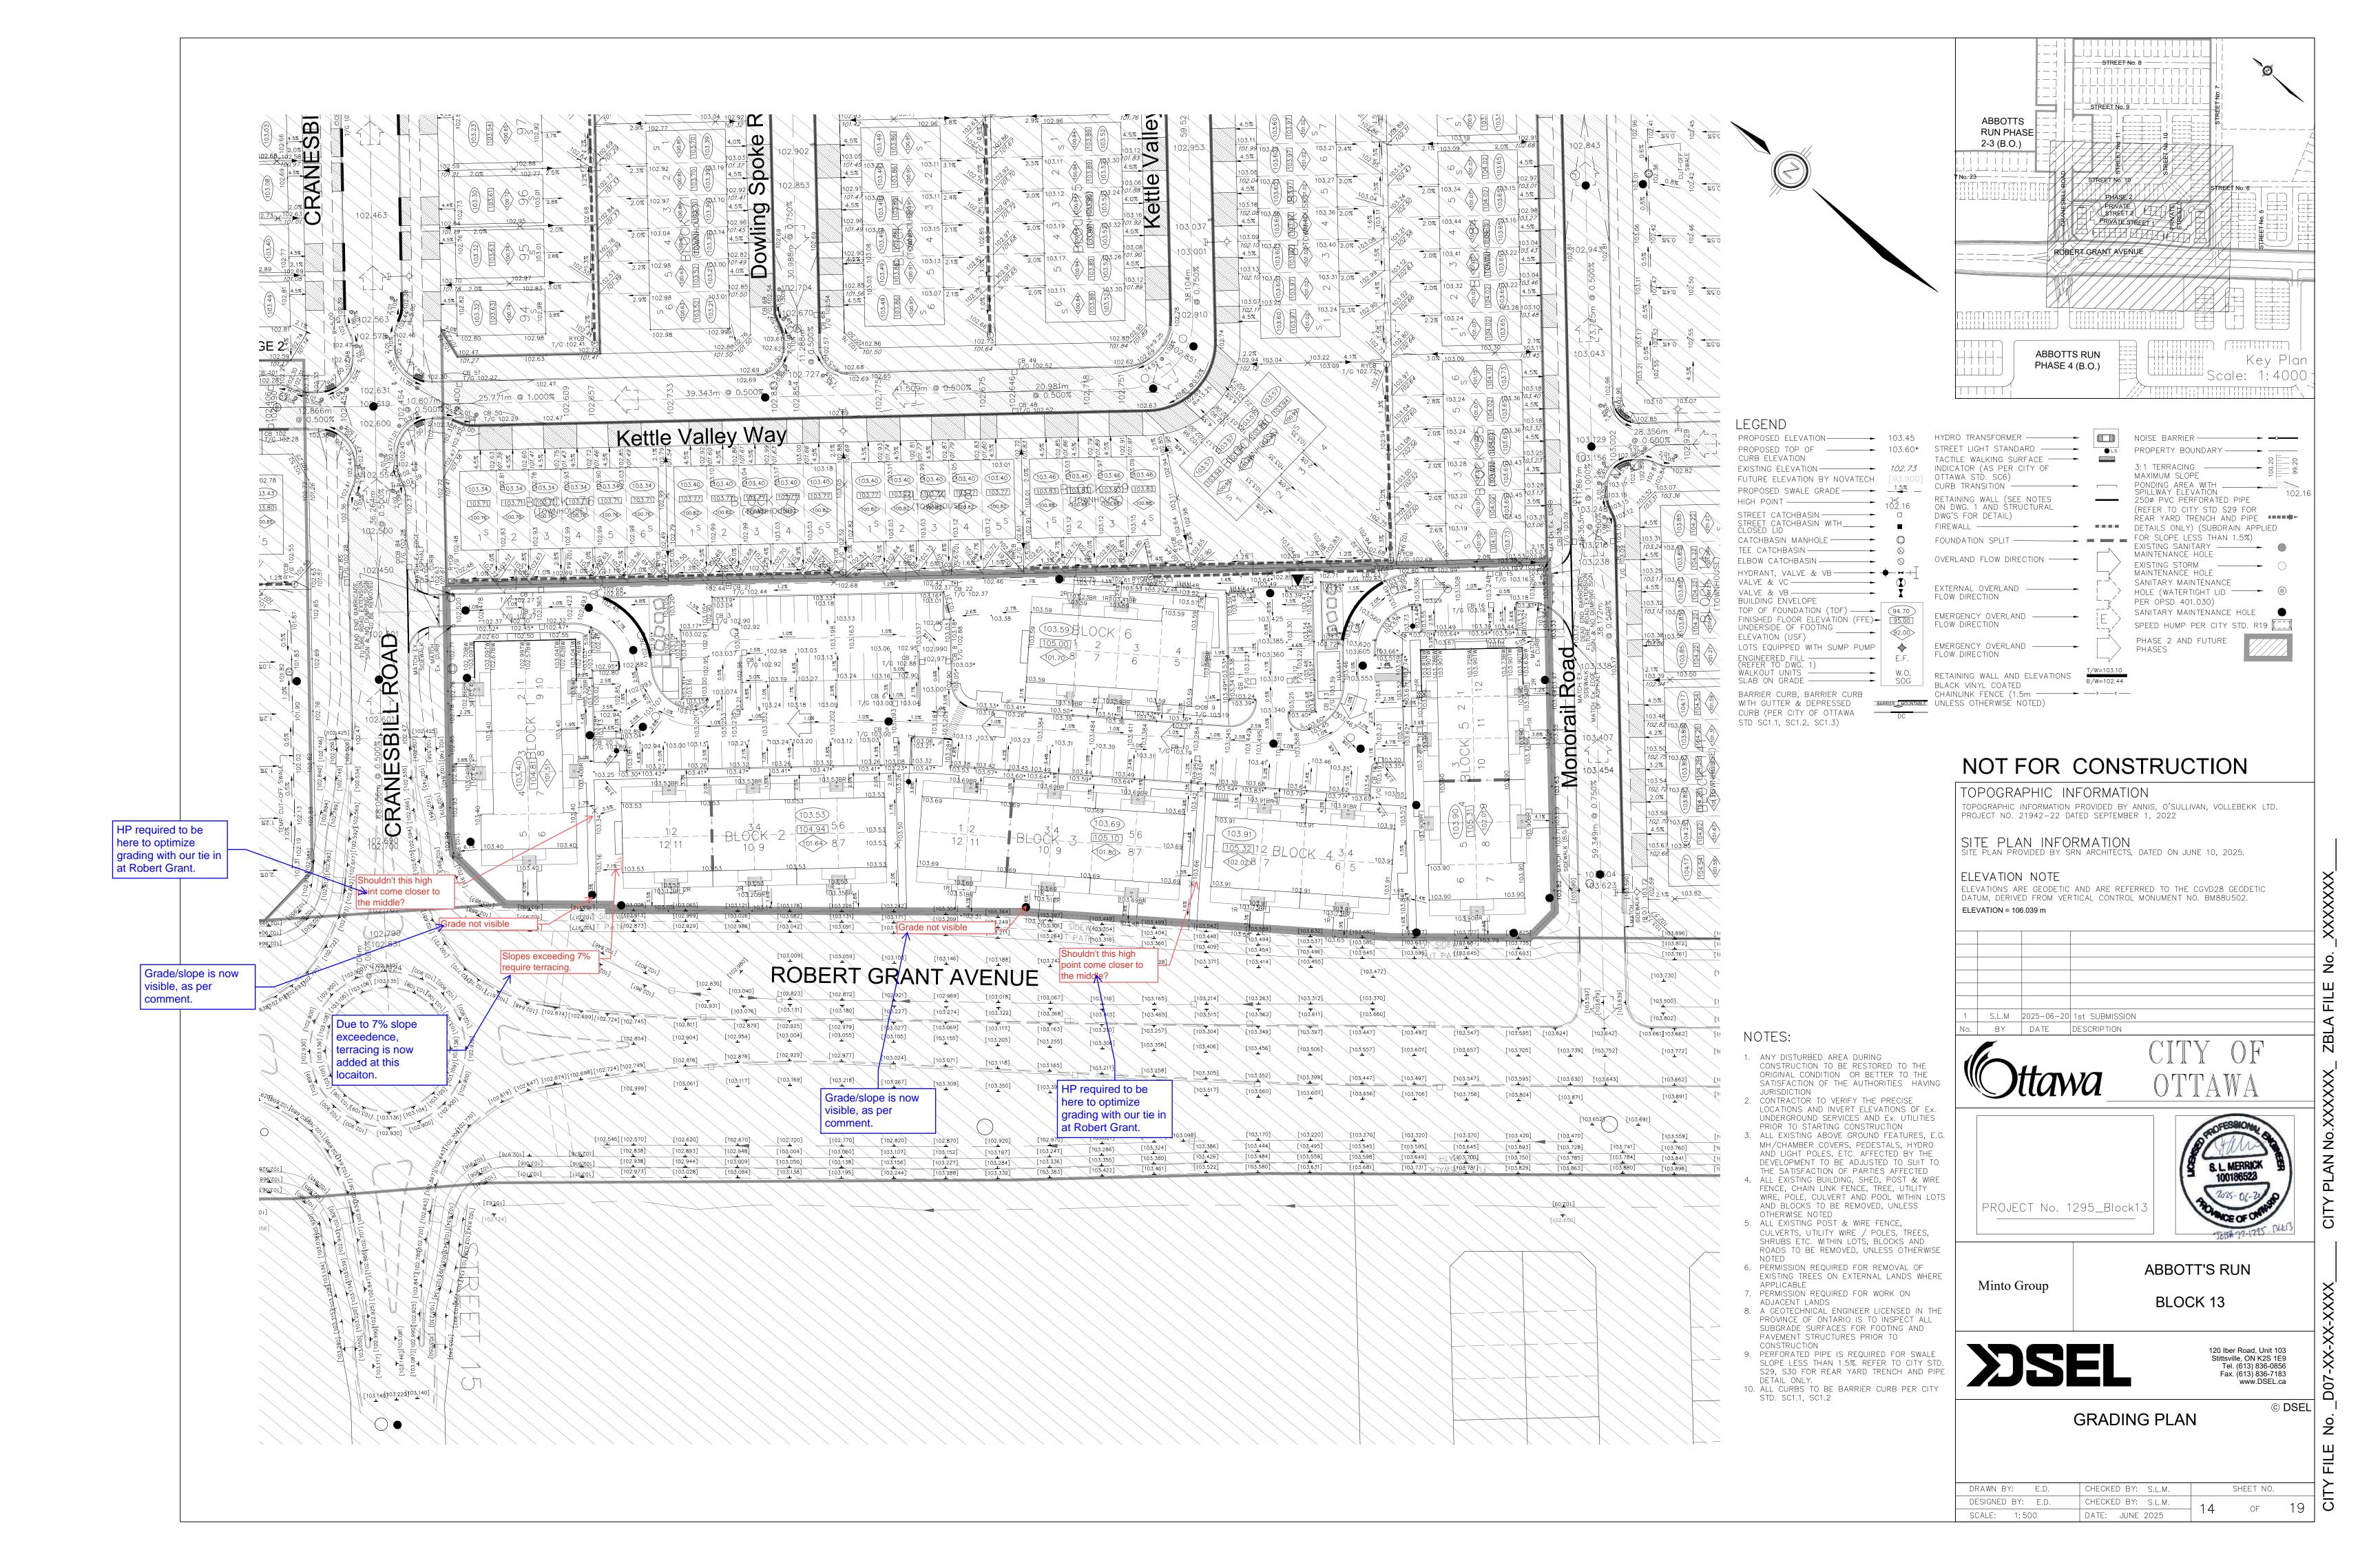
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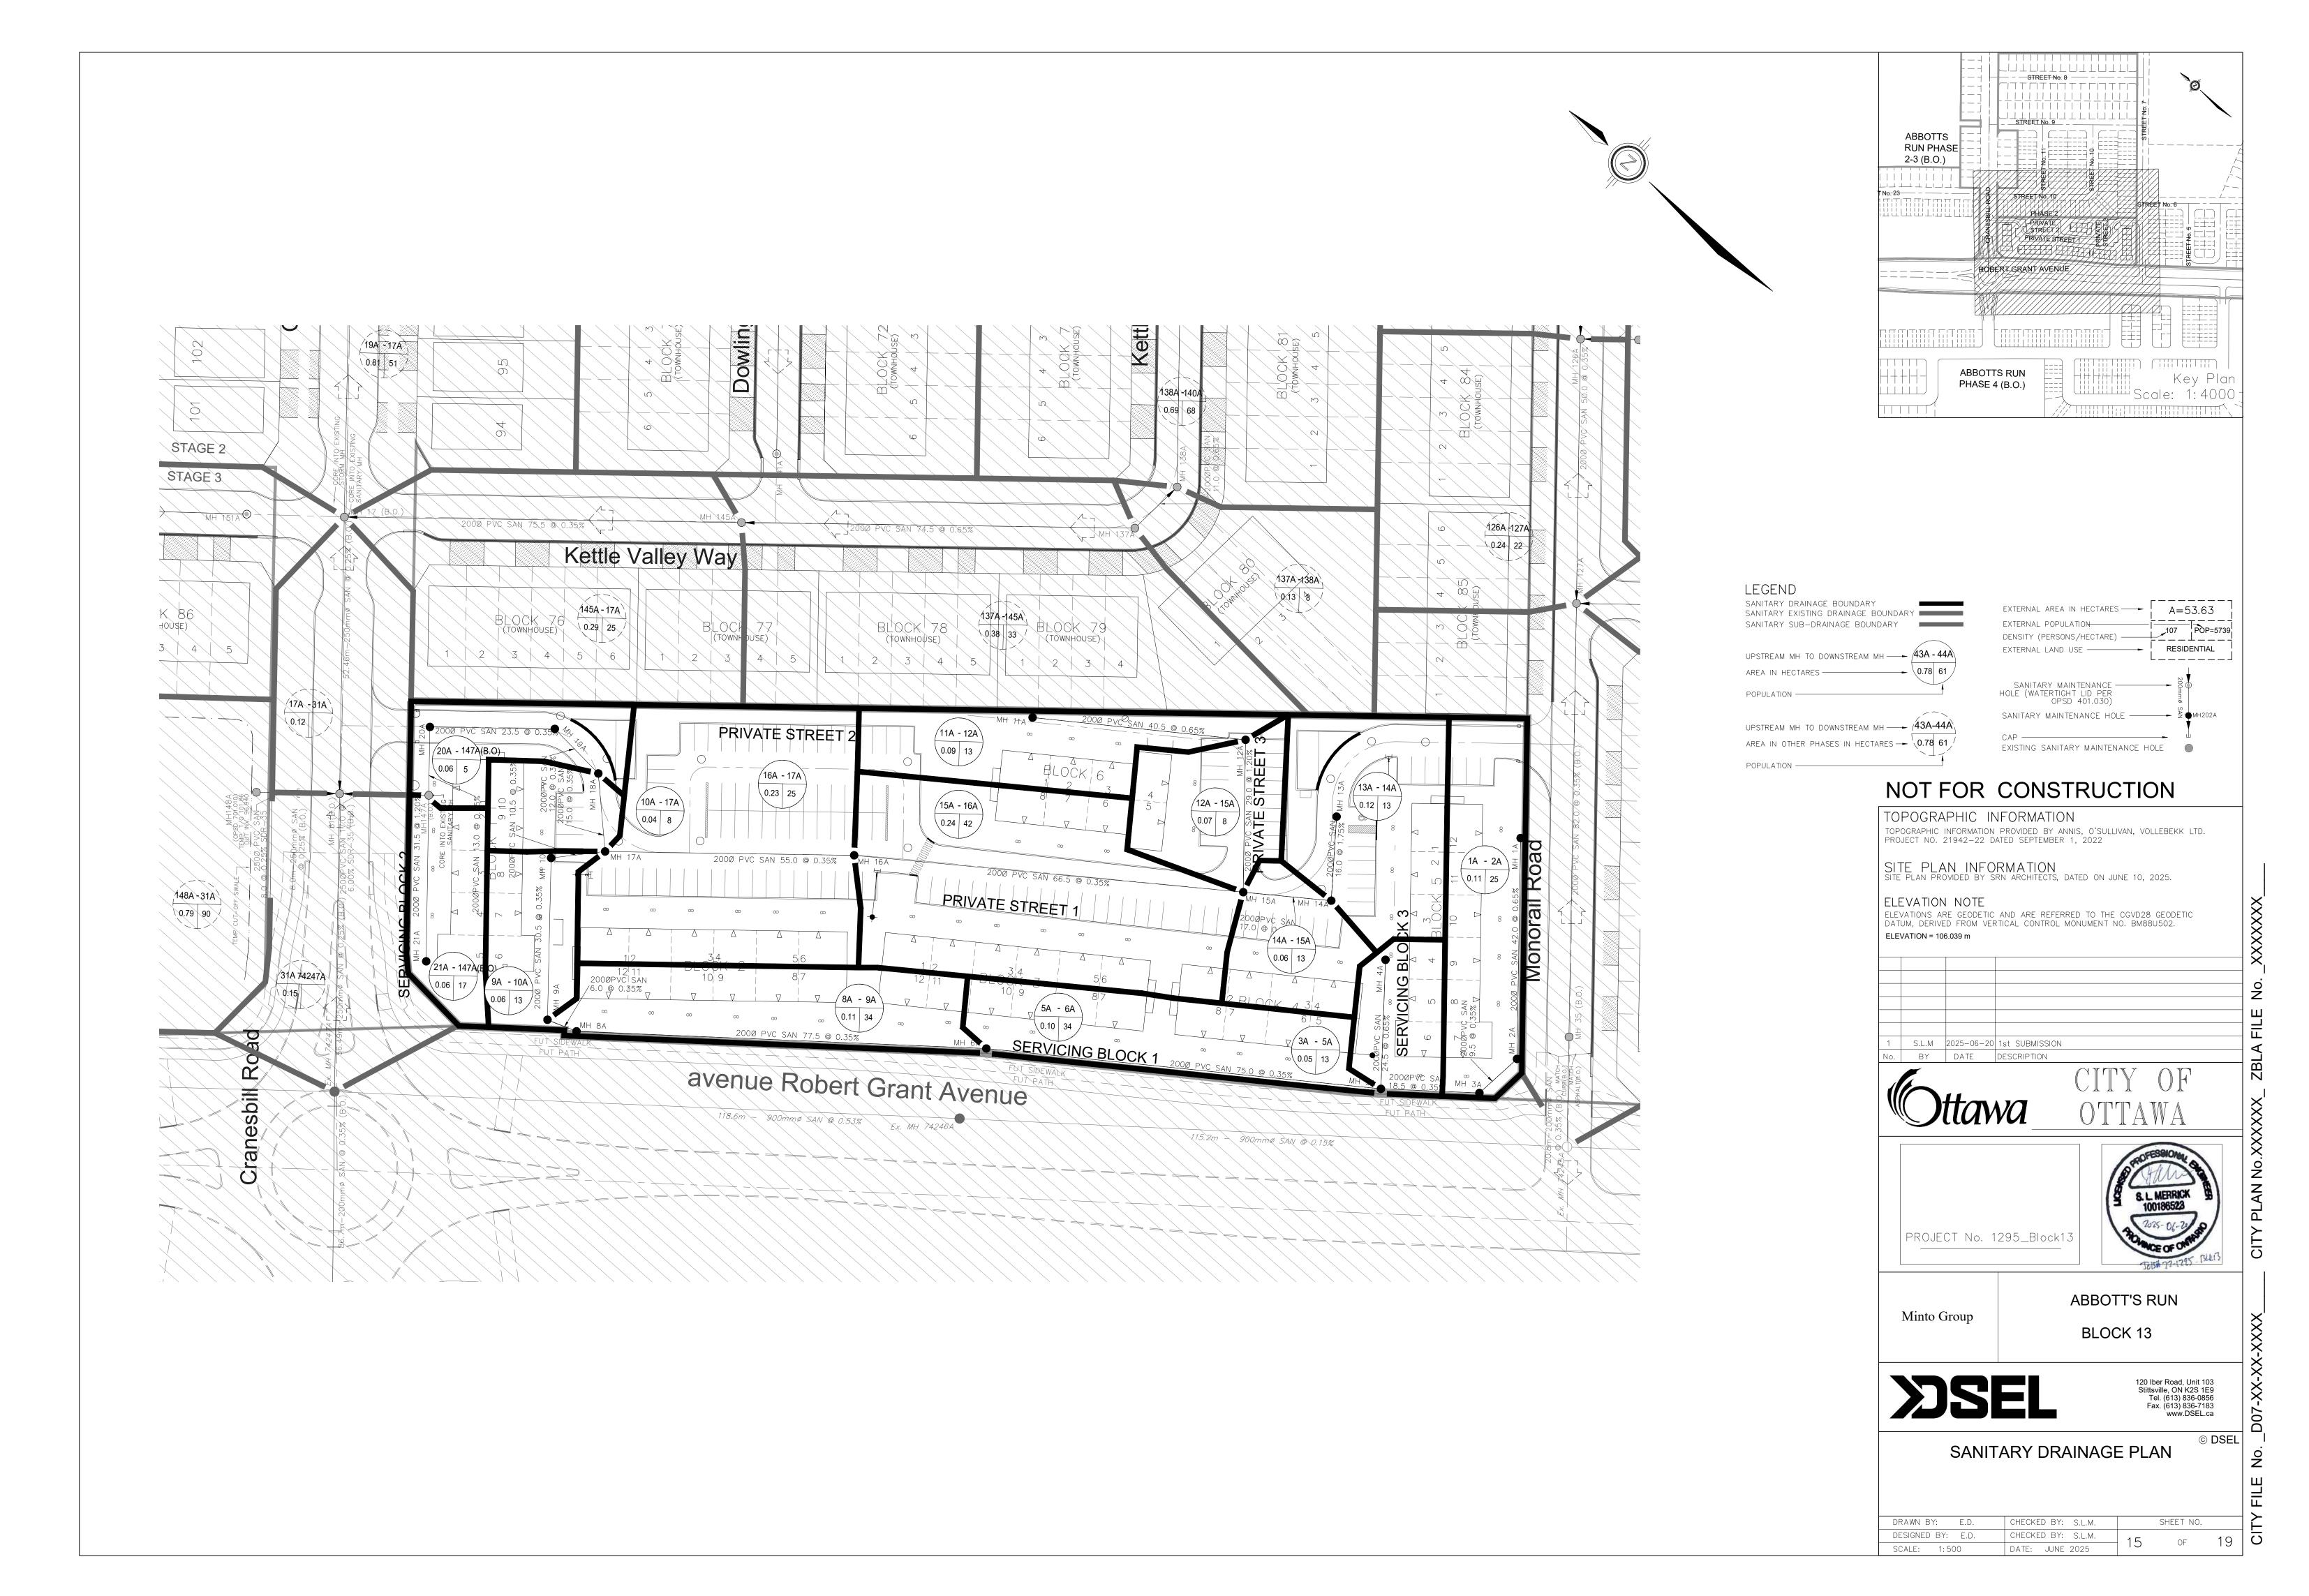





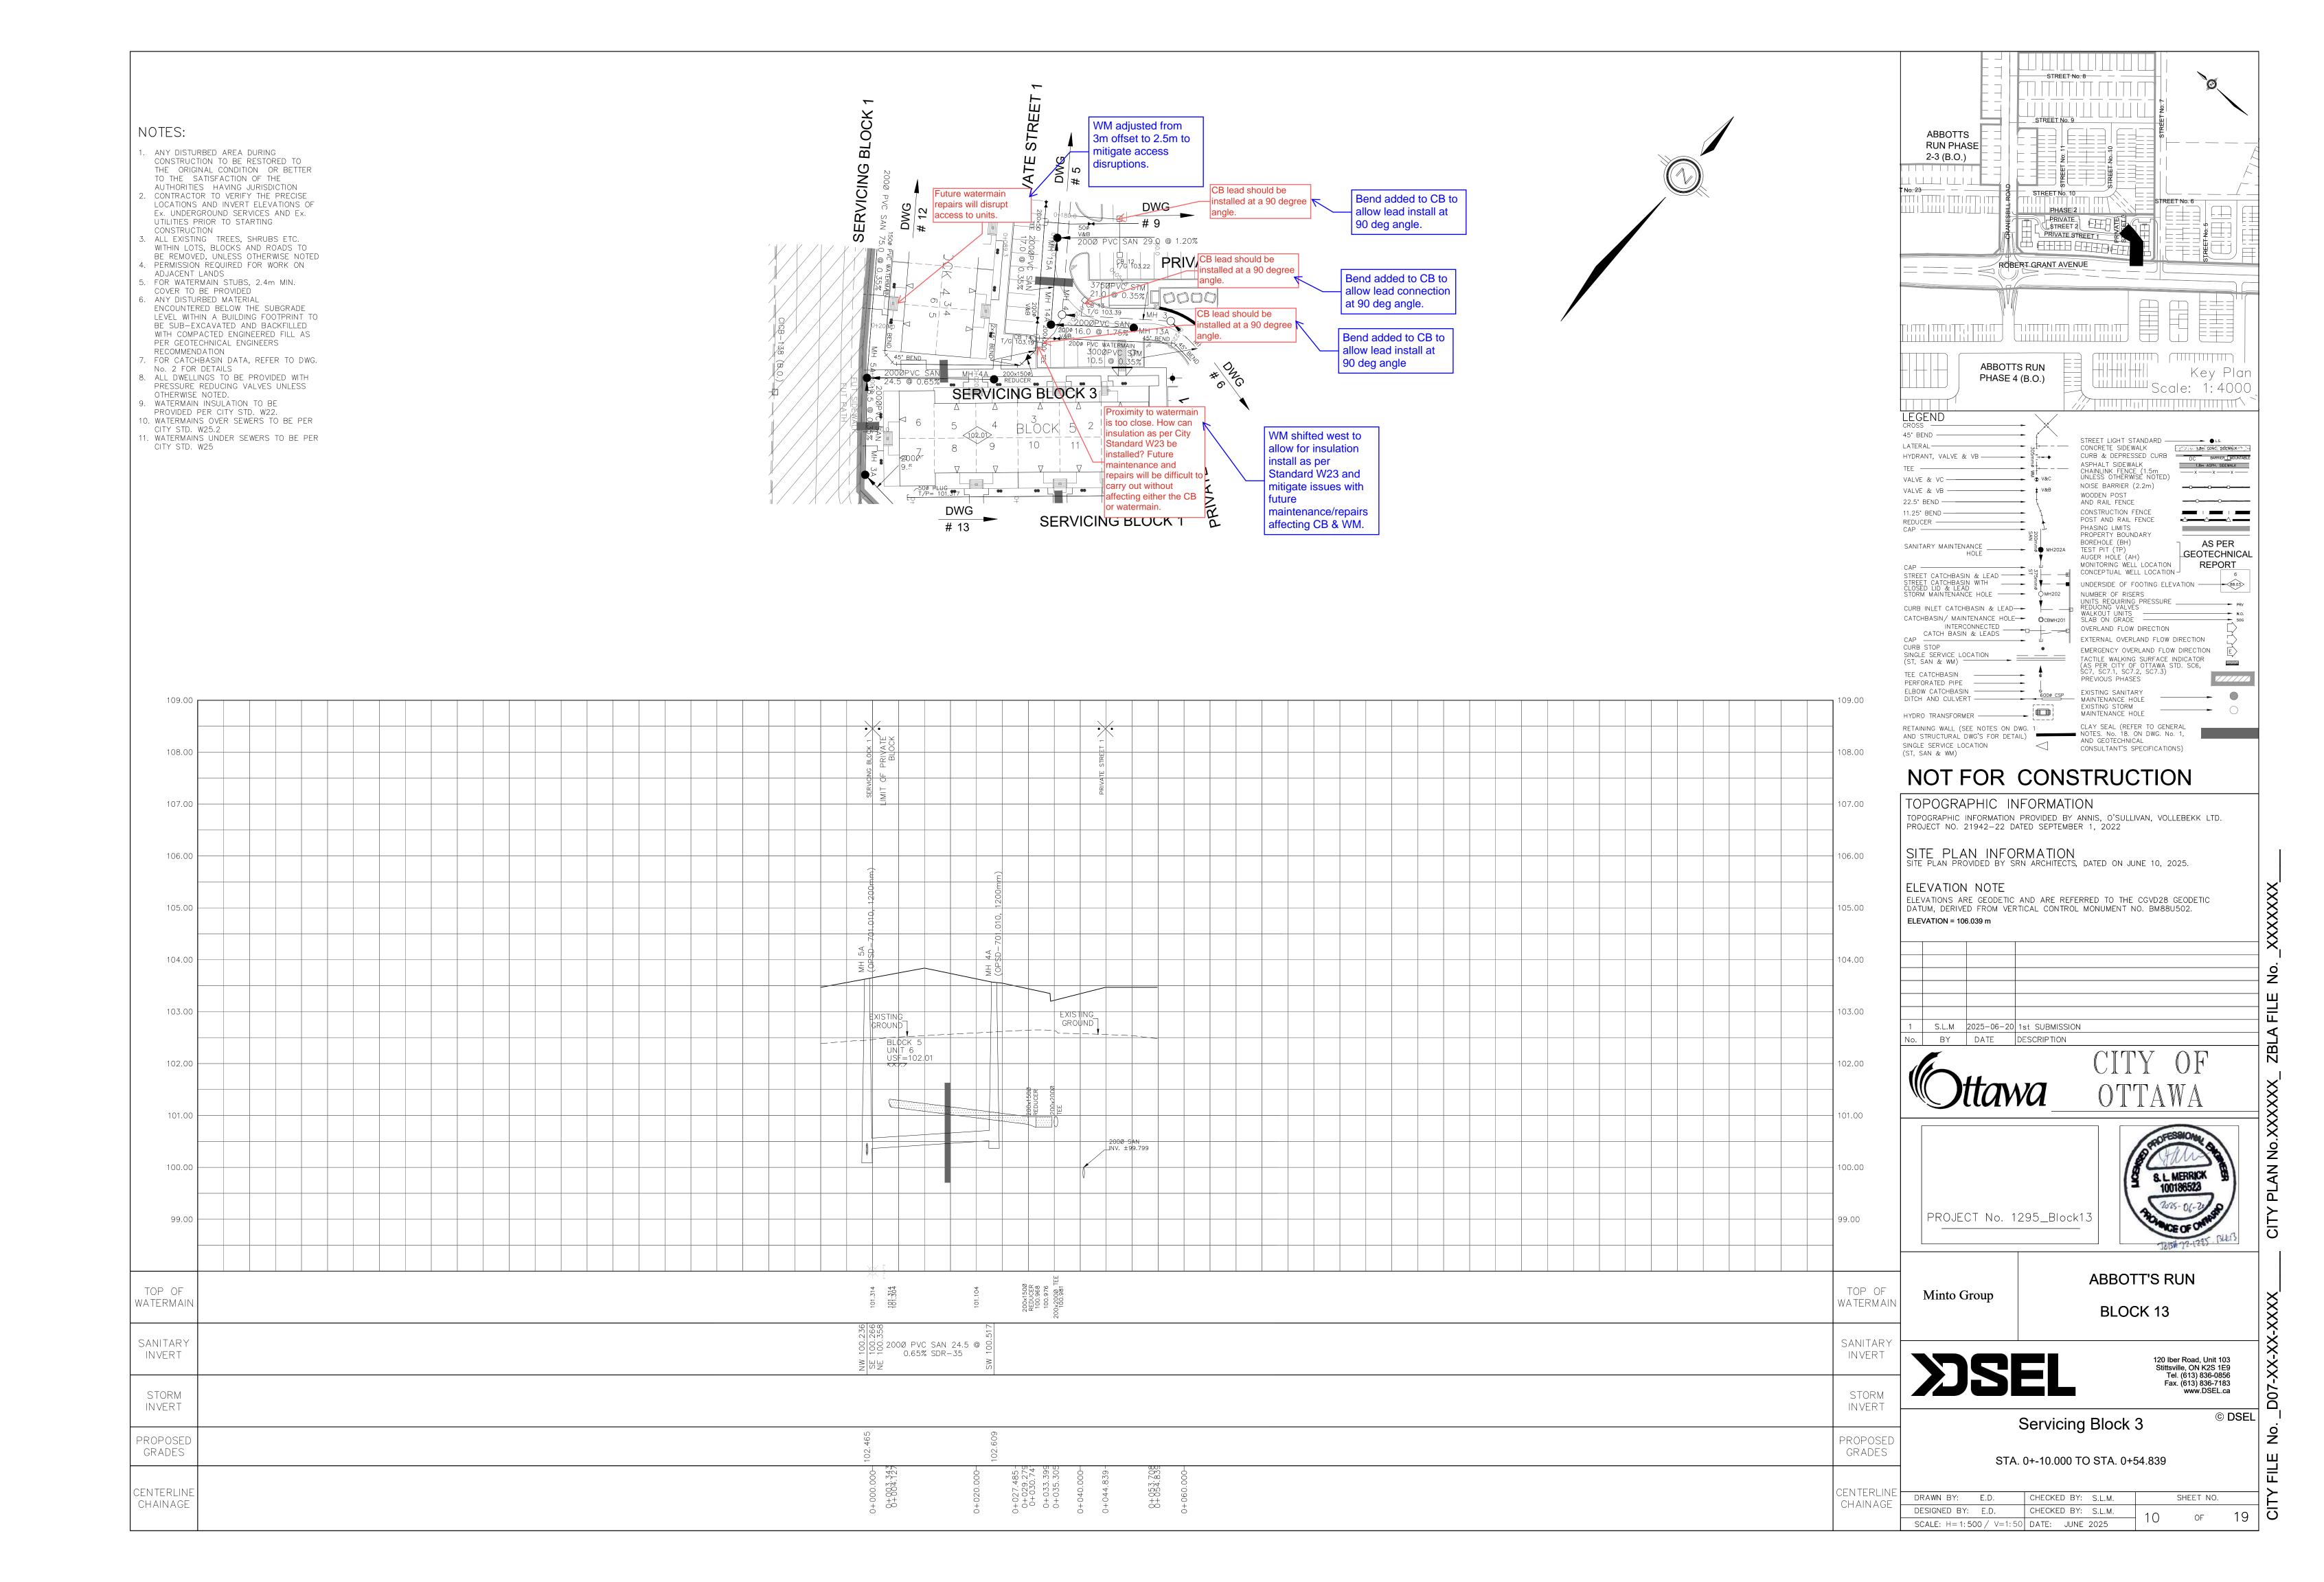

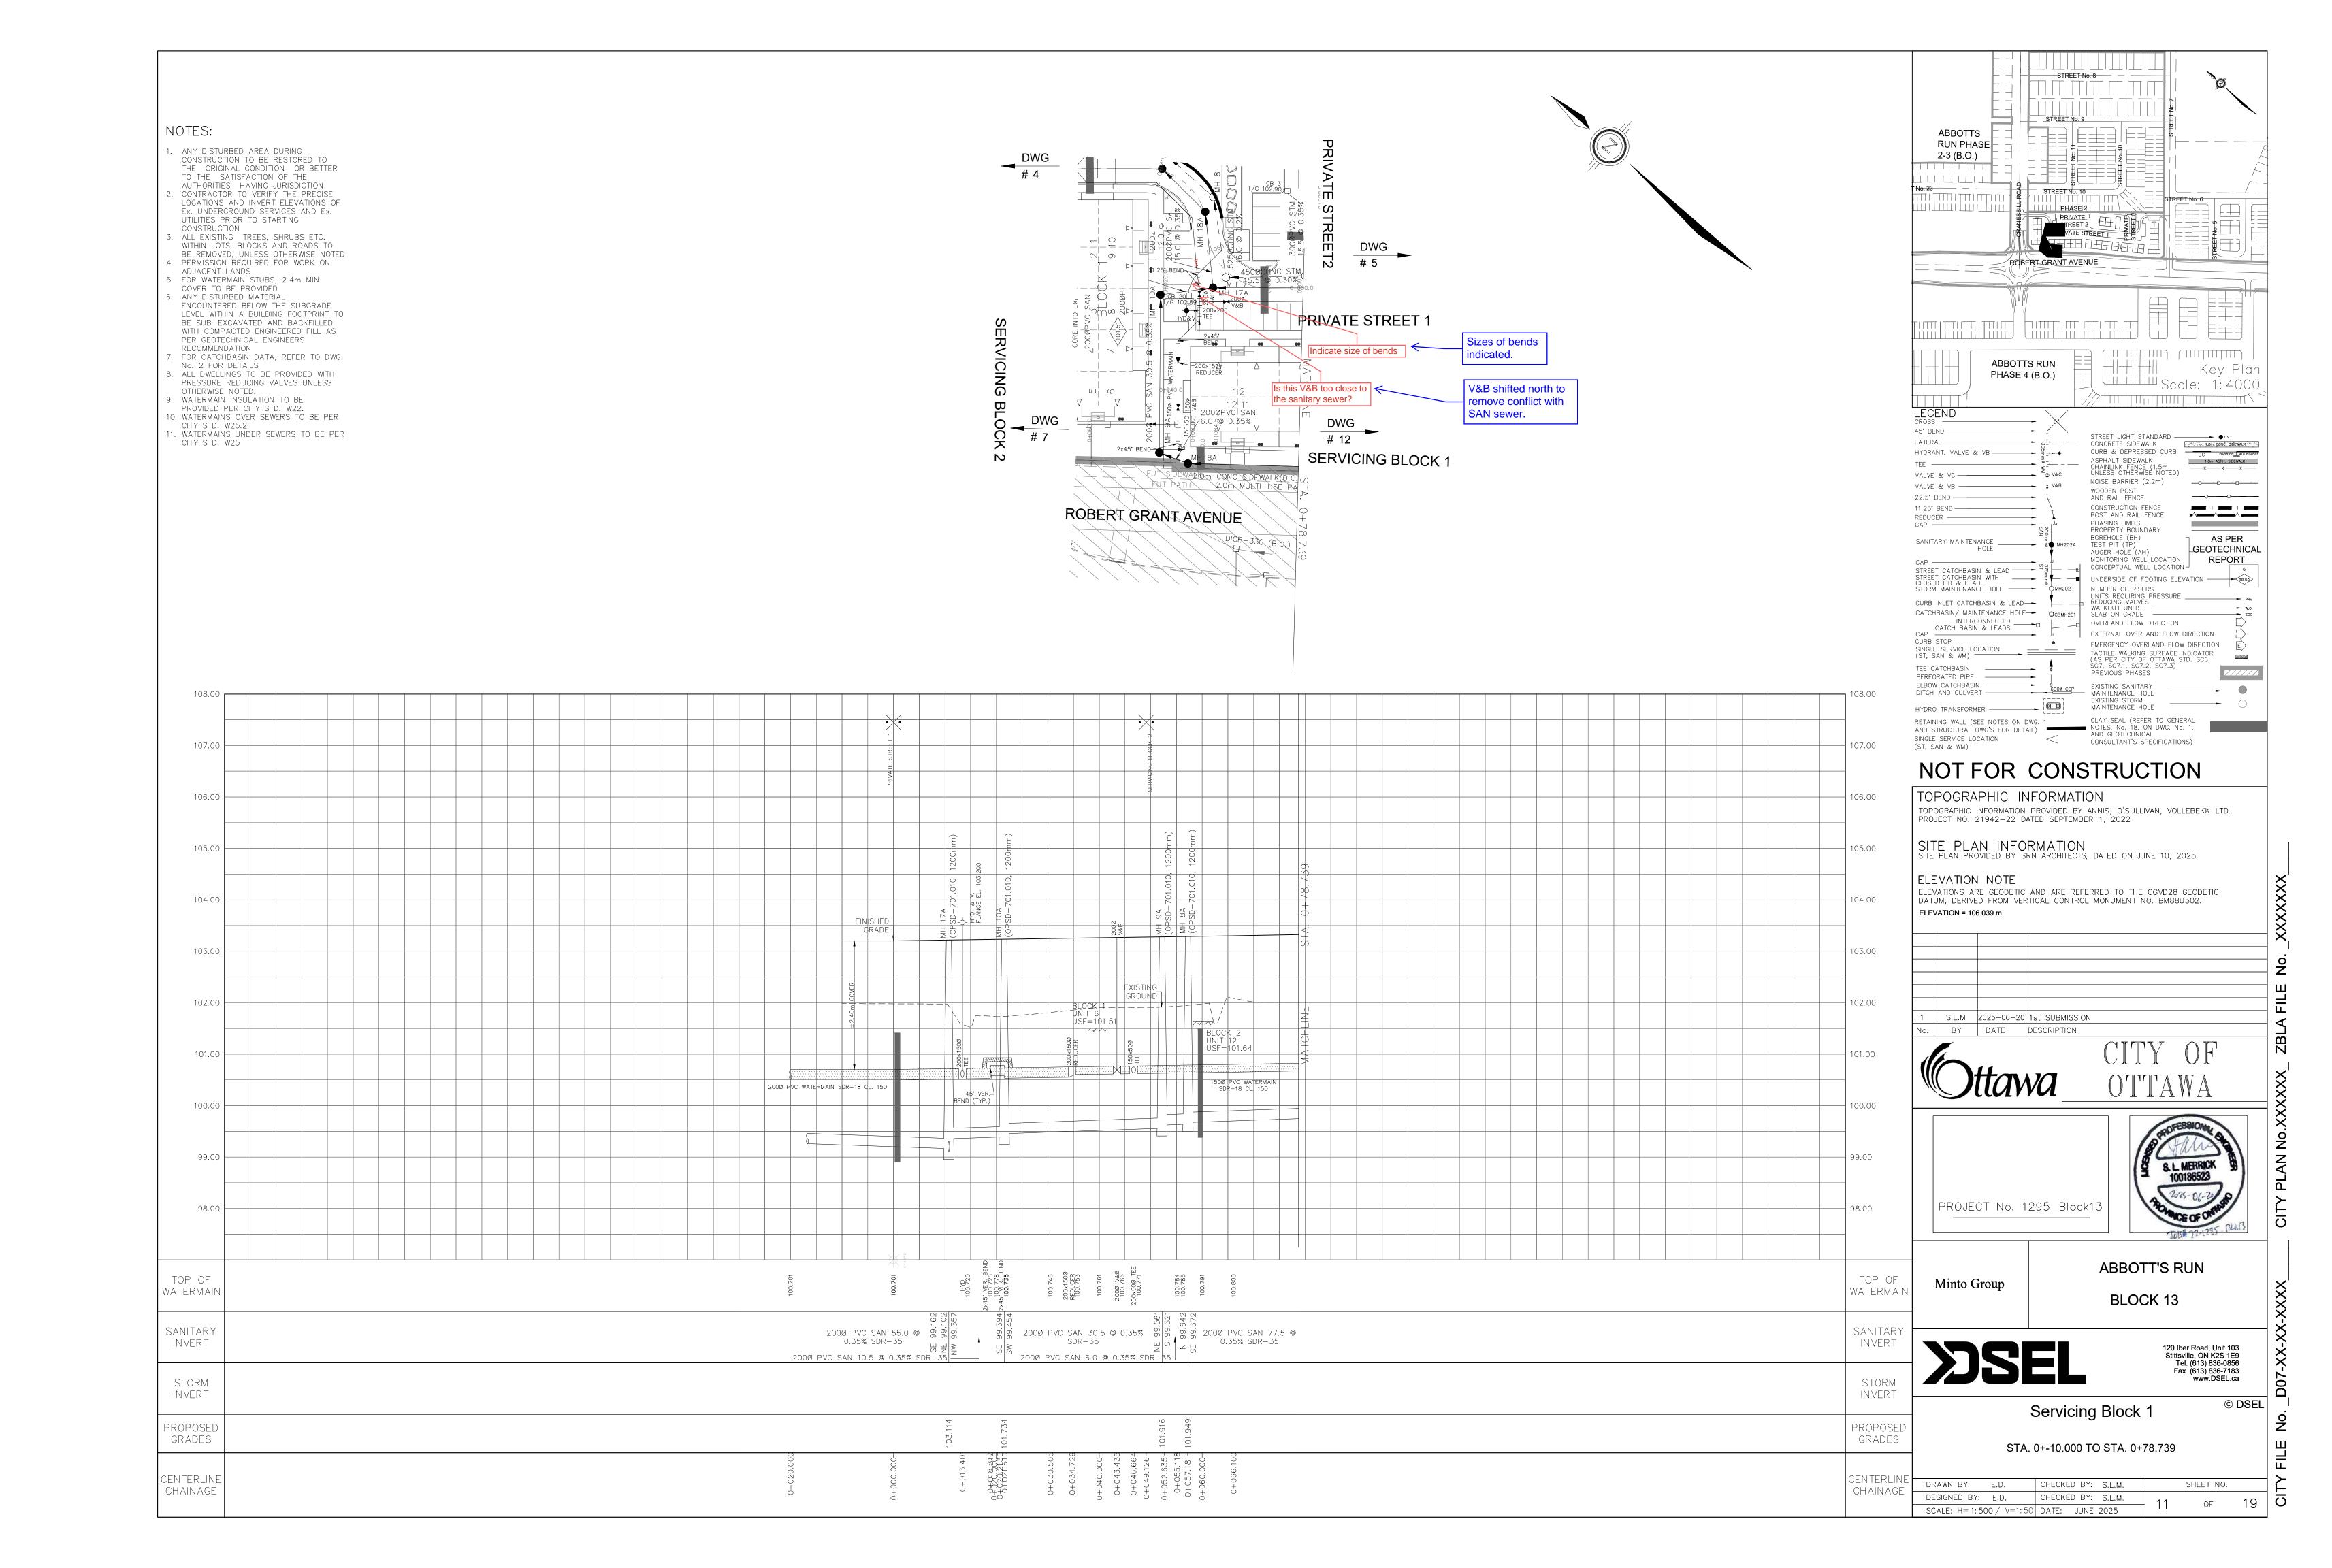


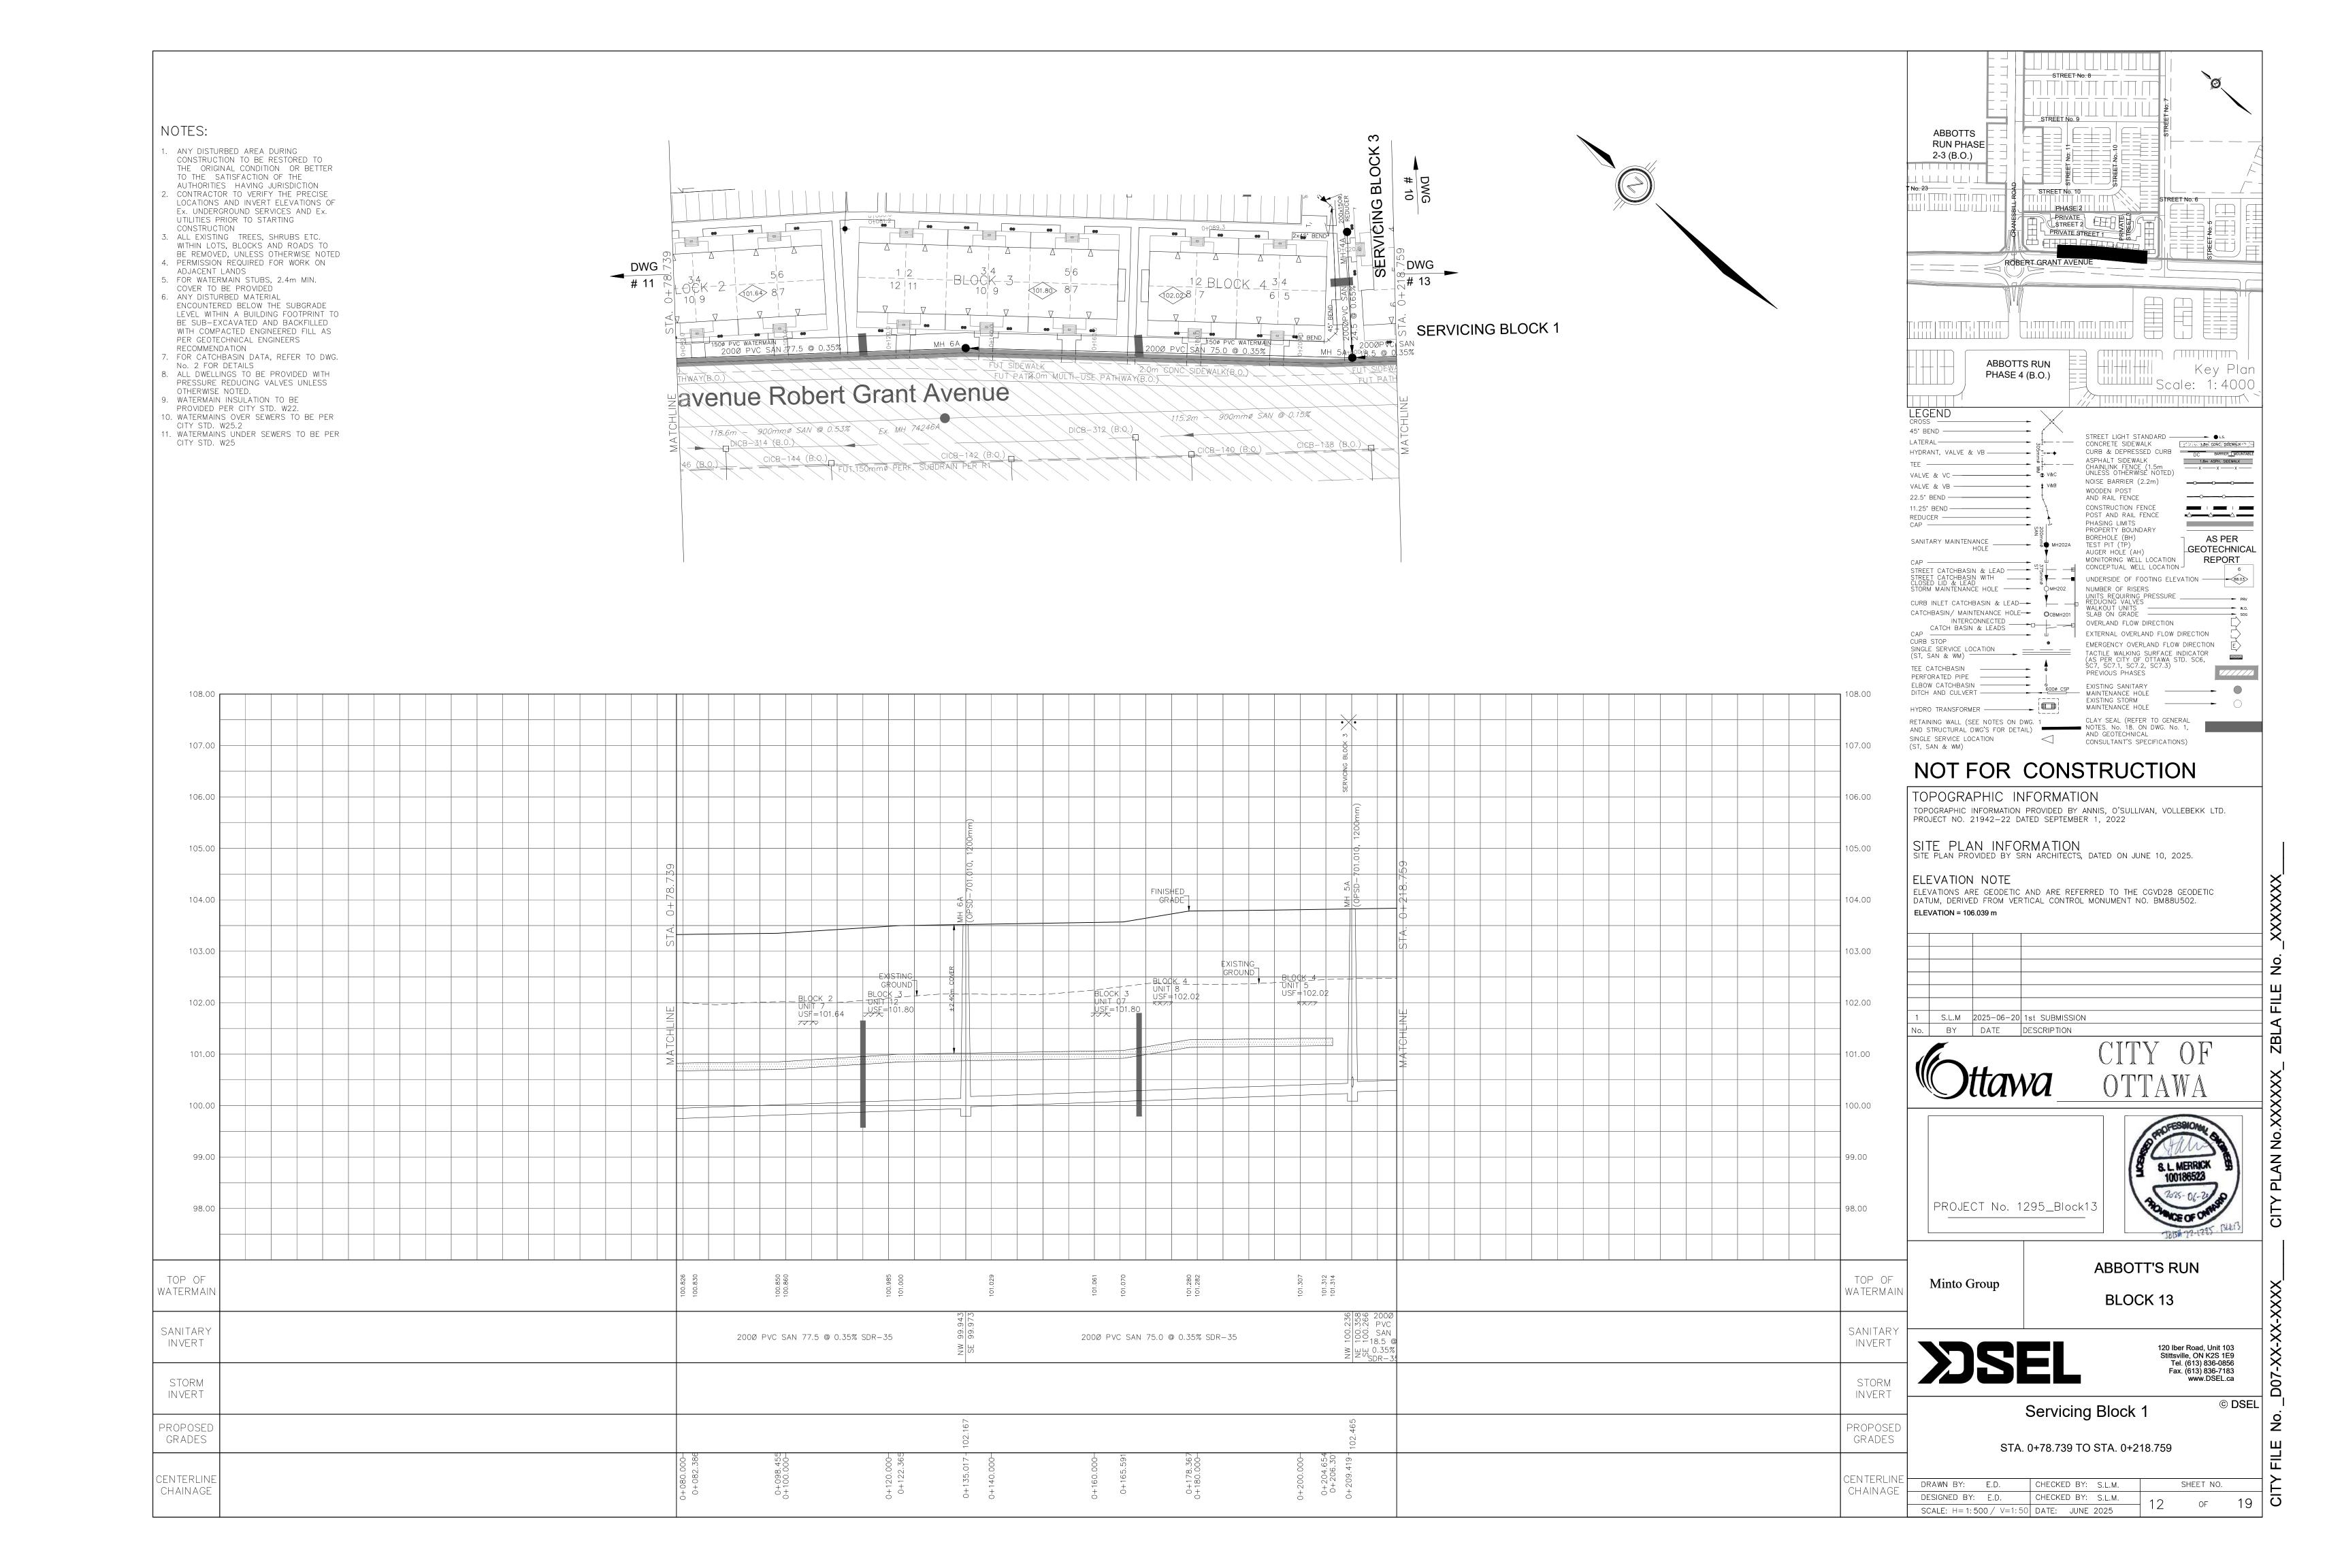

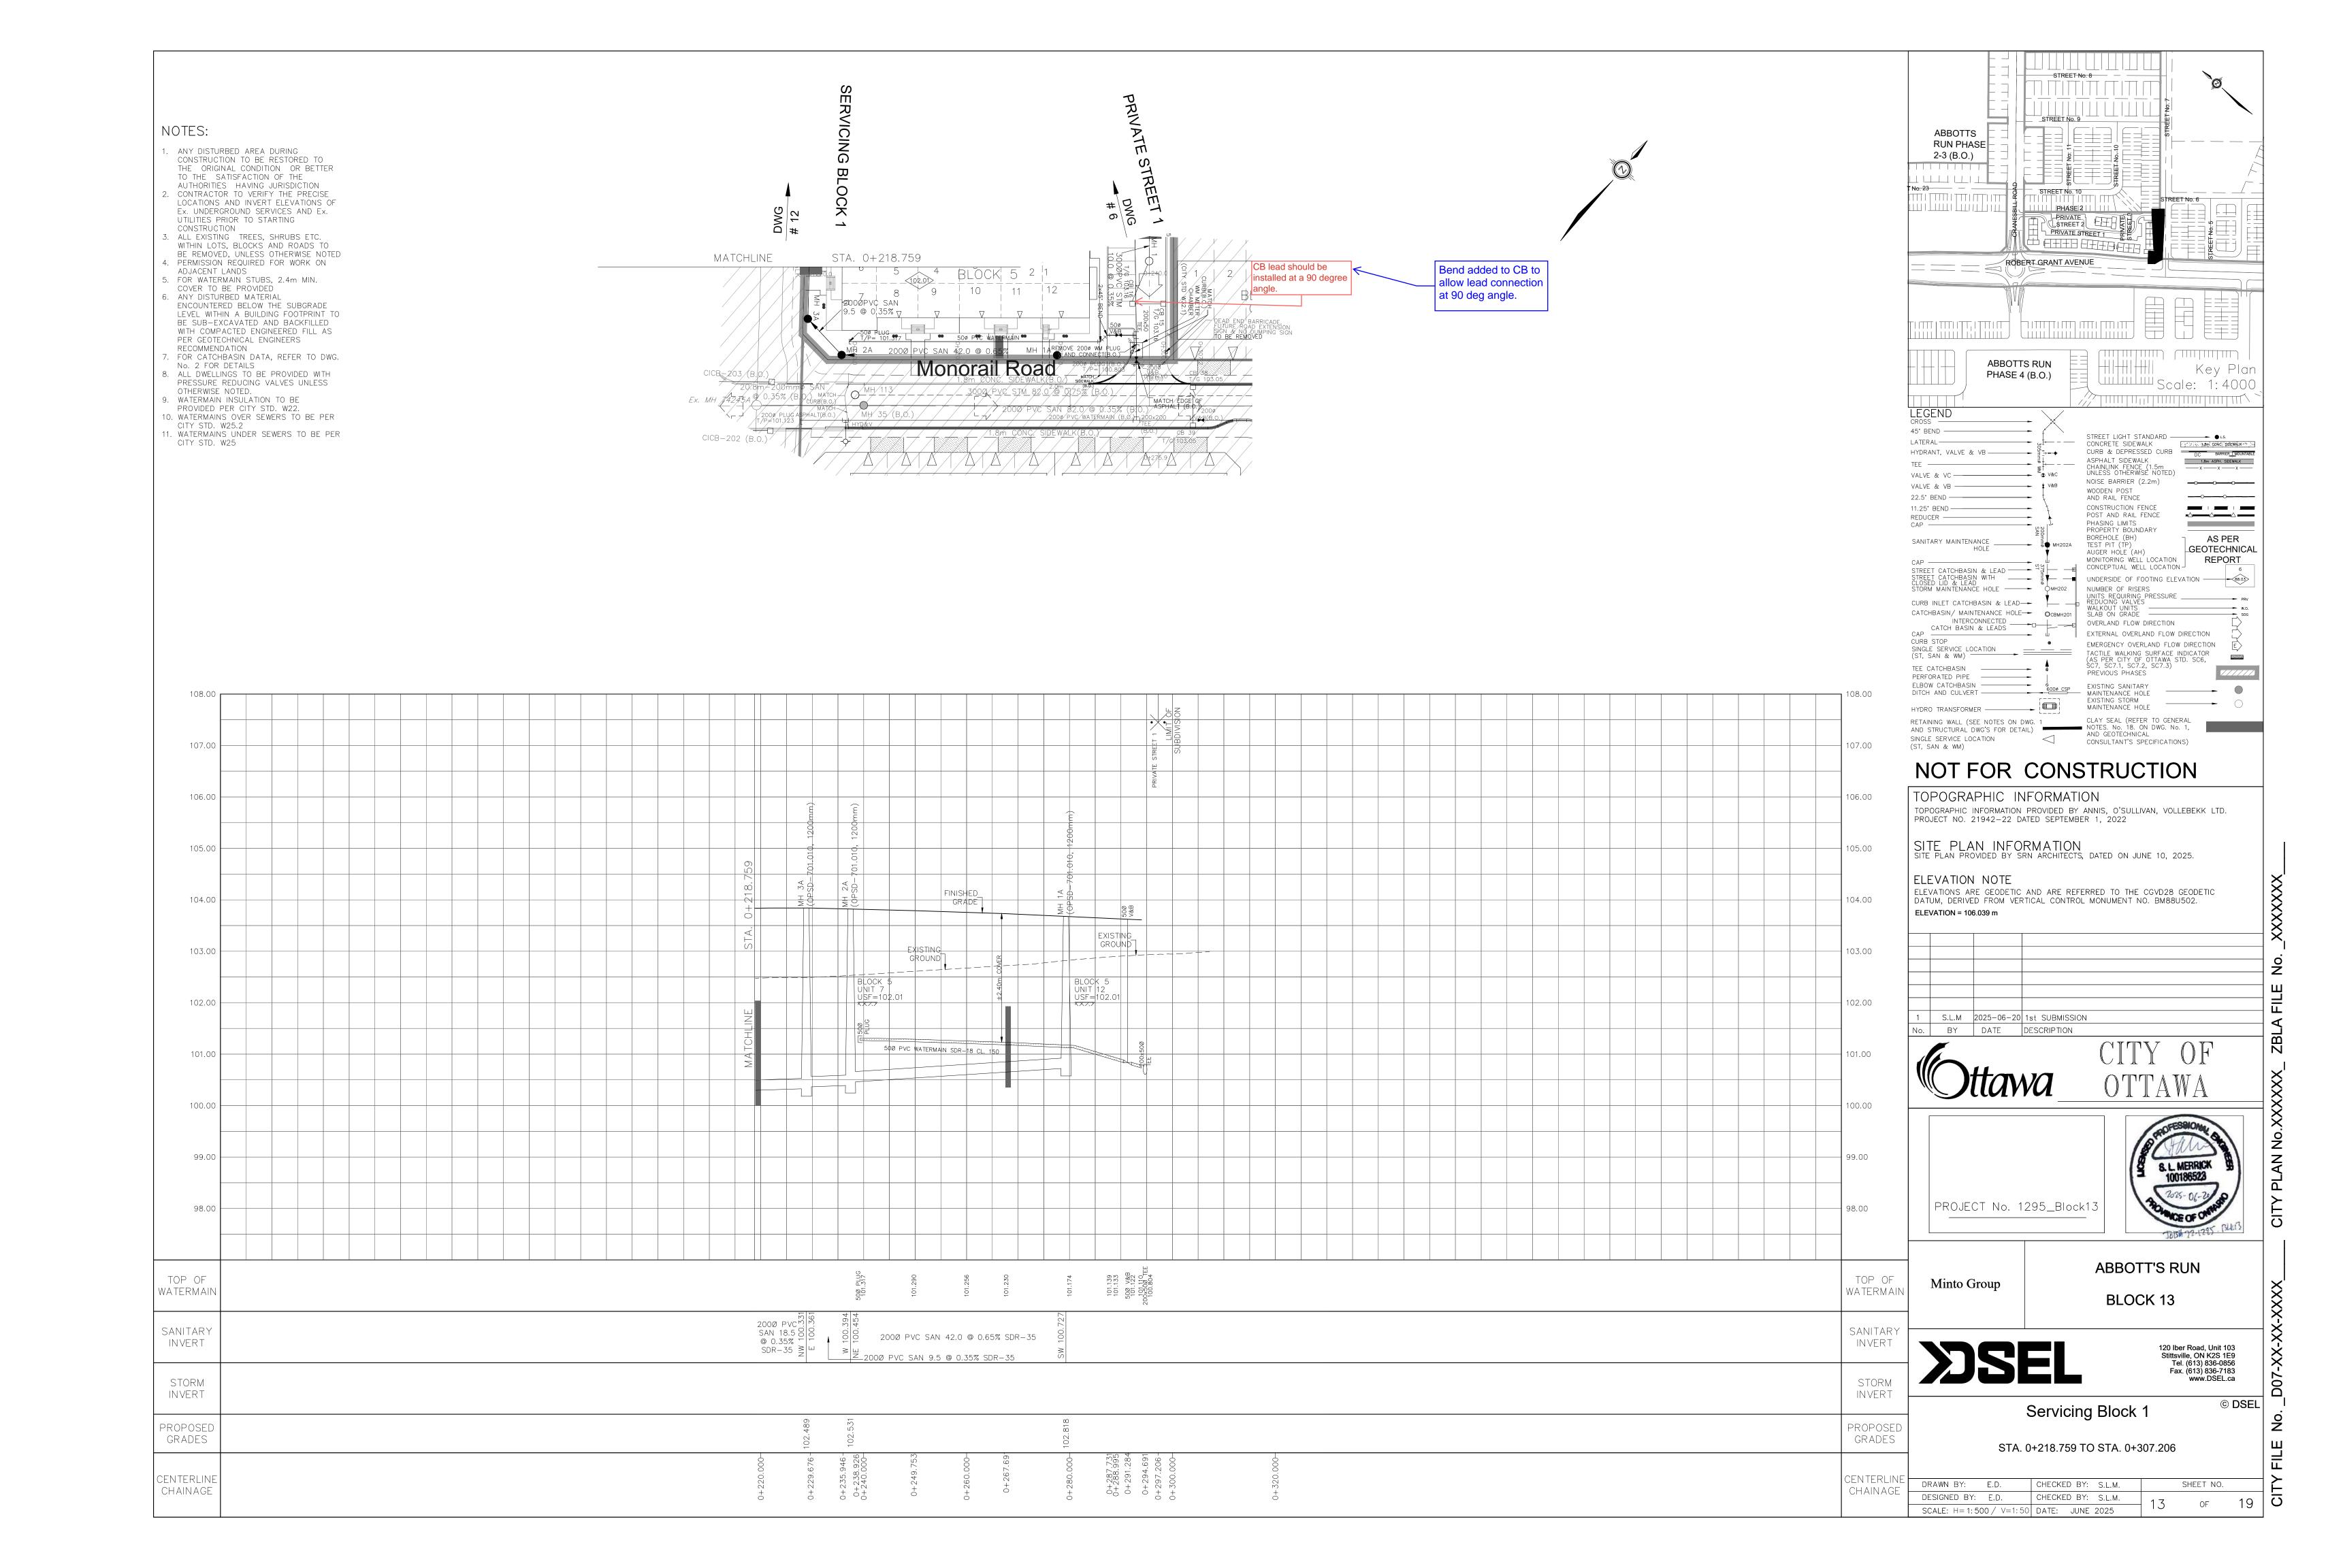


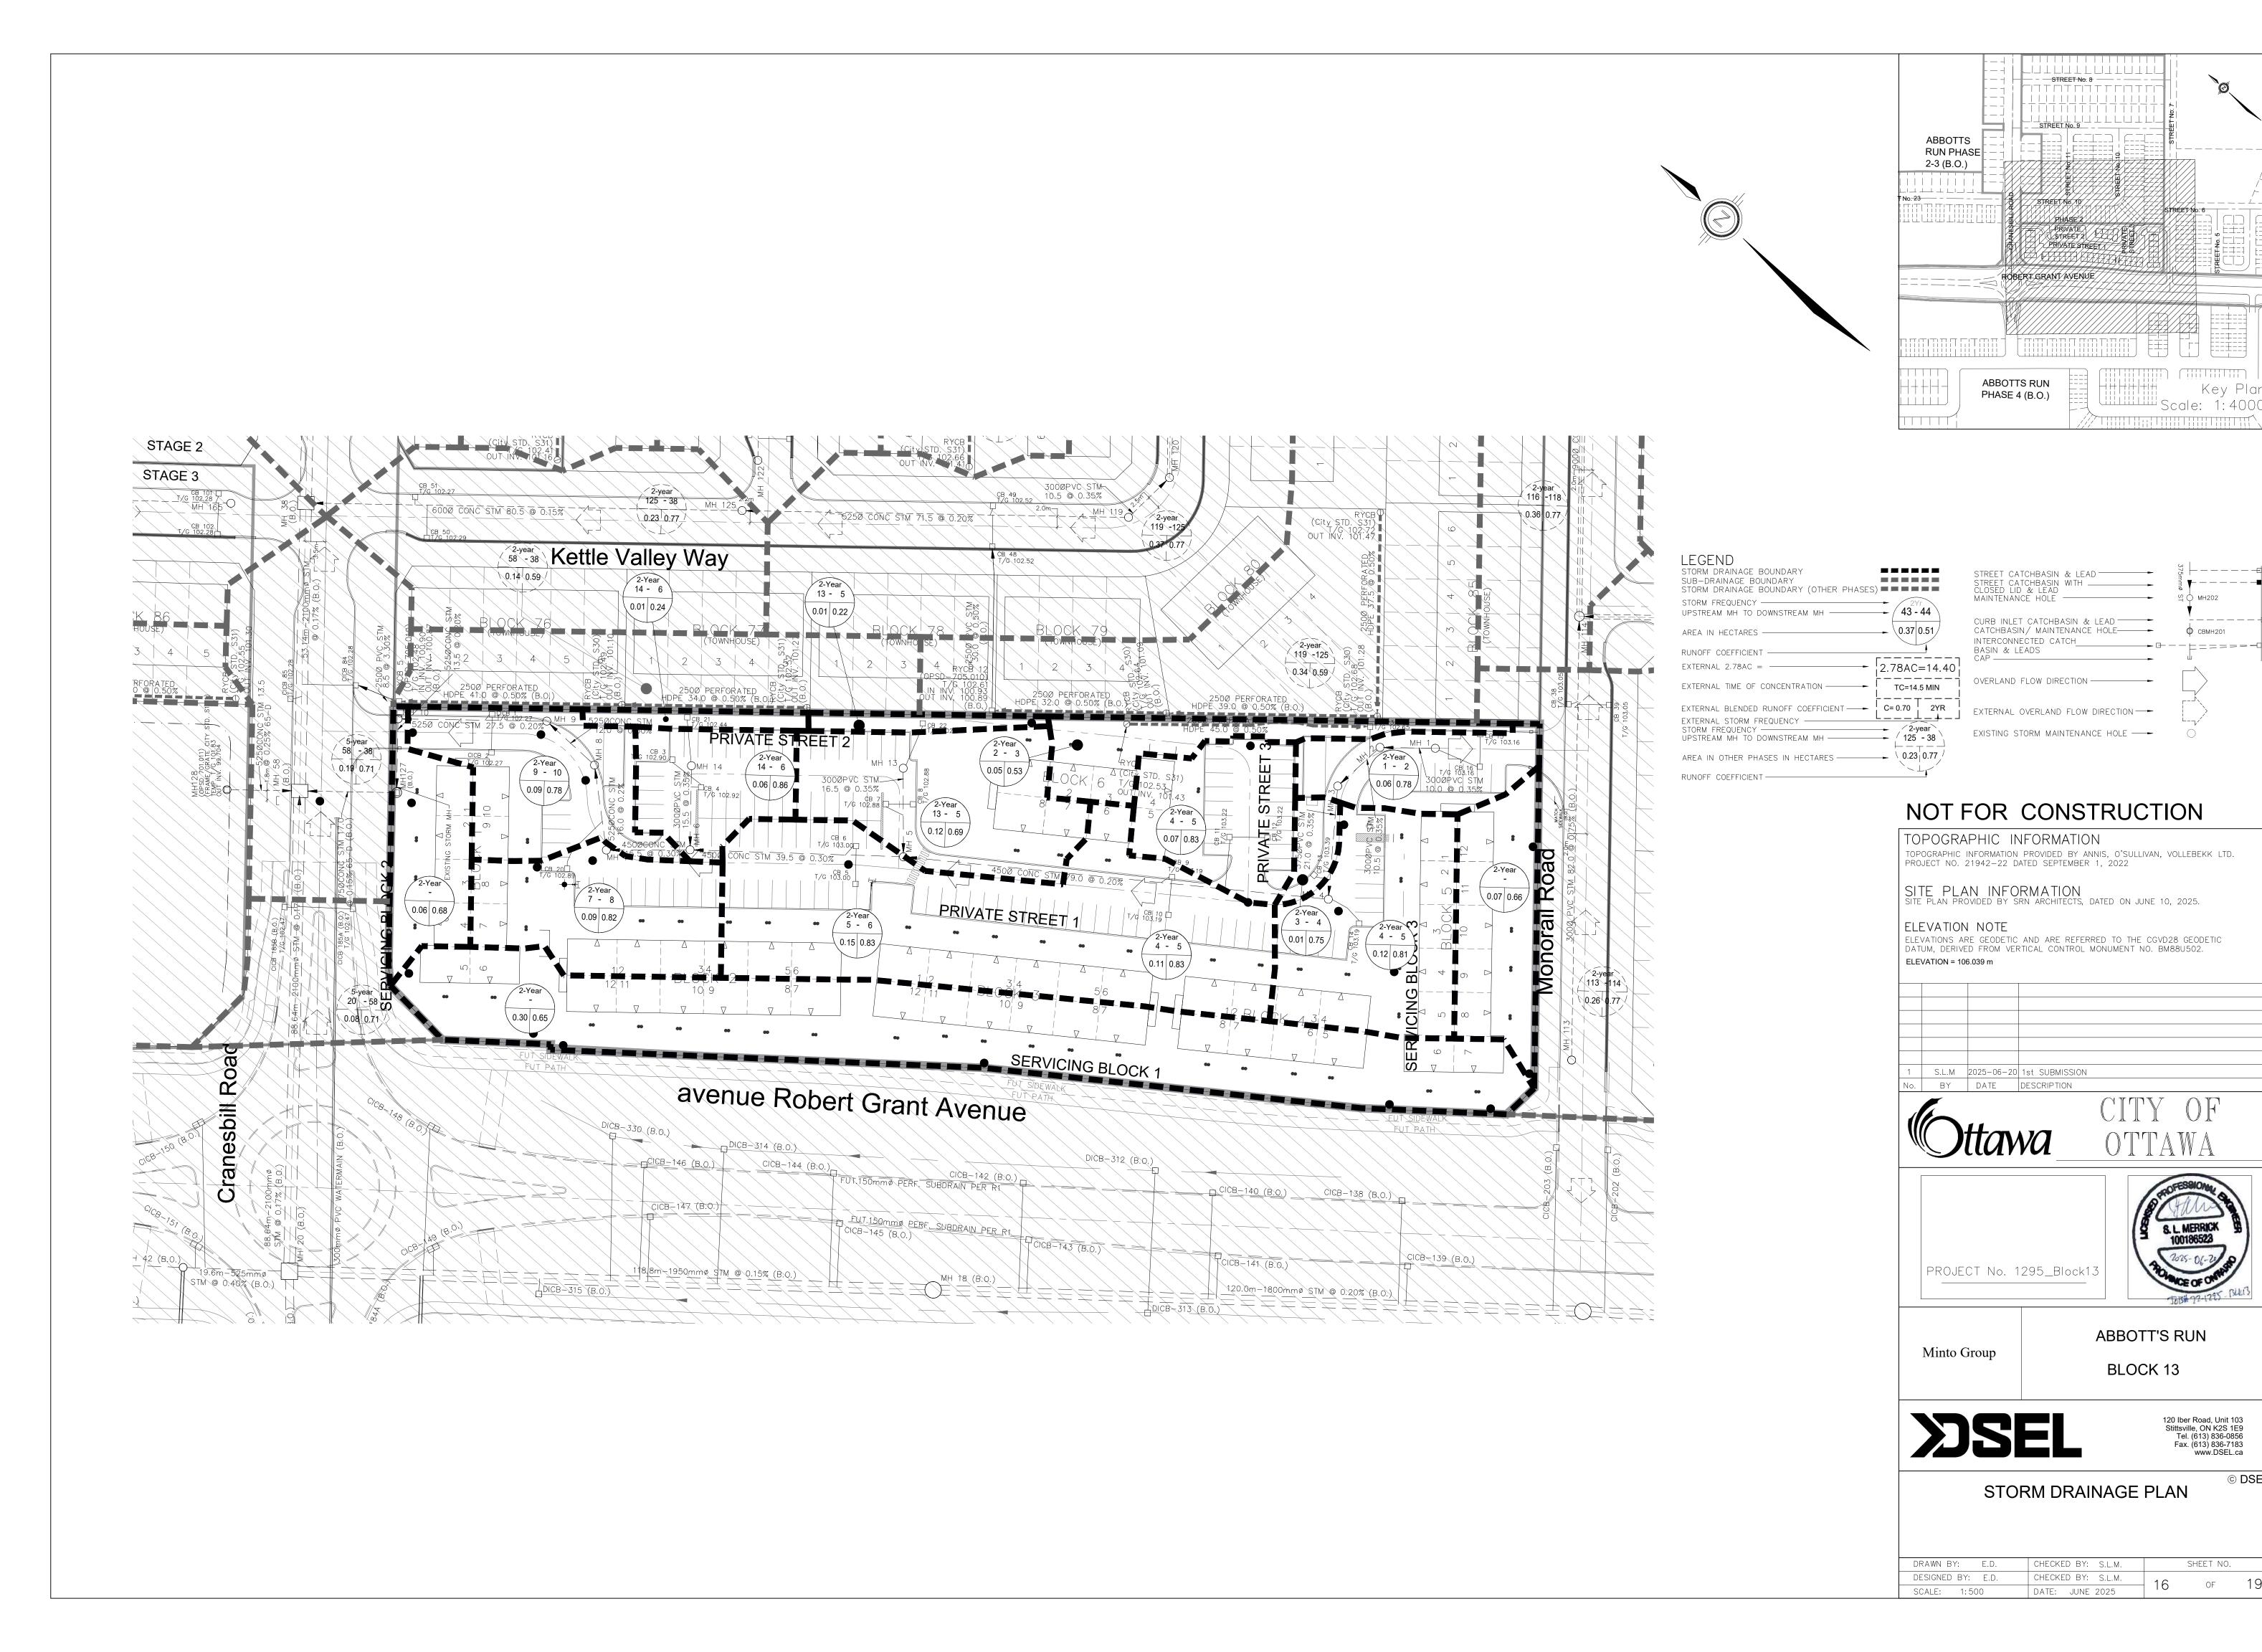

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			100 Ye	ar Ponding Stre	ss Test			
PONDING AREA	CB ID		T/G	100 YEAR PONDING ELEVATION		100 YEAR +20% PONDING ELEVATION		ICD Size (m)
				Elevation(m)	Depth(m)	Elevation(m)	Depth(m)	
PA-1	CB_1	CB_2	102.27	102.59	0.32	102.62	0.35	0.083
PA-10	CB_20		102.89	103.05	0.16	103.07	0.18	0.094
PA-2	CB_3	CB_4	102.90	103.03	0.13	103.08	0.18	0.083
PA-3	CB_7	CB_8	102.88	103.10	0.22	103.31	0.43	0.083
PA-4	CB_5	CB_6	103.00	103.22	0.22	103.30	0.3	0.108
PA-5	CB_9	CB_10	103.19	103.37	0.18	103.45	0.26	0.094
PA-6	CB_11	CB_12	103.22	103.32	0.1	103.36	0.14	0.083
PA-7	CB_13		103.39	103.39	0	103.57	0.18	0.083
PA-8	CB_14		103.19	103.48	0.29	103.63	0.44	0.094
PA-9	CB_15	CB_16	103.16	103.26	0.1	103.28	0.12	0.083

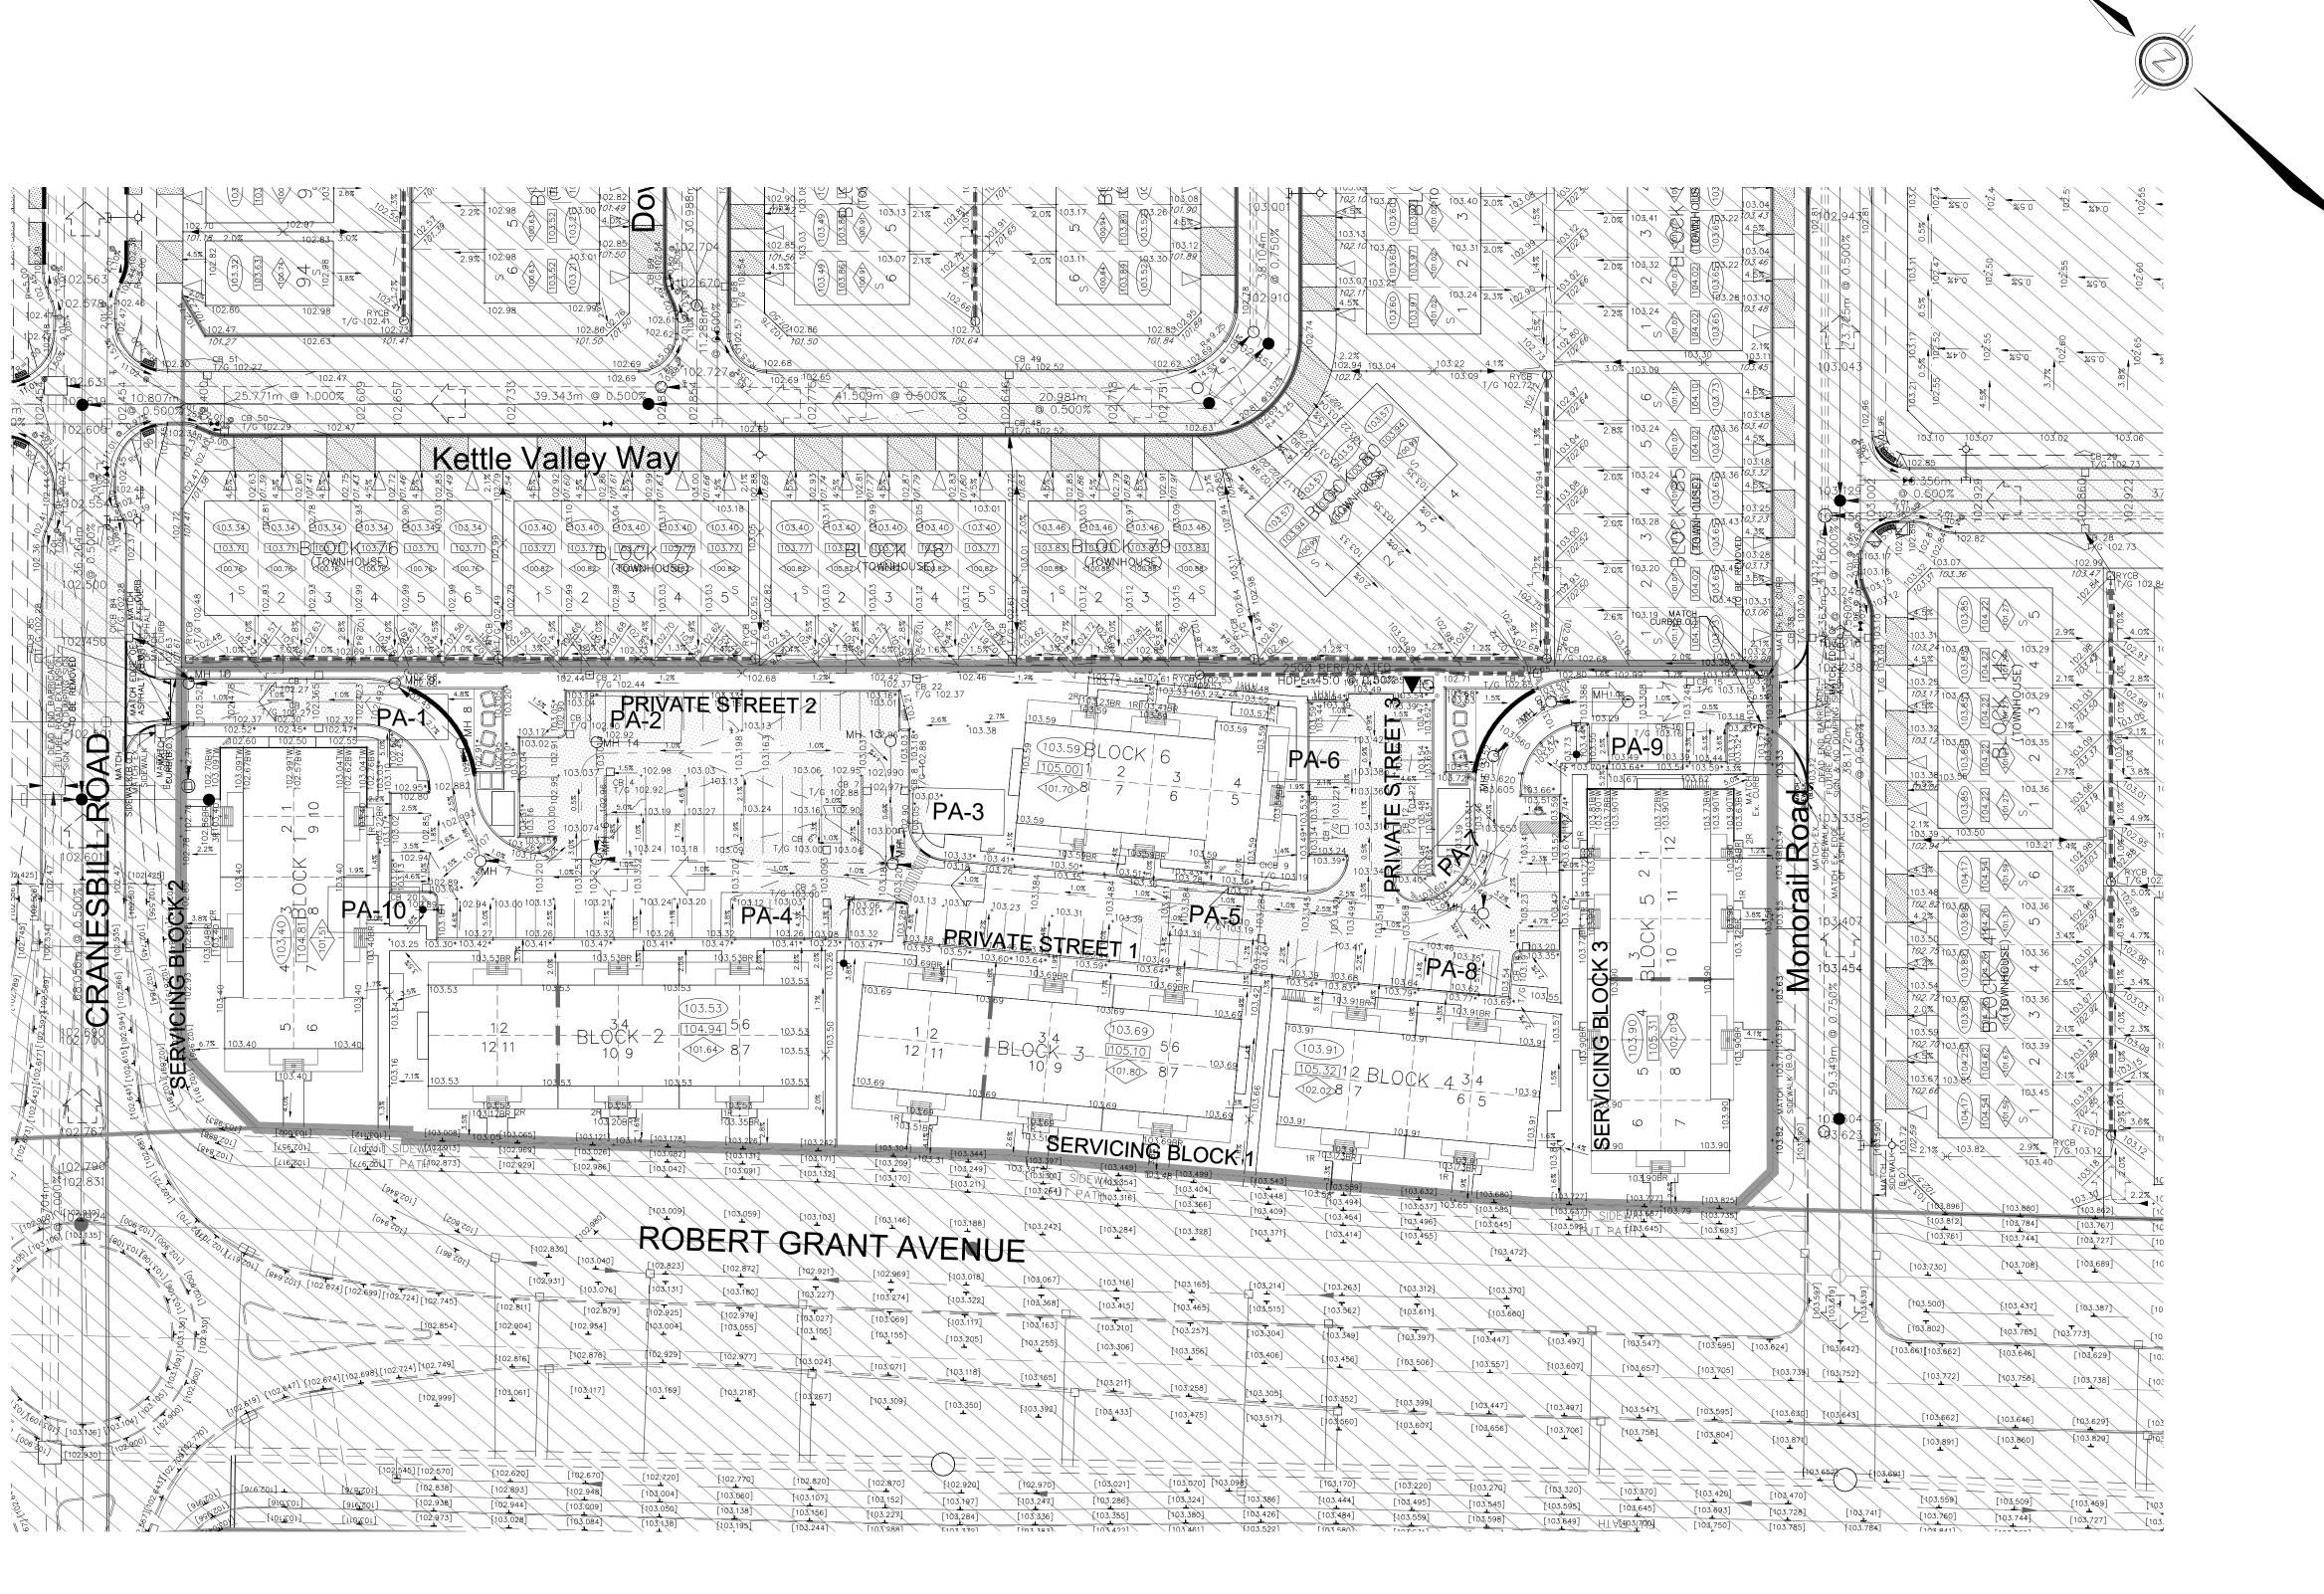

LEGEND:	
PONDING AREA	
EXISTING ELEVATION	93.50
PROPOSED ELEVATION	95.00
CONTOUR ELEVATION —	92.00
OVERLAND FLOW DIRECTION	
STORM MAINTENANCE HOLE	MH 97

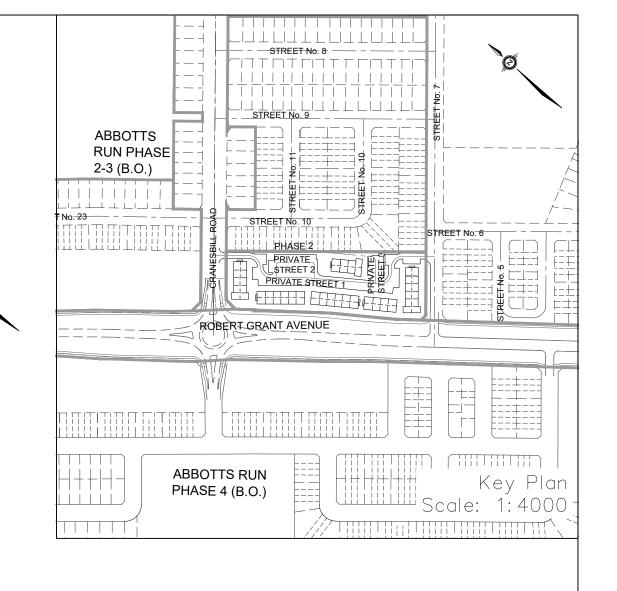NOT FOR CONSTRUCTION

TOPOGRAPHIC INFORMATION

PROJECT NO. 21942-22 DATED SEPTEMBER 1, 2022

SITE PLAN INFORMATION SITE PLAN PROVIDED BY SRN ARCHITECTS, DATED ON JUNE 10, 2025.

ELEVATION NOTE

ELEVATIONS ARE GEODETIC AND ARE REFERRED TO THE CGVD28 GEODETIC DATUM, DERIVED FROM VERTICAL CONTROL MONUMENT NO. BM88U502.

ELEVATION = 106.039 m

TOPOGRAPHIC INFORMATION PROVIDED BY ANNIS, O'SULLIVAN, VOLLEBEKK LTD.


S.L.M 2025-06-20 1st SUBMISSION

No. BY DATE DESCRIPTION

Ottawa

CITY OF OTTAWA

PROJECT No. 1295_Block13

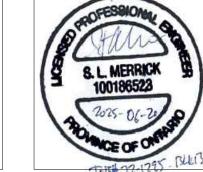

Minto Group


ABBOTT'S RUN
BLOCK 13



120 Iber Road, Unit 103 Stittsville, ON K2S 1E9 Tel. (613) 836-0856 Fax. (613) 836-7183 www.DSEL.ca

100 YEAR + 20% PONDING AREA PLAN
AND ICD PLAN

DRAWN BY: E.D.	CHECKED BY: S.L.M.		SHEET NO.	
DESIGNED BY: E.D.	CHECKED BY: S.L.M.	17	ΩF	10
SCALE: 1:500	DATE: JUNE 2025	/	OF	19

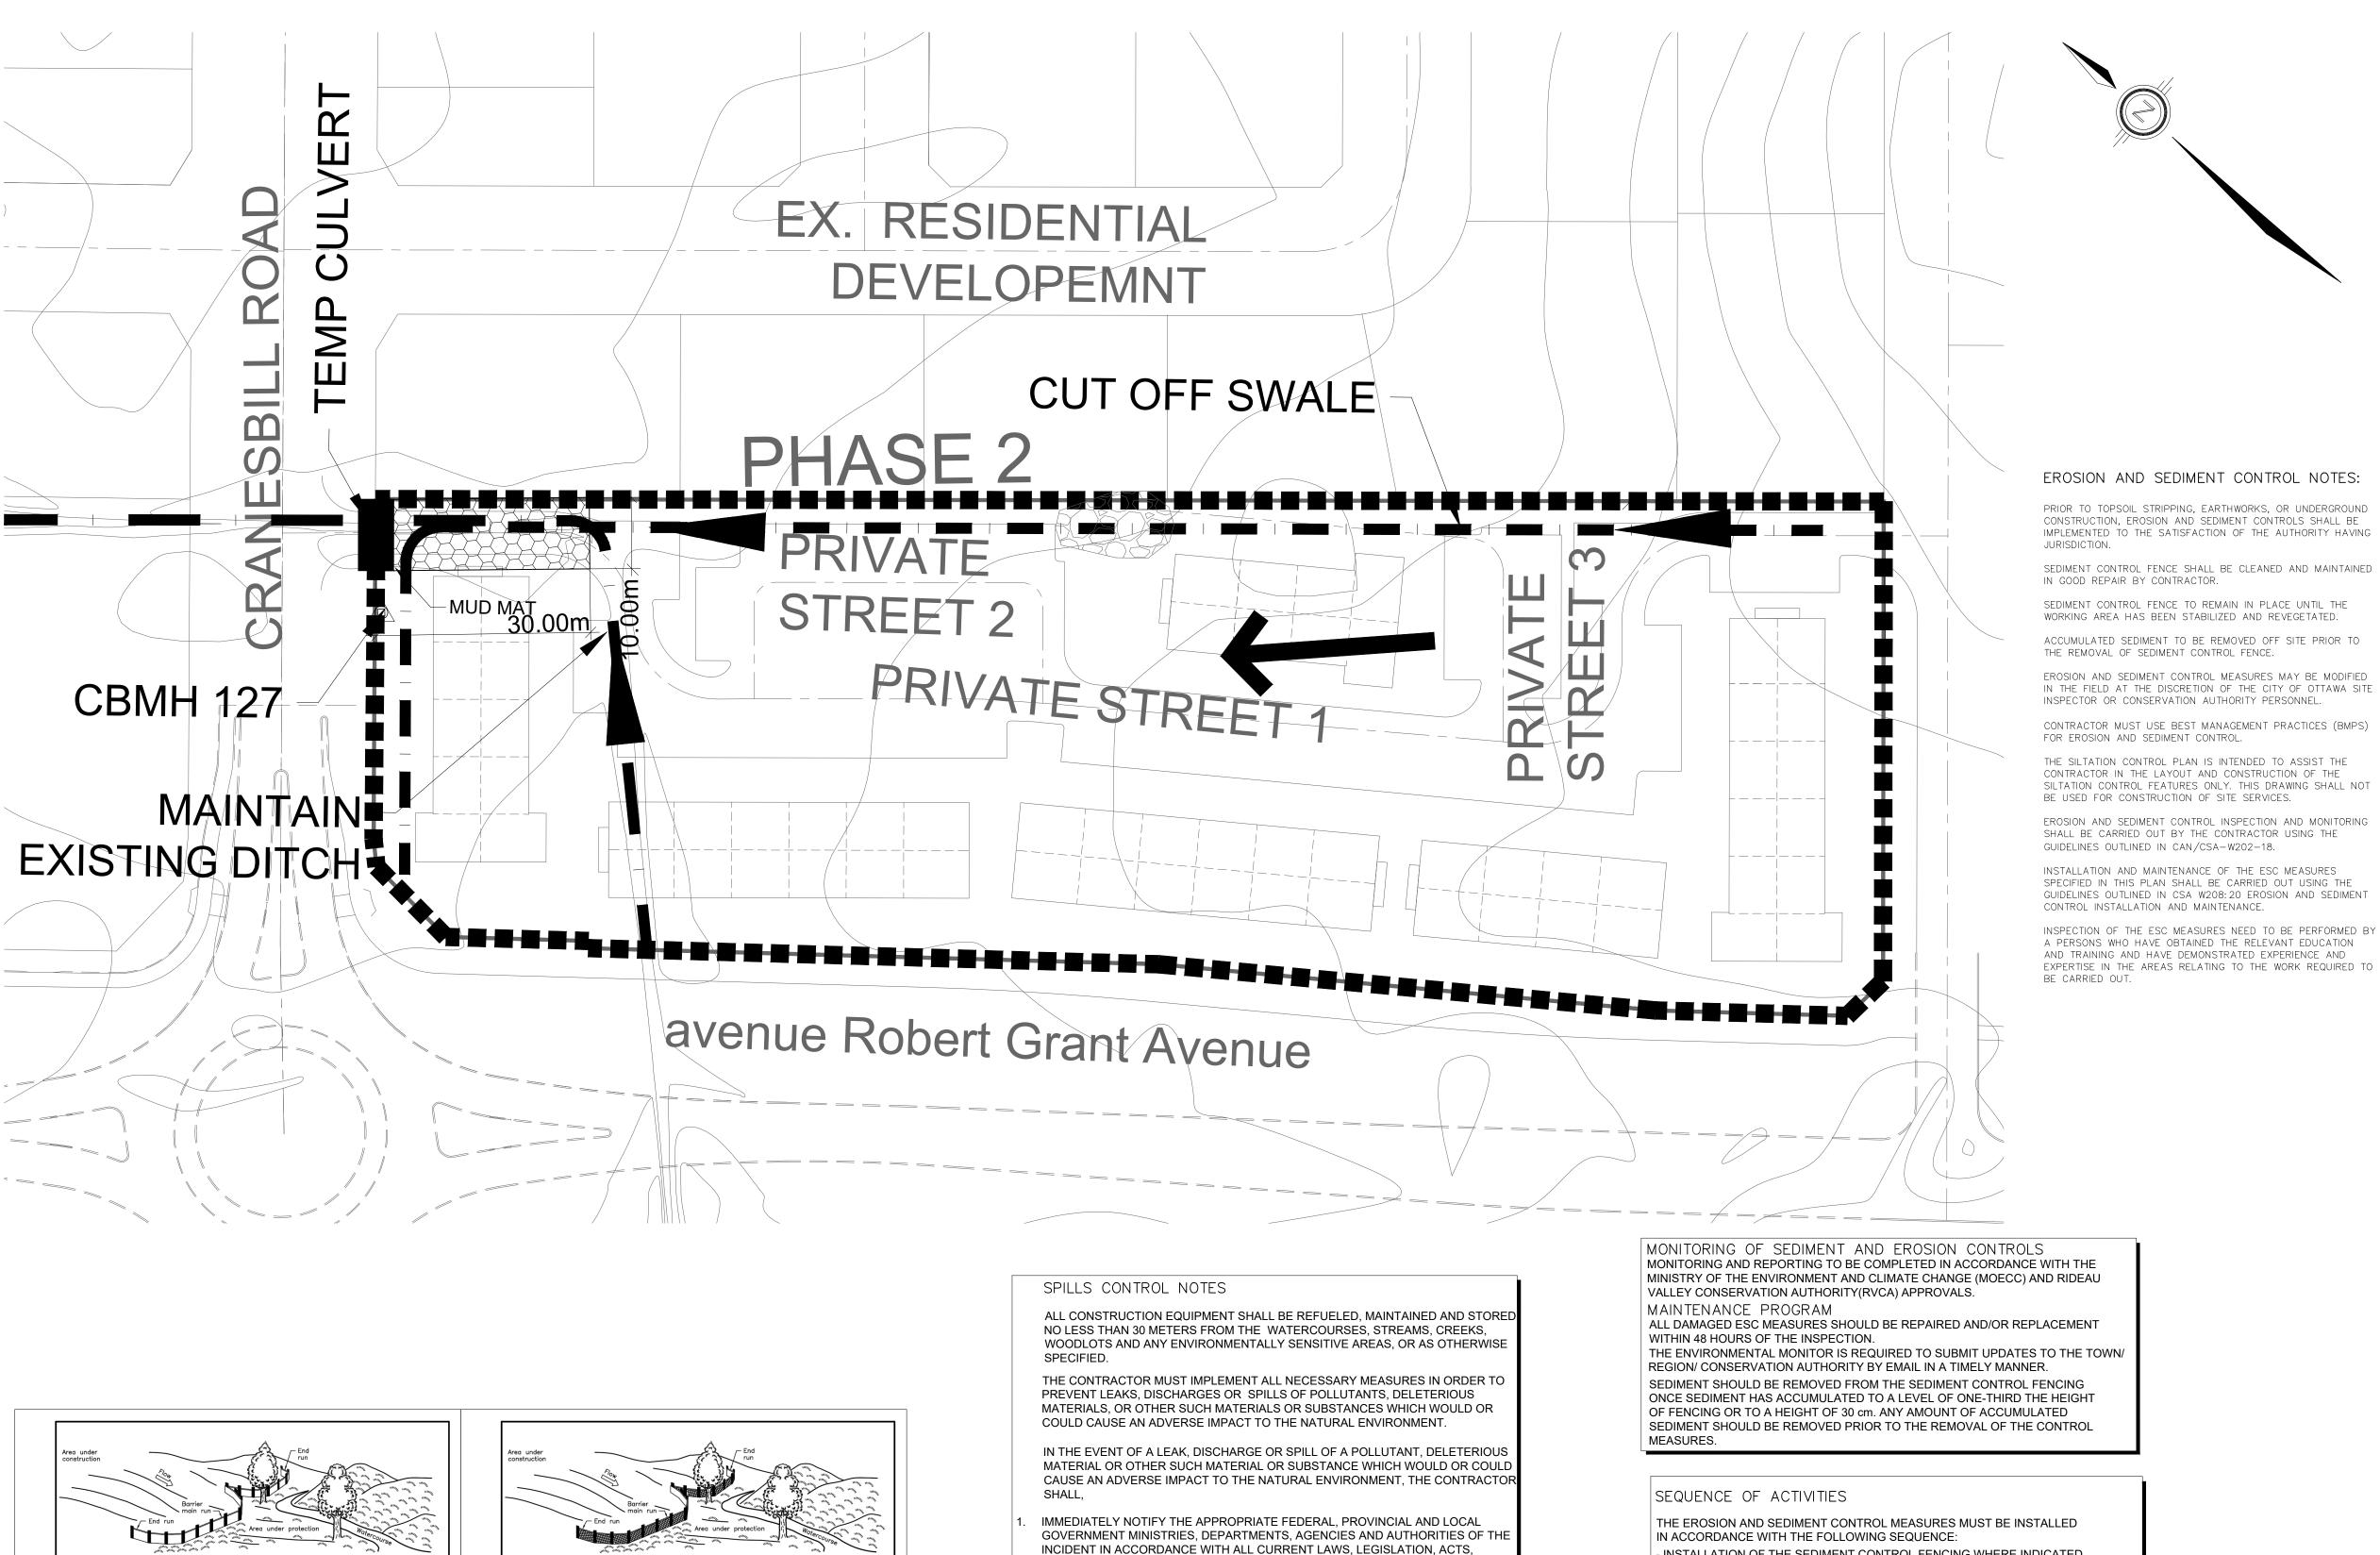

- INCIDENT IN ACCORDANCE WITH ALL CURRENT LAWS, LEGISLATION, ACTS, BY-LAWS, PERMITS, APPROVALS, ETC.
- TAKE IMMEDIATE MEASURES TO CONTAIN THE MATERIAL OR SUBSTANCE, AND T TAKE SUCH MEASURES AS THEY DEEM APPROPRIATE TO MITIGATE AGAINST THI ANY ADVERSE IMPACTS TO THE NATURAL ENVIRONMENT.
- THE CONTRACT SHALL RESTORE THE AFFECTED AREA TO ORIGINAL CONDITION OR BETTER, ALL TO THE SATISFACTION OF THE AUTHORITIES HAVING JURISDICTION.

50mm DIAMETER CLEAR STONE FOR THE FIRST 10m -150mm DIAMETER CLEAR STONE FOR THE REMAINDER OF THE LENGTH

TERRAFIX 270R MUD MAT DETAIL SCALE N.T.S.

2m max

300mm min— of geotextile in trench

SECTION A-A

A All dimensions are in millimetres unless otherwise shown

ONTARIO PROVINCIAL STANDARD DRAWING

HEAVY-DUTY

SILT FENCE BARRIER

Trench shall be backfilled and compacted

SECTION A-A

SILT FENCE BARRIER

All dimensions are in millimetres unless otherwise silomin.

ONTARIO PROVINCIAL STANDARD DRAWING Nov 2021 Rev 3

LIGHT-DUTY

OPSD 219.110

- INSTALLATION OF THE SEDIMENT CONTROL FENCING WHERE INDICATED.

- REMOVAL OF SITE VEGETATION IN ACCORDANCE WITH ALL APPLICABLE BY-LAWS, - CONSTRUCTION OF THE EROSION AND SEDIMENT CONTROL POND IN ACCORDANCE WITH THE DESIGN DRAWINGS.

- REGULAR MONITORING OF THE SEDIMENT CONTROL FENCES BY THE CONTRACTOR TO VERIFY THAT THE FENCES ARE FUNCTIONING AS INTENDED. - REGULAR MONITORING OF THE SEDIMENT BASIN TO VERIFY THAT THE BASIN IS FUNCTIONING AS INTENDED. - REMOVAL OF THE EROSION AND SEDIMENT CONTROL DEVICES ONCE THE SITE

HAS BEEN STABILIZED.

STEEL OR WOODEN POST INSTALLED AT 3.0m C/C MAX. 270R OR APPROVED EQUAL FILTER FABRIC TO BE TERRAFIX 270R OR APPROVED EQUAL. FILTER FABRIC TO BE FOLDED OVER AND FILTER CLOTH FOLDED OVER STAPLED TO THE SNOW FENCE. - 1.2m 9 GAUGE FARM FENCE FILTER FABRIC LAID IN DITCH ON UPSTREAM SIDE OF FENCE AND BACKFILLED WITH CLEAR STONE. TYPICAL INSTALLATION FROZEN INSTALLATION

SILT CONTROL FENCE

STREET No. 8 -**RUN PHASE** 2-3 (B.O.) PRIVATE STREET PHASE 4 (B.O.)

LEGEND PROPOSED SILT FENCE

MAJOR OVERLAND FLOW DIRECTION

CENTERLINE GRADE

EXISTING CONTOUR ELEVATION PROPOSED ROCK FLOW CHECK DAM (OPSD 219.210)

SWALE PROPOSED SWALE

NOT FOR CONSTRUCTION

TOPOGRAPHIC INFORMATION

TOPOGRAPHIC INFORMATION PROVIDED BY ANNIS, O'SULLIVAN, VOLLEBEKK LTD.

SITE PLAN INFORMATION ITE PLAN PROVIDED BY SRN ARCHITECTS, DATED ON JUNE 10, 2025.

ELEVATION = 106.039 m

ELEVATION NOTE ELEVATIONS ARE GEODETIC AND ARE REFERRED TO THE CGVD28 GEODETIC DATUM, DERIVED FROM VERTICAL CONTROL MONUMENT NO. BM88U502.

S.L.M 2025-06-20 1st SUBMISSION

BY DATE DESCRIPTION

PROJECT No. 1295_Block13

Minto Group

ABBOTT'S RUN BLOCK 13


Tel. (613) 836-0856 Fax. (613) 836-7183

EROSION AND SEDIMENT CONTROL PLAN

DRAWN BY: E.D. CHECKED BY: S.L.M. SHEET NO DESIGNED BY: E.D. CHECKED BY: S.L.M. SCALE: 1:500 DATE: JUNE 2025


STAGE 1

DETAIL FOR STREET CB SILT PROTECTION SCALE: NTS

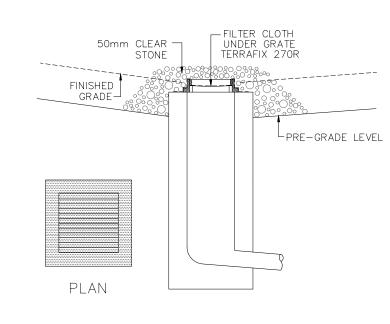

DETAIL FOR RLCB/DICB SILT PROTECTION

SCALE: NTS

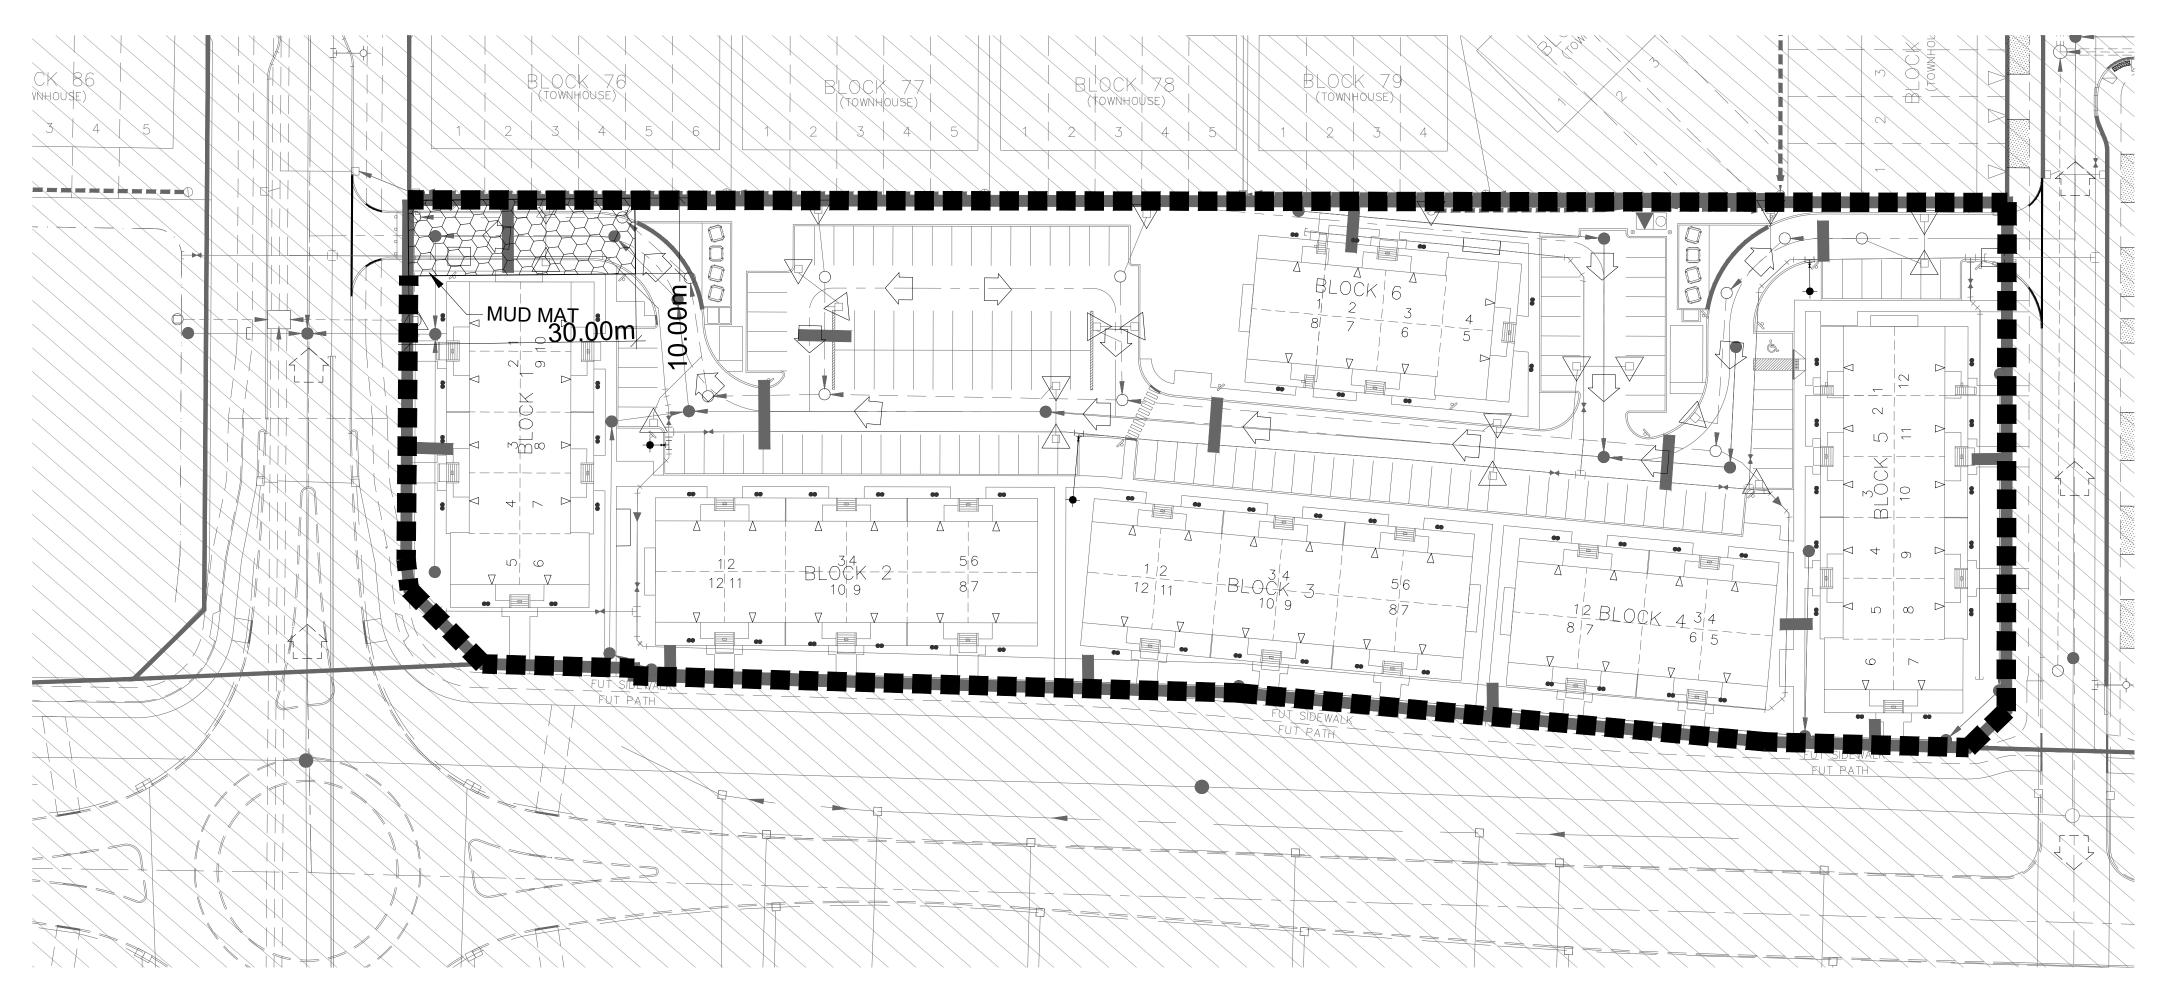

EROSION AND SEDIMENT CONTROL NOTES:

PRIOR TO TOPSOIL STRIPPING, EARTHWORKS, OR UNDERGROUND CONSTRUCTION, EROSION AND SEDIMENT CONTROLS SHALL BE IMPLEMENTED TO THE SATISFACTION OF THE AUTHORITY HAVING JURISDICTION.

SEDIMENT CONTROL FENCE SHALL BE CLEANED AND MAINTAINED IN GOOD REPAIR BY CONTRACTOR.

SEDIMENT CONTROL FENCE TO REMAIN IN PLACE UNTIL THE WORKING AREA HAS BEEN STABILIZED AND REVEGETATED.

ACCUMULATED SEDIMENT TO BE REMOVED OFF SITE PRIOR TO THE REMOVAL OF SEDIMENT CONTROL FENCE.

EROSION AND SEDIMENT CONTROL MEASURES MAY BE MODIFIED IN THE FIELD AT THE DISCRETION OF THE CITY OF OTTAWA SITE INSPECTOR OR CONSERVATION AUTHORITY PERSONNEL.

CONTRACTOR MUST USE BEST MANAGEMENT PRACTICES (BMPS) FOR EROSION AND SEDIMENT CONTROL.

THE SILTATION CONTROL PLAN IS INTENDED TO ASSIST THE CONTRACTOR IN THE LAYOUT AND CONSTRUCTION OF THE SILTATION CONTROL FEATURES ONLY. THIS DRAWING SHALL NOT BE USED FOR CONSTRUCTION OF SITE SERVICES.

EROSION AND SEDIMENT CONTROL INSPECTION AND MONITORING SHALL BE CARRIED OUT BY THE CONTRACTOR USING THE

GUIDELINES OUTLINED IN CAN/CSA-W202-18.

INSTALLATION AND MAINTENANCE OF THE ESC MEASURES SPECIFIED IN THIS PLAN SHALL BE CARRIED OUT USING THE GUIDELINES OUTLINED IN CSA W208:20 EROSION AND SEDIMENT CONTROL INSTALLATION AND MAINTENANCE.

INSPECTION OF THE ESC MEASURES NEED TO BE PERFORMED BY A PERSONS WHO HAVE OBTAINED THE RELEVANT EDUCATION AND TRAINING AND HAVE DEMONSTRATED EXPERIENCE AND EXPERTISE IN THE AREAS RELATING TO THE WORK REQUIRED TO BE CARRIED OUT.

MONITORING OF SEDIMENT AND

EROSION CONTROLS

MONITORING AND REPORTING TO BE COMPLETED IN ACCORDANCE WITH THE MINISTRY OF THE ENVIRONMENT, CONSERVATION, AND PARKS (MECP) AND RIDEAU VALLEY CONSERVATION

AUTHORITY(RVCA) APPROVALS.

MAINTENANCE PROGRAM
ALL DAMAGED ESC MEASURES SHOULD BE

REPAIRED AND/OR REPLACEMENT WITHIN 48
HOURS OF THE INSPECTION. THE ENVIRONMENTAL
MONITOR IS REQUIRED TO SUBMIT UPDATES TO
THE TOWN/ REGION/ CONSERVATION AUTHORITY

THE TOWN/ REGION/ CONSERVATION AUTHORITY
BY EMAIL IN A TIMELY MANNER. SEDIMENT SHOULD
BE REMOVED FROM THE SEDIMENT CONTROL
FENCING ONCE SEDIMENT HAS ACCUMULATED TO
A LEVEL OF ONE-THIRD THE HEIGHT OF FENCING
OR TO A HEIGHT OF 30 cm. ANY AMOUNT OF

ACCUMULATED SEDIMENT SHOULD BE REMOVED PRIOR TO THE REMOVAL OF THE CONTROL MEASURES.

LEGEND
PROPOSED SILT FENCE

PHASE 4 (B.O.)

STREET No. 8

PRIVATE STREET

STORM DRAIN INLET PROTECTION

MAJOR OVERLAND FLOW DIRECTION

RUN PHASE 2-3 (B.O.)

NOT FOR CONSTRUCTION

TOPOGRAPHIC INFORMATION

TOPOGRAPHIC INFORMATION PROVIDED BY ANNIS, O'SULLIVAN, VOLLEBEKK LTD. PROJECT NO. 21942—22 DATED SEPTEMBER 1, 2022

SITE PLAN INFORMATION SITE PLAN PROVIDED BY SRN ARCHITECTS, DATED ON JUNE 10, 2025.

ELEVATION NOTE

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ELEVATION = 106.039 m

1 S.L.M 2025-06-20 1st SUBMISSION
No. BY DATE DESCRIPTION



Minto Group

CITY OF OTTAWA

PROJECT No. 1295_Block13

ABBOTT'S RUN BLOCK 13

DSEL


120 Iber Road, Unit 103 Stittsville, ON K2S 1E9 Tel. (613) 836-0856 Fax. (613) 836-7183 www.DSEL.ca


EROSION AND SEDIMENT CONTROL PLAN
STAGE 2

DRAWN BY: E.D. CHECKED BY: S.L.M. SHEET NO.


DESIGNED BY: E.D. CHECKED BY: S.L.M.


SCALE: 1:500 DATE: JUNE 2025

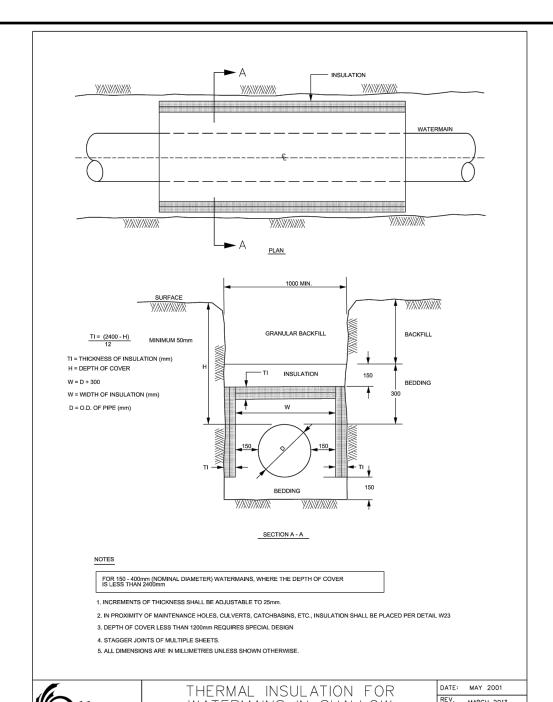


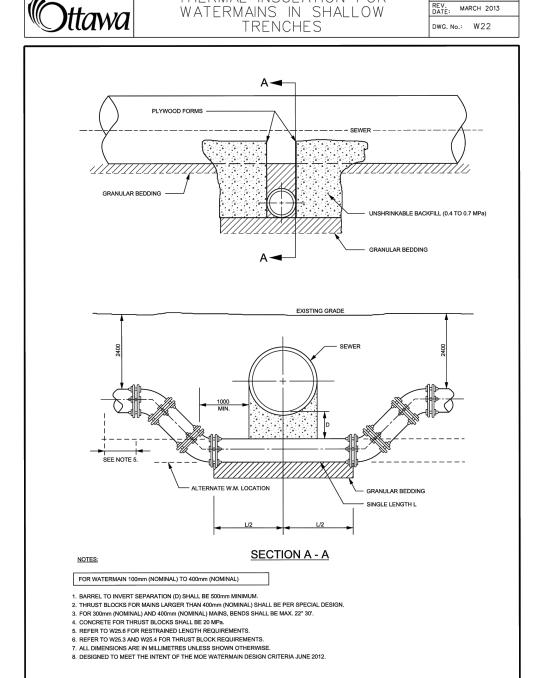


WATERMAIN CROSSING

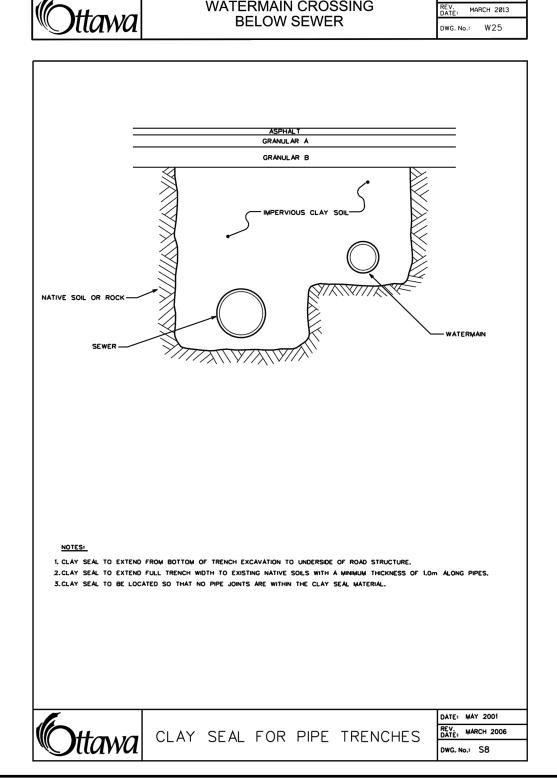


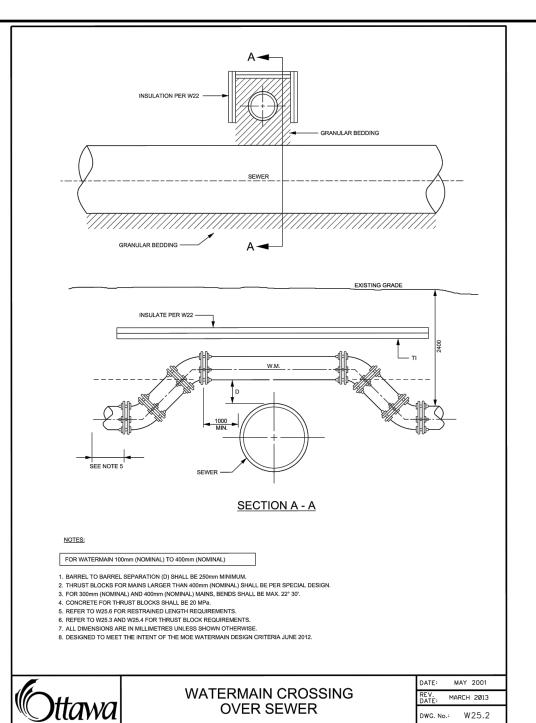


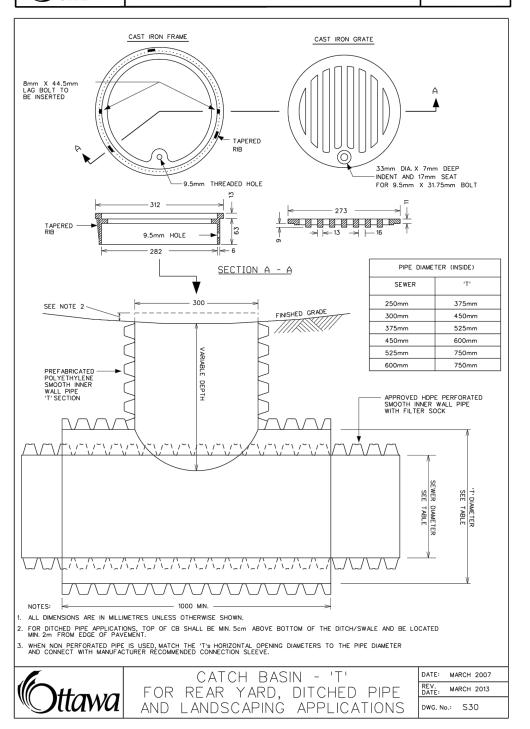


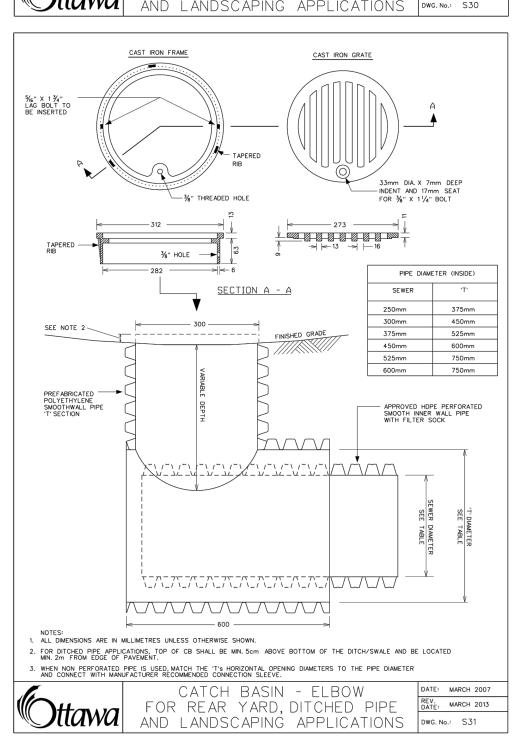


CB & INLET CONTROL DEVICE (ICD) DATA (Circular Orifice Plate)									
STREET NAME	CATCHBASIN ID	PIPE DIA. (mm)	LENGTH (m)	INV. DEPTH (m)	TOP OF GRATE	GRATING COVER	INLET INV (m)	OUTLET INV (m)	ICD DIA. (mm)
PRIVATE STREET 1	CICB_1	200	1.99	1.47	102.27	S22	100.83	100.80	83
PRIVATE STREET 1	CICB_2	200	6.00	1.38	102.27	S22		100.89	
PRIVATE STREET 2	CB_3	200	7.39	1.38	102.90	S19 PERFORATED		101.52	
PRIVATE STREET 2	CB_4	200	1.35	1.50	102.92	S19 PERFORATED	101.45	101.42	83
PRIVATE STREET 1	CB_5	200	6.00	1.38	103.00	S19 PERFORATED		101.62	
PRIVATE STREET 1	CB_6	200	3.02	1.47	103.00	S19 PERFORATED	101.56	101.53	108
PRIVATE STREET 2	CB_7	200	4.30	1.50	102.88	S19 PERFORATED	101.44	101.38	83
PRIVATE STREET 2	CB_8	200	6.01	1.38	102.88	S19 PERFORATED		101.50	
PRIVATE STREET 1	CICB_9	200	2.52	1.47	103.19	S22	101.75	101.72	94
PRIVATE STREET 1	CB_10	200	6.00	1.38	103.19	S19 PERFORATED		101.81	
PRIVATE STREET 1	CB_11	200	9.84	1.50	103.22	S19 PERFORATED	101.78	101.72	83
PRIVATE STREET 1	CB_12	200	6.21	1.38	103.22	S19 PERFORATED		101.84	
PRIVATE STREET 1	CB_13	200	3.93	1.38	103.39	S19 PERFORATED		102.01	83
PRIVATE STREET 1	CB_14	200	6.79	1.38	103.19	S19 PERFORATED		101.81	94
PRIVATE STREET 1	CB_15	200	6.00	1.38	103.16	S19 PERFORATED		101.78	
PRIVATE STREET 1	CB_16	200	8.49	1.47	103.16	S19 PERFORATED	101.72	101.69	83
PRIVATE STREET 1	CB_20	200	10.77	1.38	102.89	S19 PERFORATED		101.51	94
PRIVATE STREET 2	CB_21	200	7.75	1.38	102.44	S19 PERFORATED		101.06	
PRIVATE STREET 2	CB_22	200	7.87	1.38	102.37	S19 PERFORATED		100.99	
PRIVATE STREET 1	CB_23	200	5.08	1.38	102.65	S19 PERFORATED		101.27	

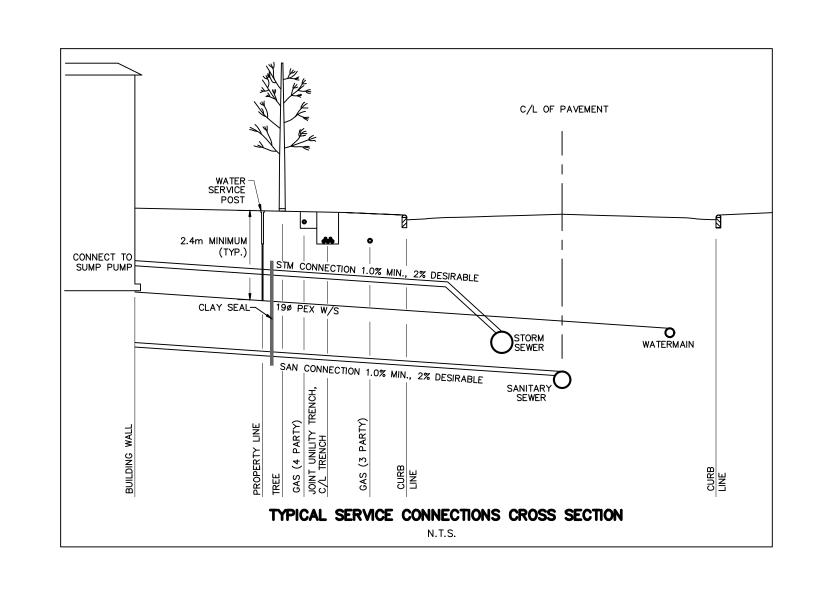

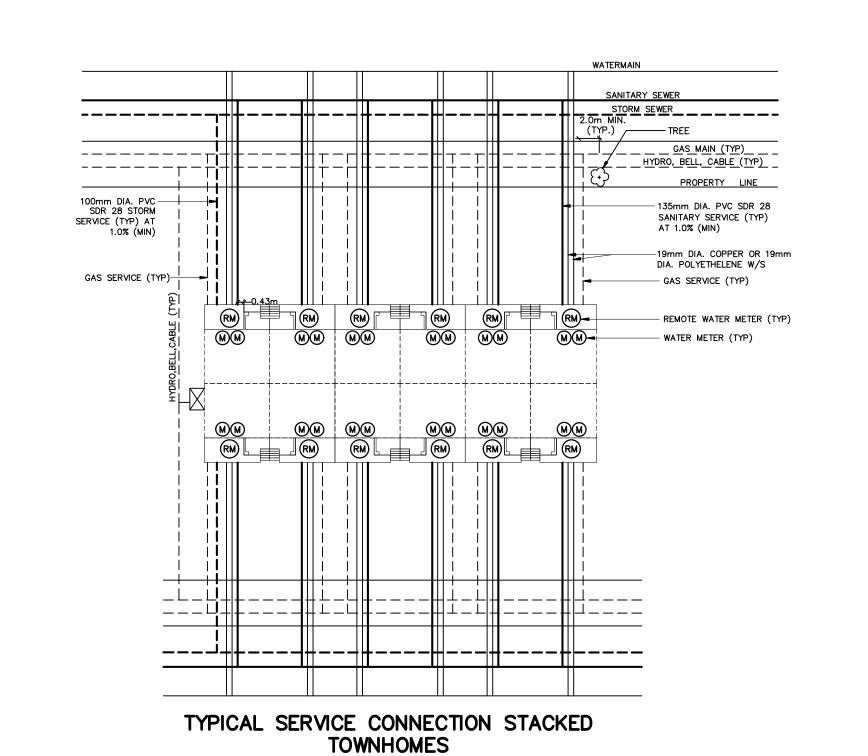

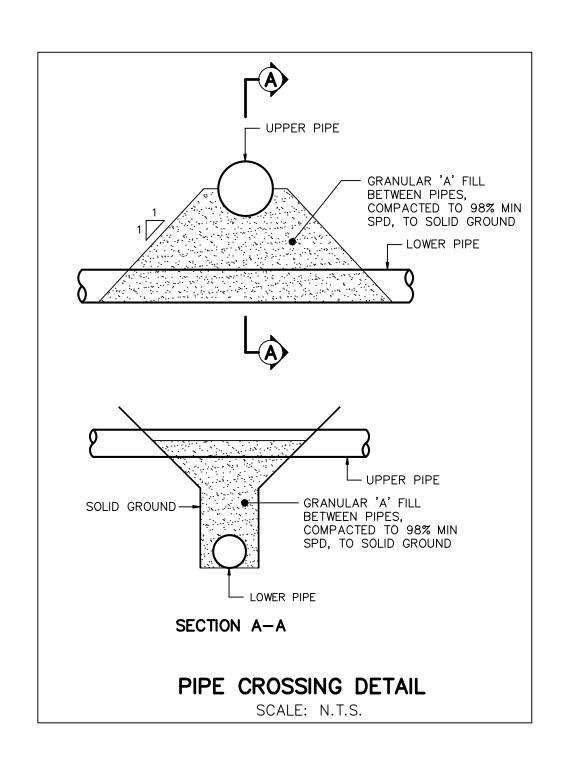

NOT FOR CONSTRUCTION

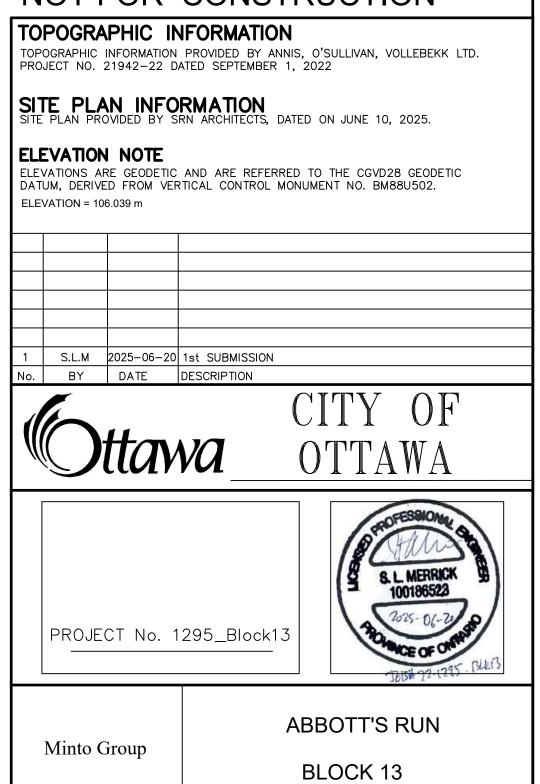

DETAILS AND TABLE

CHECKED BY: S.L.M.

CHECKED BY: S.L.M.

DATE: JUNE 2025

DRAWN BY: E.D.

DESIGNED BY: E.D.

SCALE: 1:500

Stittsville, ON K2S 1E9 Tel. (613) 836-0856 Fax. (613) 836-7183 www.DSEL.ca © DSEL

SHEET NO.

OF

