





ROADSIDE CATCH BASIN PROTECTION DETAIL: TERRAFIX SILTSACK

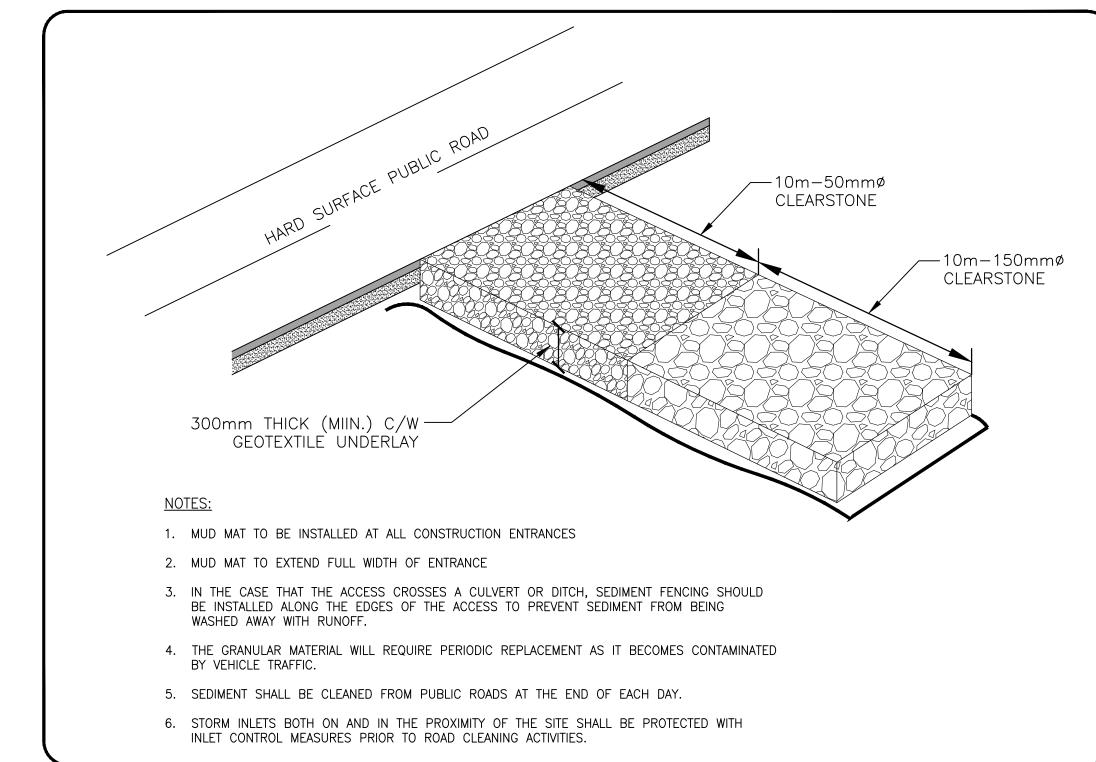



MUD MAT ENTRANCE DETAIL SCALE: N.T.S.

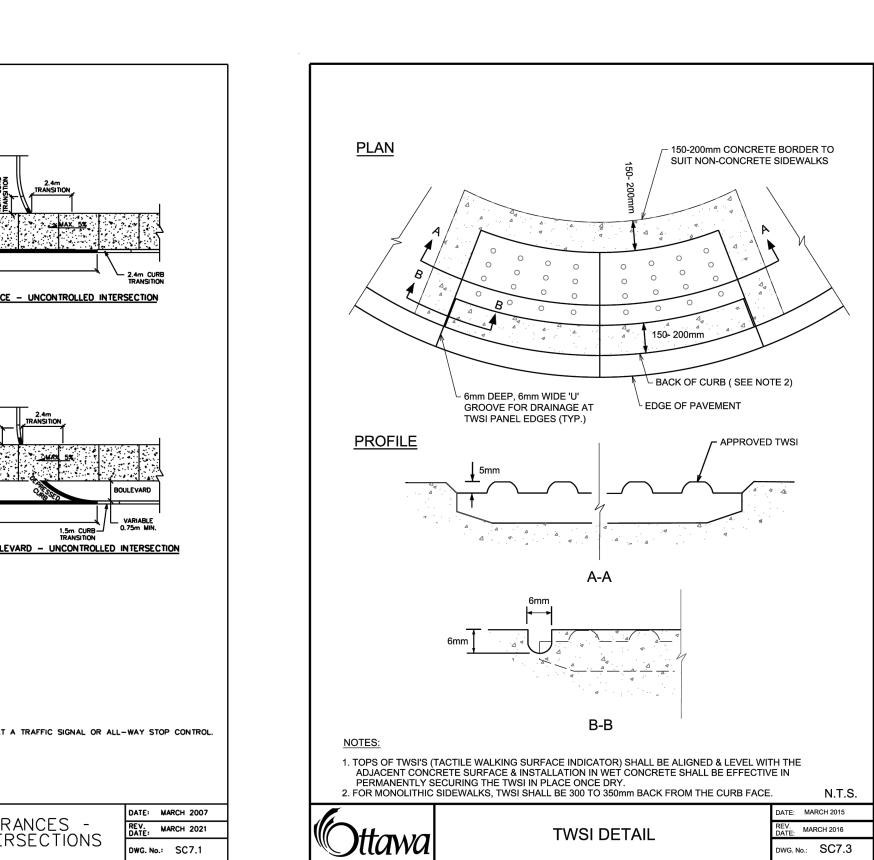


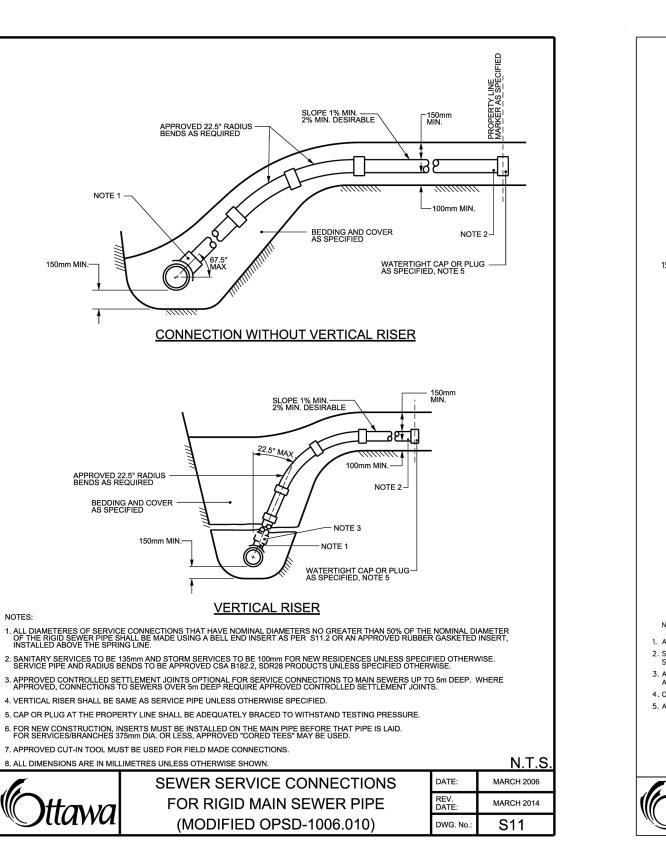


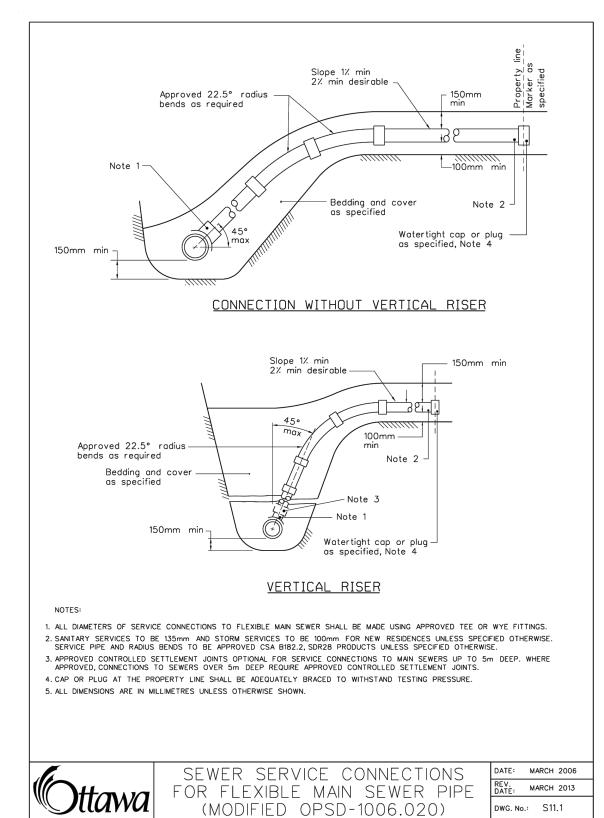

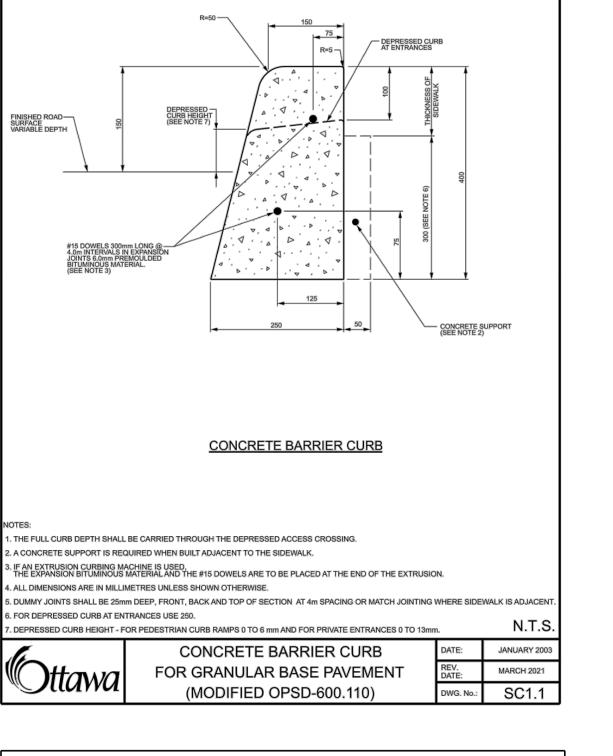

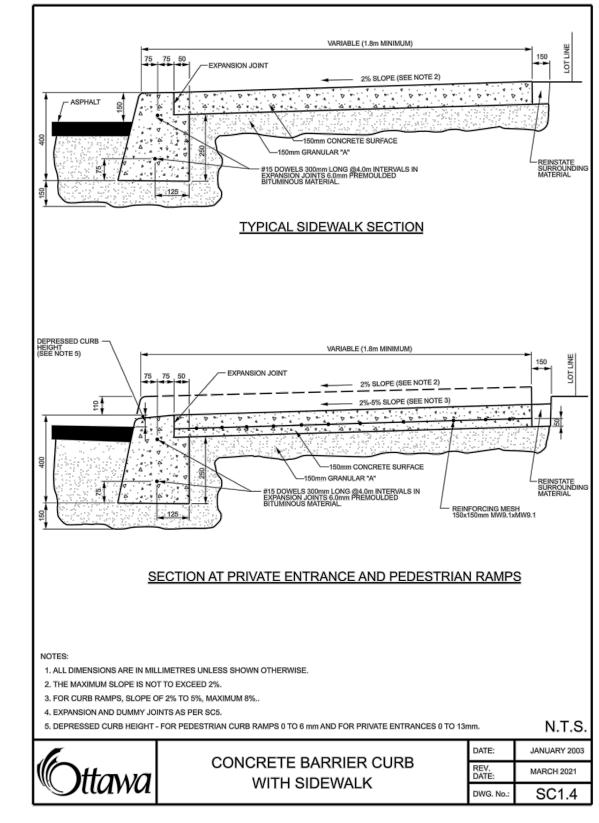

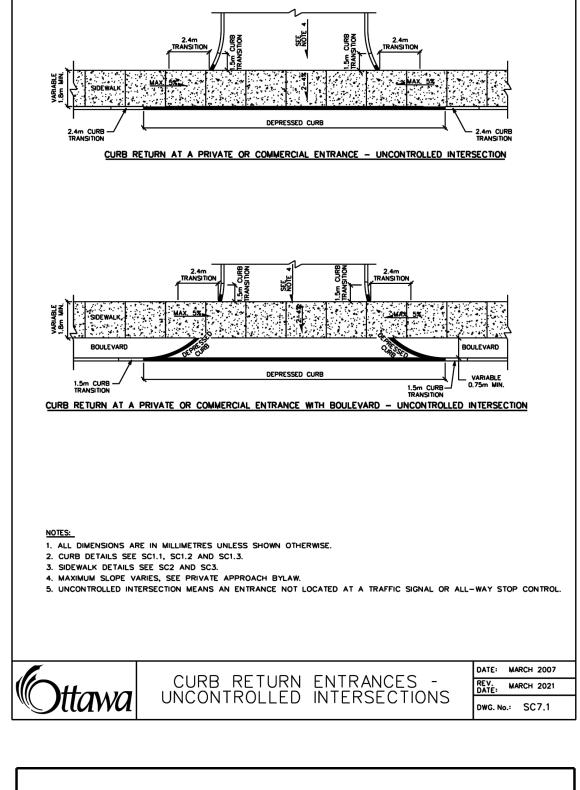


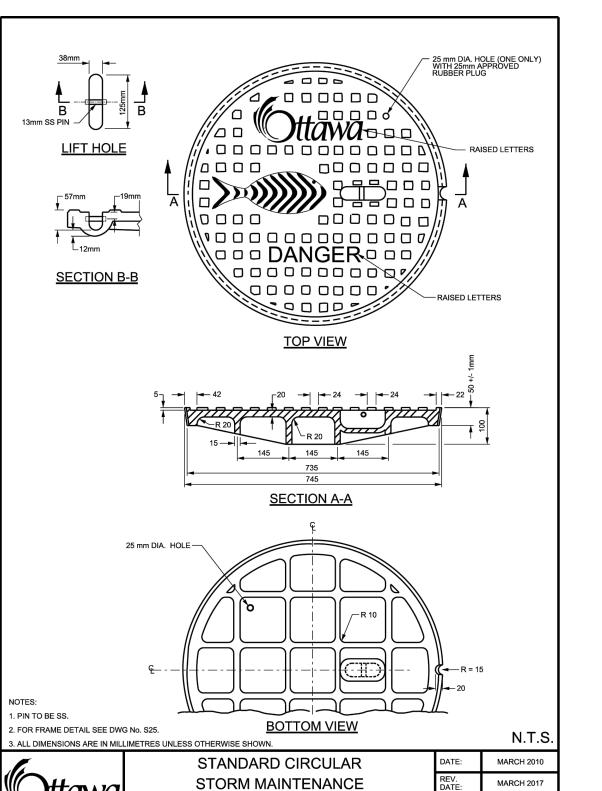



STORM MAINTENANCE

HOLE COVER

DWG. No.: \$24.1

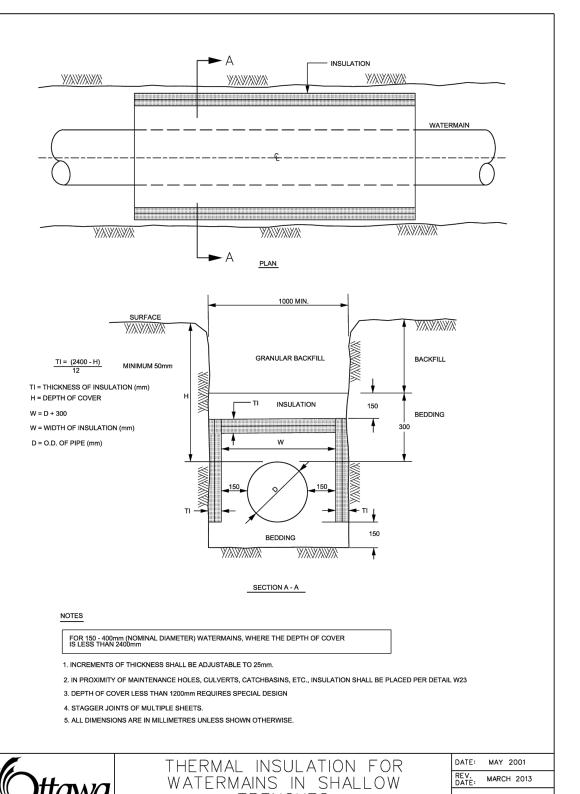

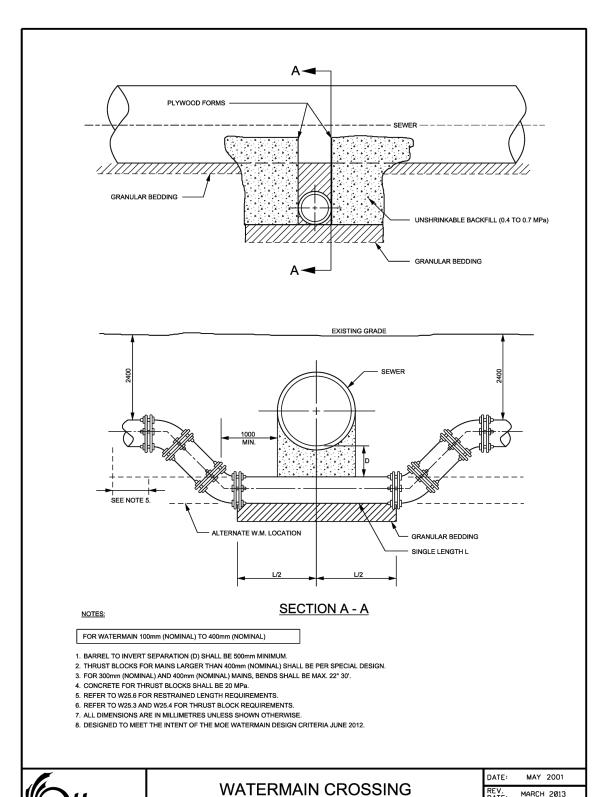

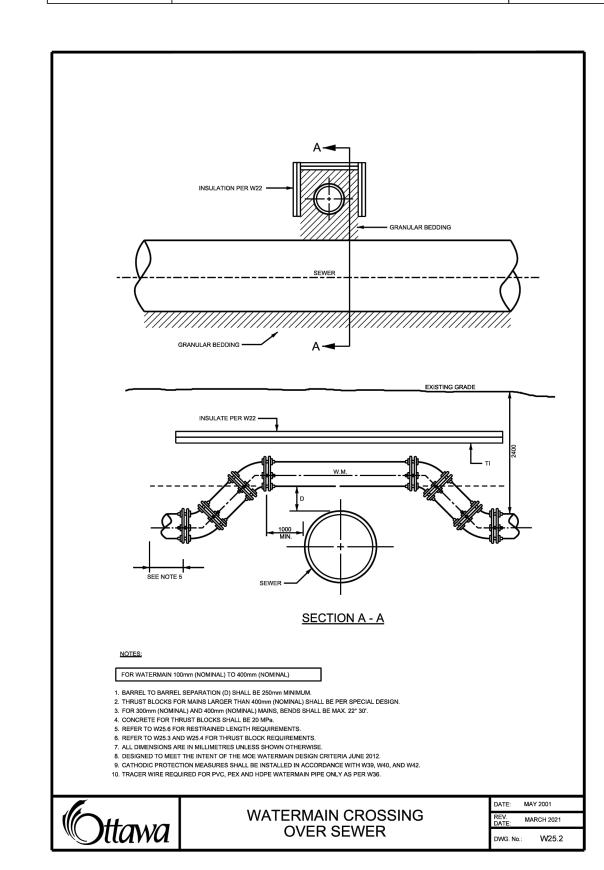



Stantec Consulting Ltd. 400 - 1331 Clyde Avenue Ottawa ON Tel. 613.722.4420 www.stantec.com

Copyright Reserved The Contractor shall verify and be responsible for all dimensions. DO NOT scale the drawing - any errors or omissions shall be reported to

Stantec without delay. The Copyrights to all designs and drawings are the property of Stantec. Reproduction or use for any purpose other than that authorized by Stantec is forbidden.

PROPOSED SILT FENCE BOUNDARY AS PER OPSD 219.110 PROPOSED CATCH BASIN PROTECTION AS PER TERRAFIX SILTSACK DETAIL

PROPOSED MUD MAT LOCATION PROPOSED VALVE BOX

PROPOSED VALVE CHAMBER PROPOSED FIRE HYDRANT PROPOSED SANITARY SEWER MANHOLE PROPOSED STORM SEWER MANHOLE

PROPOSED CATCHBASIN

CONTRACTOR TO PROVIDE EROSION AND SEDIMENT CONTROLS (BEST MANAGEMENT PRACTICES) DURING CONSTRUCTION OF THIS PROJECT. EROSION MUST BE MINIMIZED AND SEDIMENTS MUST BE REMOVED FROM CONSTRUCTION SITE RUN-OFF IN ORDER TO PROTECT DOWNSTREAM AREAS. DURING ALL CONSTRUCTION, EROSION AND SEDIMENTATION SHOULD BE CONTROLLED BY THE

- LIMIT THE EXTENT OF EXPOSED SOILS AT ANY GIVEN TIME. REVEGETATE EXPOSED AREAS AND SLOPES AS SOON AS POSSIBLE.
- MINIMIZE AREA TO BE CLEARED AND GRUBBED.
- PROTECT EXPOSED SLOPES WITH PLASTIC OR SYNTHETIC MULCHES. INSTALL CATCH BASIN INSERTS OR EQUIVALENT IN ALL PROPOSED CATCH BASINS AND CATCH BASIN MANHOLES AND IN ALL EXISTING CATCH BASINS THAT WILL RECEIVE RUN-OFF FROM THE SITE.
- A SILT FENCE SHALL BE INSTALLED AROUND THE PERIMETER OF ALL AND ANY STOCKPILES OF MATERIAL TO BE USED OR REMOVED FROM SITE. (LOCATION TO
- A VISUAL INSPECTION SHALL BE DONE DAILY ON SEDIMENT CONTROL MEASURES AND CLEANED OF ANY ACCUMULATED SILT AS REQUIRED. THE DEPOSITS WILL BE DISPOSED OFF SITE AS PER THE REQUIREMENTS OF THE CONTRACT.
- SEDIMENT CONTROL BARRIERS MAY ONLY BE REMOVED TEMPORARILY WITH APPROVAL OF CONTRACT ADMINISTRATOR TO ACCOMMODATE CONSTRUCTION OPERATIONS, ALL AFFECTED BARRIERS MUST BE REINSTATED AT NIGHT WHEN CONSTRUCTION IS COMPLETED. NO REMOVAL WILL OCCUR IF THERE IS A SIGNIFICANT RAINFALL EVENT ANTICIPATED (>10mm) UNLESS A NEW DEVICE HAS BEEN INSTALLED TO PROTECT EXISTING STORM AND SANITARY SEWER SYSTEMS,
- NO REFUELING OR CLEANING OF EQUIPMENT IS PERMITTED NEAR ANY EXISTING CONTRACTOR SHALL REMOVE SEDIMENT CONTROL MEASURES WHEN, IN THE

OR DOWNSTREAM WATERCOURSES.

- OPINION OF THE CONTRACT ADMINISTRATOR, THE MEASURE(S) IS NO LONGER REQUIRED. NO CONTROL MEASURES SHALL BE PERMANENTLEY REMOVED WITHOUT PRIOR WRITTEN AUTHORIZATION FROM THE CONTRACT
- THE CONTRACTOR SHALL PERIODICALLY, OR WHEN REQUESTED BY THE CONTRACT ADMINISTRATOR, CLEAN OUT ACCUMULATED SEDIMENTS AS
- ACCIDENTAL DISCHARGES OF SEDIMENT MATERIAL INTO THE WATERCOURSE. APPROPRIATE RESPONSE MEASURES, INCLUDING ANY REPAIRS TO EXISTING CONTROL MEASURES OR THE IMPLEMENTATION OF ADDITIONAL CONTROL MEASURES, SHALL BE CARRIED OUT BY THE CONTRACTOR WITHOUT DELAY.

THE CONTRACTOR SHALL IMMEDIATELY REPORT TO THE ENGINEER ANY

- CONTRACTOR SHALL INSTALL MUD MATS AT ENTRANCE TO THE SITE.
- STORMWATER SWALES TO BE COVERED WITH HYDRO-SEED AND MULCH.

REVISION PER 1ST SUBMISSION CITY COMMENTS ISSUED FOR TENDER File Name: 160401916 DB New Access.dwa Permit-Seal

Client/Project RICHCRAFT

> 2750 - 2760 SHEFFIELD ROAD NEW ACCESS ROAD OTTAWA, ONTARIO

EROSION CONTROL PLAN AND **DETAIL SHEET**

Drawing No.

PLAN # 19210

632 — 624 စ္ ပ္က | - 559 - - - -_____ 572 _____ SECTION C-C SECTION A-A -| | | 25 | SECTION D-D -SECTION B-B SOLID ALTERNATE . ALL DIMENSIONS SHOWN ARE FOR FINISHED CASTINGS ONLY. PATTERN MAKERS AND CASTING SHOP SHOULD MAKE ALLOWANCES ACCORDINGLY. 2. ALL DIMENSIONS ARE IN MILLIMETRES UNLESS SHOWN OTHERWISE. 3. FOR NEW CONSTRUCTION WHERE SURFACE INLETS ARE SPECIFIED. 4. COMPANIES WITH GRATE DIMENSIONS NOT EXACTLY THE SAME AS SHOWN ABOVE WILL ALSO BE CONSIDERED. 5. ALTERNATE SOLID COVER TO HAVE EYE 25mm Dio. HOLE WITH 25mm APPROVED PLUG HEAVY DUTY "FISH" TYPE ROUND CATCH BASIN COVER (MODIFIED OPSD-400.07)

FRAME PLAN

FOR DEPRESSED CURB AT ENTRANCES USE 250.


SECTION D-D -PERFORATED

-| -| 25

SEE DETAIL 1

PLAN

13mm SS PIN -/ U____

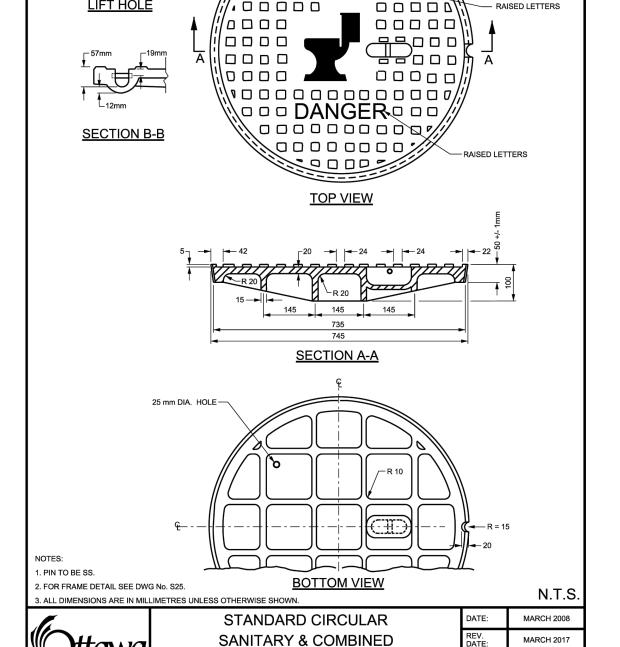

MAINTENANCE HOLE COVER

