

ZONING INFO

MIN. LOT WIDTH

MIN. LOT AREA

SETBACK

MAX. HEIGHT

AMENITY AREA

MIN. FRONTAGE

FRONTAGE

LANDSCAPED AREA

ZONING PROVISION

MIN. FRONT YARD SETBACK

MIN. INTERIOR SIDE YARD

MIN. REAR YARD SETBACK

43.5m OF BUILDING WALLS / 109.7m OF

ENTIRE FRONTAGE = 39% OF

PROVIDED

47.68m

5323.54m²

6.1m

N/A

N/A

13.25m

552m²

349.5m²

4.3m

227m2

242m2

Ground Floor Amenity: 83m2

<u>REQUIRED</u>

No minimum

No minimum

Minimum: 0m

No minimum

7.5m

no minimum

4.5m

Balconies:

Playground:

ZONING PROVISION

MINIMUM GLAZING OF

GROUND FLOOR

FACADE

GROUND FACADE

ACTIVATION

REQUIRED

include: a minimum of

one active entrance

from each individual

occupancy located

to the front lot line

area of the ground

floor façade facing

average grade up 4.5

Ogilvie, from the

metres, must be

transparent glazing

resident entrance

access doors

and active customer or

comprised of

immediately adjacent

<u>PROVIDED</u>

10.7% glazing

The ground floor Building is located facade facing a public within 6.1m of the

street of a building front lot line. No

located within 4.5 m of active entrances

the front lot line must face Ogilvie Rd.

50% of the surface 7.7 m2/72m2 =

PARKING QUEING + LOADING

RESIDENTIAL SPACES

ACCESSIBLE PARKING

VISITOR SPACES

BICYCLE PARKING

DRIVEWAY WIDTH

REQUIRED

39

3m @ single

traffic lane

6m @ double

traffic lane

PROVIDED

43

4m for single

traffic lane,

driveway to

parking garage

6m for double

traffic lane,

parking lot

DEVELOPMENT INFO

4M-172 CITY OF OTTAWA

BLOCKS C, D, AND L REGISTERED PLAN

REFERENCE SURVEY
BASED ON INFORMATION FROM A SURVEY

PREPARED BY ANNIS, O'SULLIVAN,

VOLLEBEKK LTD. DATED JULY 5, 2023

1360 OGILVIE RD, OTTAWA, ON K1J 9M6

5323.54m²

2558.69m²

5028.37m²

12,910.6m²

975m²

3,900m²

AM10 H(40)

14.15m, 4 STOREYS

LEGAL DESCRIPTION

MUNICIPAL ADDRESS

<u>SITE AREAS</u> BETTER LIVING CO-OP

COMMUNITY WORKS

GROSS FLOOR AREA

BIRCHWOOD

BUILDING AREA

BUILDING HEIGHT

TOTAL

ZONE



ACCOMODATIONS LEGEND							
DWELLING UNIT TYPE		TOTAL					
DWELLING UNIT TIPE	3(NEW)	4	5	6	TOTAL		
BACHELOR	1				1		
1-BEDROOM	25			0	25		
2-BEDROOM	4	7	6	6	23		
3-BEDROOM	9	7	6	4	26		
4-BEDROOM				1	1		
5-BEDROOM				1	1		
1-B(SENIOR)					0		
2-B(SENIOR)					٥		

1. PARKING FIGURES IN TABLE REFLECT BLC SITE ONLY
2. TOTAL SITE PARKING(INCLUDING BLC SITE):

PARKING LEGEND							
BLOCK BLOCK					TOTAL	TOTAL REQUIRED	TOTAL PARKING
DWELLING UNIT TYPE	3(NEW)	4	5 6	TOTAL	PARKING	PROVIDED	
APARTMENT (1.2)	39				39	47	
STACKED (1.2)	0	14	12	12	38	46	3
VISITOR PARKING (0.2)						15	
						108	total: 4

AMENITY LEGEND							
		BLC	OCK		TOTAL	TOTAL REQUIRED	TOTAL AMENITY SPACE
	3(NEW)	4	5	6	IOIAL	AMENITY SPACE (m2)	PROVIDED (m2)
DWELLING UNITS	39	14	12	12	77	462	552

SITE PLAN GENERAL NOTES:

- 1. ALL GENERAL SITE INFORMATION AND CONDITIONS COMPILED FROM EXISTING PLANS AND SURVEYS 2. DO NOT SCALE THIS DRAWING
 - 3. REPORT ANY DISCREPANCIES PRIOR TO COMMENCING WORK. NO RESPONSIBILITY IS BORN BY THE CONSULTANT FOR UNKNOWN SUBSURFACE CONDITIONS
 - 4. CONTRACTOR TO CHECK AND VERIFY ALL DIMENSIONS ON SITE AND REPORT ANY ERRORS AND/OR OMISSIONS TO THE
 - 5. REINSTATE ALL AREAS AND ITEMS DAMAGED AS A RESULT OF CONSTRUCTION ACTIVITIES TO THE SATISFACTION OF THE CONSULTANT
- 6. CONTRACTOR TO LAYOUT PLANTING BEDS, PATHWAYS ETC. TO APPROVAL OF CONSULTANT PRIOR TO ANY JOB EXCAVATION
- 7. THE ACCURACY OF THE POSITION OF UTILITIES IS NOT GUARANTEED - CONTRACTOR TO VERIFY PRIOR TO EXCAVATION 8. INDIVIDUAL UTILITY COMPANY MUST BE CONTACTED FOR CONFIRMATION OF UTILITY EXISTENCE AND LOCATION PRIOR TO
- 9. ALL DISTURBED AREAS TO BE RESTORED TO ORIGINAL CONDITION OR BETTER UNLESS OTHERWISE NOTED

SITE PLAN LEGEND:

CONSULTANT

EXISTING BUILDING (NOT IN SCOPE) FIRE ACCESS ROUTE EASEMENT / ROW ASPHALT PAVING - NEW

ASPHALT PAVING - EXISTING

CONCRETE SIDEWALK - EXISTING

CONCRETE SIDEWALK - NEW

GRASS - EXISTING

GRASS - NEW

PAVER TYPE 1 - NEW

CONCRETE PAD

- - - - - EXTENT OF EASEMENT / ROW

EMERGENCY EXIT

SERVICE DOORS

BUILDING MAIN ENTRANCE / TOWN ENTRANCE

PROPERTY LINE

STAMP

CSV ARCHITECTS

sustainable design · conception écologique

190 O'Connor Street, Suite 100

Ottawa, Ontario,K2P 2R3

613.564.8118

www.csv.ca

STRUCTURAL ENGINEER

200, 1550 Carling Avenue

Ottawa, Ontario K1Z 8S8

250 City Centre Avenue

Ottawa, Ontario K1R 6K7

LANDSCAPE ARCHITECT James B. Lennox & Associates

3332 Carling Avenue Ottawa, Ontario K2H 5A8

MECHANICAL AND ELECTRICAL

Chorley + Bisset Consulting Engineers

Cunliffe & Associates

cunliffe@cunliffe.ca

613-729-7242

ENGINEER

613-241-0030 email@chorley.com

613-722-5168

7 2025-09-04 Re-Issued for SPC

2025-03-17 Reissued for SPC 2025-02-19 Issued for Permit

4 2024-11-08 Issued for 80% Review 3 2024-10-08 Issued for SPC

2 2024-07-15 Issued for SPC

1 2024-07-19 Issued for 66% REV DATE ISSUE

NOTES

1. OWNERSHIP OF THE COPYRIGHT OF THE DESIGN AND THE WORKS EXECUTED FROM THE DESIGN REMAINS WITH CSV ARCHITECTS, AND MAY NOT BE REPRODUCED IN ANY FORM WITHOUT THE WRITTEN CONSENT OF CSV ARCHITECTS.

2. THE DRAWINGS, PRESENTATIONS AND SPECIFICATIONS AS INSTRUMENTS OF SERVICE ARE AND SHALL REMAIN THE PROPERTY OF CSV ARCHITECTS. THEY ARE NOT TO BE USED BY THE CLIENT ON OTHER PROJECTS OR ON EXTENSIONS TO THIS PROJECT WITHOUT THE WRITTEN CONSENT OF CSV ARCHITECTS. 3. THIS DRAWING IS TO BE READ IN CONJUNCTION WITH ALL OTHER PROJECT DRAWINGS AND SPECIFICATIONS. 4. DO NOT SCALE DRAWINGS. CONTRACTOR SHALL BE RESPONSIBLE TO VERIFY DIMENSIONS ON SITE.

5. ALL WORK SHALL BE IN ACCORDANCE WITH THE ONTARIO BUILDING CODE AND ALL SUPPLEMENTS AND APPLICABLE MUNICIPAL REGULATIONS.

CLIENT

BETTER LIVING CO-OPERATIVE

OTTAWA ONTARIO, CANADA

PROJECT

BLOCK 3 **REDEVELOPMENT**


1360 OGILVIE ROAD GLOUCESTER, ON K1J 9M6

OVERALL SITE PLAN

PROJECT NO: 2022-2040 DRAWN: KM APPROVED: PM As indicated DATE PRINTED: 2025-09-03 4:44:24 PM

REV

DRAWING NO. ₹

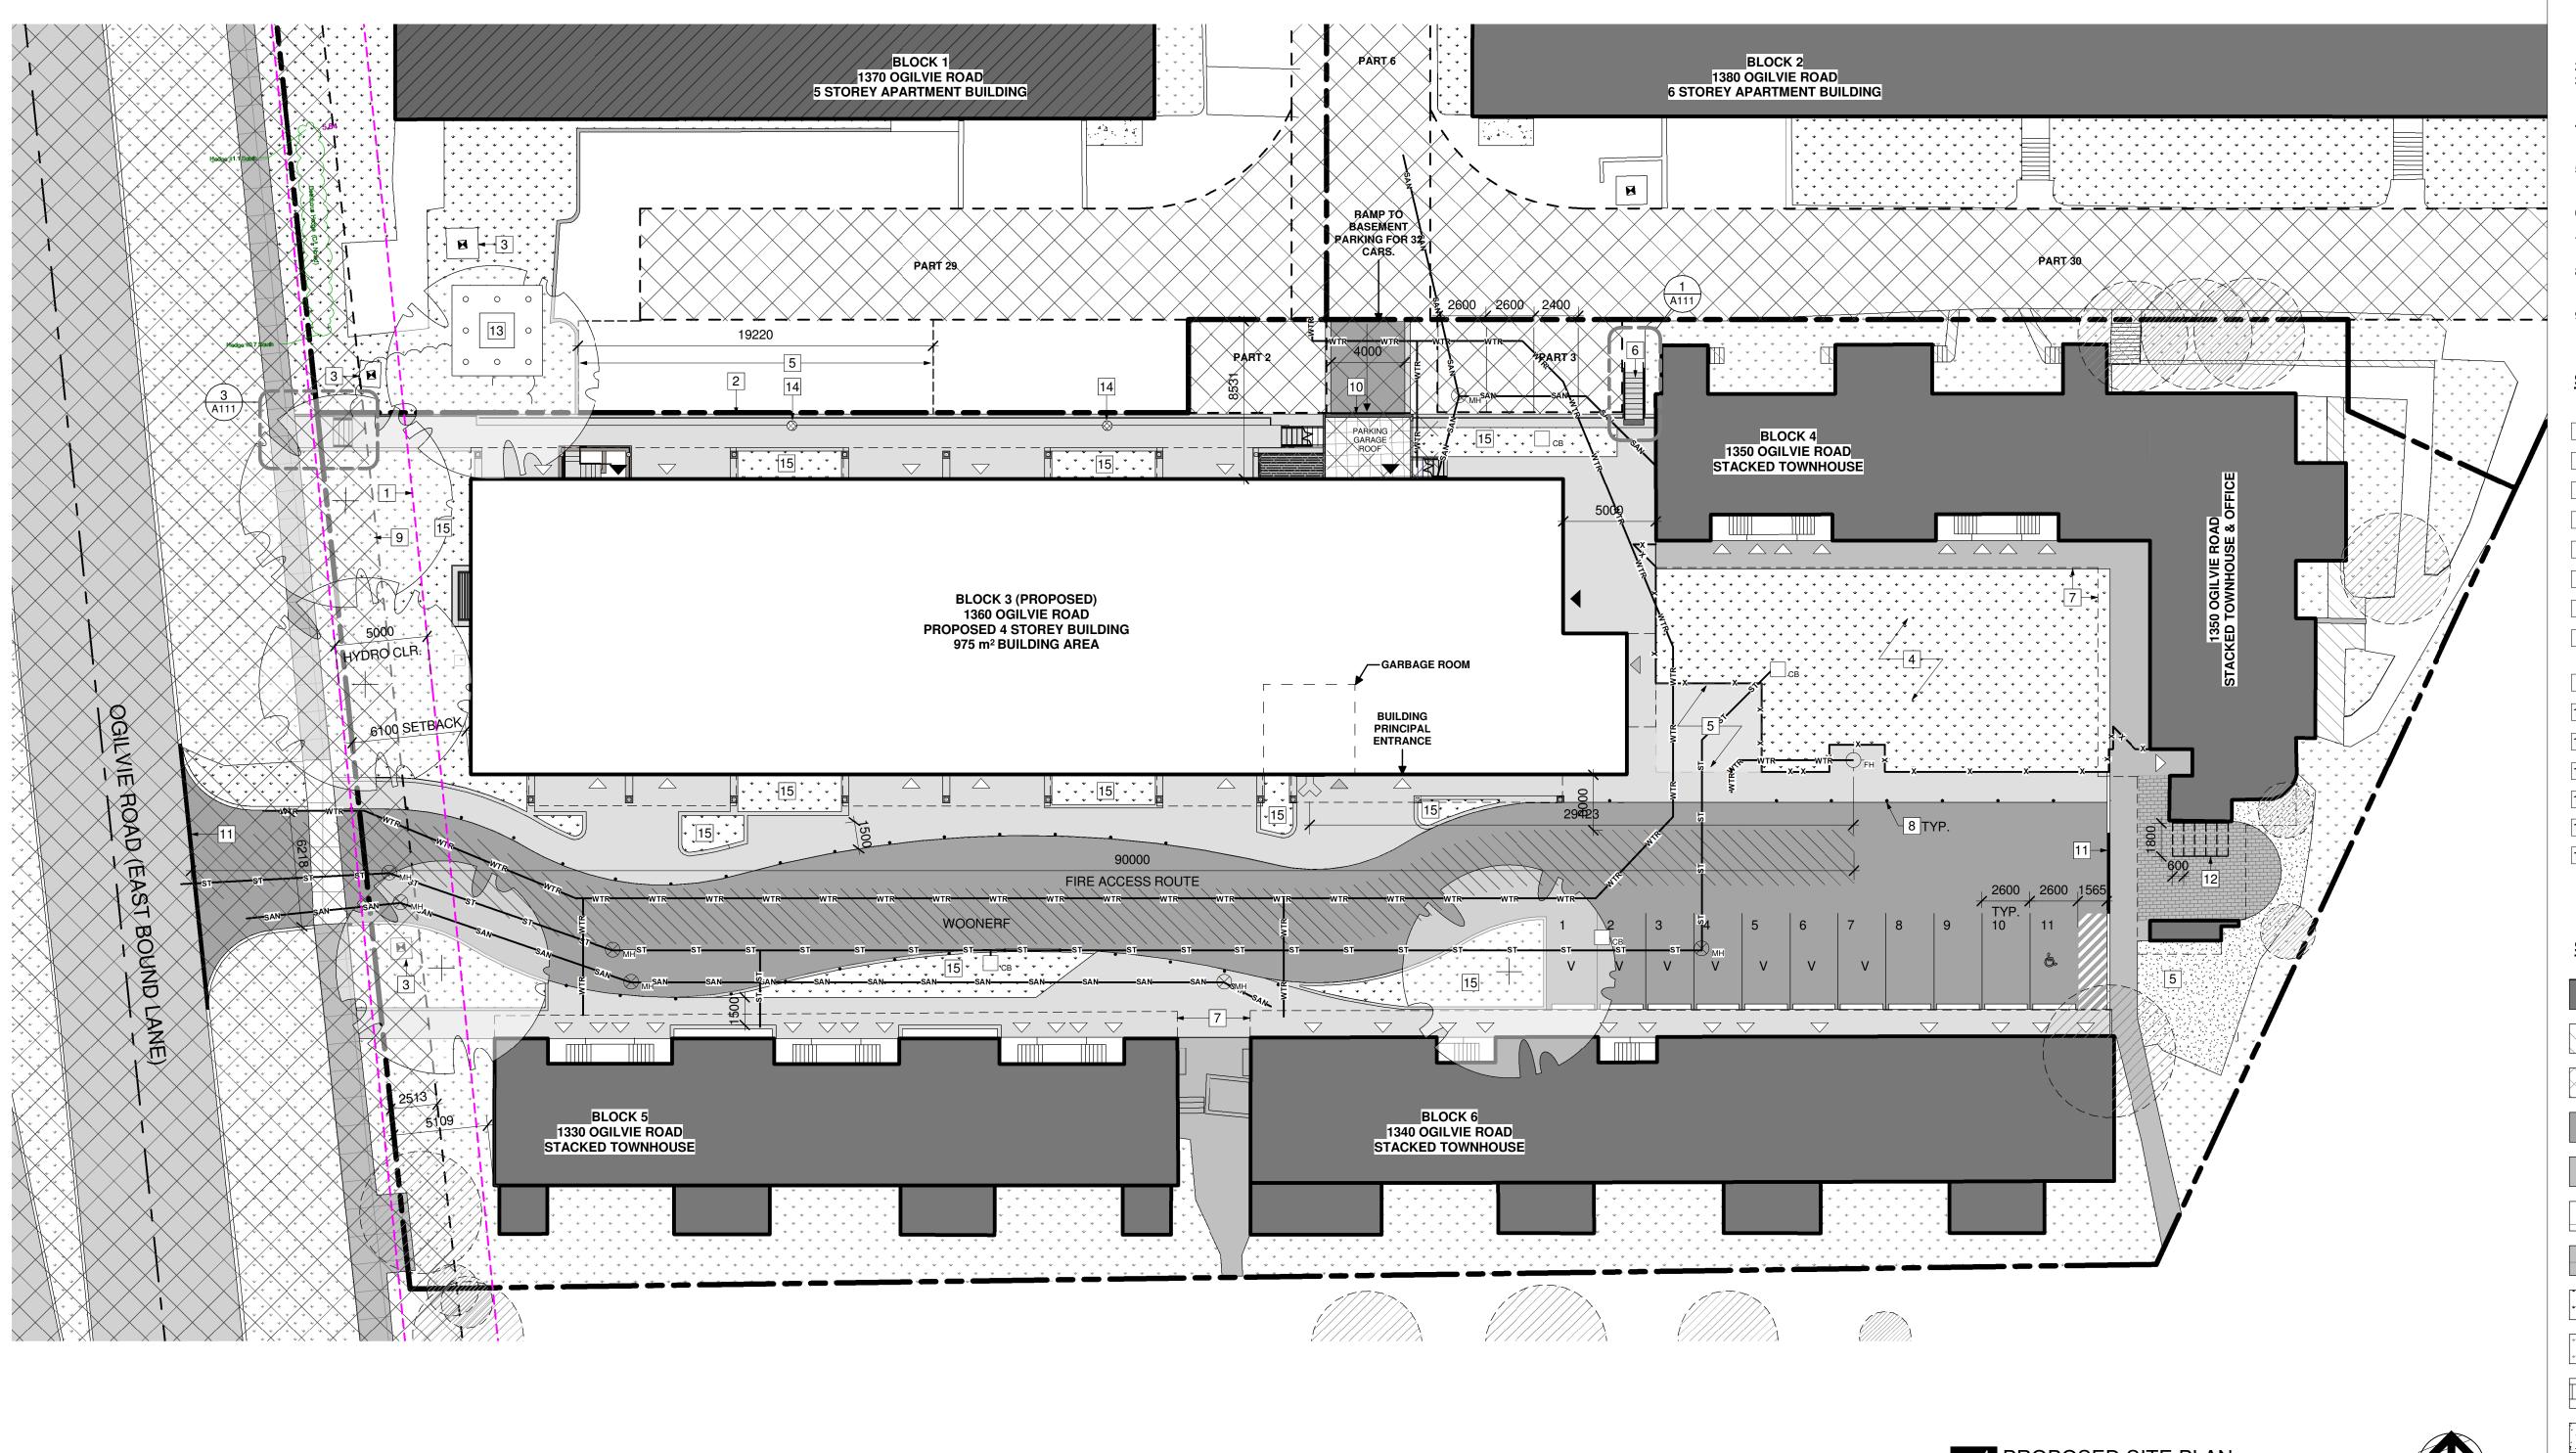

1 PROPOSED SITE PLAN

ACCOMODATIONS LEGEND

DWELLING UNIT TYPE

BLOCK

DEVELOPMENT INFO)	ZONING INFO								
LEGAL DESCRIPTION		ZONING PROVISION	REQUIRED	PROVIDED	ZONING PROVISION	REQUIRED	PROVIDED	PARKING QUEING + LOADING	REQUIRED	PROVIDED
BLOCKS C, D, AND L F 4M-172 CITY OF OTTA		MIN. LOT WIDTH	No minimum	47.68m	GROUND FACADE	The ground floor	Building is located	RESIDENTIAL SPACES	92	43
REFERENCE SURVEY		MIN. LOT AREA	No minimum	5323.54m ²	ACTIVATION	facade facing a public street of a building	front lot line. No	VISITOR SPACES	15	7
BASED ON INFORMAT PREPARED BY ANNIS,		MIN. FRONT YARD SETBACK	Minimum: 0m	6.1m		located within 4.5 m of the front lot line must include: a minimum of	face Ogilvie Rd.	ACCESSIBLE PARKING	-	3
VOLLEBEKK LTD. DAT		MIN. INTERIOR SIDE YARD	No minimum	N/A		one active entrance from each individual		BICYCLE PARKING	39	44
MUNICIPAL ADDRESS 1360 OGILVIE RD, OTT	⁻ AWA, ON K1J 9M6	SETBACK MIN. REAR YARD SETBACK	7.5m	N/A		occupancy located immediately adjacent to the front lot line		DRIVEWAY WIDTH	3m @ single traffic lane	4m for single traffic lane,
SITE AREAS BETTER LIVING CO-OP	5323.54m²	MAX. HEIGHT	40m	13.25m	MINUMUNA OL AZINIO OF	50% of the surface	7.7 0/ 70 0		6m @ double	driveway to parking garage
COMMUNITY WORKS BIRCHWOOD	2558.69m ²	AMENITY AREA	462m2	552m ²	MINIMUM GLAZING OF GROUND FLOOR	area of the ground	7.7 m2/ 72m2 = 10.7% glazing		traffic lane	6m for double
TOTAL	<u>5028.37m²</u> 12,910.6m²	LANDSCAPED AREA	no minimum	349.5m ²	FACADE	floor façade facing Ogilvie, from the				traffic lane, parking lot
BUILDING AREA	975m²	MIN. FRONTAGE	4.5m	4.3m		average grade up 4.5 metres, must be				
GROSS FLOOR AREA	3,900m ²	FRONTAGE CALCULATION:	AMENITY BRE	EAKDOWN		comprised of transparent glazing	_			
BUILDING HEIGHT	14.15m , 4 STOREYS	43.5m OF BUILDING WALLS / 109.7m OF ENTIRE FRONTAGE = 39% OF				and active customer o resident entrance	r			

242m2

Playground:

FRONTAGE

AM10 H(40)

ZONE

access doors

DIVICE LINE LINET TVDC		2200.1		TOTAL	i. FARRING HOUR	LO IN TADLE REFELOT DEC				
DWELLING UNIT TYPE	3(NEW)	4	5	6	TOTAL	SITE ONLY				
BACHELOR	1				1	2. TOTAL SITE PAR	RKING: DFFICE, RESIDENT, AND			
1-BEDROOM	25			0	25	VISITOR PAF	VISITOR PARKING SPACES: 170 SPACE B. INLCUDING ONLY RESIDENT AND VISIT EXCLUDING OFFICE: 154 SPACES			
2-BEDROOM	4	7	6	6	23					
3-BEDROOM	9	7	6	4	26	EXCLUDING OFFICE: 154 SPACES				
4-BEDROOM				1	1					
5-BEDROOM				1	1					
1-B(SENIOR)					0					
2-B(SENIOR)					0					
TOTAL	. 39	14	12	12	77					
			P.A	ARKING LEG	GEND					
DWELLING UNIT TYPE		BLO	CK		TOTAL	TOTAL REQUIRED	TOTAL PARKING			
DWELLING UNIT TYPE	3(NEW)	4	5	6	TOTAL	PARKING	PROVIDED			
APARTMENT (1.2)	39				39	47				
STACKED (1.2)	0	14	12	12	38	46	36			
VISITOR PARKING (0.2)						15	7			
						108	total: 43			
					-					
			AN	MENITY LEG	GEND					
		BLO	CK CK		TOTAL	TOTAL REQUIRED	TOTAL AMENITY SPACE			

1. PARKING FIGURES IN TABLE REFLECT BLC

SITE PLAN GENERAL NOTES:

- 1. ALL GENERAL SITE INFORMATION AND CONDITIONS COMPILED FROM EXISTING PLANS AND SURVEYS
 - 2. DO NOT SCALE THIS DRAWING . REPORT ANY DISCREPANCIES PRIOR TO COMMENCING WORK. NO RESPONSIBILITY IS BORN BY THE CONSULTANT FOR
 - UNKNOWN SUBSURFACE CONDITIONS . CONTRACTOR TO CHECK AND VERIFY ALL DIMENSIONS ON SITE AND REPORT ANY ERRORS AND/OR OMISSIONS TO THE
 - CONSULTANT REINSTATE ALL AREAS AND ITEMS DAMAGED AS A RESULT OF CONSTRUCTION ACTIVITIES TO THE SATISFACTION OF THE CONSULTANT
 - CONTRACTOR TO LAYOUT PLANTING BEDS, PATHWAYS ETC. TO APPROVAL OF CONSULTANT PRIOR TO ANY JOB EXCAVATION
 - 7. THE ACCURACY OF THE POSITION OF UTILITIES IS NOT GUARANTEED - CONTRACTOR TO VERIFY PRIOR TO EXCAVATION 8. INDIVIDUAL UTILITY COMPANY MUST BE CONTACTED FOR

CONFIRMATION OF UTILITY EXISTENCE AND LOCATION PRIOR TO

ALL DISTURBED AREAS TO BE RESTORED TO ORIGINAL CONDITION OR BETTER UNLESS OTHERWISE NOTED

SITE PLAN KEYNOTES:

- OTTAWA HYDRO SETBACK / CLEARANCES
- NEW RETAINING WALL PER 1/A111
- EXISTING HYDRO TRANSFORMER ON CONCRETE PAD
- PLAYGROUND AREA (N.I.C)
- SNOW STORAGE
- NEW LANDSCAPE STAIR
- EXISTING ROOF OVERHANG
- BOLLLARDS ALONG PROPOSED WOONERF, REFER TO
- LANDSCAPE

ROW EASEMENT

- LOCATION OF TRAFFIC SIGNAL
- DEPRESSED CURB
- NEW BIKE RACKS (5 TOTAL)
- NEW TRANSFORMER PER ELECTRICAL DOCUMENTS
- AREA DRAIN. REFER TO CIVIL DOCUMENTS
- SOFT LANDSCAPING PER LANDSCAPE

SITE PLAN LEGEND:

EXISTING BUILDING (NOT IN SCOPE)

FIRE ACCESS ROUTE

EASEMENT / ROW

ASPHALT PAVING - NEW

ASPHALT PAVING - EXISTING

CONCRETE SIDEWALK - NEW

CONCRETE SIDEWALK - EXISTING

GRASS - NEW

GRASS - EXISTING

PAVER TYPE 1 - NEW

CONCRETE PAD

PROPERTY LINE

— — — — EXTENT OF EASEMENT / ROW OTTAWA HYDRO SETBACK _____

____ x ____ FENCING PER LANDSCAPE

NEW DOMESTIC WATER **NEW SANITARY**

— н —

NEW STORM NEW ELECTRICAL SERVICE BELOW GRADE

СВ CATCH BASIN

-O_{FH} FIRE HYDRANT

 \bigotimes_{MH} MANHOLE $\stackrel{\textstyle \curvearrowleft}{\longrightarrow}$ SIAMESE CONNECTION

> **EMERGENCY EXIT**

SERVICE DOORS BUILDING MAIN ENTRANCE / \triangle TOWN ENTRANCE

OTTAWA ONTARIO, CANADA PROJECT

BETTER LIVING

CO-OPERATIVE

CSV ARCHITECTS

sustainable design · conception écologique

190 O'Connor Street, Suite 100

Ottawa, Ontario,K2P 2R3

613.564.8118

www.csv.ca

STRUCTURAL ENGINEER

200, 1550 Carling Avenue

Ottawa, Ontario K1Z 8S8

MECHANICAL AND ELECTRICAL

Chorley + Bisset Consulting Engineers

Cunliffe & Associates

cunliffe@cunliffe.ca

250 City Centre Avenue

Ottawa, Ontario K1R 6K7

LANDSCAPE ARCHITECT James B. Lennox & Associates

613-729-7242

ENGINEER

613-241-0030

613-722-5168

CIVIL ENGINEER

CIVIL ENGINEERS

115 Walgreen Road

info@mcintoshperry.com

McIntosh Perry

Carp, Ontario

613-836-2184

STAMP

NOTES

SPECIFICATIONS.

CLIENT

TITLE

9 2025-09-04 Re-Issued for SPC 8 2025-03-17 Reissued for SPC

7 2025-02-19 Issued for Permit 6 2025-02-13 Permit Coordination 5 2024-11-08 Issued for 80% Review 4 2024-10-08 Issued for SPC

2 2024-07-15 Issued for SPC

1 2024-07-19 Issued for 66%

CONSENT OF CSV ARCHITECTS.

2. THE DRAWINGS, PRESENTATIONS AND

TO THIS PROJECT WITHOUT THE WRITTEN

1. OWNERSHIP OF THE COPYRIGHT OF THE DESIGN AND THE WORKS EXECUTED FROM THE DESIGN REMAINS WITH CSV ARCHITECTS, AND MAY NOT BE

REPRODUCED IN ANY FORM WITHOUT THE WRITTEN

SPECIFICATIONS AS INSTRUMENTS OF SERVICE ARE AND SHALL REMAIN THE PROPERTY OF CSV ARCHITECTS. THEY ARE NOT TO BE USED BY THE CLIENT ON OTHER PROJECTS OR ON EXTENSIONS

CONSENT OF CSV ARCHITECTS.

3. THIS DRAWING IS TO BE READ IN CONJUNCTION WITH ALL OTHER PROJECT DRAWINGS AND

4. DO NOT SCALE DRAWINGS. CONTRACTOR SHALL BE RESPONSIBLE TO VERIFY DIMENSIONS ON SITE.

5. ALL WORK SHALL BE IN ACCORDANCE WITH THE ONTARIO BUILDING CODE AND ALL SUPPLEMENTS

AND APPLICABLE MUNICIPAL REGULATIONS.

REV DATE ISSUE

address address

phone email

email@chorley.com

3332 Carling Avenue

Ottawa, Ontario K2H 5A8

BLOCK 3 **REDEVELOPMENT**

1360 OGILVIE ROAD GLOUCESTER, ON K1J 9M6

PROPOSED SITE PLAN


PROJECT NO: 2022-2040 DRAWN: KM APPROVED: PM

SCALE: As indicated DATE PRINTED: 2025-09-03 4:44:30 PM


REV DRAWING NO. ₹

A110


19156

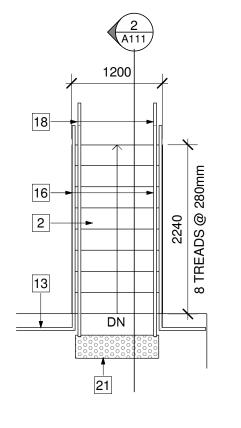




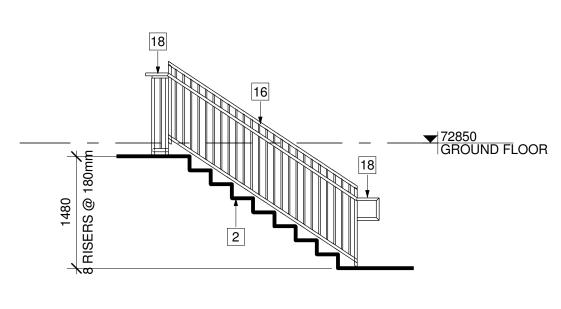




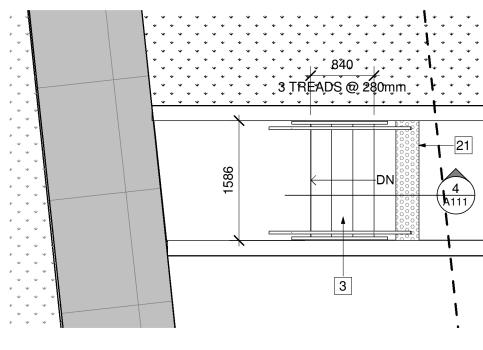

3 SITE STAIR A PLAN DETAIL

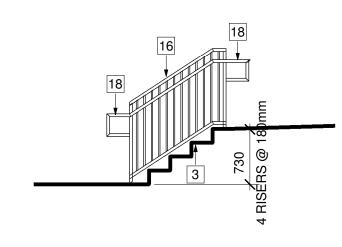

4 STAIR SECTION

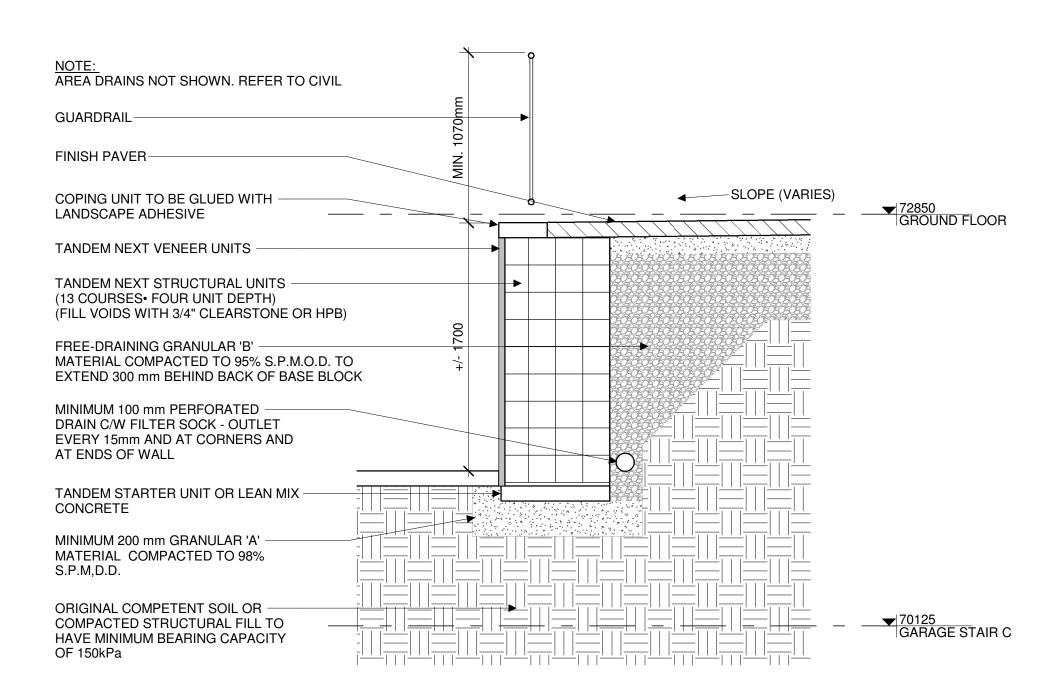

5 RETAINING WALL SECTION @ GL 1
A111 1:25

GENERAL STAIR NOTES:

- 1. DEMARCATE LEADING EDGE OF TREADS AND LEADING EDGE OF LANDING WITH COLOUR CONTRAST/DISTINCTIVE VISUAL PATTERN.
- 2. CONTRACTOR TO PROVIDE ENGINEERED STAMPED SHOP DRAWINGS OF STAIRS, HANDRAILS AND GUARDS SEALED AND SIGNED BY A PROFESSIONAL STRUCTURAL ENGINEER LICENSED IN THE PROVINCE OF ONTARIO.
- 3. PROVIDE 50mm MIN. CLEARANCE BETWEEN HANDRAIL AND ANY ADJACENT SURFACE.
- 4. ALL METAL COMPONENTS FOR GUARDS AND HANDRAILS TO BE PRIMED AND PAINTED. COLOUR PER FINISH PLANS
- 5. PROVIDE 50mm MIN. CLEARANCE BETWEEN HANDRAIL AND
- 6. PROVIDE COLOUR CONTRASTING AND SLIP RESISTANT STRIP ALONG EDGE OF NOSINGS AS PER OBC 2012 3.4.6.1. VISUAL INDICATOR STRIP TO BE INT INTEGRATED INTO TREAD LINER FINISH MATERIAL.

STAIR KEYNOTES:

STAIR TYPE

- WOOD STAIR
- PRECAST CONCRETE STAIR

ANY ADJACENT SURFACE.

- CAST-IN-PLACE CONCRETE STAIR
- STEEL PAN TREAD C/W CLOSED RISER & CONCRETE FILL ,PAINTED. STAIR FINISH PER FLOOR FINISH PLAN
- INTERMEDIATE LANDING SEE STRUCTURAL

GUARDRAIL/HANDRAIL TYPE

- 38mm Ø METAL WALL MOUNTED HANDRAIL PER OBC 3.4.6.5
- 38mm Ø WOOD WALL MOUNTED HANDRAIL
- 1070mm HIGH STEEL GUARD C/W 16mm Ø BALUSTERS @ 100mm O.C.
- 915mm HIGH CONTINUOUS 38mm Ø METAL HANDRAIL MOUNTED TO STAIR STRINGER C/W 16mm Ø BALUSTERS @ 100mm O.C.
- 915mm HIGH CONTINUOUS 38mmØ METAL HANDRAIL MOUNTED TO 1070mm HIGH METAL GUARD C/W 16mm Ø BALUSTERS @ 100mm O.C. CONNECTED TO STRINGERS WITH MOUNTING PLATE
- 915mm HIGH CONTINUOUS 38mmØ METAL HANDRAIL MOUNTED TO 1070mm HIGH METAL GUARD C/W 16mm Ø BALUSTERS @ 100mm O.C. CAST INTO PRECAST CONCRETE
- WALL MOUNTED HANDRAIL BRACKET, PAINTED TYP.
- 300mm HANDRAIL EXTENSION (TYP.)

305mm TACTILE INDICATOR STRIP TO COMPLY WITH OBC 3.4.6.1 AND 3.8.3.18 (2) REFER TO SPECS - TYP. EXTEND FULL WIDTH OF STAIRS AS SHOWN.

sustainable design · conception écologique

CSV ARCHITECTS

613.564.8118 190 O'Connor Street, Suite 100 Ottawa, Ontario,K2P 2R3 www.csv.ca

STRUCTURAL ENGINEER Cunliffe & Associates 200, 1550 Carling Avenue Ottawa, Ontario K1Z 8S8 613-729-7242 cunliffe@cunliffe.ca

MECHANICAL AND ELECTRICAL **ENGINEER** Chorley + Bisset Consulting Engineers 250 City Centre Avenue Ottawa, Ontario K1R 6K7 613-241-0030 email@chorley.com

LANDSCAPE ARCHITECT James B. Lennox & Associates 3332 Carling Avenue Ottawa, Ontario K2H 5A8 613-722-5168

CIVIL ENGINEER

address

address

phone

email

CIVIL ENGINEERS McIntosh Perry 115 Walgreen Road Carp, Ontario 613-836-2184 info@mcintoshperry.com

STAMP

- 5 2025-09-04 Re-Issued for SPC
- 4 2025-03-17 Reissued for SPC 2025-02-19 Issued for Permit 2 2024-11-08 Issued for 80% Review

1 2024-10-08 Issued for SPC REV DATE ISSUE

NOTES

1. OWNERSHIP OF THE COPYRIGHT OF THE DESIGN AND THE WORKS EXECUTED FROM THE DESIGN REMAINS WITH CSV ARCHITECTS, AND MAY NOT BE REPRODUCED IN ANY FORM WITHOUT THE WRITTEN CONSENT OF CSV ARCHITECTS. 2. THE DRAWINGS, PRESENTATIONS AND SPECIFICATIONS AS INSTRUMENTS OF SERVICE ARE AND SHALL REMAIN THE PROPERTY OF CSV ARCHITECTS. THEY ARE NOT TO BE USED BY THE CLIENT ON OTHER PROJECTS OR ON EXTENSIONS TO THIS PROJECT WITHOUT THE WRITTEN CONSENT OF CSV ARCHITECTS. 3. THIS DRAWING IS TO BE READ IN CONJUNCTION WITH ALL OTHER PROJECT DRAWINGS AND SPECIFICATIONS. 4. DO NOT SCALE DRAWINGS. CONTRACTOR SHALL BE RESPONSIBLE TO VERIFY DIMENSIONS ON SITE. 5. ALL WORK SHALL BE IN ACCORDANCE WITH THE

ONTARIO BUILDING CODE AND ALL SUPPLEMENTS AND APPLICABLE MUNICIPAL REGULATIONS.

CLIENT

BETTER LIVING CO-OPERATIVE

OTTAWA ONTARIO, CANADA

PROJECT

BLOCK 3 **REDEVELOPMENT**

1360 OGILVIE ROAD GLOUCESTER, ON K1J 9M6


SITE DETAILS

PROJECT NO: 2022-2040 DRAWN: DF APPROVED: DH

As indicated DATE PRINTED: 2025-09-03 4:44:34 PM

REV

DRAWING NO. 7 A111 6

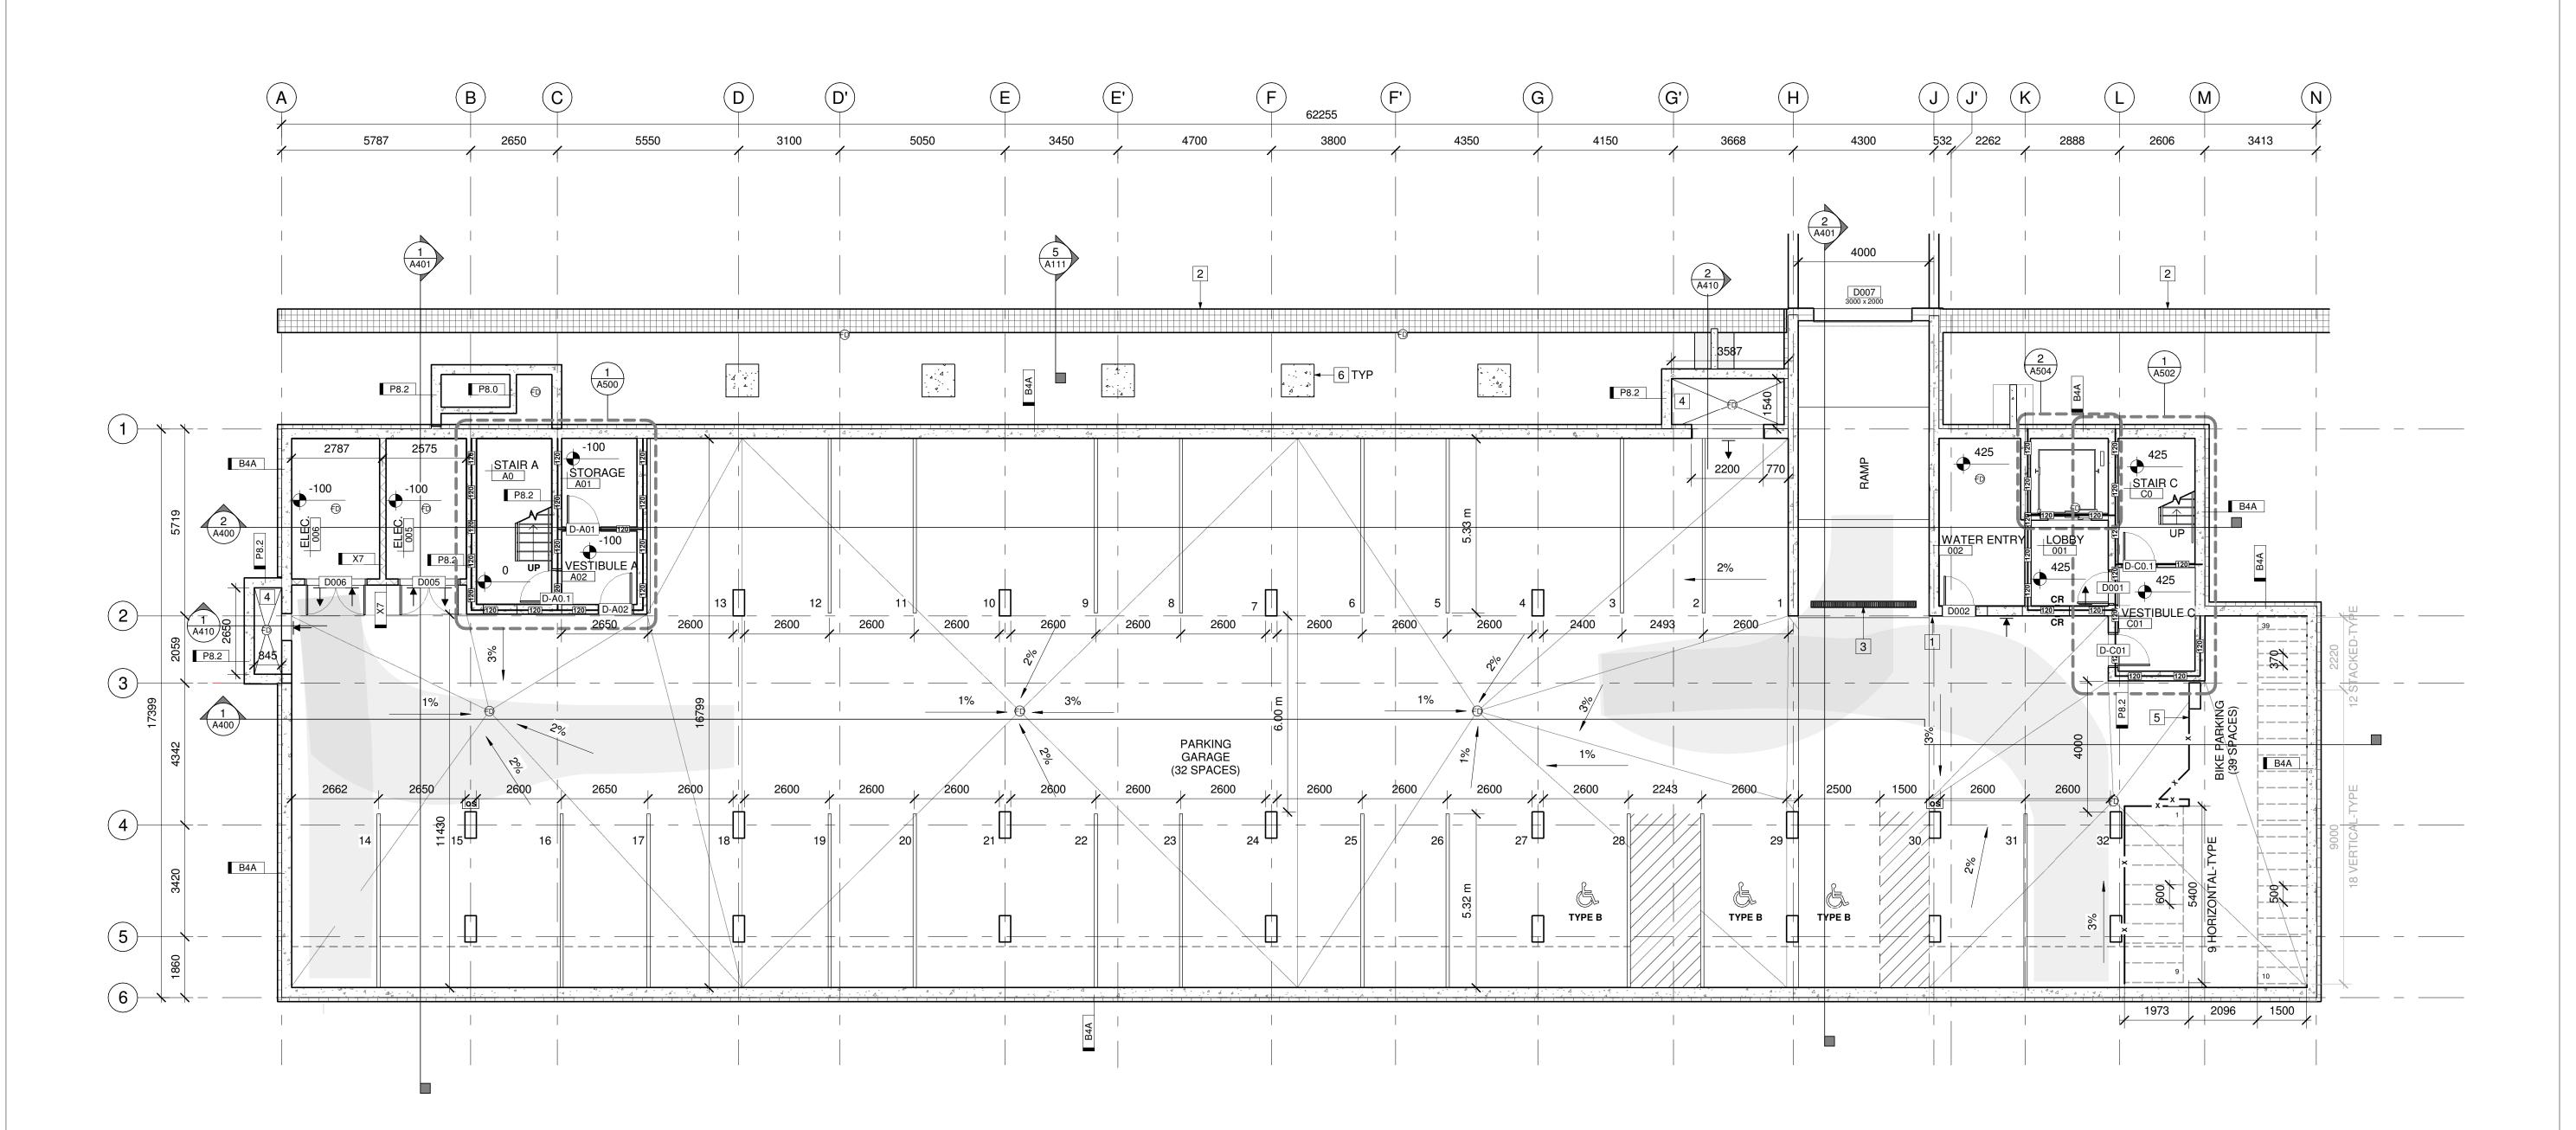

1 UNDERGROUND PARKING LEVEL

GENERAL REFERENCE PLAN NOTES:

- 1. ALL DIMENSIONS ARE TO FACE OF FRAMING UNLESS OTHERWISE NOTED.
- 2. ALL DOOR DIMENSIONS ARE TO THE CENTRE OR INSIDE OF FRAME. 3. ALL WINDOW DIMENSIONS ARE TO THE CENTER OR OUTSIDE OF FRAME.

UNDERGROUND PARKING PLAN KEYNOTES:

- 1 LOCATION OF TRAFFIC SIGNAL
- 2 PRE-ENGINEEREDE RETAINING WALL
- 3 TRENCH DRAIN, REFER TO MECHANICAL DOCUMENTS
- 4 AREAWAY
- 5 SECURE BIKE STORAGE. CHAINLINK FENCE W/ ACCESS DOOR. SECURE FENCE TO FLOOR SLAB AND TO U/S SLAB ABOVE
- 6 PIER FOOTING PER STRUCTURAL DOCUMENTS

LEGEND:

EARTH BACKFILL

ACCESSIBLE PARKING AISLE

— 0 MIN. FIRE RESISTANCE RATING

45 MIN. FIRE RESISTANCE RATING 60 MIN. FIRE RESISTANCE RATING

90 MIN. FIRE RESISTANCE RATING

CARD READER

DOOR

FLOOR DRAIN, REFER TO MECHANICAL.

OS OS SENSOR, WALL

INTAKE LOUVRE EXHAUST LOUVRE

CSV ARCHITECTS

sustainable design · conception écologique

190 O'Connor Street, Suite 100 Ottawa, Ontario,K2P 2R3

STRUCTURAL ENGINEER Cunliffe & Associates 200, 1550 Carling Avenue Ottawa, Ontario K1Z 8S8 613-729-7242 cunliffe@cunliffe.ca

613.564.8118

www.csv.ca

MECHANICAL AND ELECTRICAL **ENGINEER** Chorley + Bisset Consulting Engineers 250 City Centre Avenue Ottawa, Ontario K1R 6K7 613-241-0030 email@chorley.com

LANDSCAPE ARCHITECT James B. Lennox & Associates 3332 Carling Avenue Ottawa, Ontario K2H 5A8 613-722-5168

STAMP

7 2025-09-04 Re-Issued for SPC 2025-03-17 Reissued for SPC

2025-02-19 Issued for Permit 4 2024-11-08 Issued for 80% Review 3 2024-10-08 Issued for SPC

2 2024-07-15 Issued for SPC 1 2024-07-19 Issued for 66%

REV DATE ISSUE

NOTES

1. OWNERSHIP OF THE COPYRIGHT OF THE DESIGN AND THE WORKS EXECUTED FROM THE DESIGN REMAINS WITH CSV ARCHITECTS, AND MAY NOT BE REMAINS WITH CSV ARCHITECTS, AND WAT NOT BE REPRODUCED IN ANY FORM WITHOUT THE WRITTEN CONSENT OF CSV ARCHITECTS.

2. THE DRAWINGS, PRESENTATIONS AND SPECIFICATIONS AS INSTRUMENTS OF SERVICE ARE AND SHALL REMAIN THE PROPERTY OF CSV ARCHITECTS. THEY ARE NOT TO BE USED BY THE CLIENT ON OTHER PROJECTS OR ON EXTENSIONS TO THIS PROJECT WITHOUT THE WRITTEN CONSENT OF CSV ARCHITECTS. 3. THIS DRAWING IS TO BE READ IN CONJUNCTION WITH ALL OTHER PROJECT DRAWINGS AND SPECIFICATIONS. 4. DO NOT SCALE DRAWINGS. CONTRACTOR SHALL BE RESPONSIBLE TO VERIFY DIMENSIONS ON SITE. 5. ALL WORK SHALL BE IN ACCORDANCE WITH THE

ONTARIO BUILDING CODE AND ALL SUPPLEMENTS AND APPLICABLE MUNICIPAL REGULATIONS.

CLIENT

BETTER LIVING CO-OPERATIVE

OTTAWA ONTARIO, CANADA

PROJECT

BLOCK 3 REDEVELOPMENT


1360 OGILVIE ROAD GLOUCESTER, ON K1J 9M6

UNDERGROUND PARKING PLAN

PROJECT NO: 2022-2040 DRAWN: DF APPROVED: PM 1:100

DATE PRINTED: 2025-09-03 4:44:38 PM REV DRAWING NO. 7

A200 B

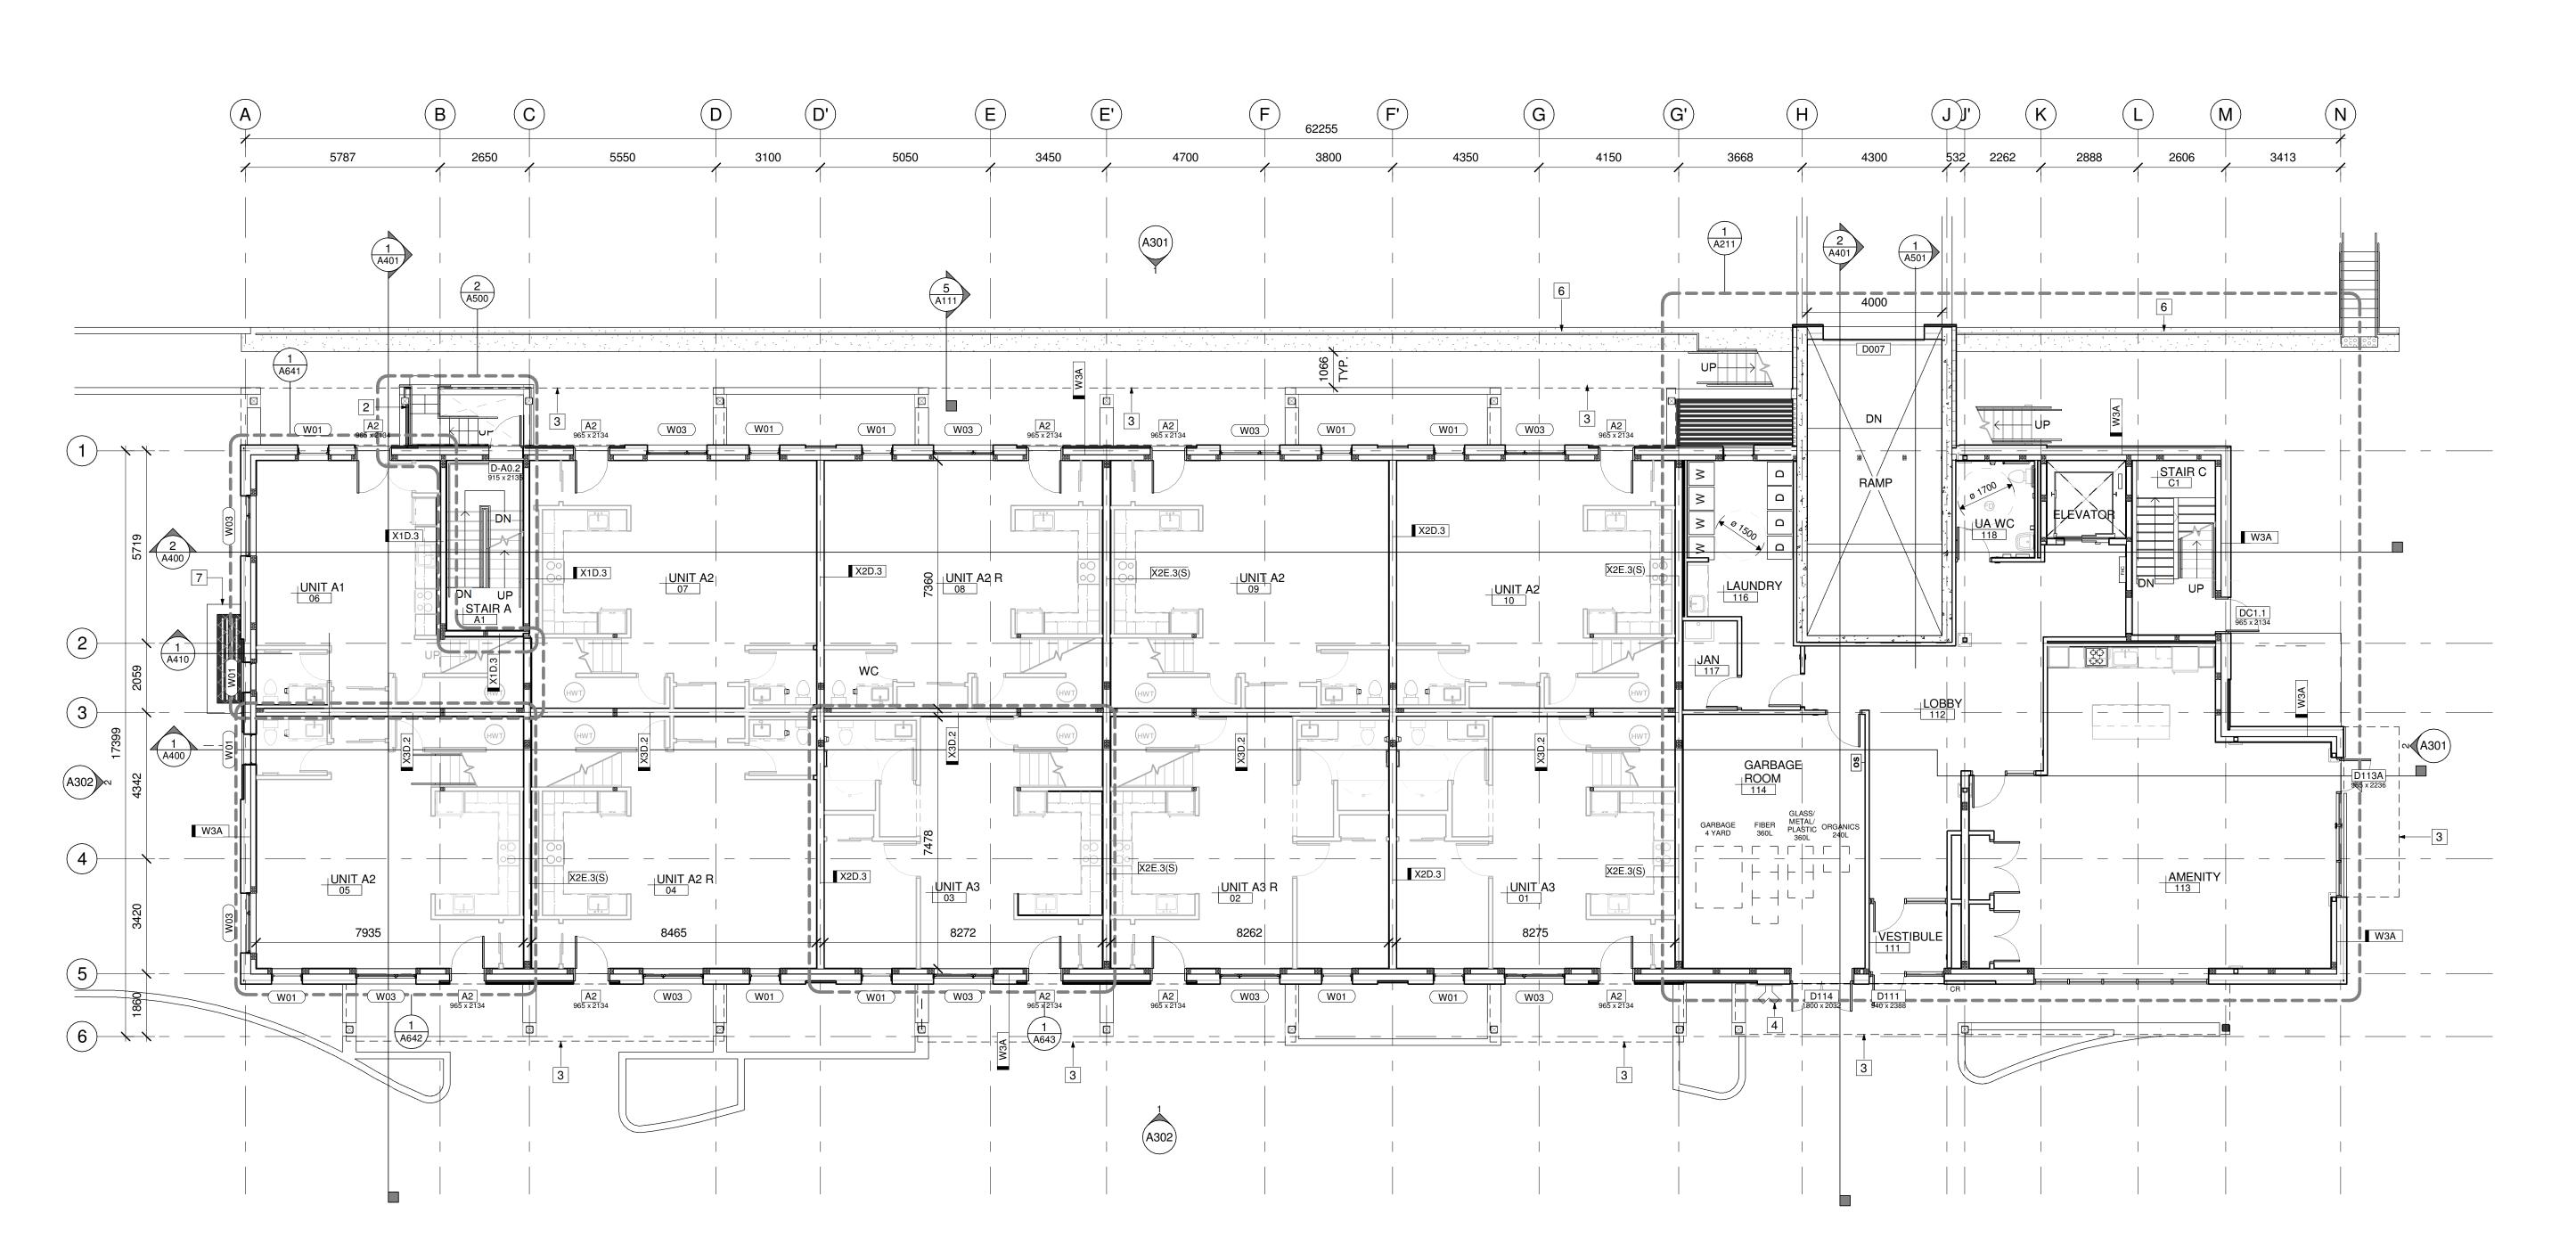

GENERAL REFERENCE PLAN NOTES:

1. ALL DIMENSIONS ARE TO FACE OF FRAMING UNLESS OTHERWISE NOTED.

1 GROUND FLOOR KEY PLAN

2. ALL DOOR DIMENSIONS ARE TO THE CENTRE OR INSIDE OF FRAME. 3. ALL WINDOW DIMENSIONS ARE TO THE CENTER OR OUTSIDE OF FRAME.

REFERENCE PLAN KEYNOTES:

- 1 MAILBOXES
- 2 PRIVACY SCREEN
- 3 CANOPY ABOVE
- 4 FIRE DEPARTMENT CONNECTION
- 5 FIRE ALARM CONTROL PANEL
- 6 RETAINING WALL C/W GUARDRAIL
- 7 BASEMENT AREAWELL, REFER TO A410

EXISTING BUILDING (NOT IN SCOPE) NOT IN CONTRACT NEW CONSTRUCTION FIRE ACCESS ROUTE — 0 MIN. FIRE RESISTANCE RATING EXTENT OF EASEMENT 45 MIN. FIRE RESISTANCE RATING 60 MIN. FIRE RESISTANCE RATING ASPHALT PAVING - NEW 90 MIN. FIRE RESISTANCE RATING ASPHALT PAVING - EXISTING 120 MIN. FIRE RESISTANCE RATING CONCRETE SIDEWALK - NEW DOOR CONCRETE SIDEWALK - EXISTING DOOR OPERATOR GRASS - NEW GRASS - EXISTING PAVER TYPE 1 - NEW CONCRETE PAD

LEGEND:

SITE PLAN LEGEND:

CSV ARCHITECTS

sustainable design · conception écologique

613.564.8118 190 O'Connor Street, Suite 100 Ottawa, Ontario,K2P 2R3 www.csv.ca

STRUCTURAL ENGINEER Cunliffe & Associates 200, 1550 Carling Avenue Ottawa, Ontario K1Z 8S8 613-729-7242 cunliffe@cunliffe.ca

MECHANICAL AND ELECTRICAL **ENGINEER** Chorley + Bisset Consulting Engineers 250 City Centre Avenue Ottawa, Ontario K1R 6K7 613-241-0030 email@chorley.com

LANDSCAPE ARCHITECT James B. Lennox & Associates 3332 Carling Avenue Ottawa, Ontario K2H 5A8 613-722-5168

STAMP

7 2025-09-04 Re-Issued for SPC 2025-03-17 Reissued for SPC

2025-02-19 Issued for Permit 4 2024-11-08 Issued for 80% Review 3 2024-10-08 Issued for SPC

2 2024-07-15 Issued for SPC 1 2024-07-19 Issued for 66% REV DATE ISSUE

1. OWNERSHIP OF THE COPYRIGHT OF THE DESIGN AND THE WORKS EXECUTED FROM THE DESIGN REMAINS WITH CSV ARCHITECTS, AND MAY NOT BE REMAINS WITH CSV ARCHITECTS, AND WAT NOT BE REPRODUCED IN ANY FORM WITHOUT THE WRITTEN CONSENT OF CSV ARCHITECTS.

2. THE DRAWINGS, PRESENTATIONS AND SPECIFICATIONS AS INSTRUMENTS OF SERVICE ARE AND SHALL REMAIN THE PROPERTY OF CSV ARCHITECTS. THEY ARE NOT TO BE USED BY THE CLIENT ON OTHER PROJECTS OR ON EXTENSIONS TO THIS PROJECT WITHOUT THE WRITTEN CONSENT OF CSV ARCHITECTS. 3. THIS DRAWING IS TO BE READ IN CONJUNCTION

WITH ALL OTHER PROJECT DRAWINGS AND SPECIFICATIONS. 4. DO NOT SCALE DRAWINGS. CONTRACTOR SHALL BE RESPONSIBLE TO VERIFY DIMENSIONS ON SITE. 5. ALL WORK SHALL BE IN ACCORDANCE WITH THE ONTARIO BUILDING CODE AND ALL SUPPLEMENTS AND APPLICABLE MUNICIPAL REGULATIONS.

CLIENT

BETTER LIVING CO-OPERATIVE

OTTAWA ONTARIO, CANADA

PROJECT

BLOCK 3 **REDEVELOPMENT**


1360 OGILVIE ROAD GLOUCESTER, ON K1J 9M6

GROUND FLOOR PLAN

PROJECT NO: 2022-2040 DRAWN: KM, DF APPROVED: PM As indicated DATE PRINTED: 2025-09-03 4:44:43 PM


REV

DRAWING NO. ₹

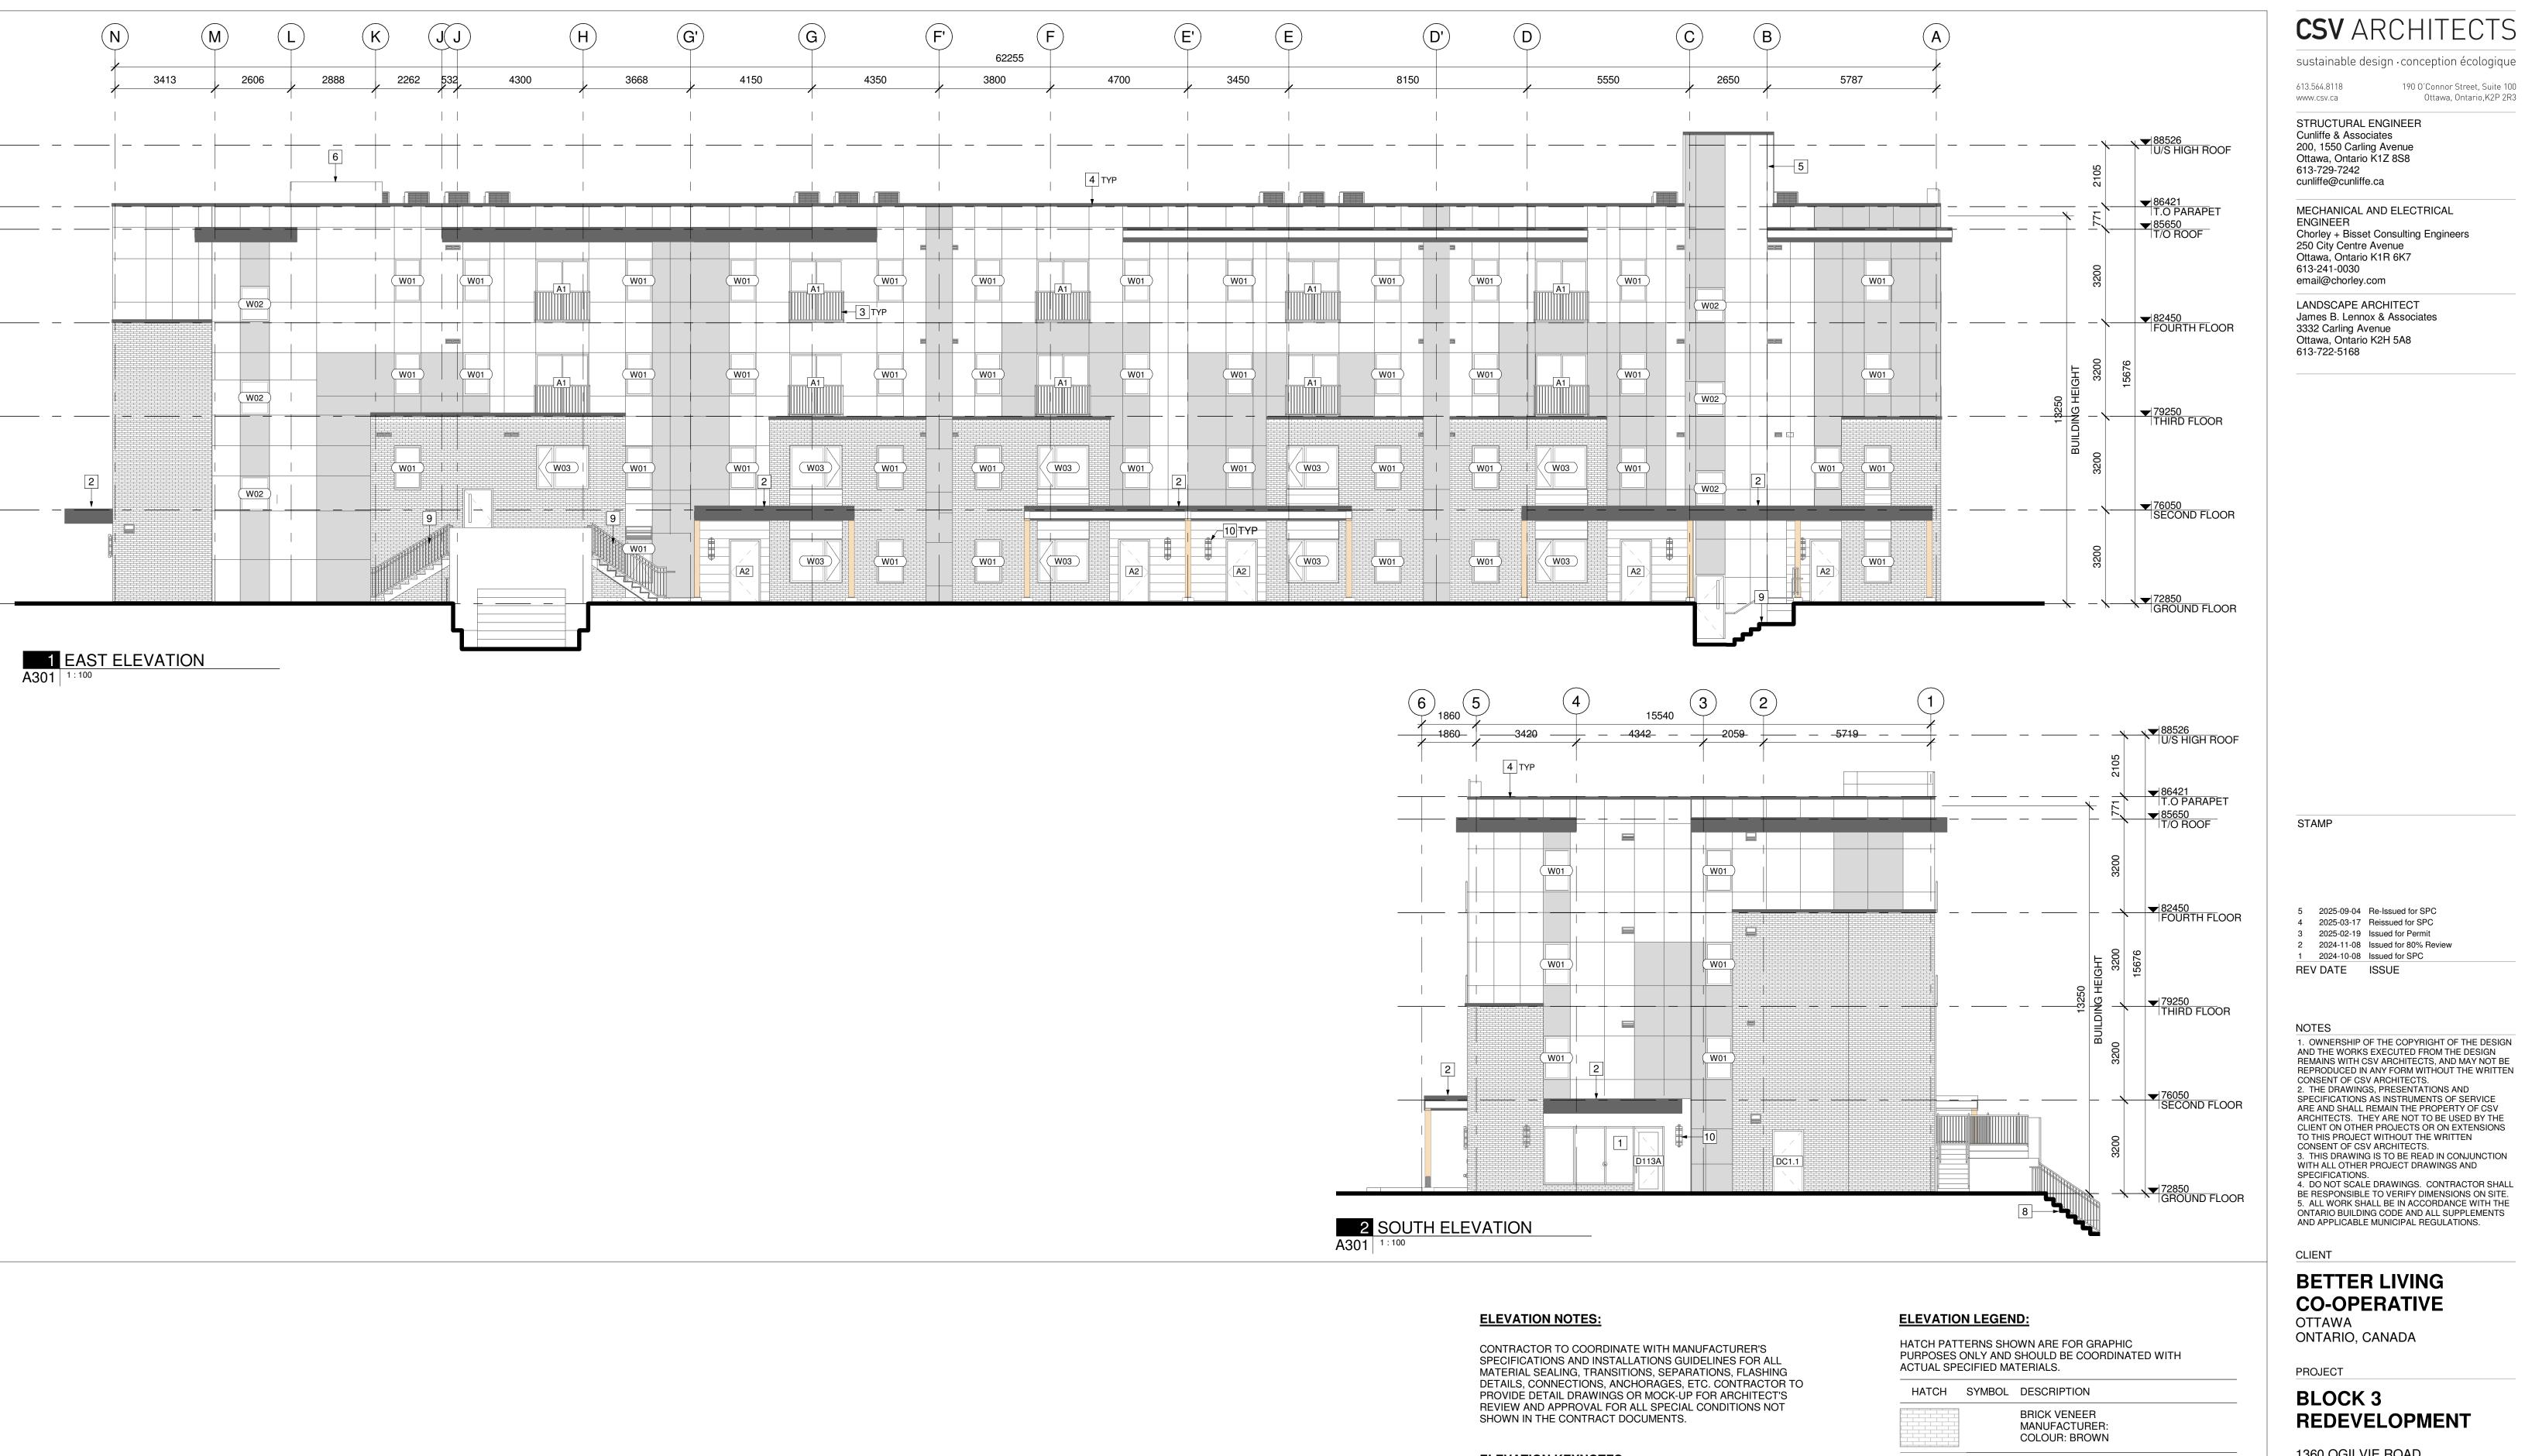

ELEVATION KEYNOTES:

- 1 STOREFRONT WALL SYSTEM
- 2 CANOPY 3 JULIETTE BALCONY
- 4 PREFINISHED METAL FLASHING
- 5 ROOFTOP ACCESS
- 6 ELEVATOR OVERRUN
- 7 GARAGE DOOR 8 NEW LANDSCAPE STAIR C/W HANDRAIL AND GUARDRAIL
- 9 EMERGENCY EXIT STAIR
- 10 EXTERIOR LIGHT FIXTURE

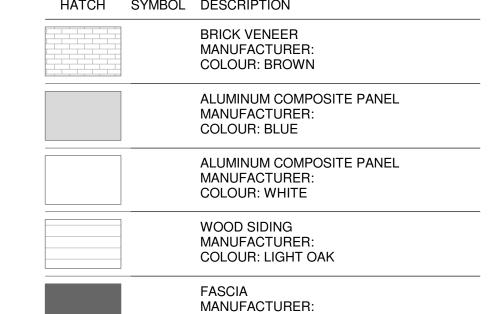

COLOUR: GREY

PROJECT

BLOCK 3 REDEVELOPMENT

1360 OGILVIE ROAD GLOUCESTER, ON K1J 9M6

TITLE **EXTERIOR ELEVATIONS**

PROJECT NO: 2022-2040 DRAWN: DF APPROVED: DH As indicated

REV

DATE PRINTED: 2025-09-03 4:44:54 PM DRAWING NO. 🕹

190 O'Connor Street, Suite 100

Ottawa, Ontario,K2P 2R3



ELEVATION NOTES:

W03

2 NORTH ELEVATION (OGILVIE RD.)

CONTRACTOR TO COORDINATE WITH MANUFACTURER'S SPECIFICATIONS AND INSTALLATIONS GUIDELINES FOR ALL MATERIAL SEALING, TRANSITIONS, SEPARATIONS, FLASHING DETAILS, CONNECTIONS, ANCHORAGES, ETC. CONTRACTOR TO PROVIDE DETAIL DRAWINGS OR MOCK-UP FOR ARCHITECT'S REVIEW AND APPROVAL FOR ALL SPECIAL CONDITIONS NOT SHOWN IN THE CONTRACT DOCUMENTS.

ELEVATION KEYNOTES:

- 1 STOREFRONT WALL SYSTEM
- 2 CANOPY
- 3 JULIETTE BALCONY
- 4 PREFINISHED METAL FLASHING
- 5 ROOFTOP ACCESS
- 6 ELEVATOR OVERRUN
- 7 GARAGE DOOR
- 8 NEW LANDSCAPE STAIR C/W HANDRAIL AND GUARDRAIL
- 9 EMERGENCY EXIT STAIR
- 10 EXTERIOR LIGHT FIXTURE

ELEVATION LEGEND:

W03

HATCH PATTERNS SHOWN ARE FOR GRAPHIC PURPOSES ONLY AND SHOULD BE COORDINATED WITH ACTUAL SPECIFIED MATERIALS.

√72850 GROUND FLOOR

HATCH	SYMBOL	DESCRIPTION
		BRICK VENEER MANUFACTURER: COLOUR: BROWN
		ALUMINUM COMPOSITE PANEL MANUFACTURER: COLOUR: BLUE
		ALUMINUM COMPOSITE PANEL MANUFACTURER: COLOUR: WHITE
		WOOD SIDING MANUFACTURER: COLOUR: LIGHT OAK
		FASCIA MANUFACTURER: COLOUR: GREY

CSV ARCHITECTS

sustainable design · conception écologique

613.564.8118 190 O'Connor Street, Suite 100 Ottawa, Ontario,K2P 2R3 www.csv.ca

STRUCTURAL ENGINEER Cunliffe & Associates 200, 1550 Carling Avenue Ottawa, Ontario K1Z 8S8 613-729-7242

cunliffe@cunliffe.ca

email@chorley.com

MECHANICAL AND ELECTRICAL **ENGINEER** Chorley + Bisset Consulting Engineers 250 City Centre Avenue Ottawa, Ontario K1R 6K7 613-241-0030

LANDSCAPE ARCHITECT James B. Lennox & Associates 3332 Carling Avenue Ottawa, Ontario K2H 5A8 613-722-5168

STAMP

- 2025-09-04 Re-Issued for SPC 4 2025-03-17 Reissued for SPC 3 2025-02-19 Issued for Permit
- 2 2024-11-08 Issued for 80% Review

1 2024-10-08 Issued for SPC REV DATE ISSUE

NOTES 1. OWNERSHIP OF THE COPYRIGHT OF THE DESIGN AND THE WORKS EXECUTED FROM THE DESIGN REMAINS WITH CSV ARCHITECTS, AND MAY NOT BE REMAINS WITH CSV ARCHITECTS, AND MAY NOT BE REPRODUCED IN ANY FORM WITHOUT THE WRITTEN CONSENT OF CSV ARCHITECTS.

2. THE DRAWINGS, PRESENTATIONS AND SPECIFICATIONS AS INSTRUMENTS OF SERVICE ARE AND SHALL REMAIN THE PROPERTY OF CSV ARCHITECTS. THEY ARE NOT TO BE USED BY THE CLIENT ON OTHER PROJECTS OR ON EXTENSIONS TO THIS PROJECT WITHOUT THE WRITTEN CONSENT OF CSV ARCHITECTS. 3. THIS DRAWING IS TO BE READ IN CONJUNCTION WITH ALL OTHER PROJECT DRAWINGS AND SPECIFICATIONS. 4. DO NOT SCALE DRAWINGS. CONTRACTOR SHALL

BE RESPONSIBLE TO VERIFY DIMENSIONS ON SITE. 5. ALL WORK SHALL BE IN ACCORDANCE WITH THE

ONTARIO BUILDING CODE AND ALL SUPPLEMENTS AND APPLICABLE MUNICIPAL REGULATIONS.

BETTER LIVING CO-OPERATIVE

OTTAWA ONTARIO, CANADA

PROJECT

CLIENT

BLOCK 3 **REDEVELOPMENT**

1360 OGILVIE ROAD GLOUCESTER, ON K1J 9M6

TITLE **EXTERIOR ELEVATIONS**

PROJECT NO: 2022-2040 DRAWN: DF APPROVED: DH As indicated

REV

DATE PRINTED: 2025-09-03 4:45:01 PM DRAWING NO. 7