




1 TREE CONSERVATION REPORT & LANDSCAPE PLAN  
SCALE 1:150

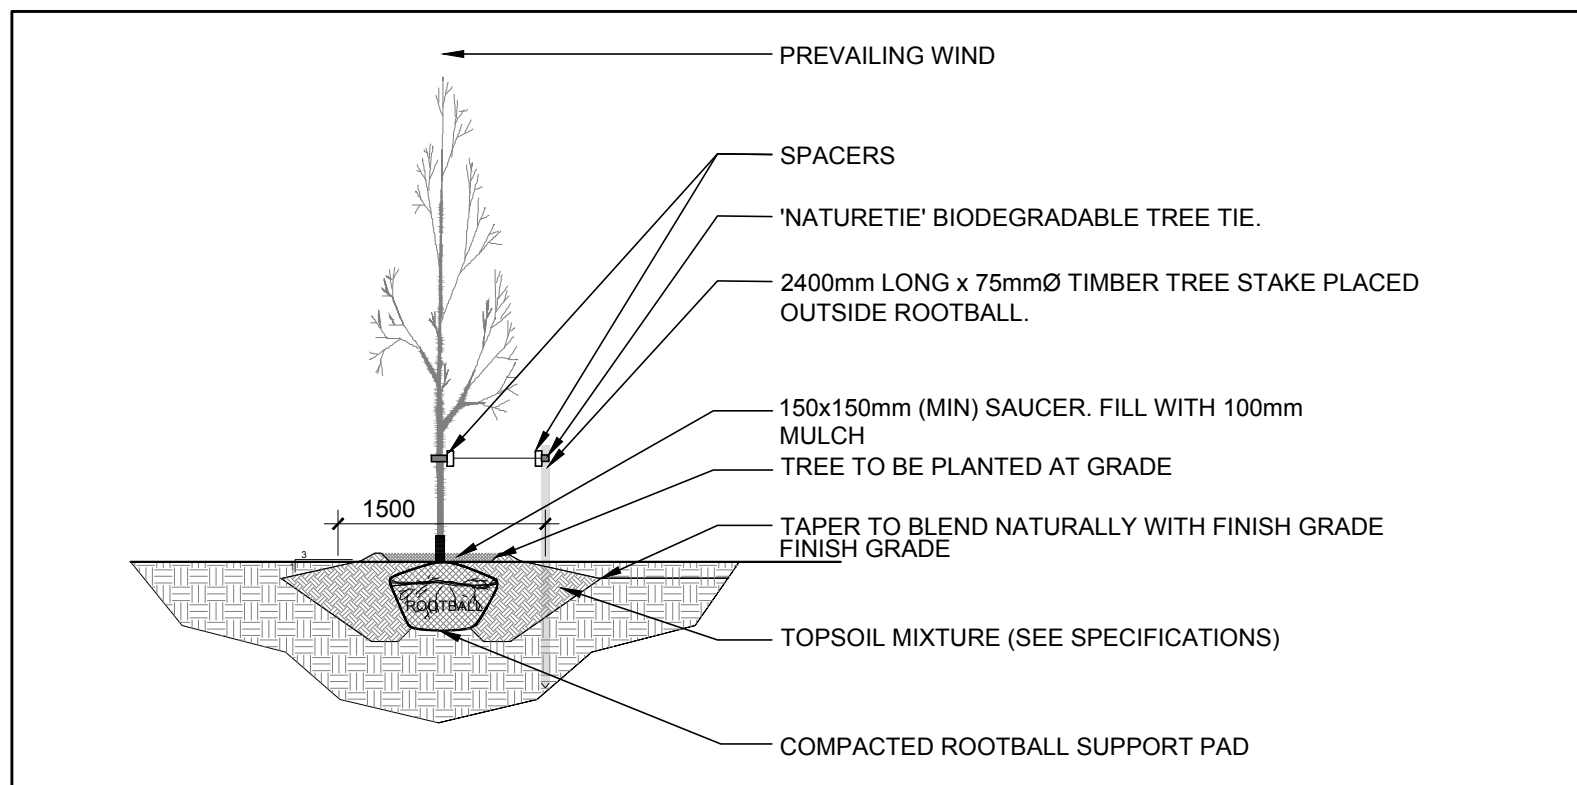


2 DECIDUOUS TREE PLANTING  
SCALE: NTS

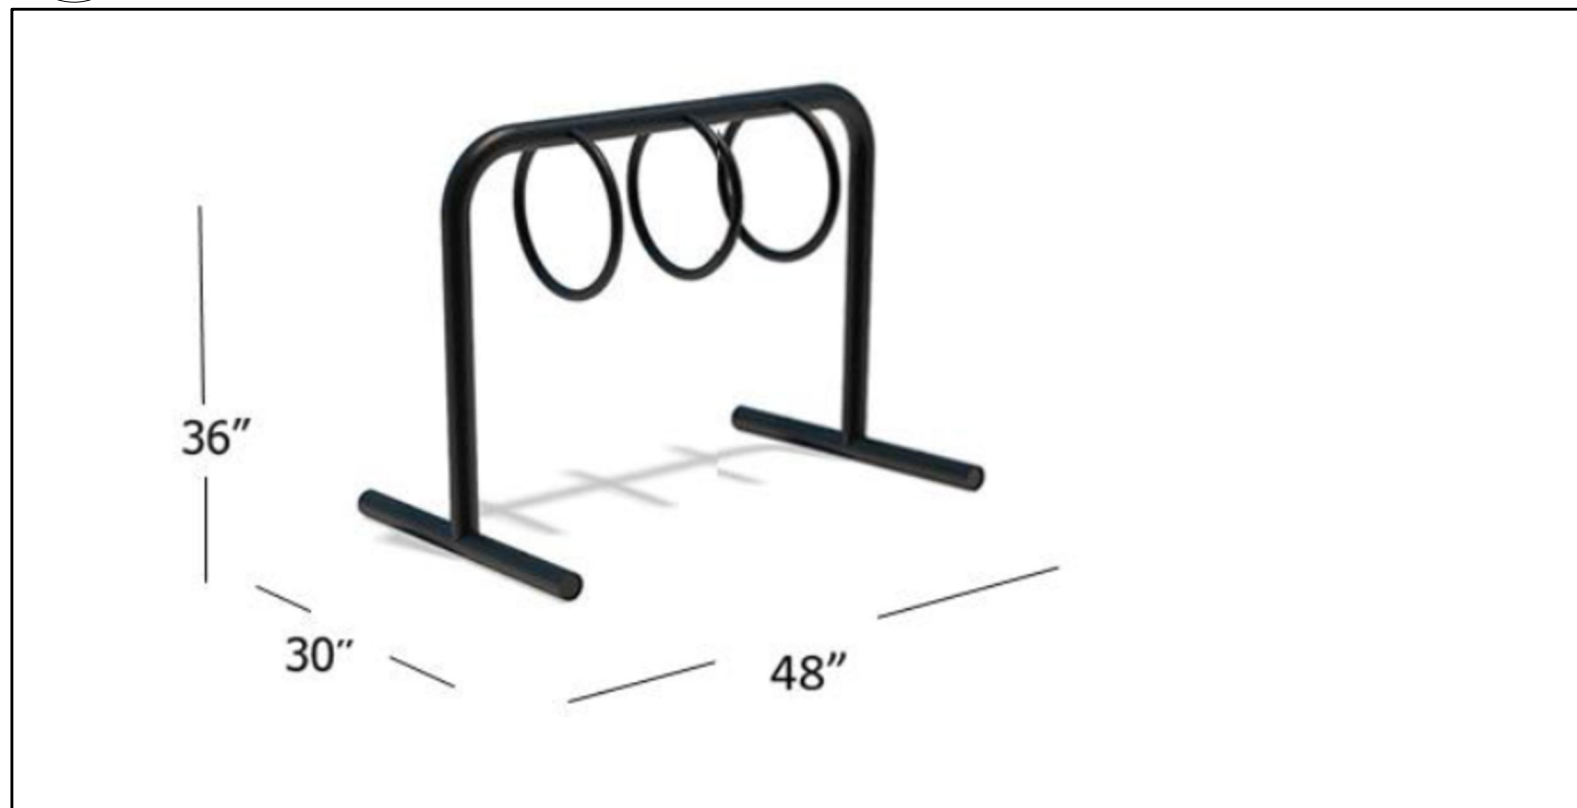


3 THREE (3) RING MAZEWELD ROUND-DEE BIKE RACK FOR 6 BIKES  
SCALE: NTS

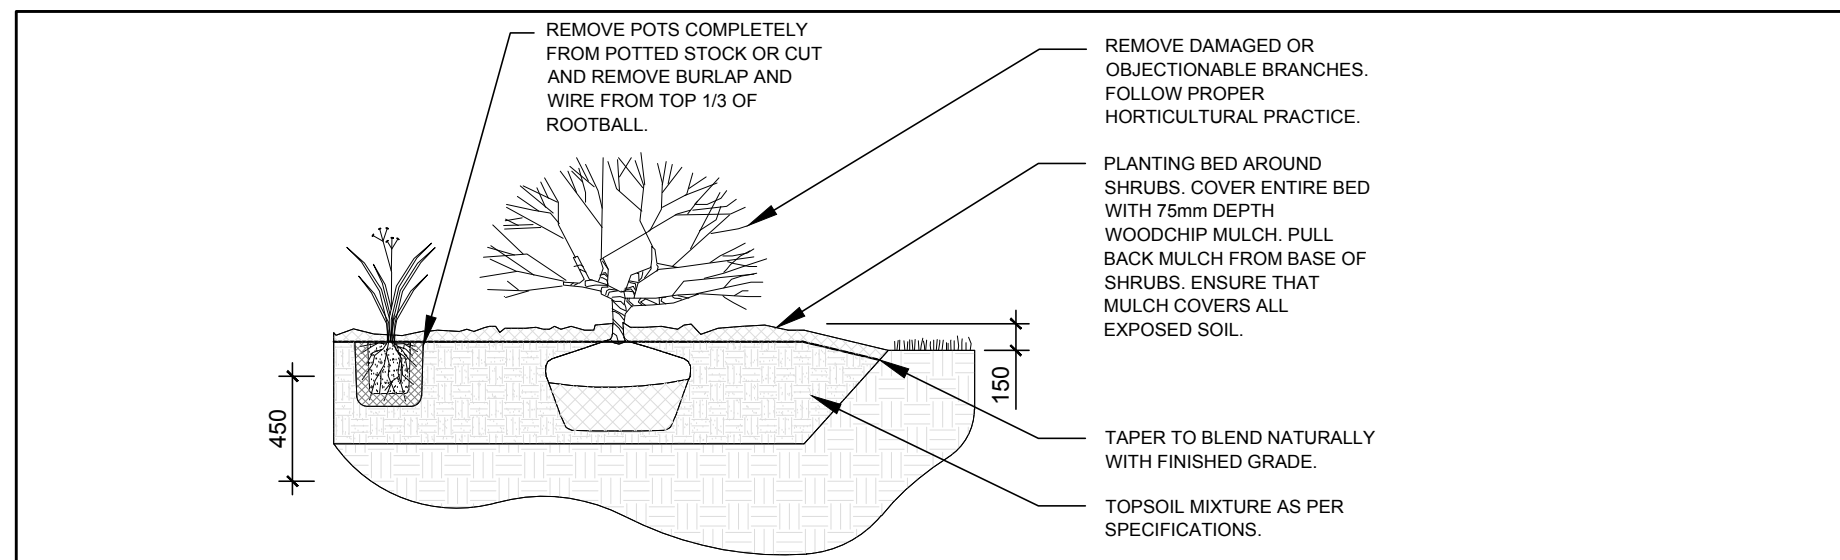


4 PROPOSED SHRUB / PERENNIAL  
SCALE: NTS

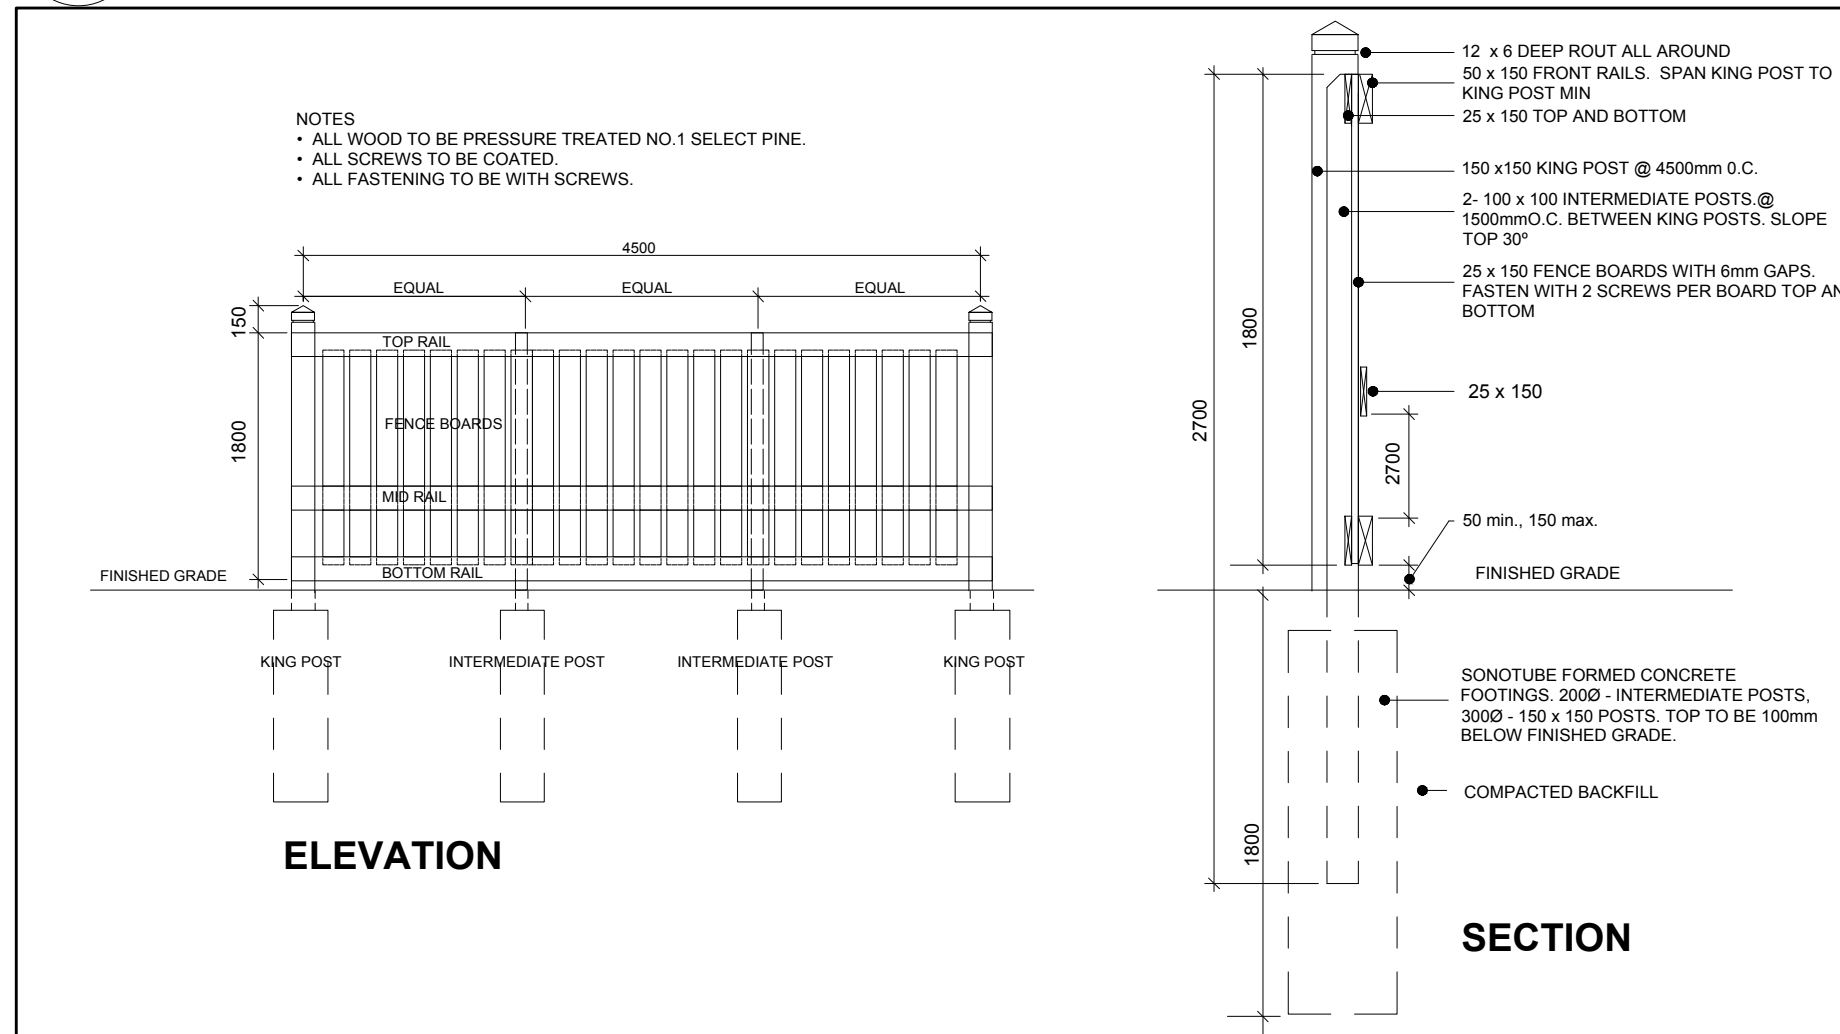

5 PROPOSED 1.8m HT. WOOD SCREEN FENCE  
SCALE: NTS

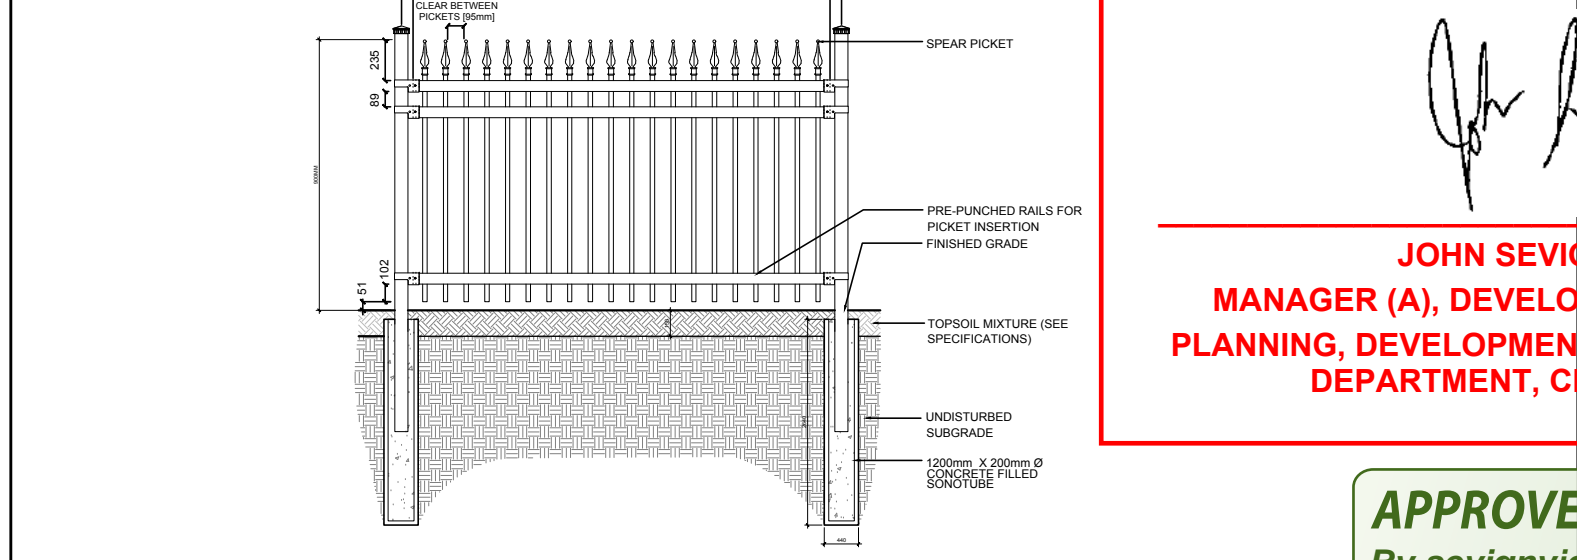

6 PROPOSED 1.2m HT. ORNAMENTAL METAL FENCE  
SCALE: NTS

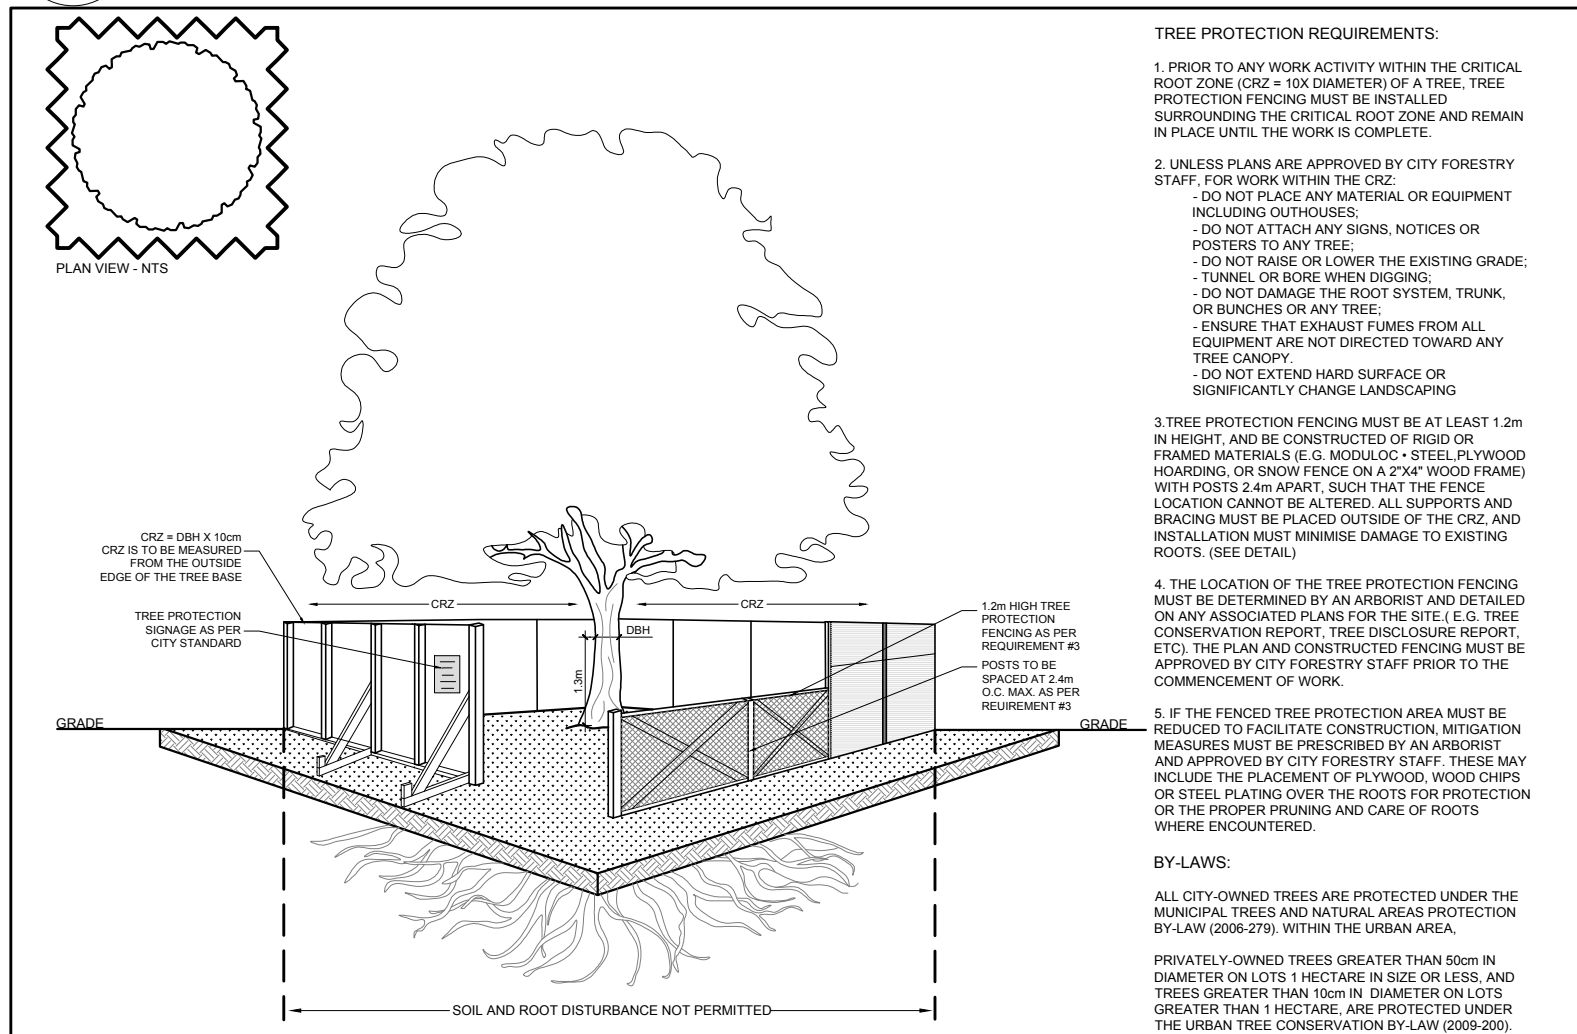

7 TREE PROTECTION FENCE  
SCALE: NTS

| PROPOSED PLANT LIST |      |                                   |                            |              |                    |
|---------------------|------|-----------------------------------|----------------------------|--------------|--------------------|
| KEY                 | QTY. | BOTANICAL NAME                    | COMMON NAME                | SIZE         | CONDITION          |
| TREES               |      |                                   |                            |              |                    |
| AM                  | 1    | Acer x freemanii 'Armstrong'      | Armstrong Maple            | 60mm cal.    | B&B                |
| HL                  | 3    | Gleditsia triacanthos 'Draves'    | Street Keeper Honey Locust | 60mm cal.    | B&B                |
| HB                  | 3    | Celtis occidentalis               | Hackberry                  | 60mm cal.    | B&B                |
| SHRUBS              |      |                                   |                            |              |                    |
| AH                  | 20   | Hydrangea arborescens 'Annabelle' | Annabelle Hydrangea        | 1 gallon pot | Potted             |
| FS                  | 26   | Sorbaria sorbifolia 'Sem'         | Sem False Spirea           | 600mm ht.    | Potted             |
| WC                  | 14   | Thuja occidentalis 'Clumps'       | White Cedar Clumps         | 2.4m ht.     | Potted / bare root |
| PERENNIALS          |      |                                   |                            |              |                    |
| GH                  | 30   | Hosta 'Guacamole'                 | Guacamole Hosta            | 250mm pot    | Potted             |
| PH                  | 23   | Hosta 'Patriot'                   | Patriot Hosta              | 250mm pot    | Potted             |

| EXISTING TREE LIST |      |                    |                   |                 |           |
|--------------------|------|--------------------|-------------------|-----------------|-----------|
| KEY                | QTY. | BOTANICAL NAME     | COMMON NAME       | SIZE            | CONDITION |
| TREES              |      |                    |                   |                 |           |
| AG                 | *    | Acer ginnala       | Amur Maple        | 100mm dbh       | Good      |
| AN                 | 4    | Acer negundo       | Manitoba Maple    | 150-400mm dbh   | Fair-Good |
| AP                 | 2    | Acer platanoides   | Freeman's Maple   | 250mm dbh       | Good      |
| MA                 | 1    | Malus sp.          | Crabapple         | 200mm dbh       | Good      |
| TC                 | 4    | Tilia cordata      | Littleleaf Linden | 200-300mm dbh   | Fair-Good |
| TO                 | *    | Thuja occidentalis | White Cedar       | 100-200mm dbh   | Good      |
| UA                 | 1    | Ulmus americana    | American Elm      | 2x400-450mm dbh | Good      |

GENERAL NOTES:

- It is the responsibility of the appropriate contractor or official to report any errors, omissions or discrepancies on this plan with actual site conditions to the Landscape Architect before proceeding with construction.
- The contractor is to notify all utility companies and authorities prior to any excavation and ascertain locations of underground services.
- The contractor is to reinstate all areas and items damaged as a result of construction activity.
- The contractor is to comply with all pertinent codes and by-laws.
- The contractor is to maintain a positive surface run-off throughout the entire construction period.
- The Landscape Architect is not responsible for subsurface conditions.
- The contractor is to identify all existing trees to remain on site with the Landscape Architect prior to construction.
- The contractor is to stake the proposed location of all plant material in conjunction with the Landscape Architect prior to excavation.
- Minimum distances for selected deciduous trees are as follows:
  - Building Foundations 7.5m
  - Sidewalks 1.5m
  - Public Streets 2.5m
  - Underground Infrastructure 2.0m
- All trees within 1m of underground utility trenches are to be excavated by hand.
- Remove all protective wrapping from tree trunks after installation.
- Staking of trees shall only be performed if necessary.
- Ensure that mulch is pulled back a min. distance of 75mm from base of tree trunk.
- All trees planted in the City road allowance shall be warranted for two years from the date of substantial performance as determined by the City of Ottawa.

JOHN SEVIGNY C.E.T.  
MANAGER (A), DEVELOPMENT REVIEW EAST  
PLANNING, DEVELOPMENT & BUILDING SERVICES  
DEPARTMENT, CITY OF OTTAWA

APPROVED  
By sevignyjo at 3:15 pm, Sep 02, 2025

CLIENT: **BRIDOR** Developments

996-B St. Augustin Rd  
Embrun, ON K0A 1W0  
Tel : (613) 443-3575

CONSULTANTS

ARCHITECTS: **P2 concepts**

739 RIDGEWOOD AVE., UNIT 201  
OTTAWA, ONTARIO, K1V 6H8

CIVIL ENGINEERS: **TATHAM ENGINEERING**

5335 Canotek Rd Unit 103,  
Gloucester, ON K1J 9L4  
Tel : (613) 747-3636

LEGEND

- PROPOSED CONCRETE
- PROPOSED DECIDUOUS TREE
- PROPOSED SHRUBS / PERENNIALS
- PROPOSED SOD
- PROPOSED RIVERSTONE MULCH
- PROPOSED TREE PROTECTION FENCE
- EXISTING TREE TO REMAIN
- EXISTING HEDGE TO REMAIN
- EXISTING TREE TO BE REMOVED
- EXISTING 1.5m HT. GALVANIZED CHAINLINK FENCE TO REMAIN
- PROPOSED 1.8m HT. WOOD SCREEN FENCE
- PROPOSED 1.2m HT. ORNAMENTAL METAL FENCE
- PROPOSED BENCH

|    |                                  |            |    |    |
|----|----------------------------------|------------|----|----|
| 16 | REVISED PER NEW CIVIL DRAWING    | 03/20/2024 | ML | JL |
| 15 | ISSUED FOR DISCUSSION AND REVIEW | 03/13/2024 | ML | JL |
| 14 | ISSUED PER NEW SITE PLAN         | 03/08/2024 | ML | JL |
| 13 | REVISED PER NEW SITE PLAN        | 12/14/2023 | ML | JL |
| 12 | FENCE ADDED NORTH OF PATHWAY     | 12/13/2023 | ML | JL |
| 11 | REVISED PER CITY COMMENTS        | 12/08/2023 | ML | JL |
| 10 | REVISED PER NEW CIVIL DRAWING    | 06/16/2023 | ML | JL |
| 9  | REVISED PER NEW CIVIL DRAWING    | 06/07/2023 | ML | JL |
| 8  | REVISED PER NEW SITE PLAN        | 12/21/2022 | ML | JL |
| 7  | REVISED PER CITY COMMENTS        | 12/05/2022 | ML | JL |
| 6  | PAVERS CHANGED TO CONCRETE       | 11/22/2022 | ML | JL |
| 5  | REVISED PER CITY COMMENTS        | 11/10/2022 | ML | JL |
| 4  | REVISED PER NEW CIVIL DRAWING    | 07/13/2022 | ML | JL |
| 3  | LEGEND REVISED                   | 09/23/2021 | ML | JL |
| 2  | RE-ISSUED FOR SITE PLAN CONTROL  | 04/19/2021 | ML | JL |
| 1  | ISSUED FOR SITE PLAN CONTROL     | 03/09/2021 | ML | JL |

**JAMES B. LENNOX & ASSOCIATES INC.**  
LANDSCAPE ARCHITECTS

3332 CARLING AVE. OTTAWA, ONTARIO K2H 5A8  
Tel. (613) 722-5168 Fax. (613) 443-3942

PROJECT  
STACKED TOWNHOUSES  
1592 TENTH LINE ROAD, OTTAWA ON

DRAWING  
TREE CONSERVATION REPORT &  
LANDSCAPE PLAN

STAMP

SCALE  
AS SHOWN

START DATE  
FEBRUARY 2021

PROJECT NO.  
21MIS2124

DRAWING NO.  
L.1

PLOT SIZE ARCH-D