

BCCO CHURCH ADDITION

1981 CENTURY RD W, NORTH GOWER, ON

ISSUED FOR SPC RESPONSE 01 2025.08.21

ARCHITECTURAL DRAWINGS



S.J. LAWRENCE ARCHITECT INC.

18 DEAKIN ST. SUITE 205

(P) 613 739 7770 (F) 613 739 7703

OTTAWA, ONTARIO K2E 8B7

STRUCTURAL DRAWINGS



CLELAND JARDINE ENGINEERING LIMITED

580 TERRY FOX DR. SUITE 200 KANATA, ONTARIO K2L 4B9

> (P) 613 591 1533 (F) 613 591 1703

CIVIL DRAWINGS



TATHAM ENGINEERING

5335 CANOTEK ROAD, UNIT 100 OTTAWA, ONTARIO K1J 9L4 (P) 613 747 3636

MECHANICAL/ELECTRICAL DRAWINGS



GOODKEY WEEDMARK CONSULTING ENGINEERS

1688 WOODWARD DRIVE OTTAWA, ONTARIO K2C 3R8

> (P) 613 727 5111 (F) 613-727 5115


<u>PLANNER</u>




Q9 PLANNING & DESIGN

43 ECCLES ST. UNIT C OTTAWA, ONTARIO K1R 6S3

(P) 613 850 8345

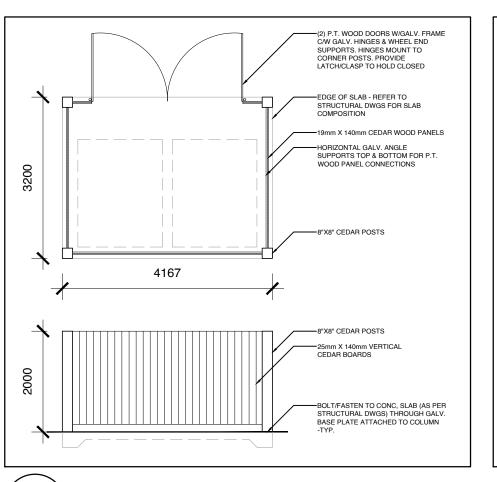

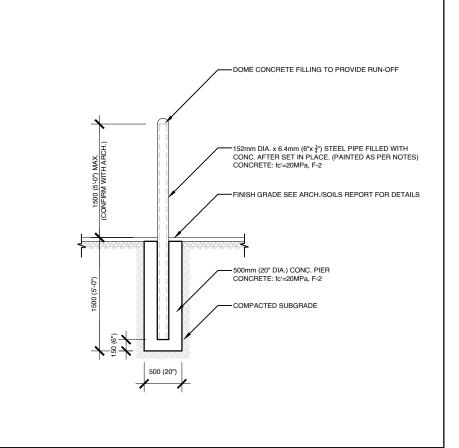



CONCESSION 2 GEOGRAPHIC TOWNSHIP OF NORTH GOWER CITY OF OTTAWA PREPARED BY ANNIS, O'SULLIVAN, VOLLEBEKK LTD. AOV JOB NO.: 23827-23 BCCO LtLt5 CS T D2 DATE OF SURVEY: MAY 11TH, 2023


PROPERTY LEGAL DESCRIPTION


PART OF LOT 5

PROJECT ZONING REVIEW/STATISTICS MUNICIPALITY: CITY OF OTTAWA MUNICIPAL ADDRESS: 1981 CENTURY ROAD, NORTH GOWER, ON REGISTERED OWNER: BRUNSTAD CHRISTIAN CHURCH LOT AREA: 36,422.13m² **ZONING ANALYSIS** OTTAWA PROPOSED USE: 2 STOREY CHURCH ADDITION





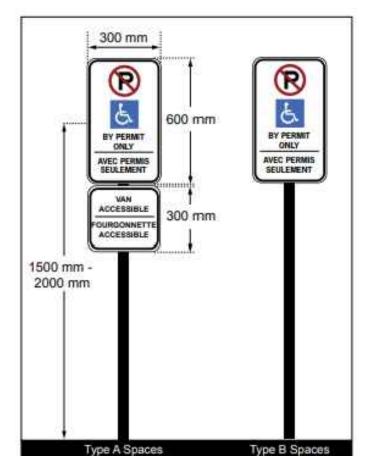

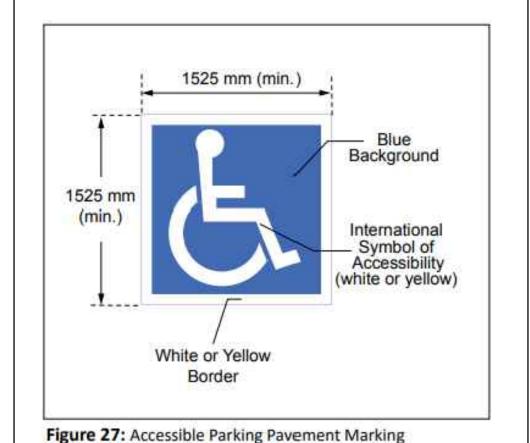

ACCESSIBLE PARKING SIGNAGE DETAIL (A0.1 SCALE: NTS

Figure 26: Accessible Parking Vertical Signage

ONTARIO BUILDING CODE MATRIX:

Occupancy "X"

22 Other (describe)

Item	BCCO CHURCH ADDITION OBC Reference													
1	Project	Descr		_ 555 5110	New Part 11			☑ Part 3			☐ Part 9)		
·				☐ Change	X	Addition	11.1 to		1.1.2.				&9.10.1.3.	
2	Maior C)ccupa	ancv (s	Group "A	2"				3.1.2.	1. (1)		9.10.2.		
3	Major Occupancy (s) Group "A2" Building Area (m²) Existing 861.8 New 2,507.2 Total 3,369.0m²											1.1.1.2. [A]		
4	Gross Area (m²) Existing 861.8 New 3,210.5 Total 4,072.3m²										1.1.1.2. [A]			
5	Number of Storeys Above Grade 2 Below Grade 1								1.4.1.2. [A] & 3.2.1.1.			1.1.1.2. [A] & 9.10.4.		
6					<u> </u>	B0.011	<u> </u>	'		L. [/ ·] G O.L		· · · · · · · · · · · · · · · · · · ·	4 0.10.1.	
7										3.2.2.10. & 3.2.5.		9.10.20.		
8	Building				Access 1				3.2.2.2083		9.10.20.			
9	_													
9					Entire Building Selected Compartments Selected Floor Areas Basement in lieu of roof rating Not Required				3.2.2.2083 3.2.1.5. 3.2.2.17. INDEX			9.10.8.2. INDEX		
10	Standpi	pe Re	quired			☐ Yes	⊠ No		3.2.9.			N/A		
11	Fire Ala	-	•				□ No		3.2.4.			9.10.18.		
12		Water Service/ Supply is adequate ✓ Yes □ No 3.2.5.7.								N/A				
13	High Building								N/A					
14										9.10.6.				
4-1	Actual (_				e⊠ Non-Co			J.Z.Z.ZU. - .00		J. 10.0.			
15	Mezzan								3.2.1.1. (3)-(8)			9.10.4.1.		
16					²/person	▼ Design	of buildin	na				9.9.1.3.		
10	Occupant load based on													
17	Barrier-	Barrier-free Design ☐ Yes ☐ No (Ground floor Only)				Only)	3.8.			9.5.2.				
18	Hazardo	ous Si	ubstan			No .			3.3.1.	.1.2. & 3.3.1.19		9.10.1.3. (4)		
19	Required Horizontal Asser Fire FRR (Hours Resistance			or Description (SG-2)			3.2.2.2083 & 3.2.1.4.			9.10.8. 9.10.9.				
	Ratir		Floors											
	(FRR)		Roof		\ Hours									
			Mezz											
			FR	R of Suppor Members	rting Listed De- or Descripti									
			Floors	s 1	Hours	Fire Sepa	Fire Separation Only							
			Roof	N/A	Hours				1					
			Mezz	Mezzanine 1 Hours										
20	Spatial	Separ	ation -	Construction	n of Exter	ior Walls			3.2.3.			9.10.14.		
			a of (m²)	L.D. (m)	L/H or H/L	Permitted Max % of	FRR (Hours)	1	ted ign or		ruction		dding	
			. ,	` '		openings	. ,		ription	Comb.	NonComb.	Comb.	NonComb	
	North	()	0	L/H, H/L	0%	0	ORC	SB-0					
	South)	0	L/H, H/L	0%	0		SB-0					
	East)	0	L/H, H/L	0%	0		SB-0					
	West)	0	L/H, H/L	0%	0		SB-0					
						U 70	U	UBC	U-DC	ш				
21	Plumbing Fixture Requirements Male/Female Count									Building Code Reference				
	@ 0 % / 0 % except as noted otherwise				Occupant Load	BC Table Number			ctures ovided	□ Part 3		☐ Part 9		
	Basement Occupancy			ancy "X"	0	Table #	0		0	3.0.0.		9.0.0.		
			Occupa		0	Table #	0		0	3.0.0.		9.0.0.		
	1st Floor Occupancy "X" Occupancy "X"				- "									
				ancy "X"										

GENERAL NOTES:

- 1. ALL WALLS TO BE CONTINUOUS FROM SLAB TO SLAB UNLESS NOTED OTHERWISE.
- 2. ALL INTERIOR CORRIDORS AND DEMISING WALLS BETWEEN SUITES TO BE TYPE W1 UNLESS OTHERWISE NOTED.

03 \ KEY PLAN

A0.1 SCALE: NTS

- 3. REFER TO FINISH SCHEDULE ON DRAWINGS. REPLACE GYPSUM BOARD WITH CEMENT BOARDS IN ALL AREAS HAVING CERAMIC TILE WALL FINISH.
- 4. INTERIOR STUD WALLS: PROVIDE TWO ROWS OF CONTINUOUS ACOUSTIC CAULKING AT STUD TRACK AT TOP OF SLAB, UNDERSIDE OF SLAB AND AT VERTICAL FACE WHERE STUDS ABUT STRUCTURE.
- 5. PIECEMEAL OF GYPSUM BOARD SHEETS IS NOT ACCEPTABLE.
- 6. INNER LAYERS OF GYPSUM BOARD SHOULD HAVE NO GAPS OVER 1/4". 7. INNER LAYERS OF GYPSUM BOARD SHOULD BE TAPED NOT SANDED.
- 8. JOINTS OF LAYERED GYPSUM BOARD SHOULD BE STAGGERED.
- 9. CAULK AT TOP AND BOTTOM OF WALLS AT EDGE OF GYPSUM BOARD PANELS.
- 10. PROVIDE CAULKING ROD BACKUP AT ANY GAP OVER 1/4".
- 11. ELECTRICAL BOXES ON OPPOSING FACES OF WALL SHALL BE LOCATED IN SEPARATE STUD CAVITIES.
- 12. RUN FIBERGLASS BATT INSULATION BEHIND AND AROUND ALL ELECTRICAL BOXES. NO BACK TO BACK ELECTRICAL BOXES.
- 13. BACKING TO BE PROVIDED AT ALL MILLWORK LOCATIONS, TO BE COORDINATED ON SITE.
- 14. ALL PENETRATIONS THROUGH ACOUSTICAL RATED WALLS (PARTY WALLS AND CORRIDOR WALLS) MUST BE SEALED TIGHT WITH A COMBINATION OF JOINT COMPOUND AND ACOUSTICAL CAULK.
- 15. ALL PENETRATIONS THROUGH FIRERATED WALLS (PARTY WALLS, CORRIDOR WALLS, ETC) MUST BE SEALED TIGHT WITH A COMBINATION OF JOINT COMPOUND AND FIRE CAULK, TO ENSURE
- 16. PROVIDE WOOD BLOCKING WITHIN WALL TO PROVIDE ANCHORAGE FOR CABINETS, WASHROOM ACCESSORIES, HAND RAILINGS, ETC. BLOCKING SHALL NOT LINK BOTH SIDES OF A WALL. PLYWOOD MAY BE USED AS BLOCKING ON THE INNER LAYER OF DOUBLE LAYER WALL ASSEMBLIES. 18GA METAL STRIPS IN 6" IN WIDTH & CONTINUOUS THROUGHOUT LENGTH OF BLOCKING
- 17. PROVIDE ¾" DOUGLAS FIR PLYWOOD, GOOD ONE SIDE WITH FIRE RETARDANT PAINT, FOR MOUNTING OF ALL ELECTRICAL PANELS, CABLING, COMMUNICATION, BELL, AND SECURITY PANELS. REFER TO ELECTRICAL DRAWINGS FOR LOCATIONS.
- 18. ALL OPENINGS FOR DOORS WITHIN CONCRETE BLOCK WALLS WITH EXPOSED BLOCK JAMBS SHALL HAVE EXPOSED JAMBS CONSTRUCTED USING BULLNOSE BLOCK.
- 19. THICKEN WALLS AS REQUIRED TO ACCOMMODATE ELECTRICAL PANELS & MECHANICAL ITEMS. CONTRACTOR TO CONFIRM CODE COMPLIANCE WITH ARCHITECT BEFORE SITE WORK BEGINS. 20. PROVIDE WALL ASSEMBLY ABOVE ALL DOORS, WINDOWS, GLAZED SCREENS & GLASS BLOCK SIMILAR TO ADJACENT WALL TYPE UP TO U/S OF STRUCTURAL SLAB ABOVE.
- 21. ALL EXPOSED CONCRETE TO BE ENCLOSED WITH 12.7mm GYPSUM BOARD ON 22mm FURRING CHANNELS UNLESS NOTED OTHERWISE ON PLANS OR DETAILS. 22. FOR ASSEMBLIES REQUIRING TO CONFORM TO A LISTED ULC/UL RATING, MATERIALS WITHIN THE ASSEMBLY SHALL BE EXACTLY AS PER THE TESTED ASSEMBLY. ALL MATERIAL SHALL BE
- LABELED WITH ULC/UL IDENTIFICATION. 23. ALL ELECTRICAL SWITCHES ARE TO BE LOCATED BETWEEN 4"-8" FROM THE ENTRANCE DOOR TO A ROOM. LOCATE STUDS TO ACCOMMODATE THE LOCATION OF SWITCHES SHOWN ON
- ELECTRICAL DRAWINGS AND SUIT THE APPROVED SUITE MOCK-UP.
- 24. PROVIDE SCUPPERS AT EDGES OF ROOF WHERE OVER FLOW CONTROL ROOF DRAINS ARE SPECIFIED. CONFIRM LOCATIONS WITH ARCHITECT.
- 25. ALL FIRE DAMPER INSTALLATION TO BE PER MANUFACTURER INSTRUCTIONS HVAC CONTRACTOR TO COORDINATE ON SITE WITH DRYWALL/FRAMING CONTRACTOR TO ENSURE INSTALLATION INSTRUCTIONS ARE FOLLOWED EXACTLY.
- 26. PROVIDE ALL CLOSETS WITH MINIMUM 1 FULL WIDTH SHELF 12" DEEP AND WITH ONE FULL WIDTH HANGER ROD.
- 27. ANY WASHROOM WALLS ADJACENT TO LIVING SPACES/PUBLIC AREAS ARE TO HAVE SOUND ATTENUATING BATT INSULATION -ULC APPROVED- IN THE STUD CAVITIES (TO FILL CAVITY).
- 28. ALL STEEL STUDS TO BE FRAMED @ 400mm o/c U.N.O ON PLAN.
- 29. ALL STEEL STUDS ARE TO EXTEND TO UNDERSIDE OF CONC. SLAB U.N.O. 30. ALL GYPSUM BOARD IS TO EXTEND TO FULL HEIGHT OF PARTITION U.N.O.

LIST OF ABBRIEVIATIONS

ALUM

ARCH

ASSY

BLDG

CLG CLR

COL CONC

DIM

ELEC

ELEV

EIFS

ES EXP

LTG MAX

MECH

MIN NBC

NO NTS OC

OH PT

PLAM

PSF PVC RCP

REINF

REQD

RWL

U/S

VEST

ACOUSTIC CEILING TILE ABOVE FINISH FLOOR ALUMINUM ARCHITECTURAL ASSEMBLY BOARD **BUILDING GRADE** BUILDING CATCH BASIN CENTER TO CENTER CONTROL JOINT CENTER LINE CEILING CLEAR COLUMN CONCRETE CARPET CARD READER CERAMIC TILE

CURTAIN WALL DIMENSION HANDICAP DOOR OPERATOR **ELEVATION** ELECTRICAL ELEVATOR **EXTERIOR INSULATED & FINISH** SYSTEM ELECTRICAL PANEL EMERGENCY SCUPPER EXPOSED EXTERIOR FIRE ALARM FLOOR DRAIN

FIRE EXTINGUISHER CABINET FIRE HOSE CABINET **FLOOR** FIRE RESISTANCE RATING GLASS/ GLAZING GRAB BAR GYPSUM WALLBOARD **HOLLOW METAL** HOT WATER TANK INTERIOR JOINT MAXIMUM MEDICINE CABINET MINIMUM NUMBER

LIGHTING MECHANICAL NATIONAL BUILDING CODE NOT TO SCALE ON CENTER OVERHEAD PRESSURE TREATED PLASTIC LAMINATE PRESSED STEEL FRAME POLY VINYL CHLORIDE REFLECTED CEILING PLAN ROOF DRAIN REINFORCED REQUIRED RAIN WATER LEADER SHOWER SIMILAR STAINLESS STEEL TOP OF TYPICAL

VINYL COMPOSITION TILE

UNDERSIDE

VESTIBULE

WATER CLOSET

DRAWING SYMBOLS REFERENCE BUBBLE DRAWING NUMBER SHEET NUMBER

ROOM LABEL **ROOM NAME ROOM NUMBER** DOOR LABEL

116.1 DOOR NUMBER

WINDOW LABEL - BASEMENT - MAIN FLOOR B2 - SECOND FLOOR - THIRD FLOOR

CONSTRUCTION ASSEMBLY (W) - WALL (EW) - EXISTING WALL (P) - PARTITION - FLOOR (R) - ROOF CEILING ELEVATION

CEILING MATERIAL CEILING FINISH HEIGHT

GRID REFERENCE GRID DESTINATION **ELEVATION HEIGHT**

ELEVATION HEIGHT

REVISION LOCATION AND NUMBER MECHANICAL UNIT

REVISION

(SYMBOL IS ONLY A DIAGRAMMIC REPRESENTATION OF THE ACTUAL UNIT VERIFY SIZE AND CONNECTION MECH. REQUIREMNTS) -REFER TO MECHANICAL

SHEET INDEX:

A1.0

A2.0

A2.1

A2.2

A4.1

(#) - WINDOW No.

(#) - ASSEMBLY No.


NOTES, OBC MATRIX & BUILDING ASSEMBLIES PROPOSED SITE PLAN

PROPOSED BASEMENT PLAN PROPOSED GROUND FLOOR PLAN PROPOSED SECOND FLOOR PLAN

PROPOSED ELEVATIONS

PROPOSED ELEVATIONS PERSPECTIVES

TYPICAL DETAILS:

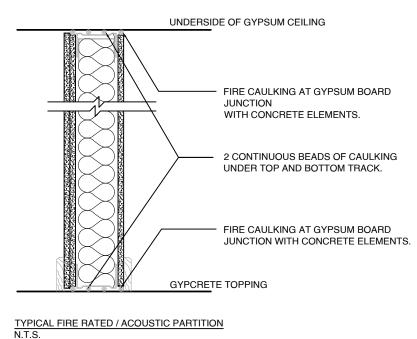

OTTAWA, ONTARIO T: (613) 739.7770 F: (613) 739.7703

lo. DATE

S.J.LAWRENCE

INCORPORATED

18 DEAKIN STREET

ARCHITECT

CLIENT NAME:

CHURCH

3) DO NOT SCALE DRAWINGS

ACCURACY

CONSULTANTS:

ARCHITECTURAL DRAWINGS S.J. LAWRENCE ARCHITECT INC. 205-18 DEAKIN STREET, NEPEAN, ON K2E 8B7 613.739.7770

STRUCTURAL DRAWINGS

CLELAND JARDINE (BPA)

613.591.1533

CIVIL DRAWINGS

SEPTIC DRAWINGS PATERSON GROUP

LANDSCAPE DRAWINGS

VS LANDSCAPE GROUP 4886 BANK ST, OTTAWA, ON K1X 1G7

613.747.3636

613.226.7381

613.774.5296 URBAN PLANNER

ATHAM ENGINEERING

580 TERRY FOX DR, KANATA, ON K2L 4B9

MECHANICAL & ELECTRICAL DRAWINGS

9 AURIGA DRIVE, OTTAWA, ON K23 7T9

Q9 PLANNING + DESIGN 43 ECCLES ST UNIT C, OTTAWA, ON K1R 6S3

ARCHITECTS

NORTH ARROW:

GOODKEY, WEEDMARK & ASSOCIATES LTD. (GWAL) 1688 WOODWARD DR. OTTAWA, ON K2C 3R8 613.727.5111

100-5335 CANOTEK RD, GLOUCESTER, ON K1J 9L4

BCCO BRUNSTAD CHRISTIAN

1) ALL WORK TO BE IN COMPLIANCE WITH LOCAL BUILDING CODES, REGULATIONS AND BY-LAWS.

CLARIFICATION TO ASSIST PROPER EXECUTION OF WORK. SUCH DRAWINGS WILL HAVE THE SAME MEANING AND INTENT AS IF THEY WERE INCLUDED WITH PLANS IN CONTRACT DOCUMENTS.

4) ALL SUB-CONTRACTORS TO TAKE THEIR OWN ON-SITE MEASUREMENTS AND BE RESPONSIBLE FOR THEIR

5) NOTIFY SHAWN J. LAWRENCE ARCHITECT FOR ANY ERRORS AND/OR OMISSIONS PRIOR TO START OF WORK

2) ADDITIONAL DRAWINGS MAY BE ISSUED FOR

SUITE 205 RCHITE INCORPORATED sjl@sjlarchitect.com

THIS DRAWING IS THE SOLE PROPERTY OF S.J. LAWRENCE ARCHITECT INCORPORATED

2025.08.21 ISSUED FOR SPC RESPONSE 01

2025.08.06 ISSUED FOR COORDINATION

2025.07.02 ISSUED FOR COORDINATION

2025.05.08 ISSUED FOR COORDINATION

2024.12.05 ISSUED FOR COORDINATION

2024.08.29 ISSUED FOR COORDINATION

REVISION

2025.03.12 ISSUED FOR SPC

REPRODUCTION IS NOT PERMITTED

BCCO CHURCH ADDITION


1981 CENTURY RD W, NORTH GOWER, ON

NOTES, OBC MATRIX & **BUILDING ASSEMBLIES** PROJECT DATE: 2023.03.15

2025.08.21 JOB NUMBER SL-1090-23 SHEET NUMBER:

APPLICATION #

AS SHOWN

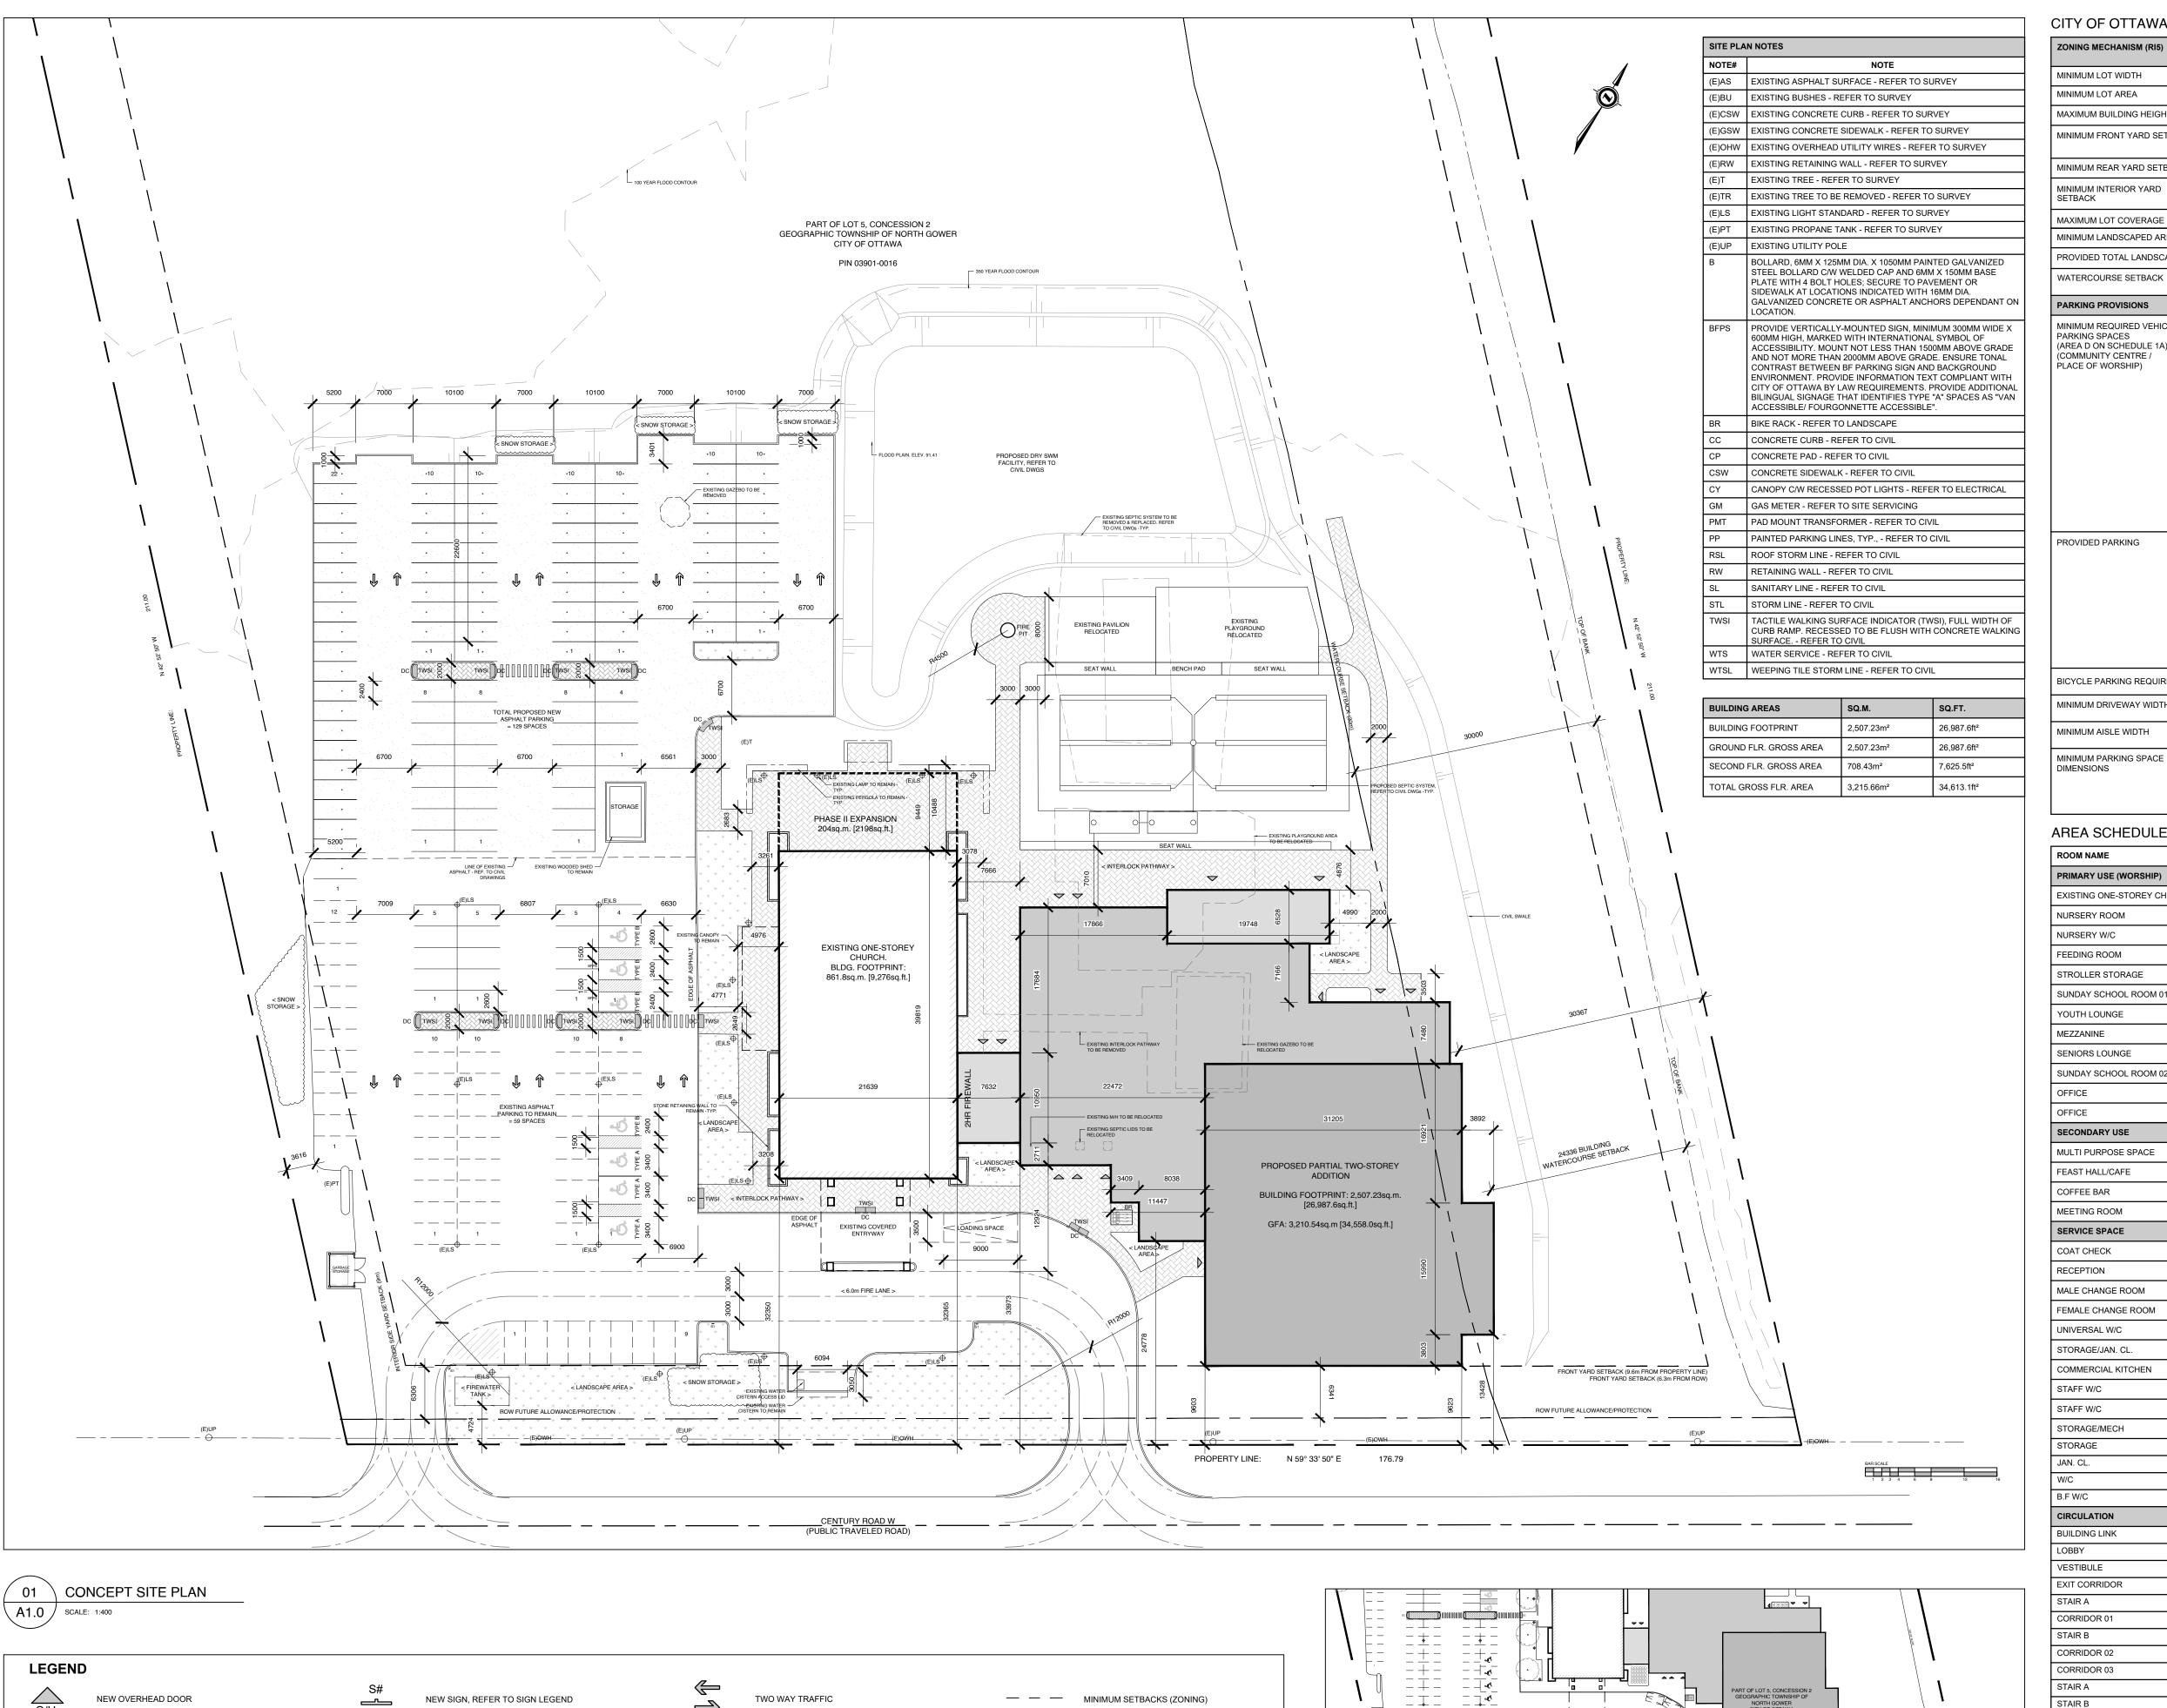

NEW CONSTRUCTION

EXISTING BUILDINGS

SOFT LANDSCAPING

CONCRETE SIDEWALK

BUILDING MOUNTED LIGHTS

REFER TO ELECTRICAL DWGs

DEPRESSED CURB (DC)

INDICATORS (TWSIs)

PROPERTY LINE

PROPOSED FENCE

TACTILE WALKING SURFACE

COMPACT PARKING SPACES

NEW DOOR / ENTRANCE

NO PARKING LINES

BICYCLE PARKING SPACE (1.8Mx0.6M)

PARKING STALL COUNT PER ROW

STREET LIGHT

VISITOR PARKING

DESIGNATED ACCESSIBLE PARKING

SPACE AS PER AODA STANDARDS

CITY OF OTTAWA ZONING BY-LAW REQUIRED ZONING MECHANISM (RI5) PROVIDED MINIMUM LOT WIDTH 176.79m MINIMUM LOT AREA 10,000m² 36,422.13m² MAXIMUM BUILDING HEIGHT MINIMUM FRONT YARD SETBACK 9.6m FROM PROPERTY LINE 6.3m FROM ROW MINIMUM REAR YARD SETBACK 130m 30.4m/80m MINIMUM INTERIOR YARD MAXIMUM LOT COVERAGE 30% 6.9% MINIMUM LANDSCAPED AREA 70.5% 20% PROVIDED TOTAL LANDSCAPE AREA 25,670m² WATERCOURSE SETBACK 24.34m PARKING PROVISIONS EXISTING BUILDING 188 SPACES PROVIDED MINIMUM REQUIRED VEHICLE CHURCH (PLACE OF WORSHIP): 861.8 m² 10 SPACES PER 100m² GFA = 861.8/100 = 8.618 x 10 PARKING SPACES (AREA D ON SCHEDULE 1A) = 87 SPACES COMMUNITY CENTRE / PLACE OF WORSHIP) PROPOSED ADDITION FLEX SPACE (COMMUNITY CENTER / PLACE OF ASSEMBLY): 1387.5 m² 10 SPACES PER 100m² GFA = 1387.5/100 = 13.875 x 10 = 139 SPACES <u>CHURCH (PLACE OF WORSHIP):</u> 587.7 m² 10 SPACES PER 100m² GFA = 587.7/100 = 5.877 x 10 = 59 SPACES TOTAL: 198 SPACES PHASE II EXPANSION <u>CHURCH (PLACE OF WORSHIP):</u> 204 m² 10 SPACES PER 100m² GFA = 204/100 = 2.04 x 10 = 20 SPACES TOTAL: 87 + 198 + 20 = 305 SPACES REQ. REGULAR SPACES (EXISTING) PROVIDED PARKING REGULAR SPACES (NEW) ACCESSIBLE SPACE (TYPE A) ACCESSIBLE SPACE (TYPE B) COMPACT SPACES (50% OF PARKING SPACES: BY-LAW 2021-218, PART 4 - SECTION 106) BICYCLE PARKING REQUIRED 1 PER 1500 m² OF GFA = 3 SPACES MINIMUM DRIVEWAY WIDTH PARKING LOT: 6.0m

PARKING LOT: 6.0m

MAY BE 4.6m x 2.4m

UP TO 50% OF REQUIRED PARKING SPACES

LENGTH: 5.2m

WIDTH: 2.6m

SERVICE SPACE:

CIRCULATION:

CENTURY ROAD W C.L. CENTURY ROAD W.

26.0m REQUIRED ROW PROTECTION

LOCATION		
GROUND FLOOR		
SECOND FLOOR		
SECOND FLOOR		
SECOND FLOOR		
SECOND FLOOR		
GROUND FLOOR		
GROUND FLOOR		
GROUND FLOOR		
SECOND FLOOR		
GROUND FLOOR		
SECOND FLOOR		
SECOND FLOOR		
SECOND FLOOR		
GROUND FLOOR		
SECOND FLOOR		
SECOND FLOOR SECOND FLOOR		
T SECOND I LOOK		
D ONLY]		
.D ONE I		

481.5 SQ.M

513.3 SQ.M

	CLIENT NAME:
	BCCO BRUNSTAD CHRISTIAN CHURCH
	NOTES:
\dashv	1) ALL WORK TO BE IN COMPLIANCE WITH LOCAL BUILDING CODES, REGULATIONS AND BY-LAWS.
	2) ADDITIONAL DRAWINGS MAY BE ISSUED FOR CLARIFICATION TO ASSIST PROPER EXECUTION OF WORK. SUCH DRAWINGS WILL HAVE THE SAME MEANING AND INTENT AS IF THEY WERE INCLUDED WITH PLANS IN CONTRACT DOCUMENTS.
	3) DO NOT SCALE DRAWINGS.

4) ALL SUB-CONTRACTORS TO TAKE THEIR OWN ON-SITE MEASUREMENTS AND BE RESPONSIBLE FOR THEIR 5) NOTIFY SHAWN J. LAWRENCE ARCHITECT FOR ANY ERRORS AND/OR OMISSIONS PRIOR TO START OF WORK.

CONSULTANTS: RCHITECTURAL DRAWINGS S.J. LAWRENCE ARCHITECT INC.

205-18 DEAKIN STREET, NEPEAN, ON K2E 8B7 613.739.7770 TRUCTURAL DRAWINGS CLELAND JARDINE (BPA) 580 TERRY FOX DR, KANATA, ON K2L 4B9 613.591.1533

MECHANICAL & ELECTRICAL DRAWINGS GOODKEY, WEEDMARK & ASSOCIATES LTD. (GWAL) 1688 WOODWARD DR. OTTAWA, ON K2C 3R8 613.727.5111 CIVIL DRAWINGS

100-5335 CANOTEK RD, GLOUCESTER, ON K1J 9L4 613.747.3636 SEPTIC DRAWINGS PATERSON GROUP 9 AURIGA DRIVE, OTTAWA,ON K23 7T9 613.226.7381

LANDSCAPE DRAWINGS VS LANDSCAPE GROUP 4886 BANK ST, OTTAWA, ON K1X 1G7 613.774.5296 URBAN PLANNER

Q9 PLANNING + DESIGN 43 ECCLES ST UNIT C, OTTAWA, ON K1R 6S3


LENGTH: 5.2m

= 81 SPACES

50% (94 SPACES PERMITTED)

WIDTH: 2.6m

ARCHITECTS

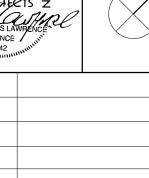

NORTH ARROW:

2025.08.21 ISSUED FOR SPC RESPONSE 01 2025.08.06 ISSUED FOR COORDINATION 2025.07.02 ISSUED FOR COORDINATION 2025.05.08 ISSUED FOR COORDINATION 2025.03.12 ISSUED FOR SPC 2024.12.05 ISSUED FOR COORDINATION 2024.08.29 ISSUED FOR COORDINATION No. DATE

S.J.LAWRENCE ARCHITECT INCORPORATED 18 DEAKIN STREET SUITE 205 OTTAWA, ONTARIO T: (613) 739.7770 F: (613) 739.7703 sjl@sjlarchitect.com

INCORPORATE

THIS DRAWING IS THE SOLE PROPERTY OF S.J. LAWRENCE ARCHITECT INCORPORATED REPRODUCTION IS NOT PERMITTED

BCCO CHURCH ADDITION


1981 CENTURY RD W, NORTH GOWER, ON


SITE PLAN


SHEET NUMBER:

PROJECT DATE: 2025.08.21 2023.03.15 SCALE: 1:400 JOB NUMBER: SL-1090-23


A1.0

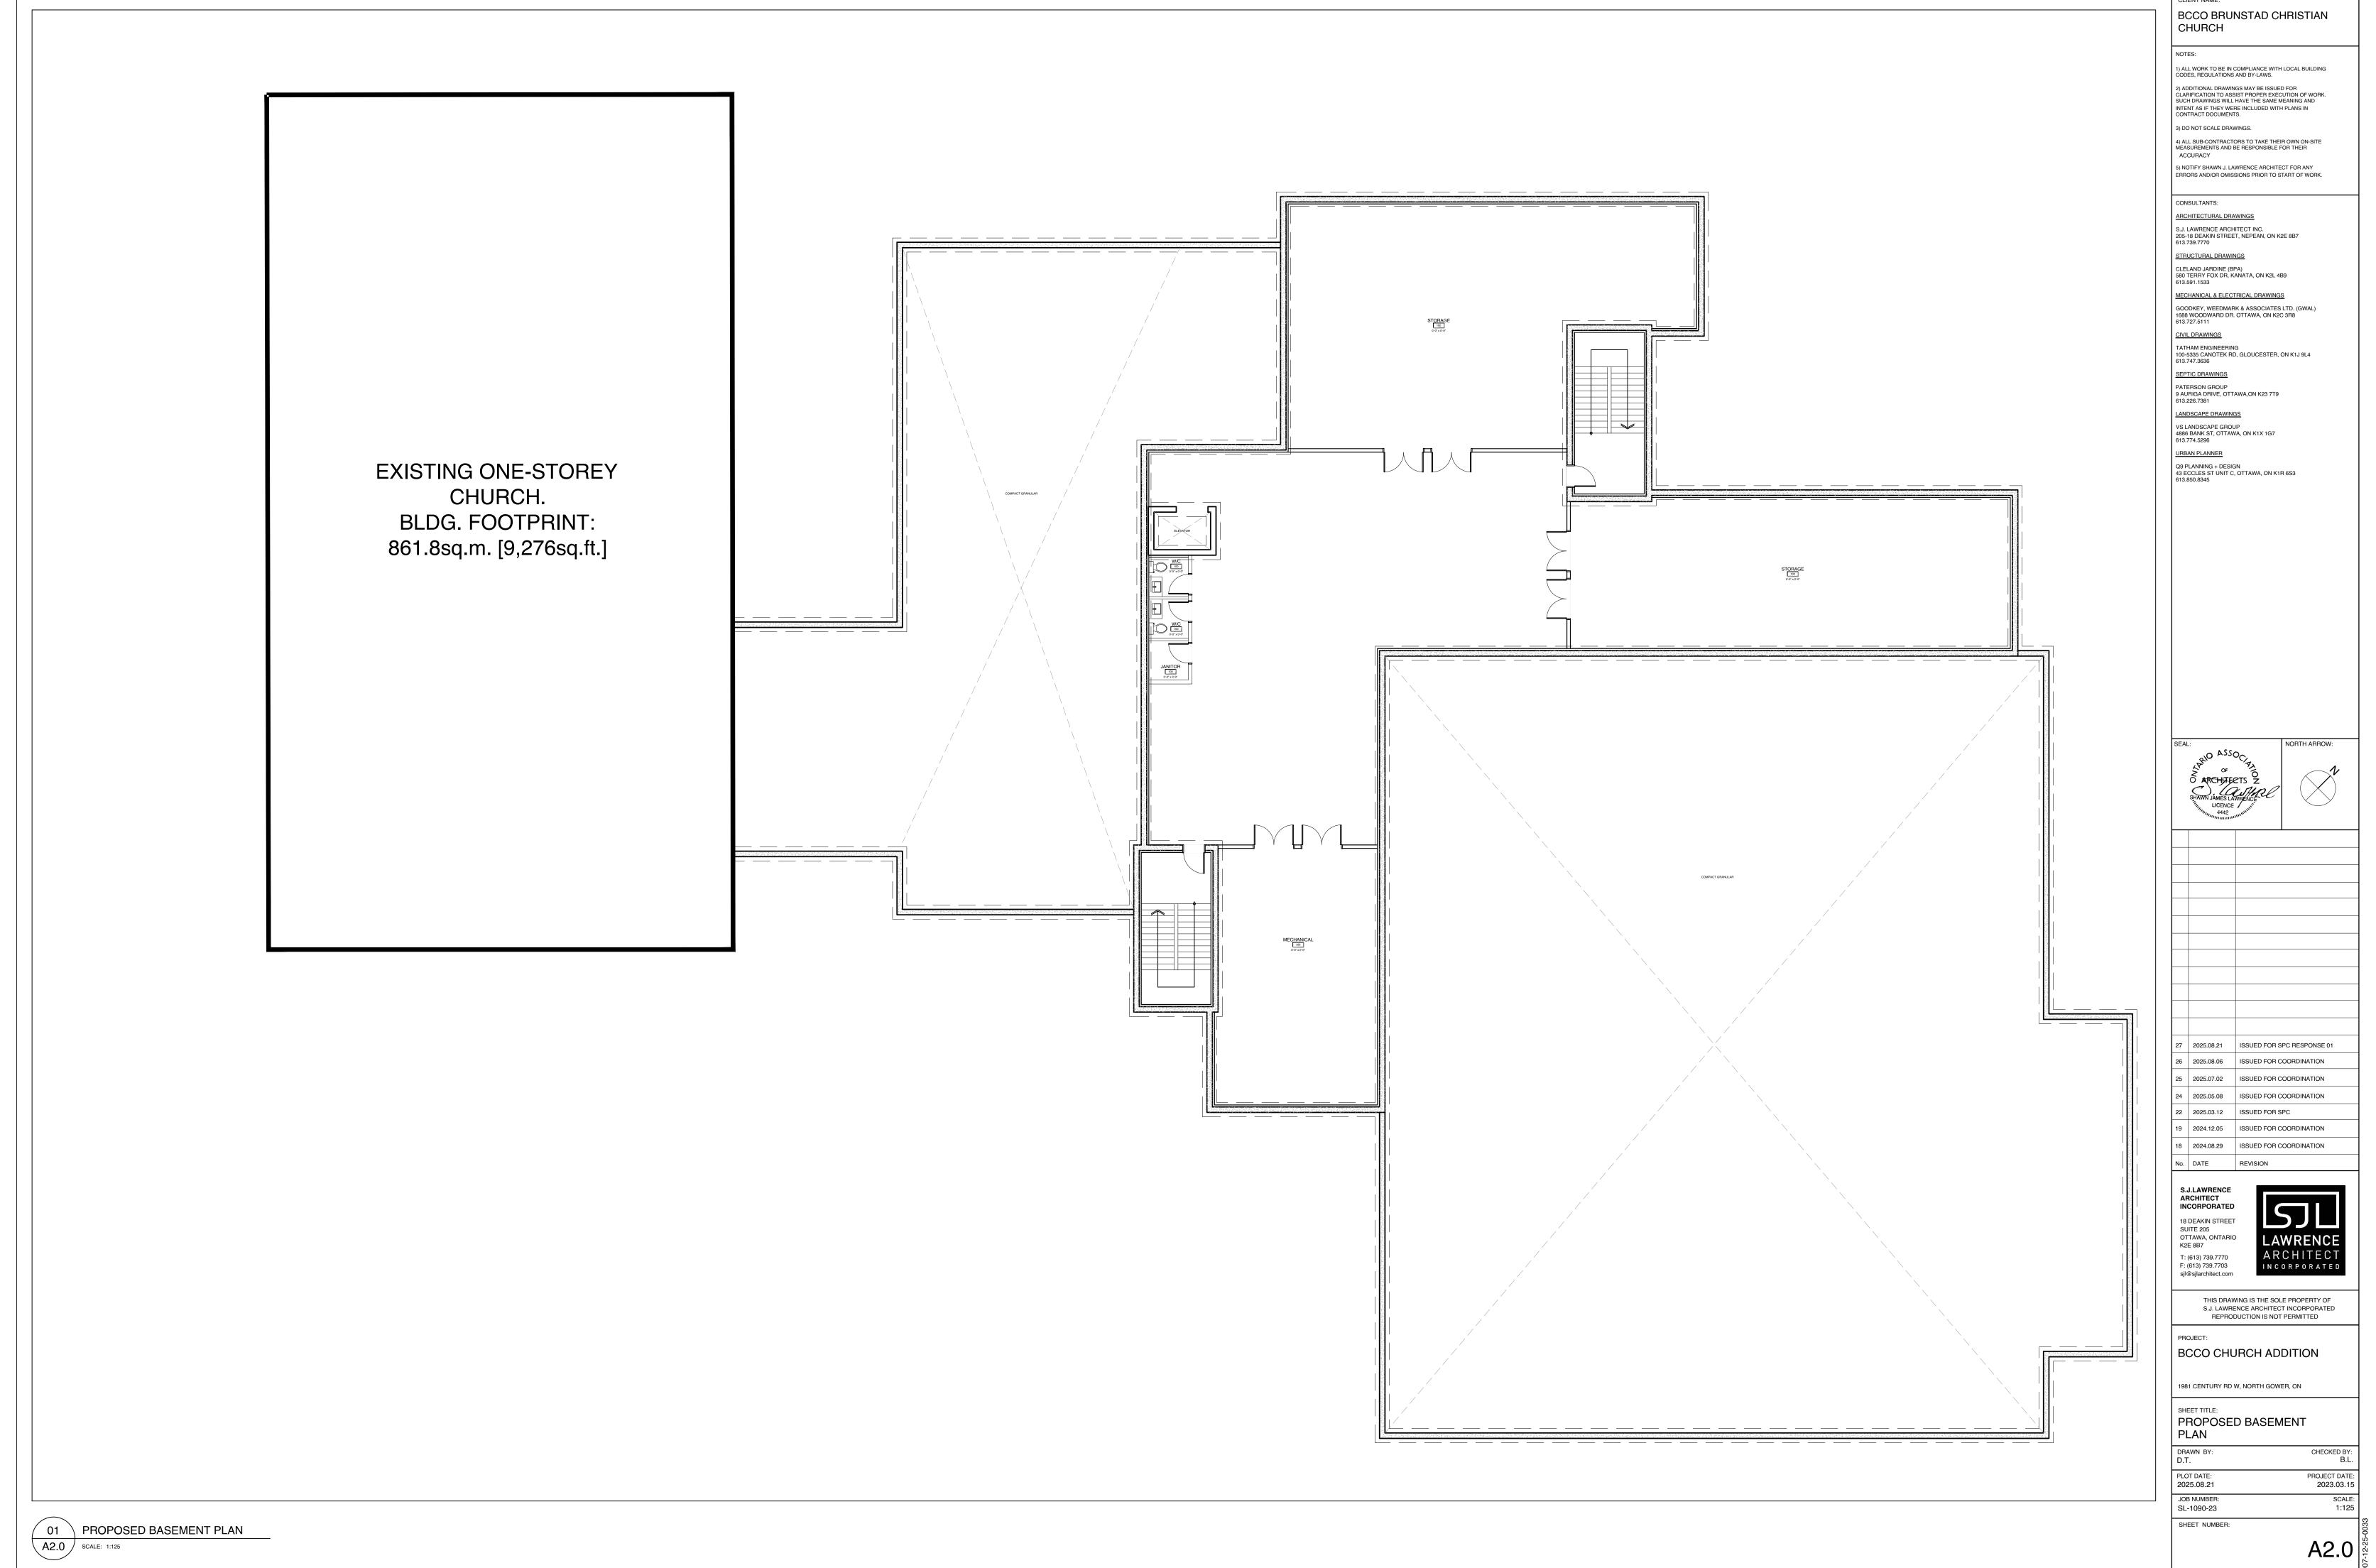

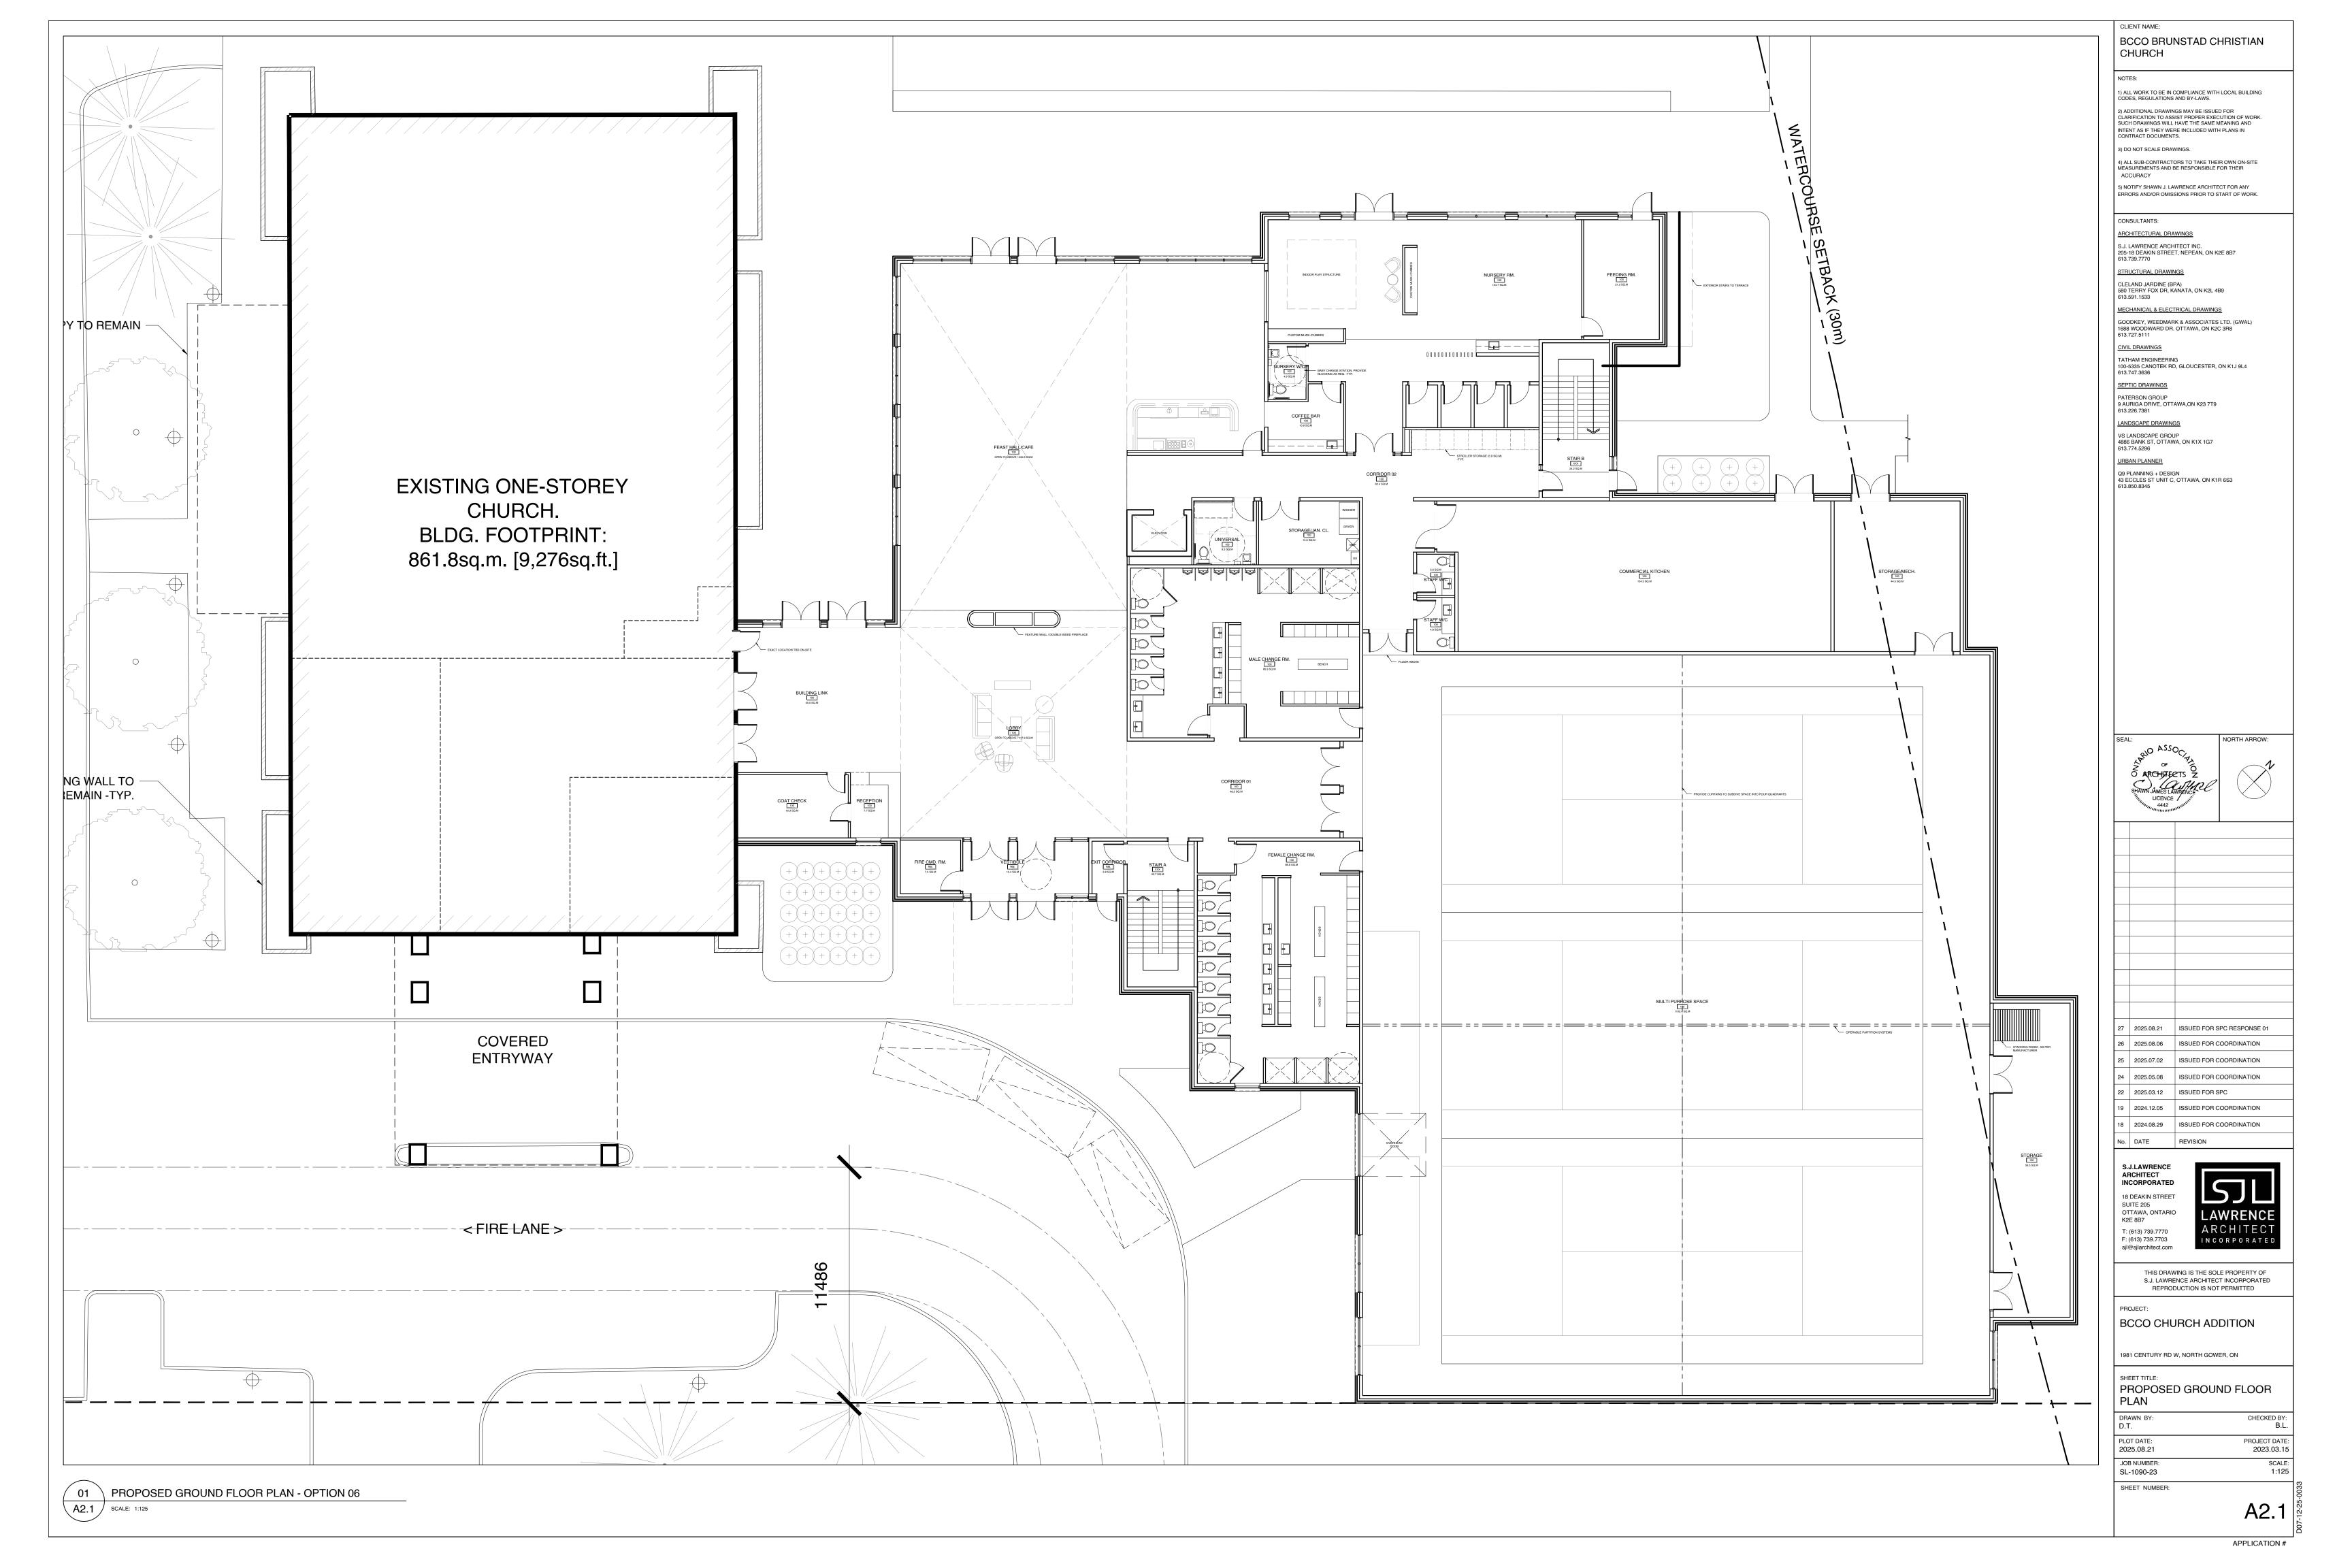

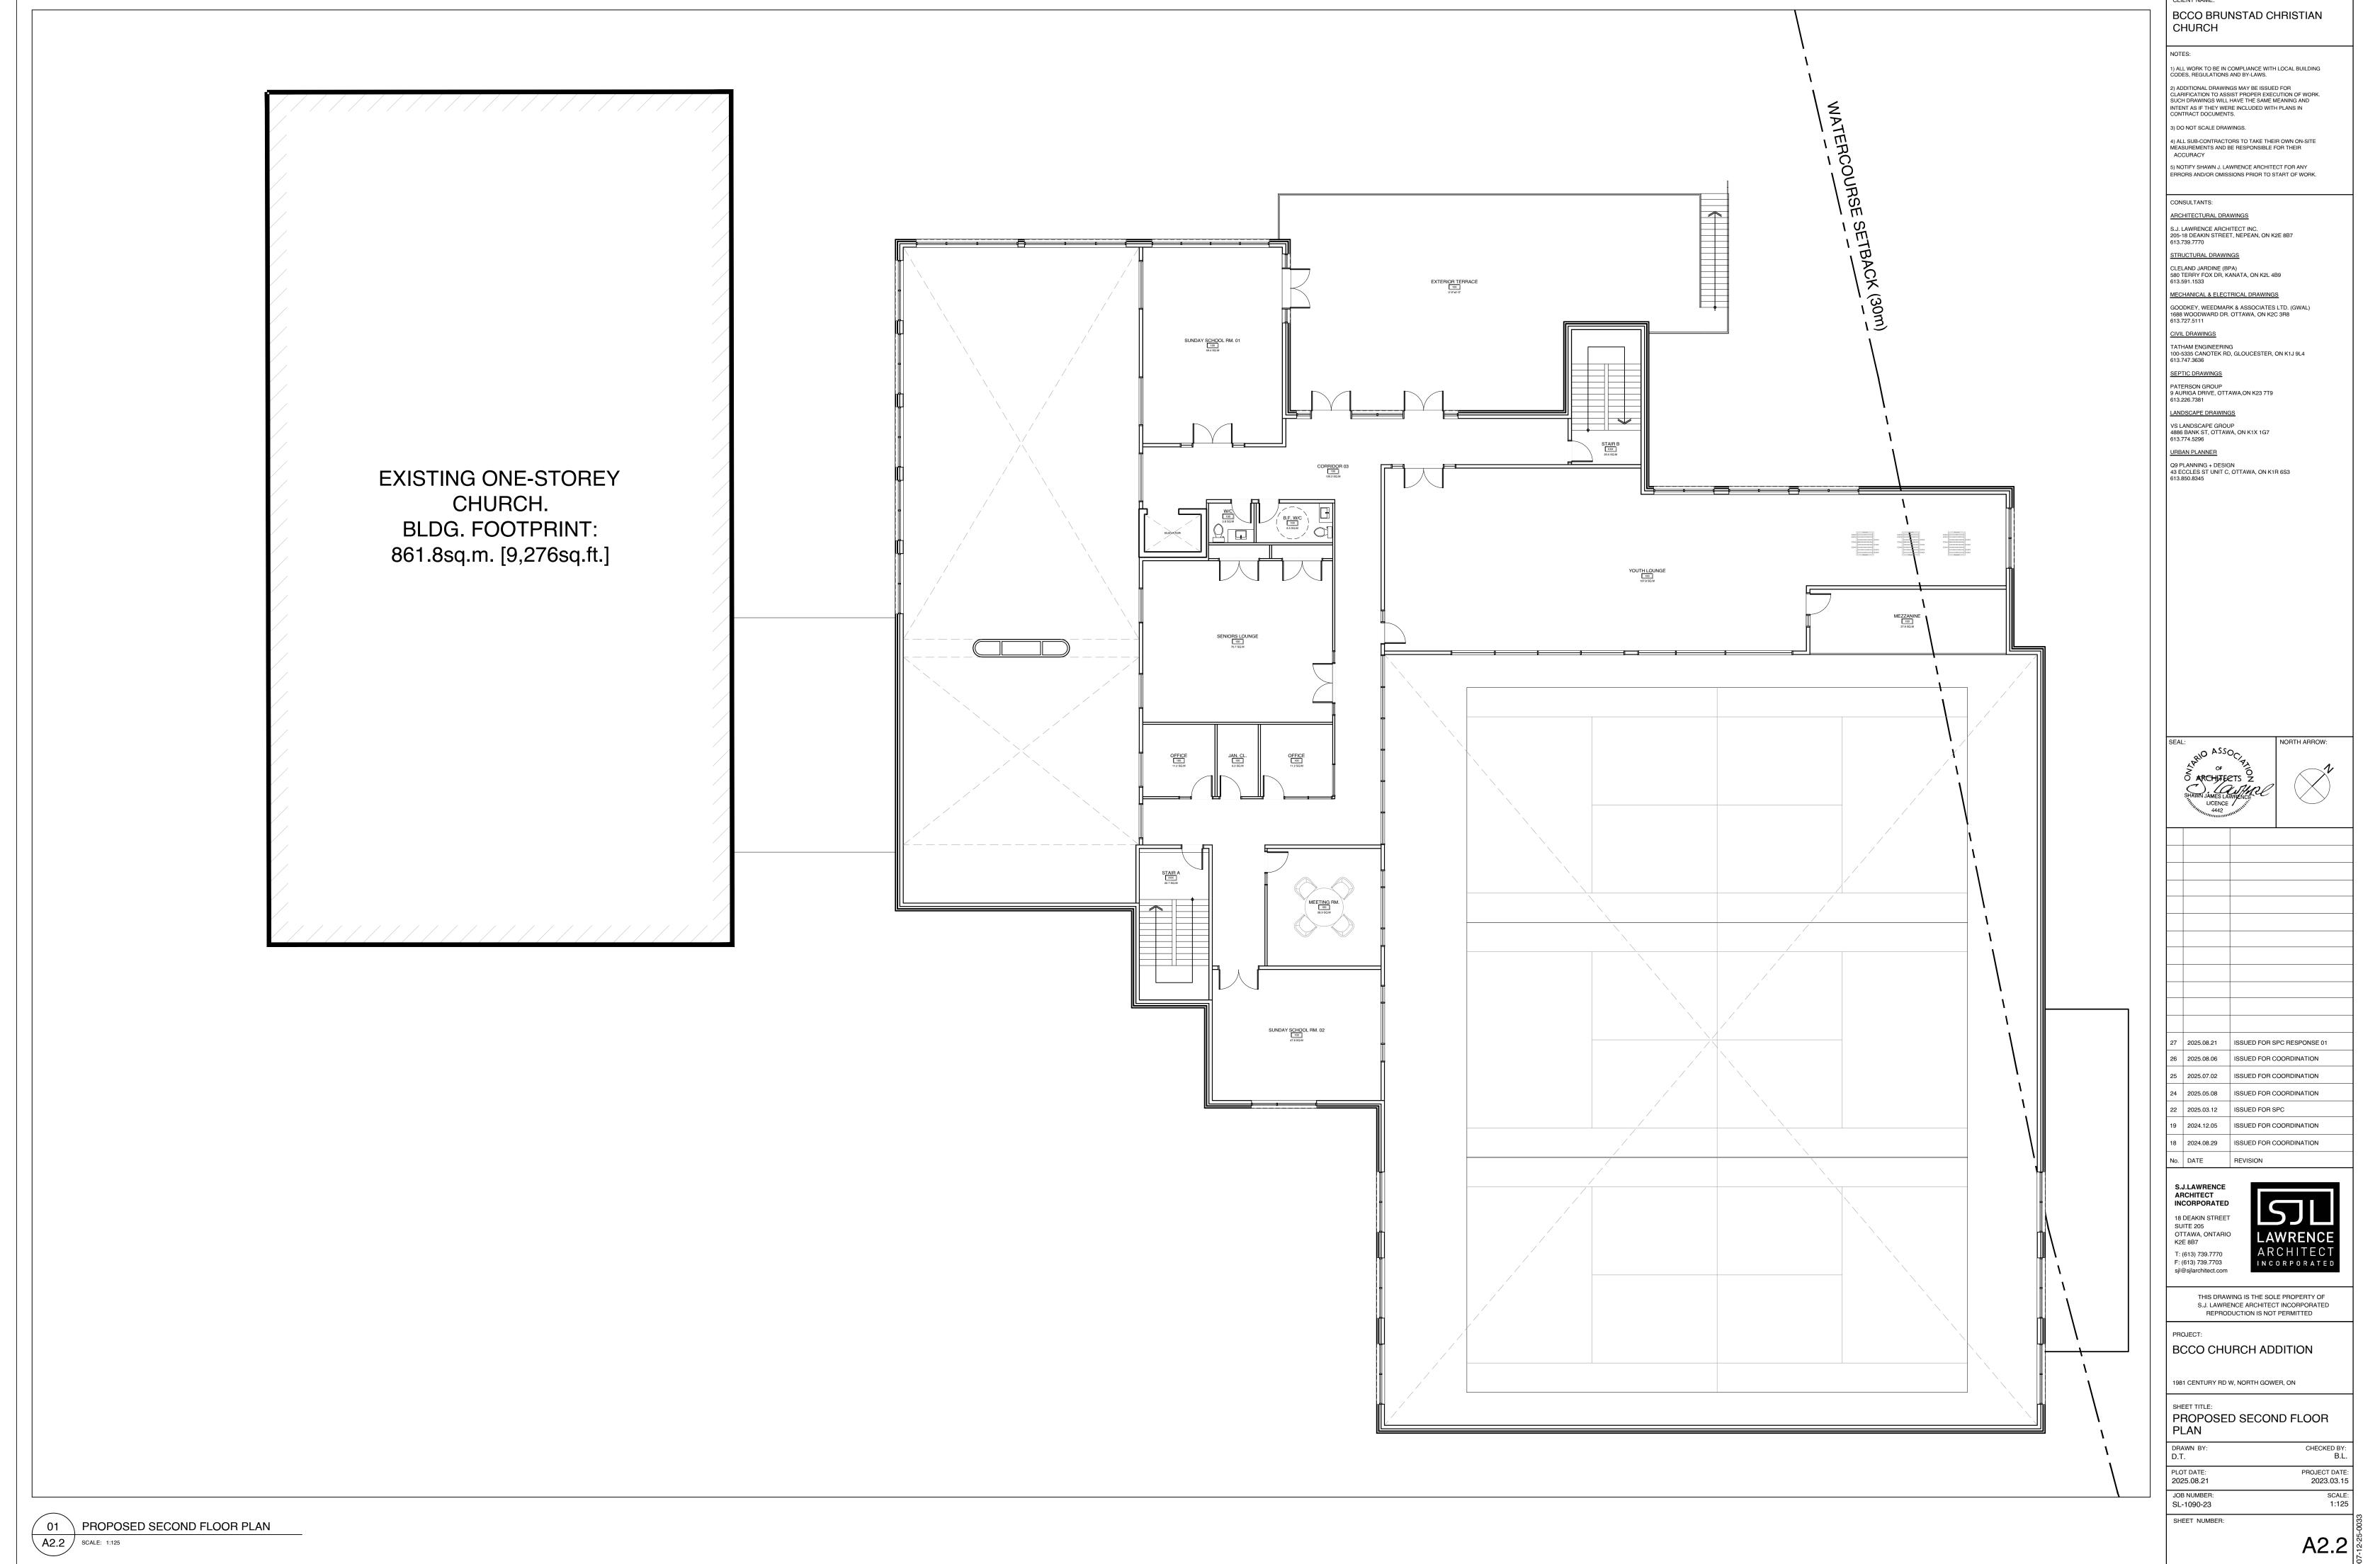

PPLICATION

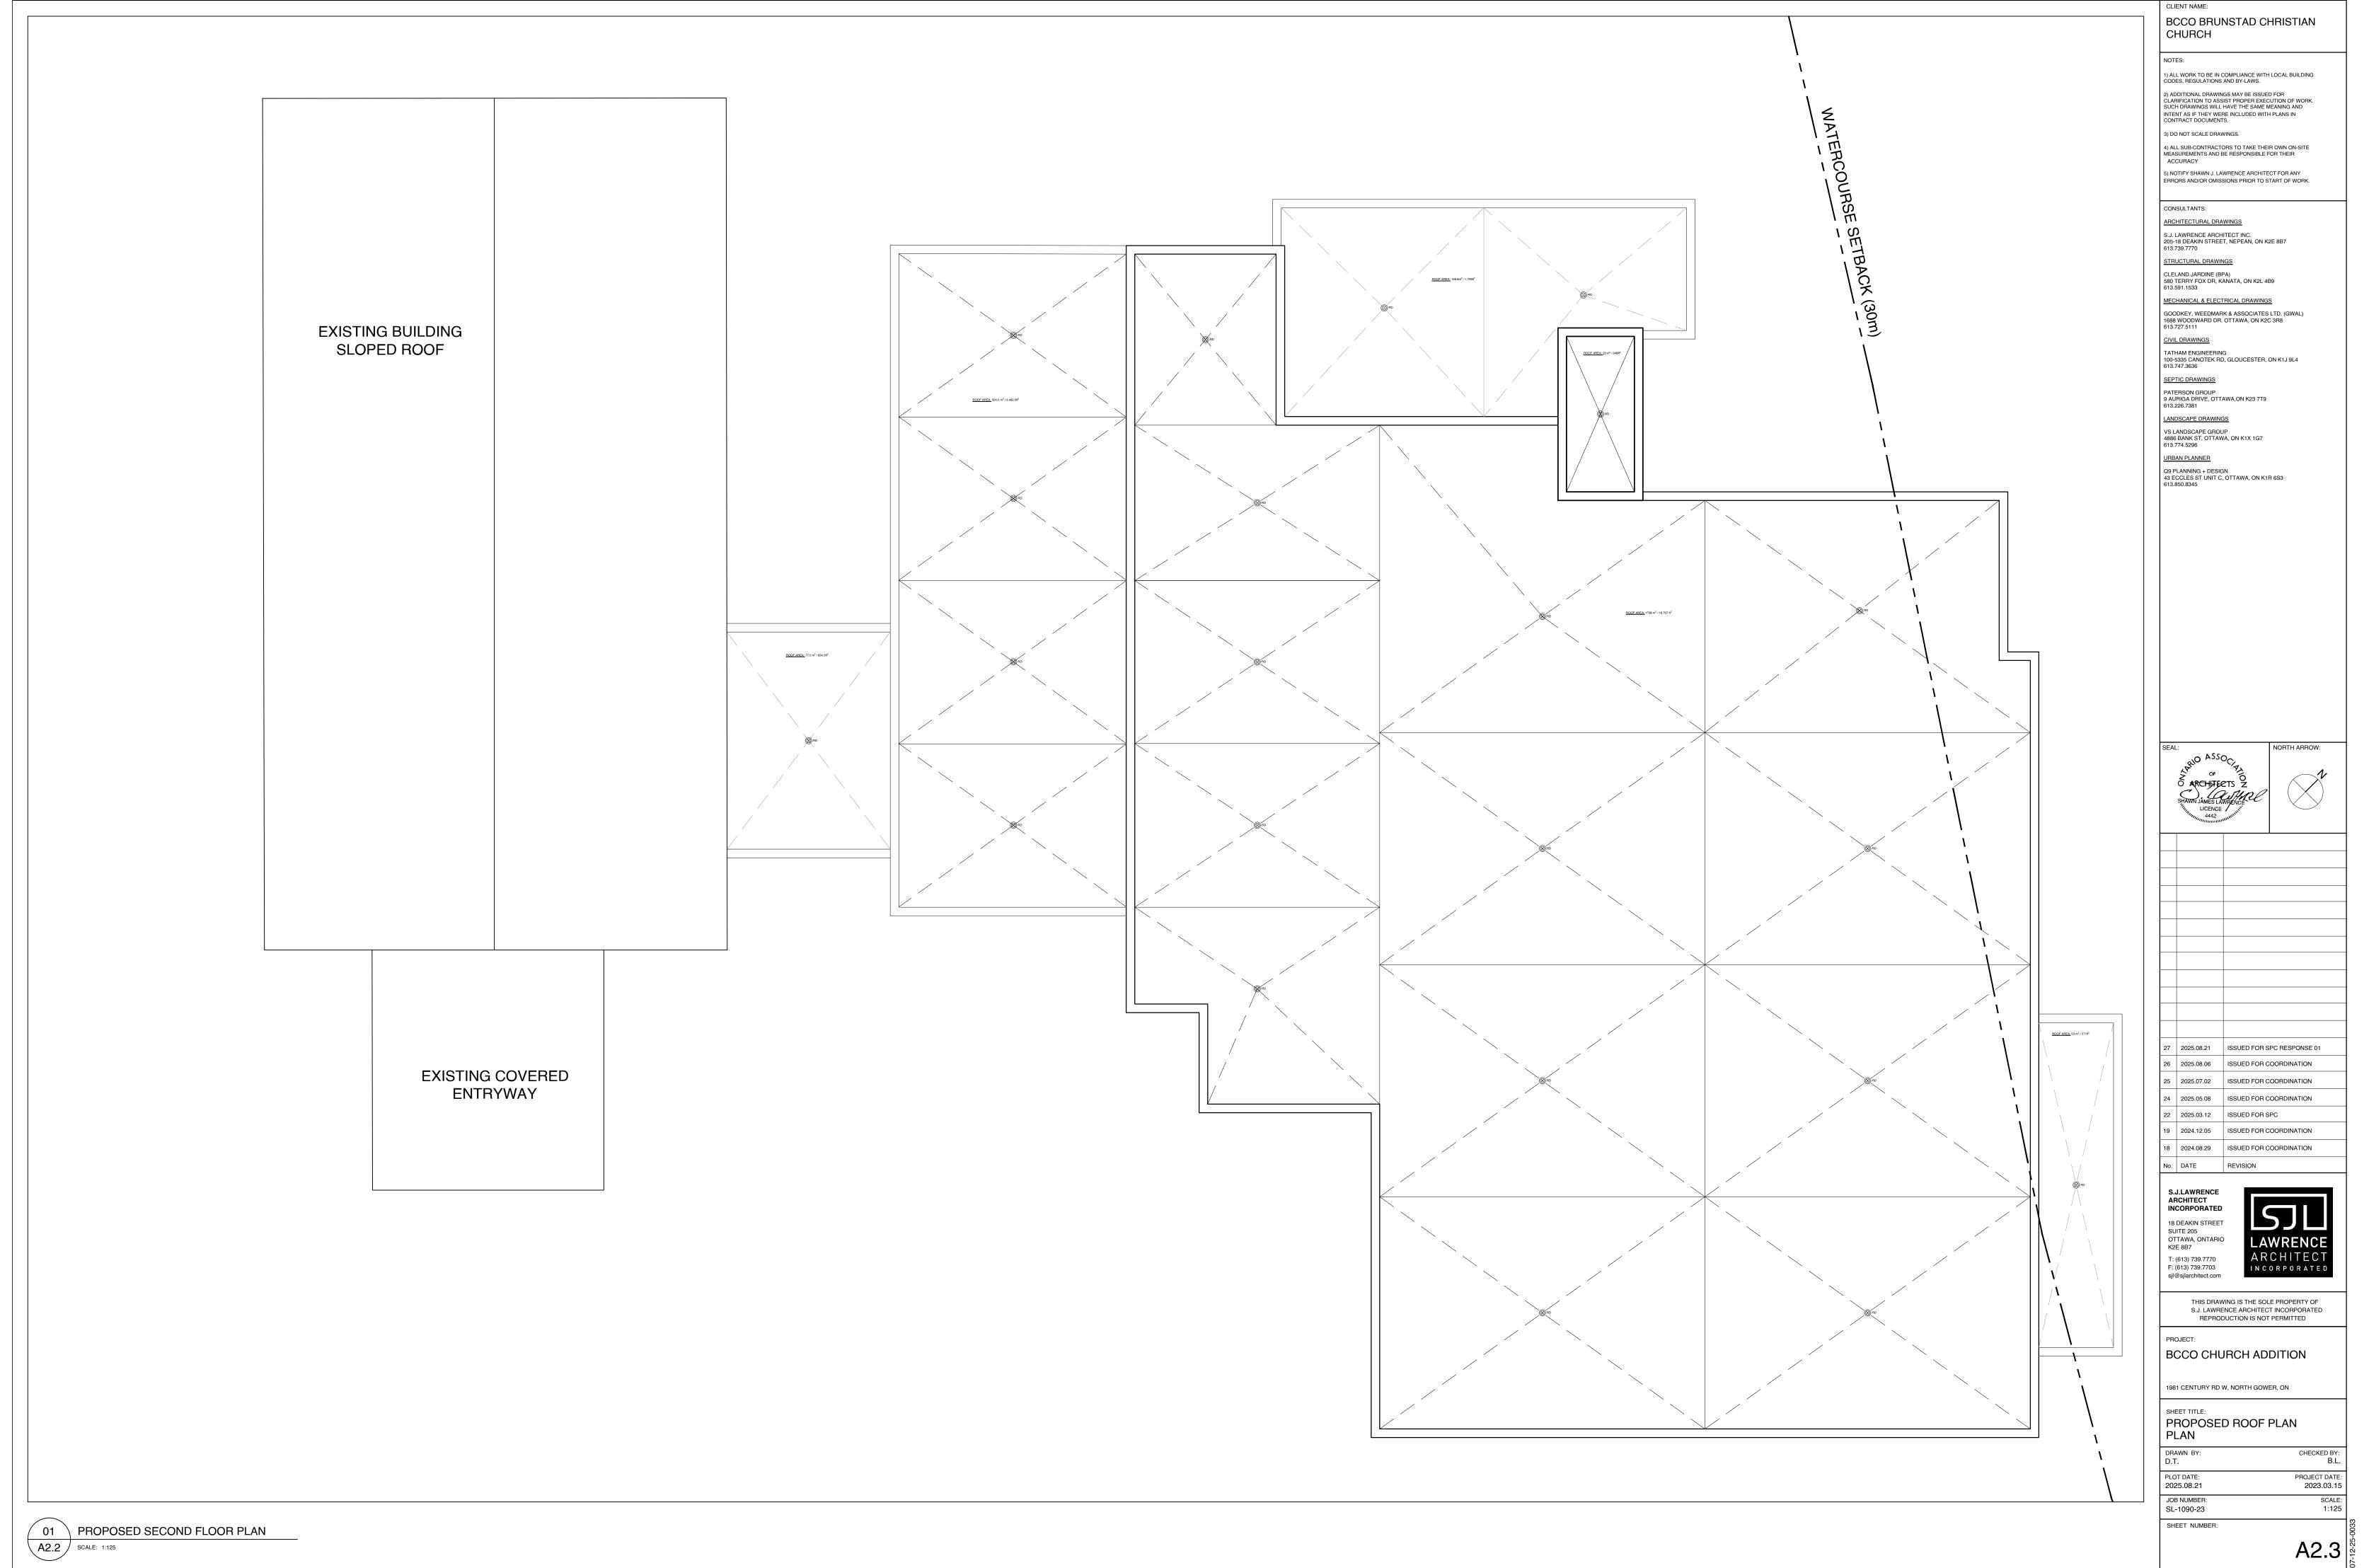



A4.0



A4.1

CLIENT NAME:

BCCO BRUNSTAD CHRISTIAN CHURCH

1) ALL WORK TO BE IN COMPLIANCE WITH LOCAL BUILDING CODES, REGULATIONS AND BY-LAWS.

2) ADDITIONAL DRAWINGS MAY BE ISSUED FOR CLARIFICATION TO ASSIST PROPER EXECUTION OF SUCH DRAWINGS WILL HAVE THE SAME MEANING AND INTENT AS IF THEY WERE INCLUDED WITH PLANS IN CONTRACT DOCUMENTS.

3) DO NOT SCALE DRAWINGS.

4) ALL SUB-CONTRACTORS TO TAKE THEIR OWN ON-SITE MEASUREMENTS AND BE RESPONSIBLE FOR THEIR ACCURACY

5) NOTIFY SHAWN J. LAWRENCE ARCHITECT FOR ANY ERRORS AND/OR OMISSIONS PRIOR TO START OF WORK.



07 2025.08.21 ISSUED FOR SPC RESPONSE 01
06 2025.03.12 ISSUED FOR SPC

 02
 2023.12.04
 ISSUED FOR PRE-CONSULT

 01
 2023.11.30
 ISSUED FOR REVIEW

 No.
 DATE
 REVISION

S.J.LAWRENCE

ARCHITECT

04 2024.06.18 ISSUED FOR REVIEW

03 2024.01.23 ISSUED FOR REVIEW

S.J.LAWRENCE ARCHITECT INCORPORATED

18 DEAKIN STREET SUITE 205 OTTAWA, ONTARIO K2E 8B7

T: (613) 739.7770 F: (613) 739.7703 sjl@sjlarchitect.com

THIS DRAWING IS THE SOLE PROPERTY OF S.J. LAWRENCE ARCHITECT INCORPORATED REPRODUCTION IS NOT PERMITTED

PROJECT:
BCCO CHURCH ADDITION

1981 CENTURY RD W, NORTH GOWER, ON SHEET TITLE:

PERSPECTIVES

SL-1090-23

DRAWN BY: CHECKED BY:

D.T. B.L. S.J.L.

PLOT DATE: PROJECT DATE:

2025-08-21 1:14:57 PM 2023.03.15

JOB NUMBER: SCALE:

A4.2