KEY PLAN: NTS

BRIAN

OBURN

BOULEVARD

LANDSCAPE PLAN

SCALE 1:250

40 YEAR CANOPY CALCULATION:

-5,729 m2 site area

-2 large trees proposed (154m2 ea.), 1 large coniferous tree proposed (79m2 ea.), 28 small trees proposed (7m2 ea)

=583m2 canopy cover =10.2% canopy cover

*Large tree calculated at 14m, large coniferous tree calculated at 10m, small tree calculated at

Tree planting opportunities are limited on site due to the presence of overhead wires on Brian Coburn Boulevard and an easement at the read and side yard.

GENERAL NOTES:

construction activity.

1. It is the responsibility of the appropriate contractor or official to report any errors, omissions or discrepancies on this plan with actual site conditions to the Landscape Architect before proceeding with construction.

2. The contractor is to notify all utility companies and authorities prior to any excavation and ascertain locations of underground services. 3. The contractor is to reinstate all areas and items damaged as a result of

4. The contractor is to comply with all pertinent codes and by-laws. 5. The contractor is to maintain a positive surface run-off throughout the entire construction period.

6. The Landscape Architect is not responsible for subsurface conditions. 7. The contractor is to identify all existing trees to remain on site with the Landscape Architect prior to construction.

8. The contractor is to stake the proposed location of all plant material in conjunction with the Landscape Architect prior to excavation. 9. Minimum distances for selected deciduous trees are as follows:

Sidewalks 1.5m Public Streets 2.5m Underground Infrastructure 1.5m

10. All trees within 1m of underground utility trenches are to be excavated by


11. Remove all protective wrapping from tree trunks after installation.

12. Staking of trees shall only be performed if necessary. 13. Ensure that mulch is pulled back a min. distance of 75mm from base of


14. The L.1 drawing has been prepared in conjunction with the Geotechnical Report addendum prepared by EXP services Inc. June 25th, 2025



KEY QTY. BOTANICAL NAME COMMON NAME SIZE CONDITION **REMARKS** Freeman's Maple Acer x freemanii **★** HB Celtis occidentalis Hackberry 50mm cal. 50mm cal. Prunus pensylvanica B&B * PC Pin Cherry B&B * SB Amelanchier canadensis Shadblow Serviceberry 50mm cal. ***** SF 12 Amelanchier laevis Allegheny Serviceberry 50mm cal. B&B ***** WS 1 2.0m ht. B&B Picea glauca White Spruce SHRUBS ★ FS 34 Rhus aromatica Fragrant Sumac 600 mm ht. 1000 mm o.c. JH 28 Juniperus horizontalis 'Bar Harbor' Bar Harbor Juniper Potted 1000 mm o.c. 600 mm spr. Physocarpos opulifolius 1000 mm o.c. Ninebark 600 mm ht. RR Potted 1000 mm o.c. 32 Rosa rugosa Rugosa Rose 600 mm ht. Rubus odoratus Flowering Raspberry Potted 1000 mm o.c. 600 mm ht. **★** WC 23 White Cedar Thuja occidentalis 2000 mm ht. Potted 1000 mm o.c. ORNAMENTAL GRASSES BL 10 Leymus arenarius 'Blue Dune' Blue Dune Grass 250mm pot 800 mm o.c. KF 17 Calamagrostis 'Karl Foerster' Karl Foerster Grass 250mm pot 800 mm o.c. * NATIVE TO ONTARIO

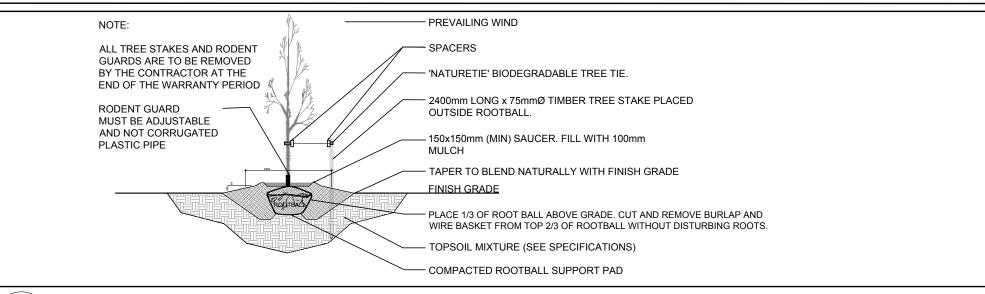


DECIDUOUS TREE PLANTING L.1 / SCALE: NTS

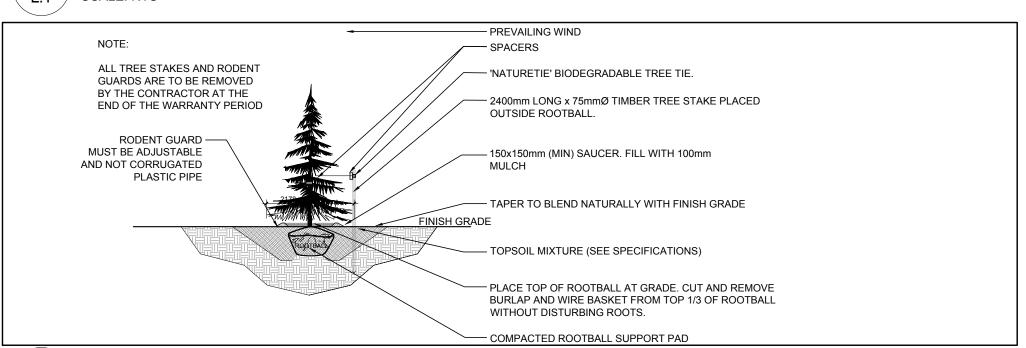

CONIFEROUS TREE PLANTING


L.1 SCALE: NTS

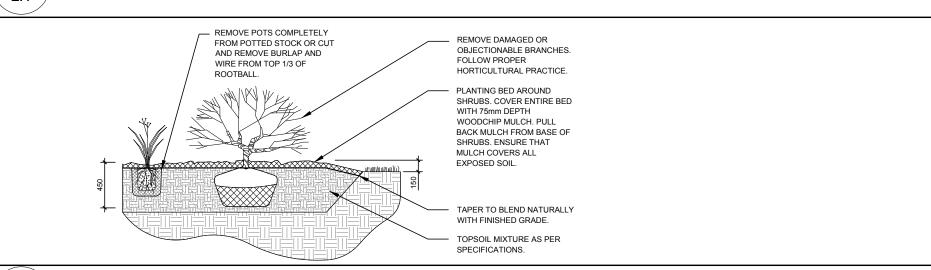

4 PROPOSED SHRUB / ORNAMENTAL GRASS PLANTING

EXISTING STUB

`+----

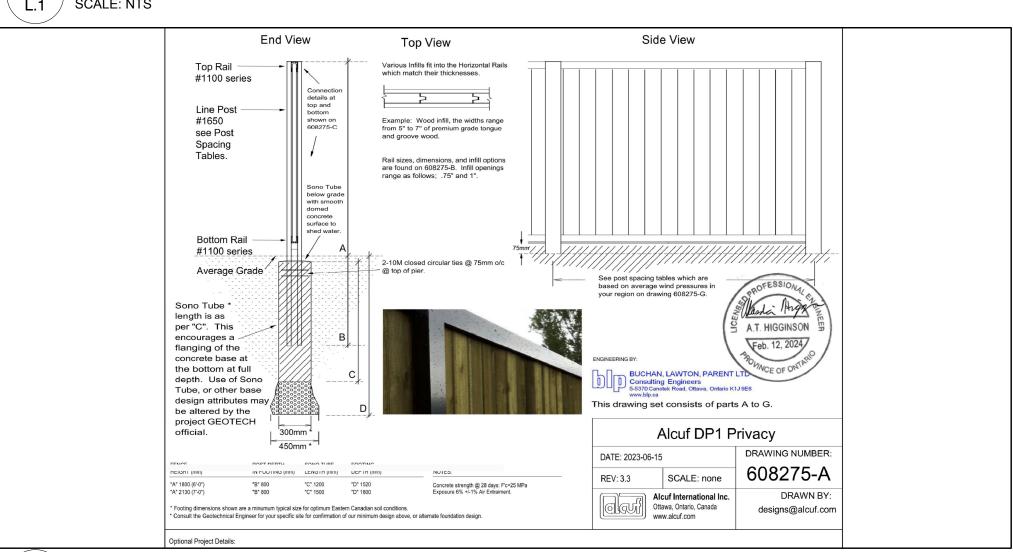

PROPOSED 2130mm HT. ALCUF WOOD SCREEN FENCE

L.1 / SCALE: NTS



3070, CHEMIN DES QUATRE-BOURGEOIS QUÉBEC (QC) G1W 2K4



53, BOUL. SAINT-RAYMOND, GATINEAU, QC J8Y 1R8

ENGINEERS / PLANNER




1565 CARLING AVENUE, SUITE 700, OTTAWA, ON K1Z 8R1

SURVEYOR

1331 CLYDE AVENUE, SUITE 400, OTTAWA, ON K2C 3G4

LEGEND

 40 YEAR CANOPY PROJECTION PROPOSED DECIDUOUS TREE - REQUIRED SOIL VOLUME (25m3)

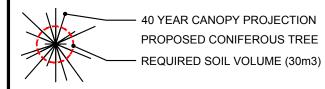

PROPOSED SHRUBS / ORNAMENTAL GRASSES

PROPOSED SOD

PROPOSED RIVERSTONE


	7	REVISED PER CITY COMMENTS	07/09/2025	ML	J
	6	REVISED PER CITY COMMENTS	02/14/2025	ML	J
	5	REVISED PER CITY COMMENTS	03/04/2024	ML	J
	4	NOTE REVISED RE: TREE PLANTING	03/04/2024	ML	J
	3	REVISED PER CITY COMMENTS	03/01/2024	ML	J
	2	REVISED PER CITY COMMENTS	02/26/2024	ML	J
	1	ISSUED FOR SITE PLAN CONTROL	12/15/2023	ML	J
	Nο	Issue	Date	DR	C

JAMES B. LENNOX & ASSOCIATES INC. **ARCHITECTS** LANDSCAPE 3332 CARLING AVE. OTTAWA, ONTARIO K2H 5A8 Tel. (613) 722-5168 Fax. 1(866) 343-3942

NAVAN ROAD DEVELOPMENT- BUILDINGS "A"

NAVAN ROAD, ORLEANS ON

LANDSCAPE PLAN

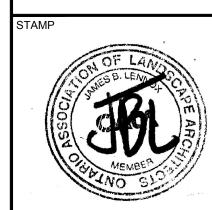


AS SHOWN START DATE NOVEMBER 2023 ROJECT NO.


24MIS2406

DRAWING NO.

SCALE

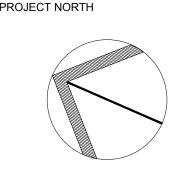

LOT SIZE ARCH-D

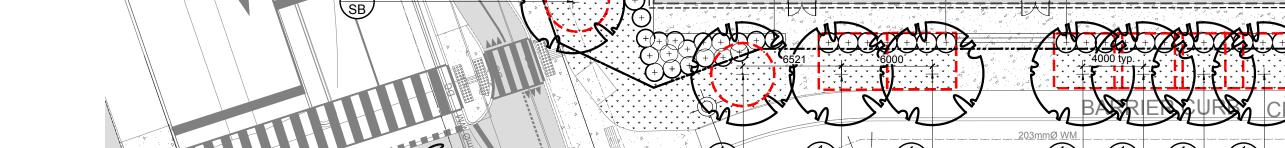

BUILDING - A

4 STORY CONDOMINIUM BUILDING

(48 UNITS)

−PROPOSED 2130mm Ht WOOD SCREEN FENCE-

REFER TO DETAIL 5/L.1

FIRE ACCESS / PARKING FOR

COMMERCIAL SPACE

BUILDING - E

4 STORY CONDOMINIUM BUILDING

4.5m - 200mmØ SAN @ 1.50%

SIAMESE CONNECTION