



**APPROVED**  
By Sole Soyak at 6:42 pm, Jul 30, 2025

*S. Soyak*

**SOLE SOYAK**  
**PLANNER II**  
**PLANNING, DEVELOPMENT AND BUILDING SERVICES**  
**DEPARTMENT, CITY OF OTTAWA**

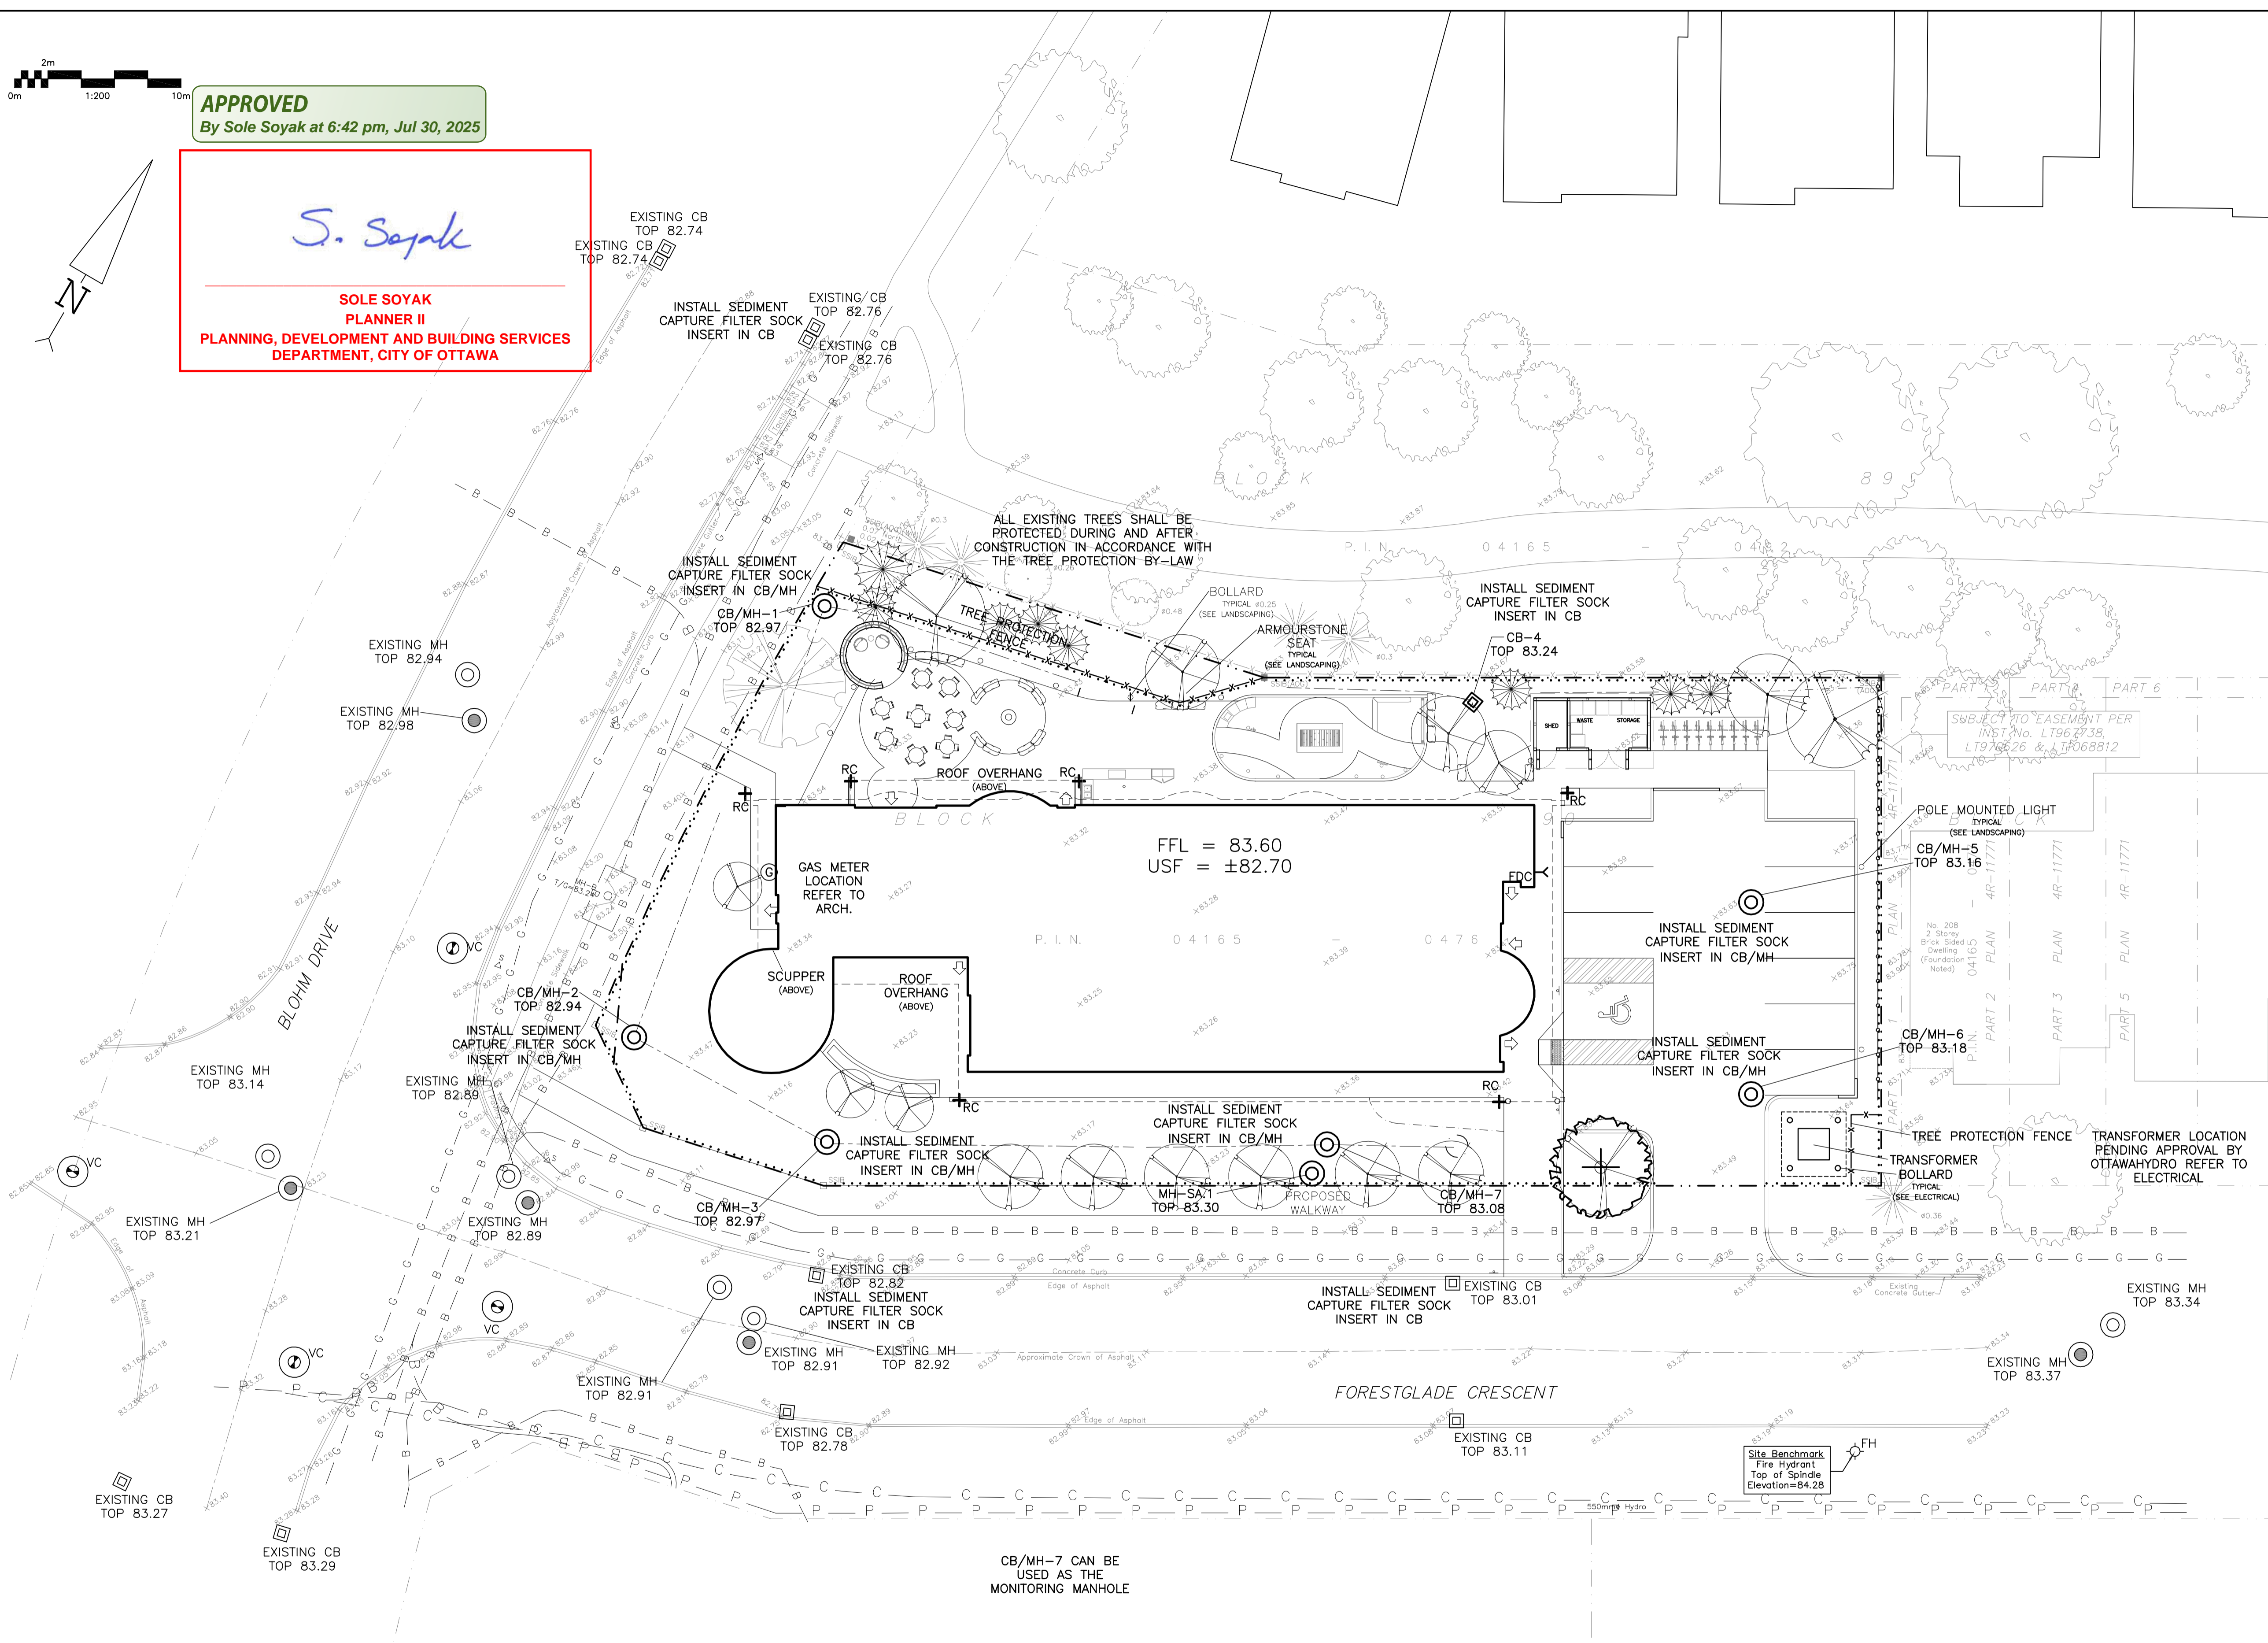

LEGEND	
FFL	FIRST FLOOR ELEVATION
USF	UNDERSIDE OF FOOTING
---	PROPERTY LINE
CB	CATCH BASIN
MH	STORM MANHOLE
CB/MH	CATCH BASIN/MANHOLE
MH	SANITARY MANHOLE
VC	VALVE CHAMBER
DS	DOWNSPOUT
FH	FIRE HYDRANT
FDC	FIRE DEPARTMENT CONNECTION
.....	SILT FENCE BARRIER

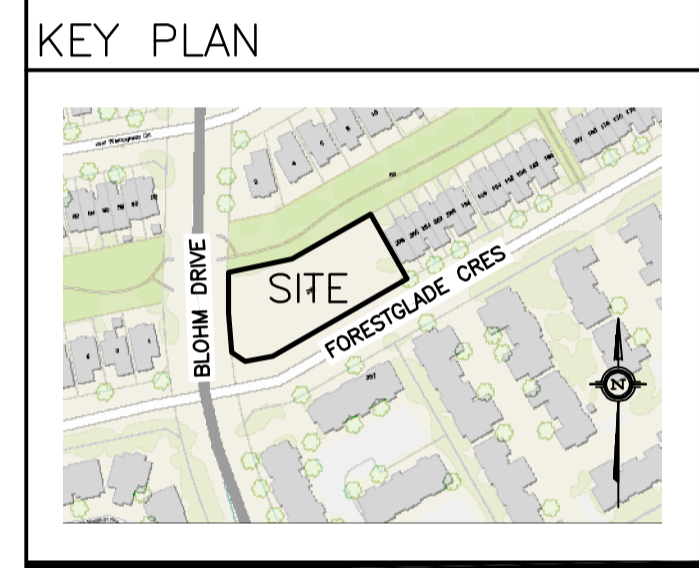

No.	DATE	REVISION
7	JUL 18-25	RE-ISSUED FOR SITE PLAN CONTROL & ISSUED FOR TENDER
6	JUN 26-25	ISSUED FOR BUILDING PERMIT
5	MAY 7-25	RE-ISSUED FOR SITE PLAN CONTROL
4	APR 4-25	ISSUED FOR SITE PLAN CONTROL
3	APR 2-25	ISSUED FOR COORDINATION
2	FEB 21-25	ISSUED FOR CLASS B COSTING
1	FEB 14-25	ISSUED FOR COORDINATION

**D. B. GRAY ENGINEERING INC.**  
*Stormwater Management - Grading & Drainage - Storm & Sanitary Sewers - Watermain*  
700 Long Point Circle  
Ottawa, Ontario  
613-425-8044  
d.gray@dbgrayengineering.com

Project  
**PROPOSED 3-STORY  
OAC WOMEN'S SHELTER  
250 FORESTGLADE CRESCENT  
OTTAWA, ONTARIO**

Drawing Title  
**EROSION & SEDIMENT  
CONTROL PLAN**

Engineer's Seal  
D.B. GRAY  
17016502  
JUL 18-25  
PROVINCE OF ONTARIO  
NOT VALID UNLESS  
SIGNED & DATED

Drawn D.B.G.  
H. Scale 1:200  
V. Scale  
Date FEB 14-25  
Job No. 24053

Drawing No.  
**C-3**  
of 7

REFER TO THE GEOTECHNICAL REPORT: THE SUB-GRADE, GRANULAR LAYERS AND SURFACE OF PAVEMENT STRUCTURES AND OTHER HARD SURFACES SHALL BE CROWNED OR SLOPED TO PROMOTE DRAINAGE OF WATER AWAY FROM THE BUILDING AND OTHER SURFACE STRUCTURES. SUB-DRAINS SHALL BE INSTALLED AT THE SUB-GRADE LEVEL AT LOCATIONS AS INDICATED ON THE PLAN TO ENSURE EFFECTIVE DRAINAGE OF SUBSURFACE WATER. THE SUB-DRAINS SHALL CONNECT TO CATCH BASINS OR STORM MANHOLES. THE SUB-DRAINS SHALL BE INSTALLED IN ACCORDANCE WITH OPSS/MUNI 405.

**REFER TO NOTES & DETAILS  
ON DRAWINGS C-4 & C-5**