
UNIT MIX/ FLOOR	ВАСН	IELOR	1 BI	DRM		DRM EN	2 B	ORM		DRM DEN		ORM EN	то	TAL	TOTAL
UNIT AREA	(40-5	2m2)	(76-8	30m2)	(76-8	80m2)	(103-1	13m2)	(82-8	34m2)	(121.	9m2)			
		B.F.		B.F.		B.F.		B.F.		B.F.				B.F.	
LEVEL 1	7	1	2	0	1	0	3	1	0	0	0	0	13	2	15
LEVEL 2	9	1	3	0	1	0	5	0	0	0	0	0	18	1	19
LEVEL 3	8	2	3	0	1	0	5	0	0	0	0	0	17	2	19
LEVEL 4	7	2	3	1	1	0	3	1	0	0	0	0	14	4	18
LEVEL 5 -8 (X4 floors)	8 X4=32	1 X4=4	3 X4=12	1 X4=4	1 X4=4	0	3 X4=12	1 X4=4	0	0	0	0	15 X4=60	3 X4=12	18 X4=72
LEVEL 9	4	2	3	1	1	0	4	0	0	0	0	0	12	3	15
PENTHOUSE LEVEL	0	0	0	0	0	0	0	0	1	0	1	0	2	0	2
TOTAL	67	12	26	6	9	0	32	6	1	0	1	0	136	24 (15%)	160
TOTAL	7	9	3	2	9	9	3	8		1	,	1	1	60	160

	BUILDING A	ADEAQ		
	GROSS FLOOR AREA AS PER O.B.C.	GROSS FLOOR AREA AS PER CITY DEF.	BALCONIES	TERRACES
GROUND FLOOR AREA	1,224.7 m²	818.8 m²	11.37 m²	101.83 m²
2ND & 3RD FLOOR AREA (X2 STOREYS)	(1,230 m ² X2 =) 2,460 m ²	(1,019.04 m ² X2 =) 2460 m ²	(17.30m ² X2 =) 34.60m ²	-
4TH FLOOR AREA	1,135.57 m²	942.00 m²	39.47 m²	42.66 m²
TYPICAL FLOOR AREA (5TH - 8TH) (X4 STOREYS)	(1,135.57 m ² X4 =) 4,542.28 m ²	(942.0 m² X4 =) 3,768.0 m²	(45.6 m ² X 4 floors=) 182.4m ²	-
9TH FLOOR AREA	1,031.43 m²	844.08 m²	-	117.23 m²
PENTHOUSE FLOOR AREA	480 m²	204.74 m²	-	512.7 m² (32.7 private+ 480 Communal)
ELEVATOR MECHANICAL ROOM FLOOR AREA	54.77 m²	0.00 m²	-	-
GROSS AREA (Excludes area below grade)	10,928.75 m² (117,636.01 ft²)	8,615.7 m ² (92,738.623 ft ²)	267.84 m²	774.42 m²
SUM AMENITIES (Balconies and Terraces)			1,042.26 m² (Including 480	m² communal)
NUMBER OF STOREYS (above grade)	1	10 storeys + 1 (Elevator Mechi	ne Room) floor	
UNDERGROUND PARKING GARAGE L1	1573.36 m²	0.00 m²		
UNDERGROUND PARKING GARAGE L2	1549.00 m²	0.00 m²		

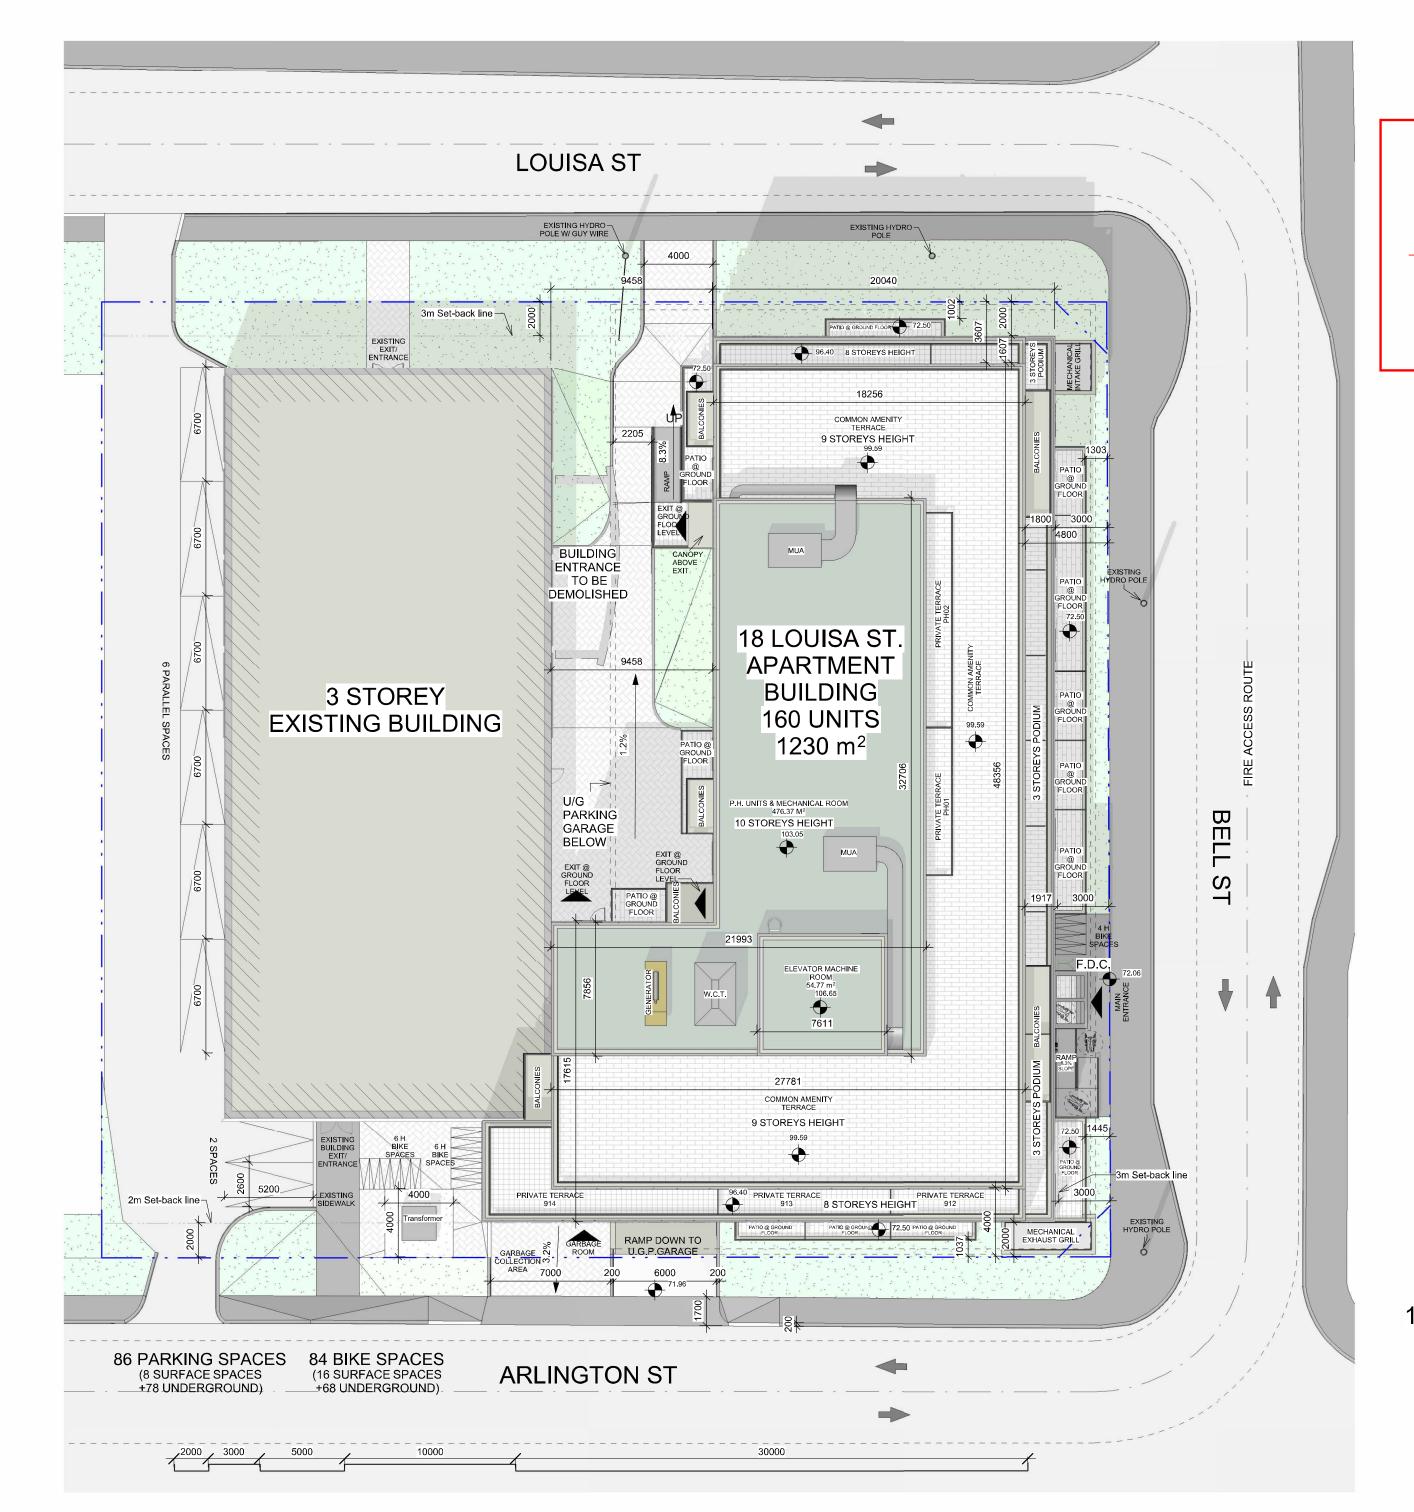



ANDREW MCCREIGHT
MANAGER, DEVELOPMENT REVIEW CENTRAL
PLANNING, DEVELOPMENT & BUILDING SERVICES
DEVELOPMENT DEPARTMENT, CITY OF OTTAWA

APPROVED

By Andrew McCreight at 2:19 pm, Jun 23, 2025

86 PARKING SPACES

8 SURFACE SPACES +78 UNDERGROUND (including 6 B.F. & 12 reduced)

84 BIKE SPACES (36 Stacked +48 Horizontal)

16 SURFACE SPACES (Horizontal) +68 UNDERGROUND (36 Stacked +32 Horizontal)

City	of Ottawa Zoning By-Law 2008-250			
ZONING MECHANISM	REQUIRED /PERMITTED	RELIEF REQ'D	PROPOSED	
MIN. LOT AREA (HIGH-RISE REGULATION)	MIN. 1150 m²		3,292 m²	
MIN. LOT WIDTH (BELL ST.)	MIN. 22.5 m ²		55.91 m²	
MIN. LOT DEPTH (LOUISA ST.)			58.86 m²	
BUILDING HEIGHT	31 m		31 m	
SETBACKS (SIDE YARDS)	3 m	YES	LOUISA ST.	2m
SETBACKS (SIDE TARDS)	3 111	TES	ARLINGTON ST.	2m
SETBACKS (FRONT YARD)	3 m		BELL ST.	3m
SETBACKS (REAR YARD)	7.2m - 7.5m		7.2m to the existing t	ouilding
LANDSCAPED AREA (%)	MIN. 30% (of developed land $2.026.7$) = 608.01 m ²		802 m² (39.57	%)

AMENITIES

Amenity Area Provided as Commonal Space MIN. 960 m² x 50% = 480m²	480 m² (50%)

LOT COVERAGE

GROUND FLOOR AREA (New Proposed Building)	1,224.7 m ²
LANDSCAPE AREA (HARD/SOFT)	802 m²
TOTAL DEVELOPED AREA	2,026.7 m ²
UNDEVELOPED (Existing building) AREA	840.43 m²
UNDEVELOPED WEST PARKING AREA PAVED ASPHALT	414.46 m²
UNDEVELOPED WEST LANDSCAPE AREA (SOFT)	10.41 m²
TOTAL LOT AREA	3,292 m²

VEHICLE PARKING CALCULATION

Minimum req	uired parking spaces / use (Se	ections 101, 1	02)	Total Parking Count Required (Including Shared Prov			
USE	PARKING RATE	GFA / UNIT	PARKING	USE	Required Parking Count		
OFFICE	1 PER 100 m²	689 m²	6.89	Office, Medical & Residential Visitor Shared	40		
MEDICAL FACILITY	0 for 200m² or less , on ground floor	200 m²	0	(see chart below)	18		
NSTRUCTIONAL FACILITY	0 for 200m² or less , on ground floor	111 m²	0	INSTRUCTIONAL FACILITY	0		
VISITOR RESIDENTIAL	0.1 / UNIT (non required for the first 12 units)	148 Units (160 - 12)	14.8	RESIDENTIAL	67		
RESIDENTIAL	0.5 / UNIT (non required for the first 12 units) 10% of value to be reduced due to location of parking in underground garage	148 Units (160 - 12)	66.6 (74 - 10%)	TOTAL REQUIRED	85		

			Sh	ared Pa	arking l	Provisi	ons (Se	ction 1	04)								
USE	Required Parking Count		kday ning		kday oon		kday noon		kday ning		rday ning		rday on		ırday noon		urday ening
	(as per section 101)	%	Р	%	Р	%	Р	%	Р	%	Р	%	Р	%	Р	%	Р
OFFICE	6.89	100%	6.89	90%	6.201	100%	6.89	15%	1.0335	20%	1.378	20%	1.378	10%	0.689	5%	0.3445
VISITOR RESIDENTIAL	14.8	50%	7.4	50%	7.4	75%	11.1	100%	14.8	100%	14.8	100%	14.8	100%	14.8	100%	14.8
Total	26.01		14.29		13.601		17.99		15.8335		16.178		16.178		15.489		15.1445

ZONING MECHANISM	REQUIRED /PERMITTED	RELIEF REQ'D	PROPOSED
VEHICLE PARKING SPACE	85		86
	standard space: Min: 2.6m wide x 5.2m long		AS REQUIRED
STANDARD PARKING SPACES DESIGN (MIN.)	up to 40% of residential 67 spaces = 26.8 can be reduced to 2.4m wide x 4.6m long		12 spaces (18%) reduced to 2.4m wide x 5.2m long
	Min: 2.6m wide x 6.7m long (parallel)		AS REQUIRED
PARKING ACCESS & ACCESS WIDTH (MIN.)	6 m		6 m
BARRIER FREE PARKING SPACE	4 Spaces total number of parking spaces is between 76 -100		4 Spaces
BF PARKING SPACES DESIGN (MIN.)	2 spaces X 2.4m wide & 2 spaces X 3.4m wide Access aisle of min. 1.5m		2 spaces X 2.4m wide & 2 spaces X 3.4m wide Access aisle of min. 1.5m

BICYCLE PARKING

BICYCLE PARKING SPACE	Total: 84 Spaces Res: 0.5 space/ unit = 80 space Instructional Facility: 1 per 1,500 m2 = 0.2 space Medical Facility: 1 per 1,000 m2 = 0.2 space Office: 1 per 250 m2 = 3.8 space		84 Spaces
	Maximum 50% (42 spaces) within Landscaped Area		16 Surface spaces
ACCESS AISLE FOR BICYCLE PARKING	Minimum width: 1.5m	YES	1.2 m
BICYCLE PARKING SPACE DESIGN (MIN.)	horizontal: 0.6m wideX1.8m long vertical: 0.5m wideX1.5m long		horizontal: 0.6m wideX1.8m long vertical: 0.6m wideX1.5m long
Maximum Number of Vertical Bicycle Parking Spaces	50% of required spaces = 42	YES	(40.4%) 34 STACKED Spaces 0.6m wide X 1.8m long

DO NOT SCALE DRAWINGS

CHECK AND VERIFY ALL DIMENSIONS BEFORE PROCEEDING WITH THE WORK.

DRAWINGS NOT TO BE USED FOR CONSTRUCTION UNLESS STAMPED AND SIGNED BY THE CONSULTANT.

THESE DRAWINGS HAVE BEEN DESIGNED IN COMFORMANCE WITH THE ONTARIO BUILDING CODE.

	Re	visions
Revision Number	Revision Date	Revision Description
Namber	Date	revision bescription
01	2022.03.14	ISSUED FOR REVIEW
	00040000	ISSUED FOR SPA
08	2024.08.08	1990ED FOR SPA
08 09	2024.08.08	RE-ISSUED FOR SPA



Alexander Wilson Architect Inc Admiralty Place 103-20 Gore Street Kingston Ontario, K7L 2L1 t: 613.545.3744 ext 213 f: 613.545.1411



18 LOUISA ST.

18 LOUISA ST. OTTAWA, ONTARIO

SITE PLAN & ZONING INFO

Drawing No.		A001	
Project No.	2414 (AWA 2204)	Revision	11
Scale	1:200	Date	2024.11.18
Drawn By	Fahd A.Z.	Checked By	AWA

DESIGNED FIRE ACCESS ROUTES, FIRE ROUTE SIGNS:

TOW AWAY ZONE

1) FIRE ROUTES SHALL BE PERMANENTLY MOUNTED ON A RIGID SIGN POST OR 2) BE ERECTED AT A HEIGHT BETWEEN 1.9 AND 2.5 METERS AS MEASURED FROM

THE TRAVELLED SURFACE OF THE FIRE ROUTE TO THE BOTTOM OF THE SIGN.

3) BE INSTALLED AT A DISTANCE OF 0.3 AND 3 METERS FROM THE TRAVELLED EDGES OF THE FIRE ROUTE AND 4) BE INSTALLED ALONG THE FIRE ROUTE AT INTERVALS NO GREATER THAN 30 METERS OR AT SUCH OTHER INTERVALS APPROVED BY THE CHIEF FIRE OFFICAIL. AS MAY BE REQUIRED TO CLEARLY IDENTIFY THE ROUTE.

5) THE DIRECTIONAL ARROWHEARS MAY BE DELETED EITHER LEFT OR RIGHT TO INDICATE THE BOUNDARIES OF THE FIRE ROUTE.

ACCESSIBLE PARKING NOTES

MINIMUM OF 1 AUTHORIZED SIGN PER PARKING SPACE, LOCATED WITHIN 2m OF THE FRONTOF THE SPACE, CENTERED ON THE SPACE


ACCESSIBLE PARKING NOTED IN PLANBY THE FOLLOWING












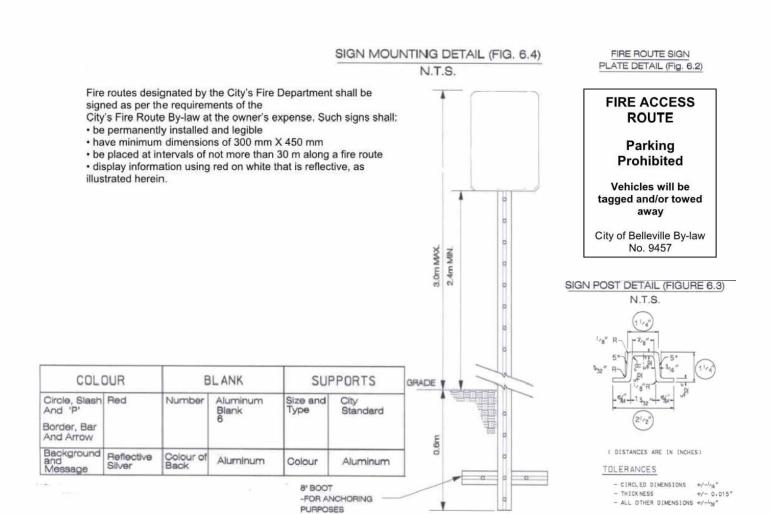

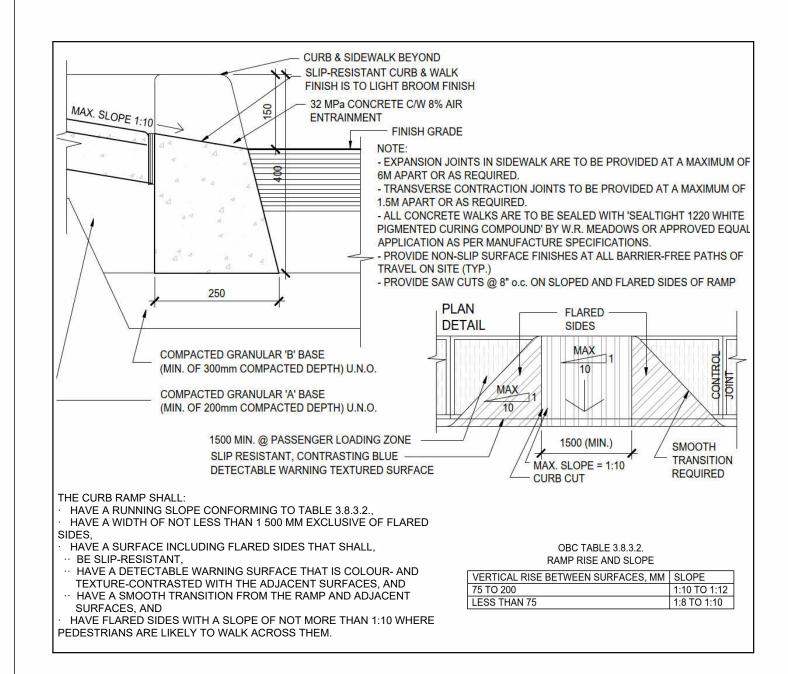


TYPICAL B.F. RAMP DEPRESSION

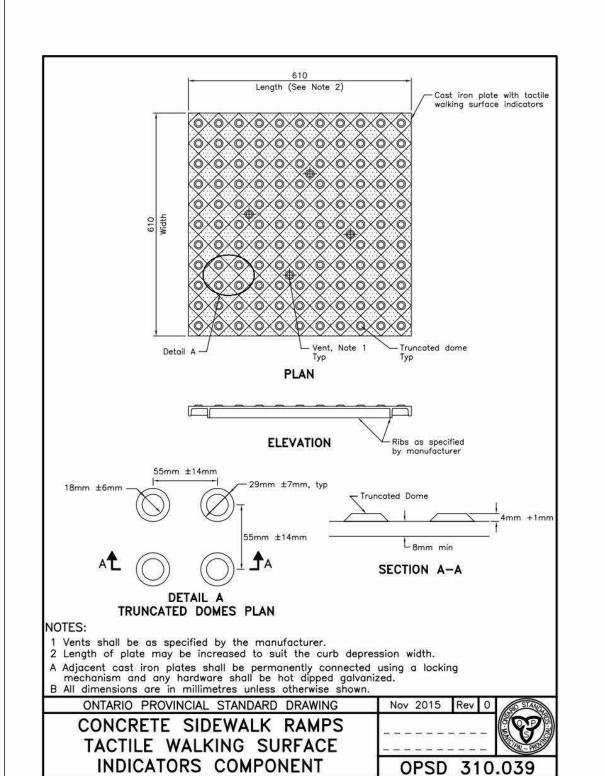

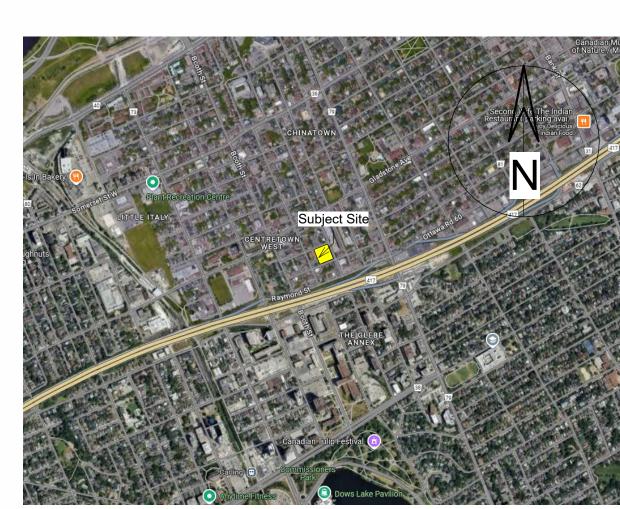


GENERAL NOTES:


1. ALL EXISTING PAVEMENT, CURBS, SIDEWALKS DRIVEWAYS AND BOULEVARD AREAS DISTURBED BY THE CONSTRUCTION MUST BE REINSTATED TO THE SATISFACTION OF THE TOWN. 2. A MINIMUM SETBACK OF 1.0m FROM STREET FURNITURE TO PROPOSED DRIVEWAYS AND SIDEWALKS SHALL BE MAINTAINED. ALL EXISTING STREET FURNITURE TO BE RELOCATED BY THE CONTRACTOR/OWNER TO A SETBACK OF 1.0m. THE COST OF THE RELOCATION OF ANY UTILITY IS THE RESPONSIBILITY OF THE DEVELOPER/ONWER. 3. THE CONTRACTOR/OWNER IS RESPONSIBLE FOR ALL UTILITY LOCATES AND AND DAMAGE OR DISTURBANCE DURING CONSTRUCTION. 4. ALL BARRIER FREE ENTRANCES AND BARRIER FREE PATHS OF TRAVEL MUST COMPLY WITH O.B.C. 3.8. 5. THE OWNER/CONTRACTOR SHALL SUPPLY ALL FIRE ROUTE AND HANDICAP SIGNS AS SET OUT IN THE TOWN BY-LAWS AND DESIGN CRITERIA. 6. ALL EXTERIOR ILLUMINATION TO BE DIRECTED DOWNWARD AS WELL AS INWARD AND DESIGNED TO MAINTAIN ZERO CUTOFF LIGHT DISTRIBUTION AS THE PROPERTY LINE. 7. ALL DOWNSPOUTS TO BE CONNECTED TO THE STORM DRAINAGE SYSTEM. 8. ALL CONDENSING UNITS TO BE SCREENED ON THE GROUND FLOOR 9. SEPARATE PERMITS ARE REQUIRED FOR ANY SIGNAGE ON THE PROPERTY. 10.WHERE POSSIBLE TREES ARE TO BE PROTECTED FROM CONSTRUCTION. 11.EXCESS SNOW WILL BE REMOVED BY PRIVATE HAULER SUBJECT TO DEMAND FOR PARKING. 12.REBOUNDING SIGN POST MOUNTED ON CURB. MANUFACTURE: IMPACT RECOVERY (http://www.impactrecovery.com/) STYLE: Sta-Rite Sign Posts. SIGN MOUNTING HEIGHT & SIGN AS PER TOWN ACCESSIBILITY STANDARDS

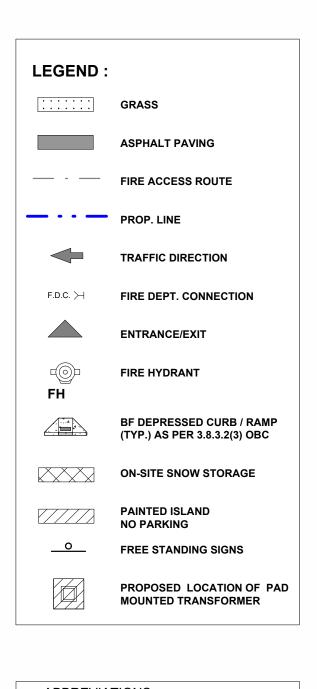

ABBREVIATIONS

- **CURB DEPRESSOIN ROOF DRAIN**
- FINISHED FLOOR LEVEL FIRE ACCESS ROUTE SIGN ACESSIBLE PARKING SIGN
- OVERHEAD DOOR
- FRIE-HYDRANT
- FIRE DEPARTMENT CONNECTION

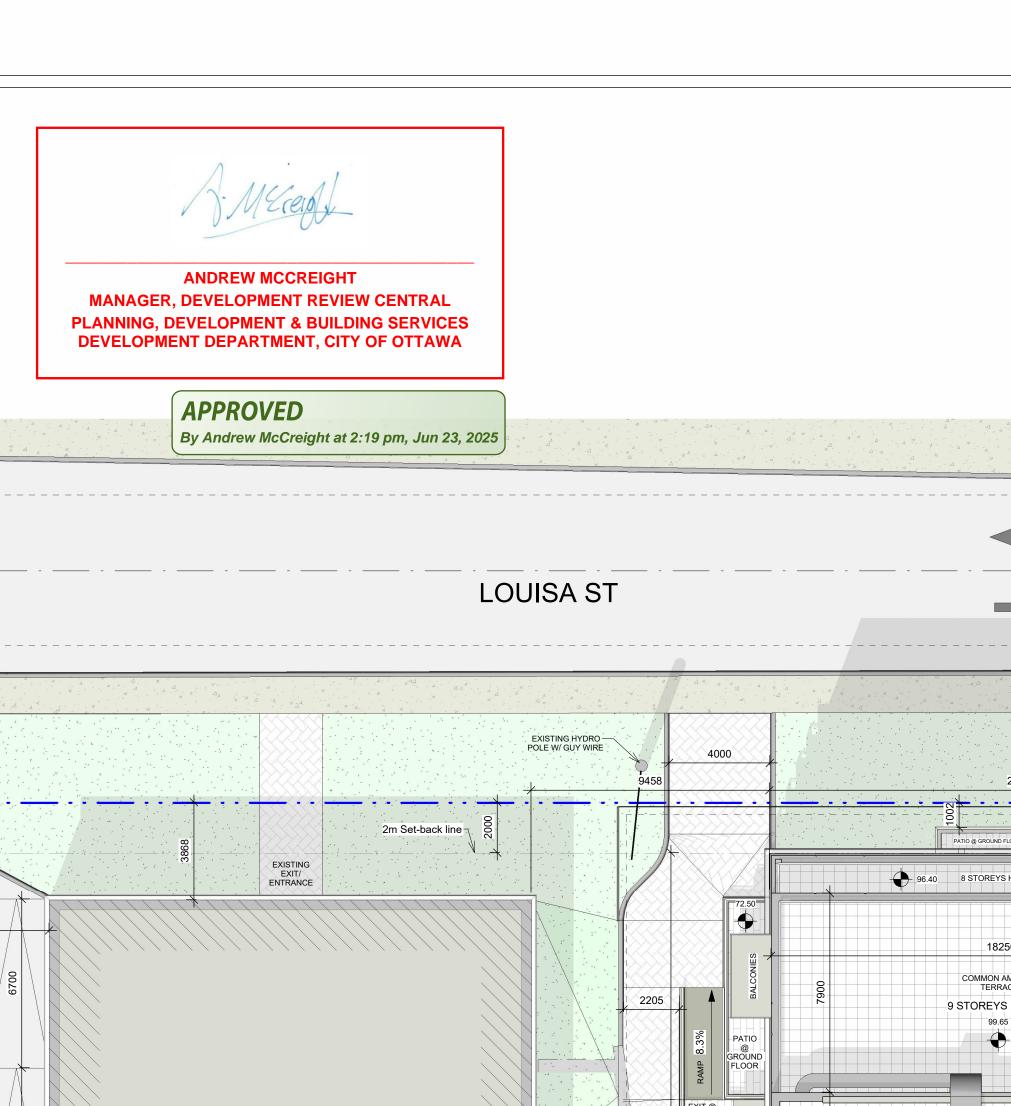

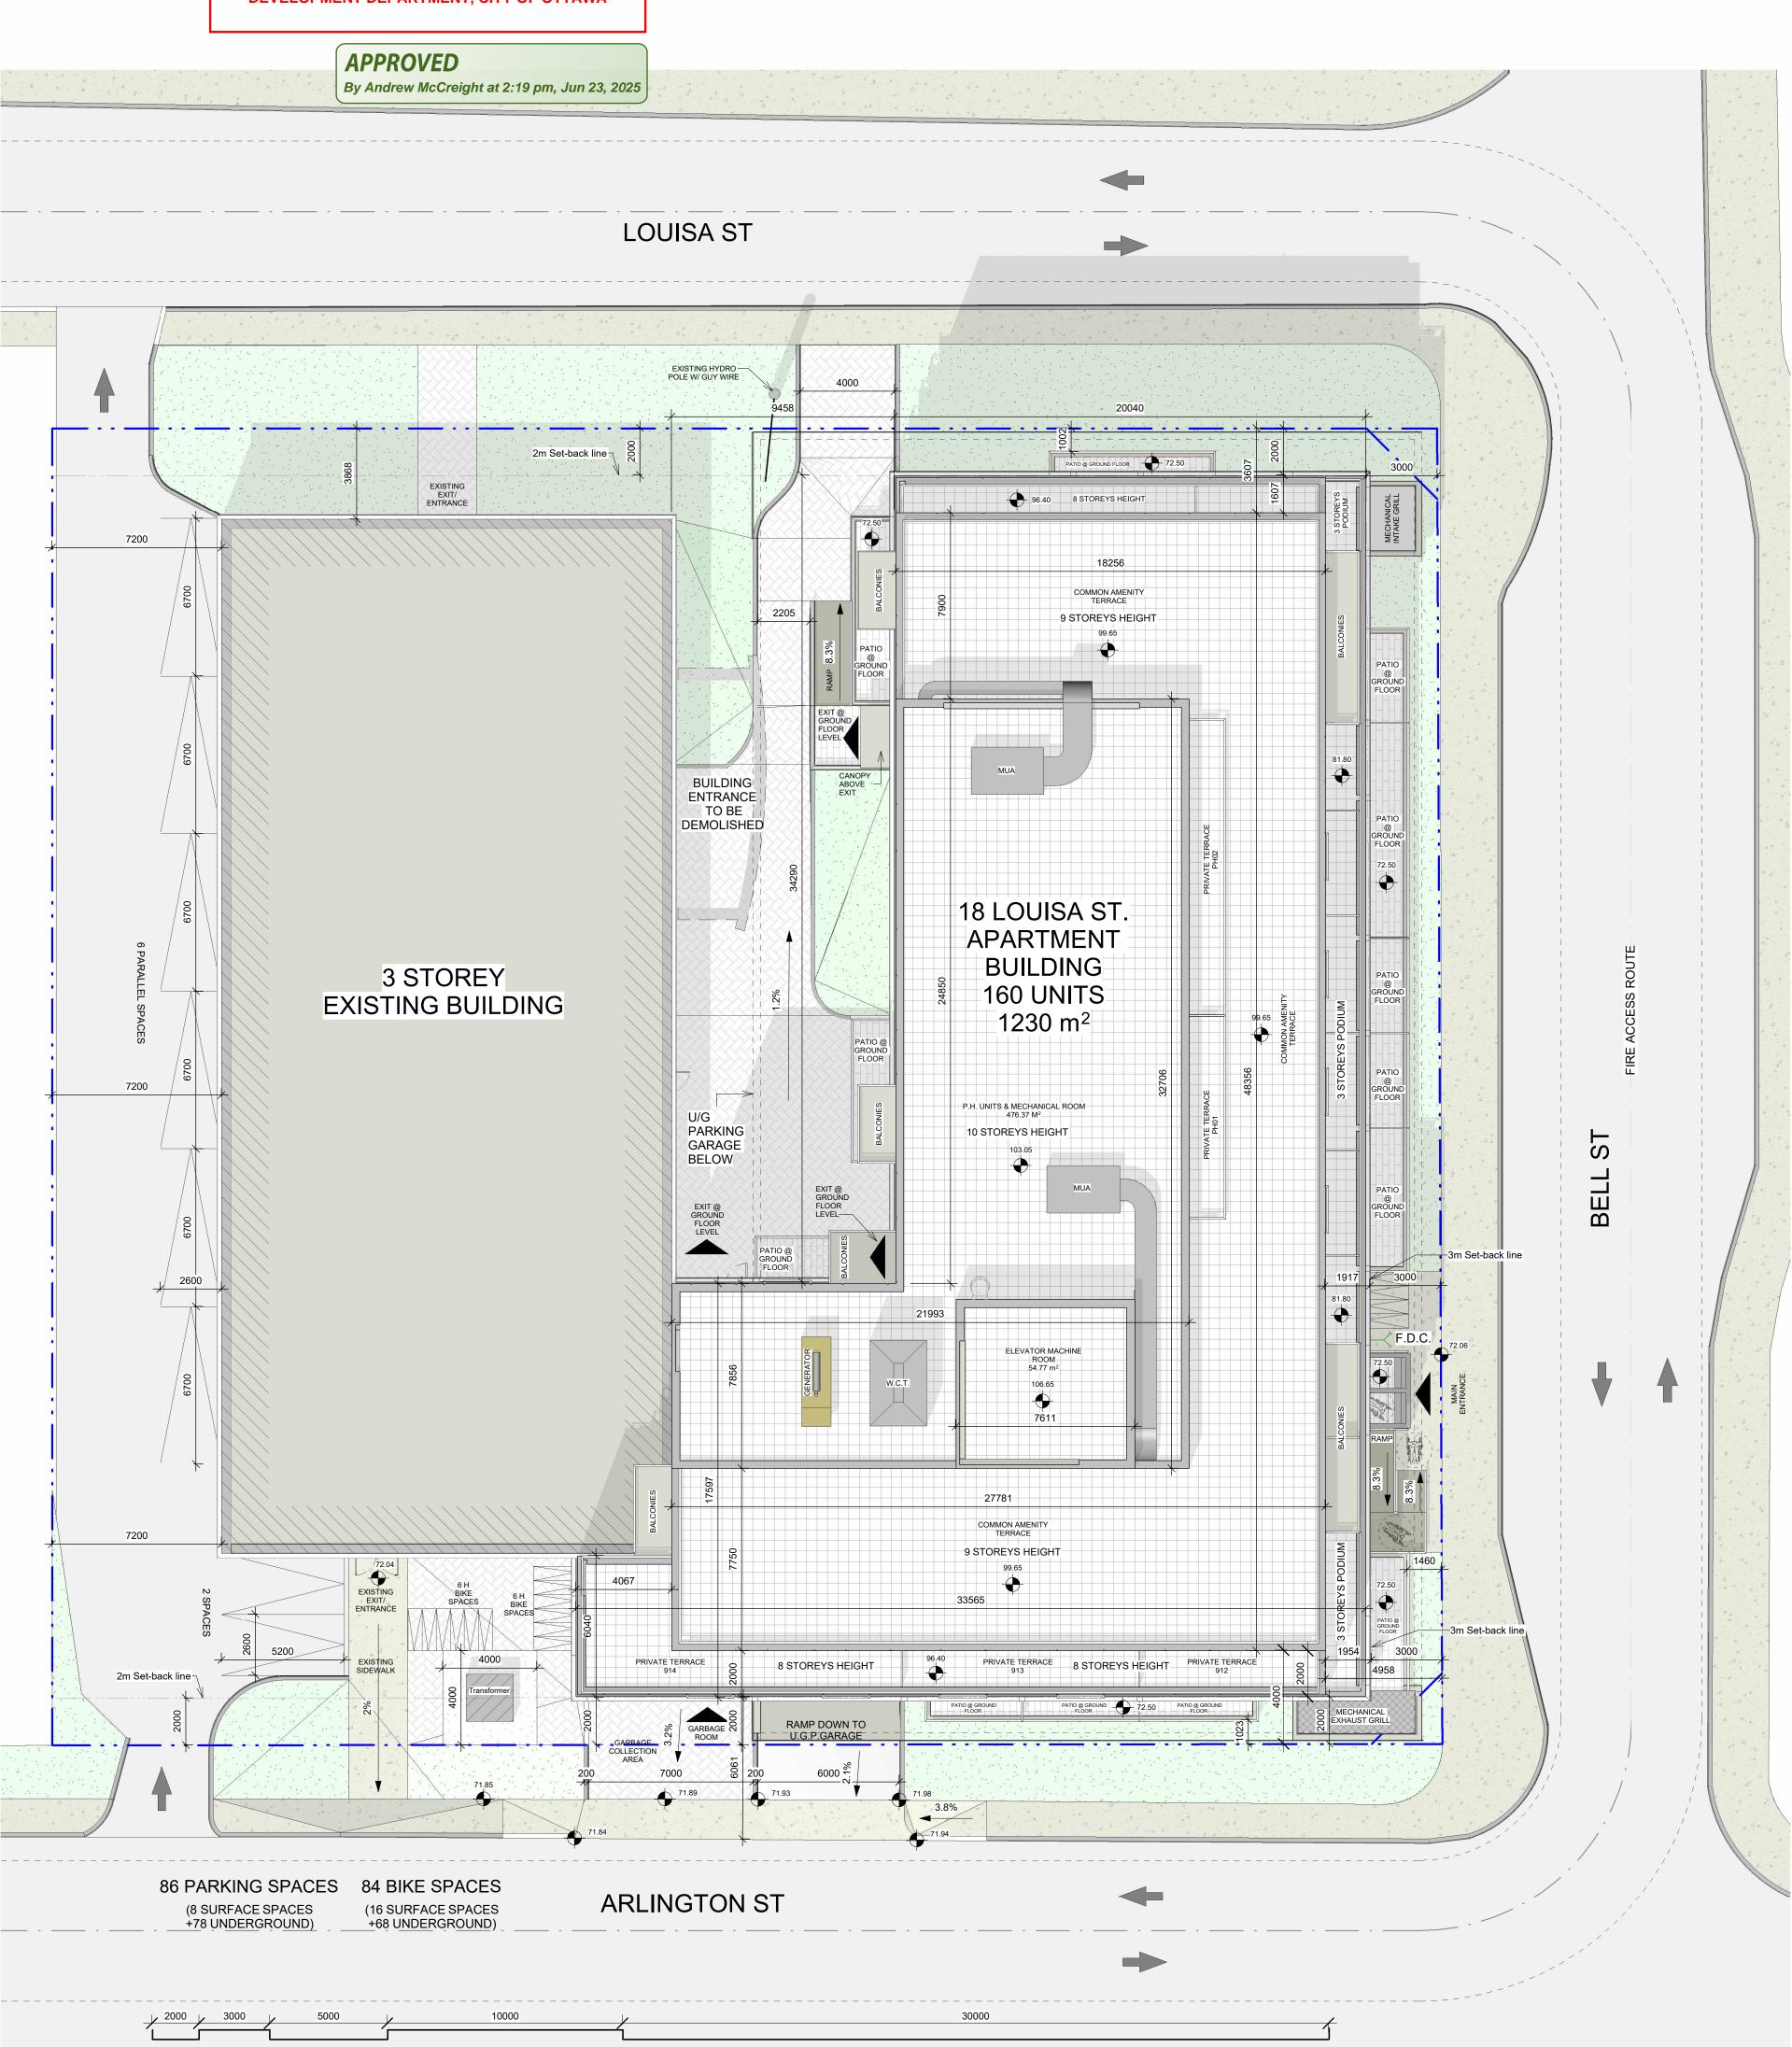

DO NOT SCALE DRAWINGS

CONSULTANT.

CHECK AND VERIFY ALL DIMENSIONS BEFORE PROCEEDING WITH THE WORK.

DRAWINGS NOT TO BE USED FOR CONSTRUCTION UNLESS STAMPED AND SIGNED BY THE

THESE DRAWINGS HAVE BEEN DESIGNED IN COMFORMANCE WITH THE ONTARIO BUILDING

	Re	visions
Revision	Revision	
Number	Date	Revision Description
01	2022.03.14	ISSUED FOR REVIEW
0.	2024.08.08	ISSUED FOR SPA
08	2024.00.00	IOCOLD I OIL OI /
08 09	2024.08.08	RE-ISSUED FOR SPA



Admiralty Place 103-20 Gore Street Kingston Ontario, K7L 2L1 t: 613.545.3744 ext 213 f: 613.545.1411



18 LOUISA ST.

18 LOUISA ST. OTTAWA, ONTARIO

SITE PLAN DETAILS & LEGENDS

	Drawn By	Fahd A.Z.	Checked By	AWA
_	Scale	As indicated	Date	2024.10.25
_	Project No.	2414 (AWA 2204)	Revision 1	0
_	Drawing No.	/	4002	

ANDREW MCCREIGHT MANAGER, DEVELOPMENT REVIEW CENTRAL PLANNING, DEVELOPMENT & BUILDING SERVICES **DEVELOPMENT DEPARTMENT, CITY OF OTTAWA**

> APPROVED By Andrew McCreight at 2:19 pm, Jun 23, 2025

Revisions			
Revision Number	Revision Date	Revision Description	
	·		
01	2022.03.14	ISSUED FOR REVIEW	
08	2024.08.08	ISSUED FOR SPA	
09	2024.09.03	RE-ISSUED FOR SPA	
10	2024.10.25	RE-ISSUED FOR SPA	

CHECK AND VERIFY ALL DIMENSIONS BEFORE

UNLESS STAMPED AND SIGNED BY THE


THESE DRAWINGS HAVE BEEN DESIGNED IN COMFORMANCE WITH THE ONTARIO BUILDING

DRAWINGS NOT TO BE USED FOR CONSTRUCTION

DO NOT SCALE DRAWINGS

CONSULTANT.

PROCEEDING WITH THE WORK.

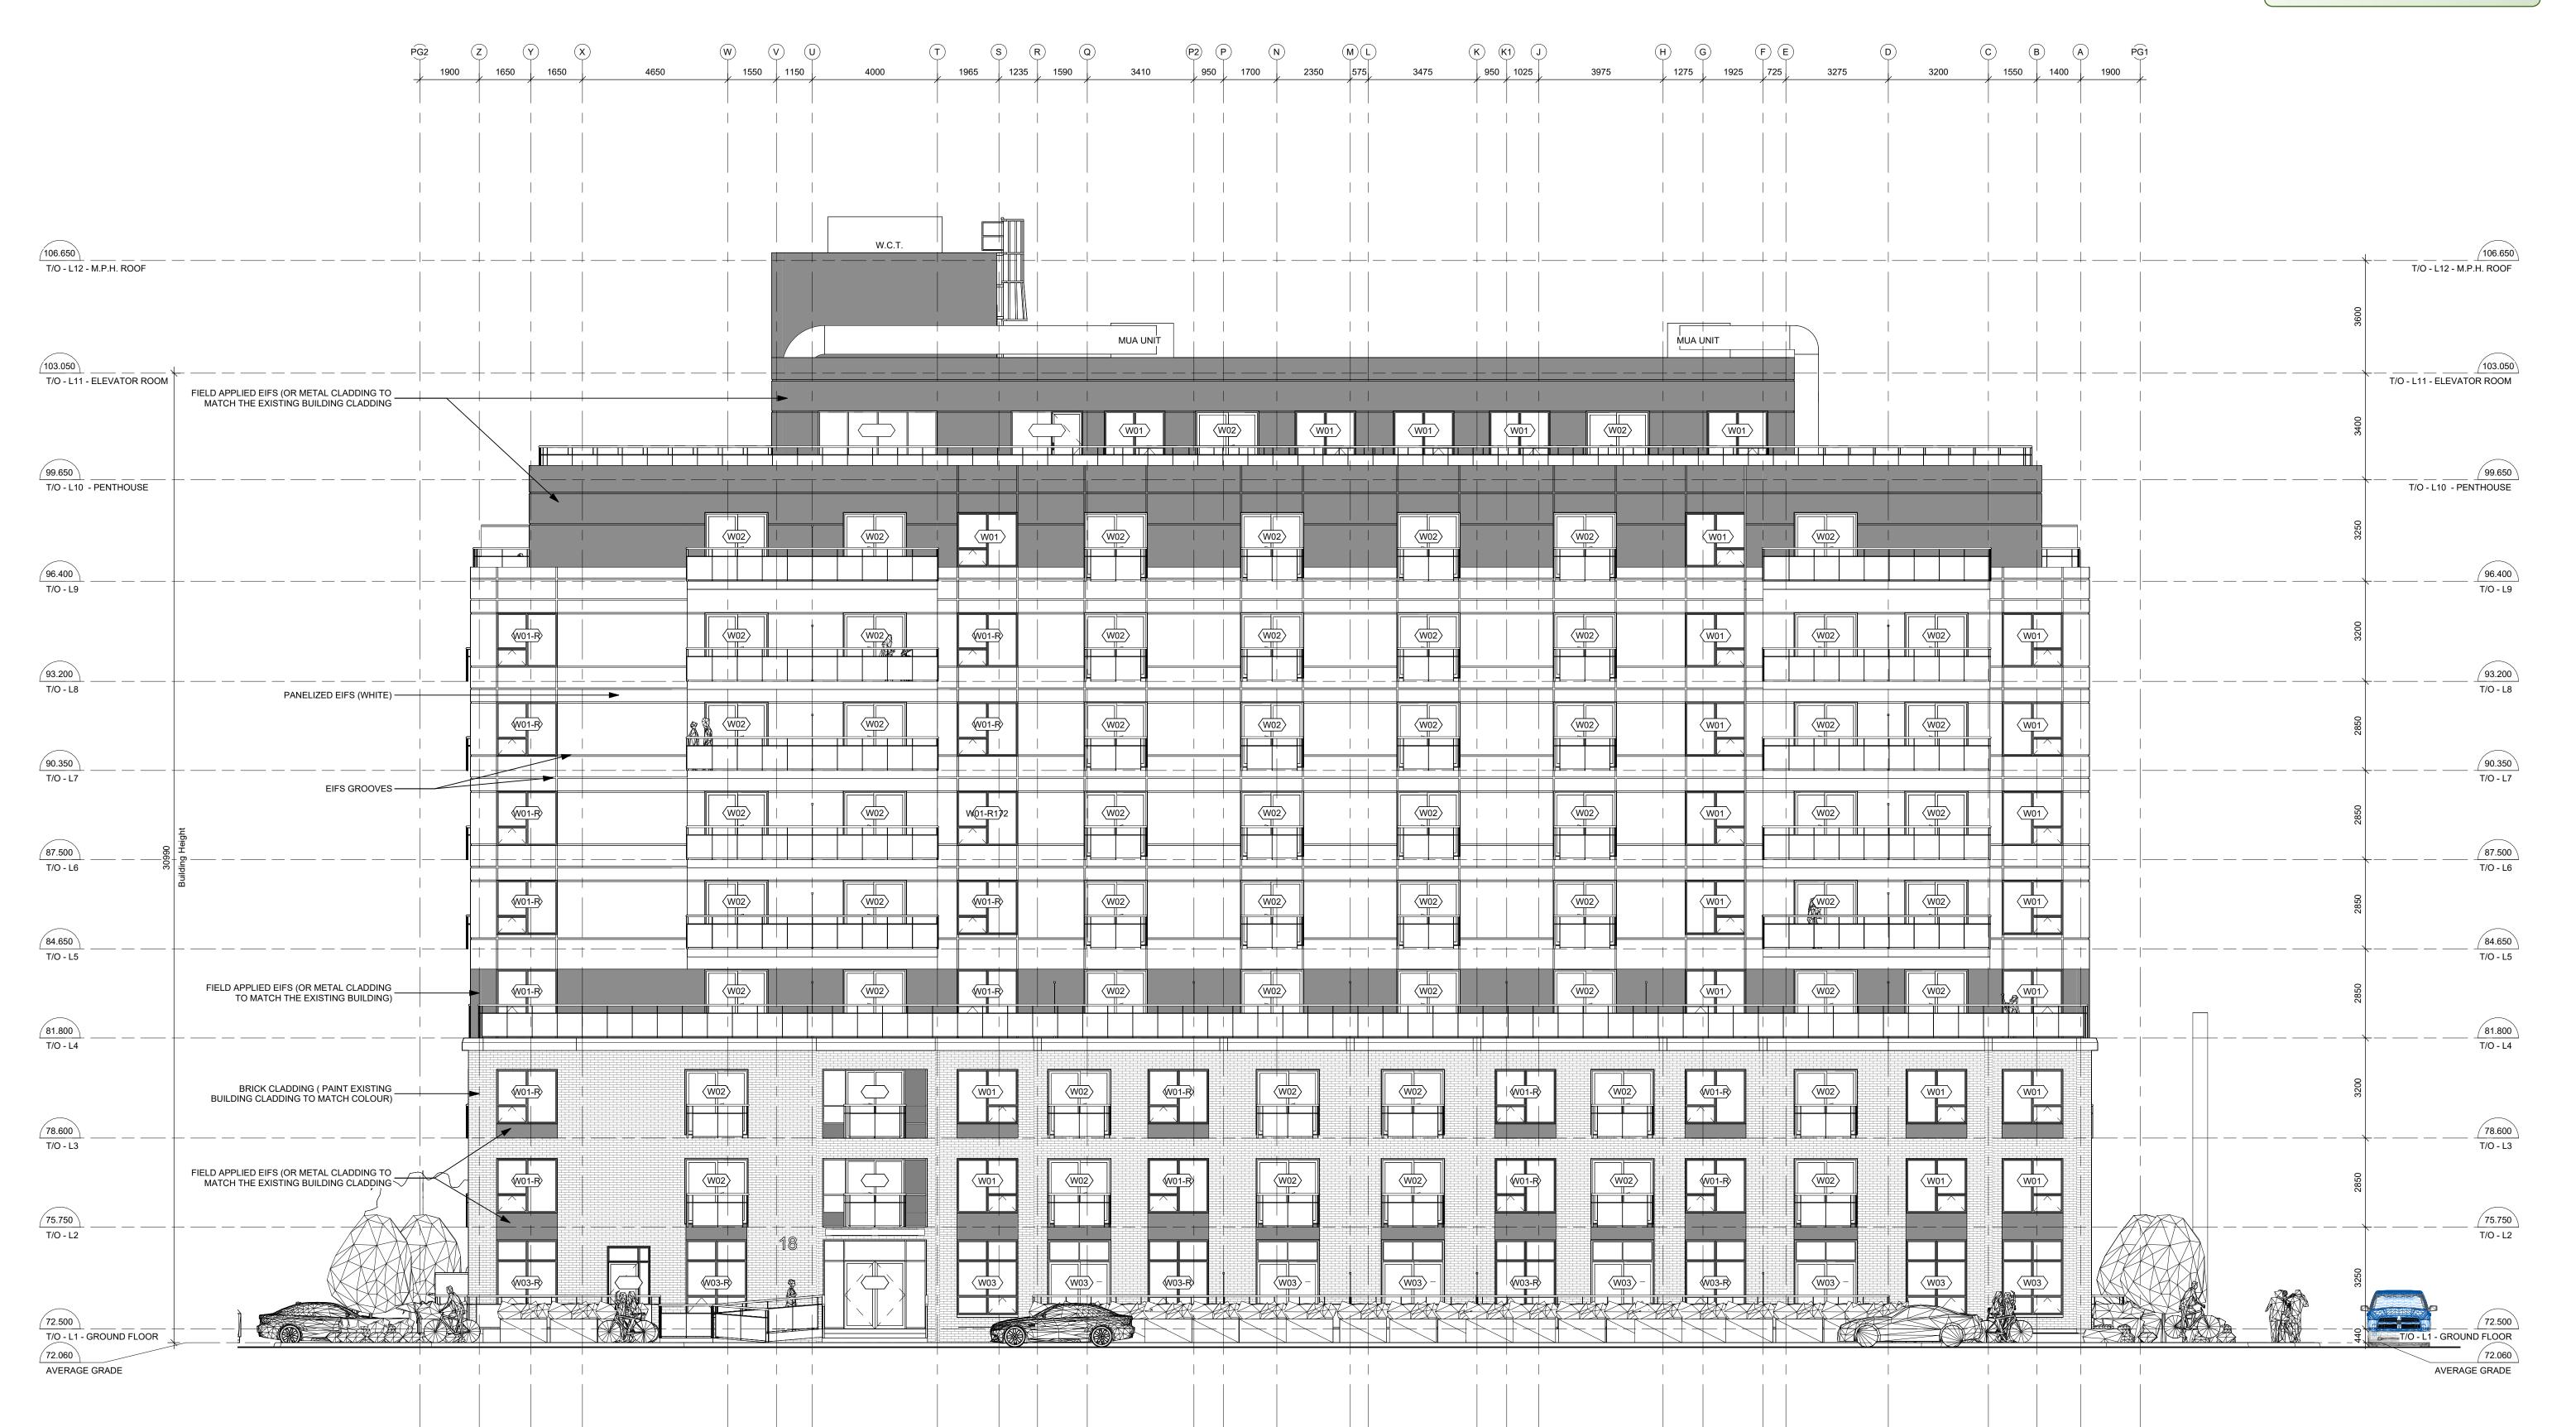

Admiralty Place 103-20 Gore Street Kingston Ontario, K7L 2L1 t: 613.545.3744 ext 213 f: 613.545.1411

18 LOUISA ST.

18 LOUISA ST. OTTAWA, ONTARIO

EAST ELEVATION

Drawing No.		A200	`
Project No.	2414 (AWA 2204)	Revision	10
Scale	1 : 100	Date	2024.10.25
Drawn By	Fahd A.Z.	Checked By	/ AWA

1 EAST ELEVATION

ANDREW MCCREIGHT MANAGER, DEVELOPMENT REVIEW CENTRAL PLANNING, DEVELOPMENT & BUILDING SERVICES DEVELOPMENT DEPARTMENT, CITY OF OTTAWA APPROVED By Andrew McCreight at 2:20 pm, Jun 23, 2025 4000 2700 2200 890 1910 1650 106.650 T/O - L12 - M.P.H. ROOF T/O - L12 - M.P.H. ROOF GENERATOR 103.050 T/O - L11 - ELEVATOR ROOM T/O - L11 - ELEVATOR ROOM T/O - L10 - PENTHOUSE T/O - L10 - PENTHOUSE 96.400 96.400 T/O - L9 T/O - L9 (W01-R) ₩01-R 84.650 T/O - L5 Existing BLDG T/O Roof 81.800 T/O - L4 81.800 T/O - L4 Existing BLDG T/O - L3 Existing BLDG T/O - L2 72.500 T/O - L1 - GROUND FLOOR 72.060 AVERAGE GRADE AVERAGE GRADE

DO NOT SCALE DRAWINGS

CHECK AND VERIFY ALL DIMENSIONS BEFORE PROCEEDING WITH THE WORK.


DRAWINGS NOT TO BE USED FOR CONSTRUCTION UNLESS STAMPED AND SIGNED BY THE CONSULTANT.

THESE DRAWINGS HAVE BEEN DESIGNED IN COMFORMANCE WITH THE ONTARIO BUILDING CODE.

	Re	visions
Revision	Revision	
Number	Date	Revision Description
01	2022.03.14	ISSUED FOR REVIEW
08	2024.08.08	ISSUED FOR SPA
09	2024.09.03	RE-ISSUED FOR SPA
		RE-ISSUED FOR SPA



Alexander Wilson Architect Inc Admiralty Place 103-20 Gore Street Kingston Ontario, K7L 2L1 t: 613.545.3744 ext 213 f: 613.545.1411

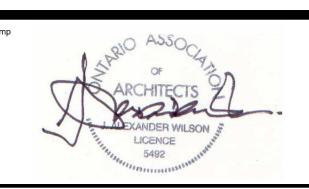

18 LOUISA ST.

18 LOUISA ST. OTTAWA, ONTARIO

SOUTH ELEVATION

	Drawn By	Fahd A.Z.	Checked By	AWA
	Scale	1 : 100	Date	2024.10.25
	Project No.	2414 (AWA 2204)	Revision	10

rawing No. A201

SOUTH ELEVATION
1: 100

ANDREW MCCREIGHT MANAGER, DEVELOPMENT REVIEW CENTRAL PLANNING, DEVELOPMENT & BUILDING SERVICES DEVELOPMENT DEPARTMENT, CITY OF OTTAWA APPROVED By Andrew McCreight at 2:20 pm, Jun 23, 2025 1650 2350 W.C.T. 106.650 T/O - L12 - M.P.H. ROOF T/O - L12 - M.P.H. ROOF GENERATOR MUA UNIT MUA UNIT 103.050 T/O - L11 - ELEVATOR ROOM T/O - L11 - ELEVATOR ROOM (V01-R) (W01-R) T/O - L10 - PENTHOUSE T/O - L10 - PENTHOUSE 96.400 96.400 T/O - L9 T/O - L9 87.500 T/O - L6 84.650 T/O - L5 81.800 T/O - L4 81.800 T/O - L4 78.910 75.750 T/O - L2 Existing BLDG T/O - L2 72.500 T/O - L1 - GROUND FLOOR AVERAGE GRADE AVERAGE GRADE

WEST ELEVATION
1:100

DO NOT SCALE DRAWINGS

CHECK AND VERIFY ALL DIMENSIONS BEFORE PROCEEDING WITH THE WORK.


DRAWINGS NOT TO BE USED FOR CONSTRUCTION UNLESS STAMPED AND SIGNED BY THE CONSULTANT.

THESE DRAWINGS HAVE BEEN DESIGNED IN COMFORMANCE WITH THE ONTARIO BUILDING CODE.

	Rev	visions
Revision Number	Revision Date	Revision Description
01	2022.03.14	ISSUED FOR REVIEW
08	2024.08.08	ISSUED FOR SPA
09	2024.09.03	RE-ISSUED FOR SPA
10	2024.10.25	RE-ISSUED FOR SPA

A

Alexander Wilson Architect Inc Admiralty Place 103-20 Gore Street Kingston Ontario, K7L 2L1 t: 613.545.3744 ext 213 f: 613.545.1411

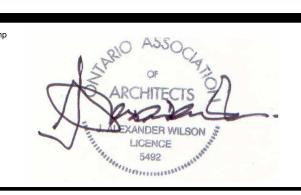

18 LOUISA ST.

18 LOUISA ST. OTTAWA, ONTARIO

WEST ELEVATION

Drawn By	Fahd A.Z.	Checked B	y AWA
Scale	1:100	Date	2024.10.25
Project No.	2414 (AWA 2204)	Revision	10
Drawing No.		A202	2

ANDREW MCCREIGHT MANAGER, DEVELOPMENT REVIEW CENTRAL **PLANNING, DEVELOPMENT & BUILDING SERVICES** DEVELOPMENT DEPARTMENT, CITY OF OTTAWA APPROVED By Andrew McCreight at 2:20 pm, Jun 23, 2025 1650 1250 106.650 T/O - L12 - M.P.H. ROOF T/O - L12 - M.P.H. ROOF GENERATOR 103.050 T/O - L11 - ELEVATOR ROOM T/O - L11 - ELEVATOR ROOM T/O - L10 - PENTHOUSE T/O - L10 - PENTHOUSE 96.400 96.400 T/O - L9 T/O - L9 87.500 T/O - L6 84.650 T/O - L5 81.800 T/O - L4 78.910 Existing BLDG T/O - L3 75.750 T/O - L2 Existing BLDG T/O - L2 72.500 T/O - L1 - GROUND FLOOR T/O - L1 - GROUND FLOOR 72.060 AVERAGE GRADE AVERAGE GRADE

NORTH ELEVATION
1: 100

DO NOT SCALE DRAWINGS

CHECK AND VERIFY ALL DIMENSIONS BEFORE PROCEEDING WITH THE WORK.


DRAWINGS NOT TO BE USED FOR CONSTRUCTION UNLESS STAMPED AND SIGNED BY THE CONSULTANT.

THESE DRAWINGS HAVE BEEN DESIGNED IN COMFORMANCE WITH THE ONTARIO BUILDING CODE.

	Rev	visions
Revision Number	Revision Date	Revision Description
01	2022.03.14	ISSUED FOR REVIEW
80	2024.08.08	ISSUED FOR SPA
09	2024.09.03	RE-ISSUED FOR SPA
10	2024.10.25	RE-ISSUED FOR SPA



Alexander Wilson Architect Inc Admiralty Place 103-20 Gore Street Kingston Ontario, K7L 2L1 t: 613.545.3744 ext 213 f: 613.545.1411

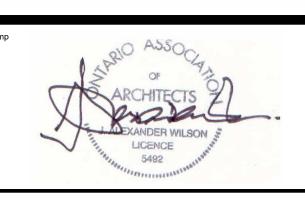

18 LOUISA ST.

18 LOUISA ST. OTTAWA, ONTARIO

NORTH ELEVATION

Drawn By	Fahd A.Z.	Checked B	y AWA
Scale	1 : 100	Date	2024.10.25
Project No.	2414 (AWA 2204)	Revision	10

A203



DO NOT SCALE DRAWINGS

CHECK AND VERIFY ALL DIMENSIONS BEFORE PROCEEDING WITH THE WORK.


DRAWINGS NOT TO BE USED FOR CONSTRUCTION UNLESS STAMPED AND SIGNED BY THE CONSULTANT.

THESE DRAWINGS HAVE BEEN DESIGNED IN COMFORMANCE WITH THE ONTARIO BUILDING CODE.

	Re	visions
Revision	Revision	
Number	Date	Revision Description
D1	2022.03.14	ISSUED FOR REVIEW
08	2024.08.08	ISSUED FOR SPA
09	2024.09.03	RE-ISSUED FOR SPA
10	2024.10.25	RE-ISSUED FOR SPA



Alexander Wilson Architect In Admiralty Place 103-20 Gore Street Kingston Ontario, K7L 2L1 t: 613.545.3744 ext 213

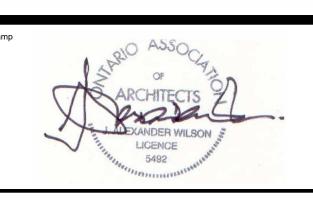

18 LOUISA ST.

18 LOUISA ST. OTTAWA, ONTARIO

COURTYARD ELEVATION

Drawn By Fahd A.Z.	Checked By AWA
Scale 1 : 100	Date 2024.10.25
Project No. 2414 (AWA 2204)	Revision 10