

GENERAL NOTES

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10 Reinstate all areas and items damaged as a result of

	7	Re-issued SPC submission	2024/11/01
	6	Issued for Coordination	2024/10/01
	6	Re-issued SPC submission	2024/07/05
	5	Re-issued SPC submission	2023/07/20
	4	Re-issued SPC submission	2023/04/24
	3	Re-issued SPC submission	2023/01/09
	2	Re-issued SPC submission	2022/07/08
I	1	Issued for SPC submission	2021/11/22
ı			

issue / revision





Ruhland & Associates Ltd

project

3996 INNES RD, OTTAWA ON

drawing title

LANDSCAPE PLAN

21-1647	L -	01	2
project number	drawing number		D07-1
	checked by M. Ruhland		12.21
1:100	D.A / T. F	M. Ruhland	_
scale	drawn by	designed by	200
			 _

Contractor to check and verify all dimensions on the job

TREE SOIL VOLUME REQUIREMENTS: - STANDARD TREE SOIL VOLUMES QUANTITIES INCLUDE THE TOP 900-1000mm OF SOIL/EXISTING SUBSOIL LAYER TO CALCULATE TOTAL SOIL VOLUMES REQUIRED BY CITY OF OTTAWA FOR SUSTAINABLE TREE GROWTH. WHERE LARGER SOFT AREAS ARE AVAILABLE, THE TOP 400-500mm LAYER IS USED TO CALCULATE SOIL VOLUMES.

WHERE EXISTING MATERIAL BELOW THE SPECIFIED TOPSOIL IS NOT CONDUCIVE TO TREE GROWTH, AN ADDITIONAL LAYER OF PLANTING MEDIUM IS TO BE INSTALLED BELOW SPECIFIED TOPSOIL DEPTH TO OBTAIN THE SOIL VOLUME DEPTH REQUIRED.

REFER TO SOIL VOLUME CHART AND PLANS FOR AREA WHERE TREE SOIL VOLUMES ARE REQUIRED.

JOHN SEVIGNY C.E.T.


MANAGER (A), DEVELOPMENT REVIEW EAST


PLANNING, DEVELOPMENT & BUILDING SERVICES


DEPARTMENT, CITY OF OTTAWA


By sevignyjo at 4:04 pm, May 27, 2025

APPROVED

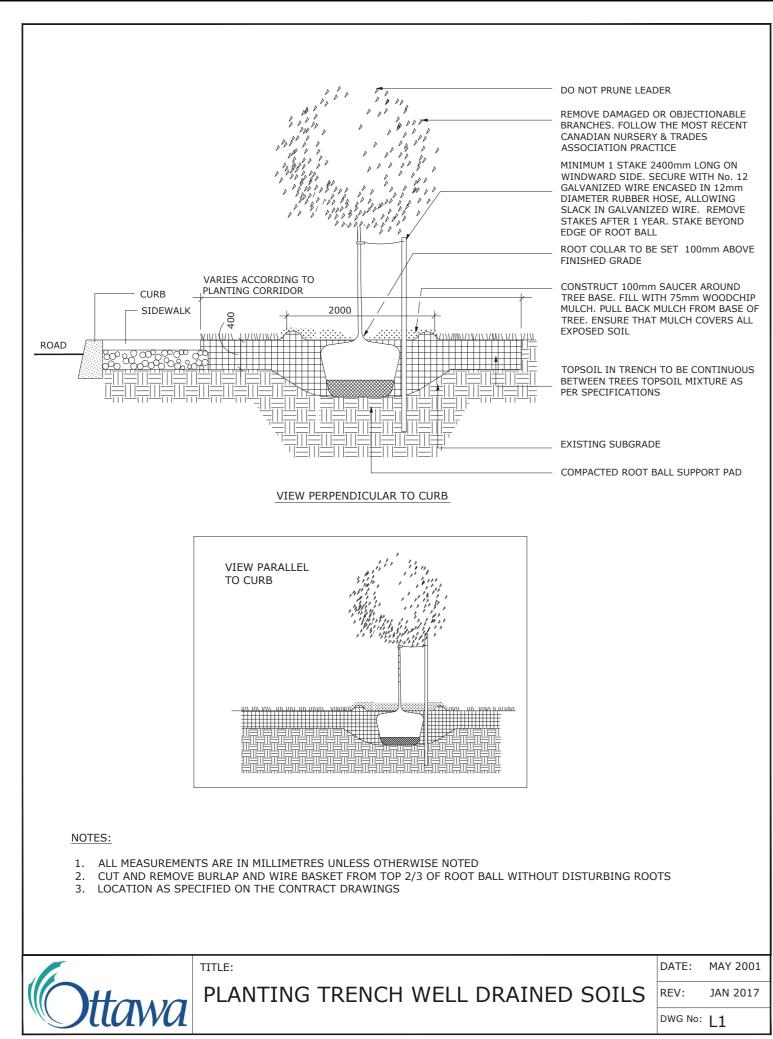

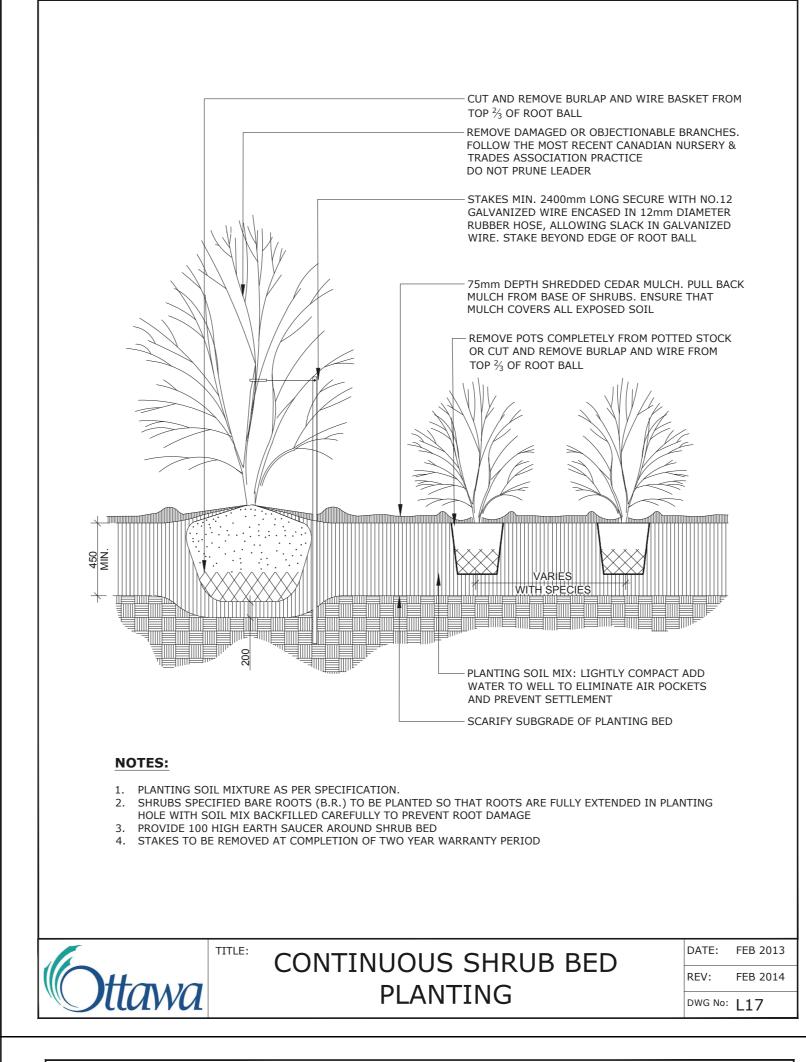

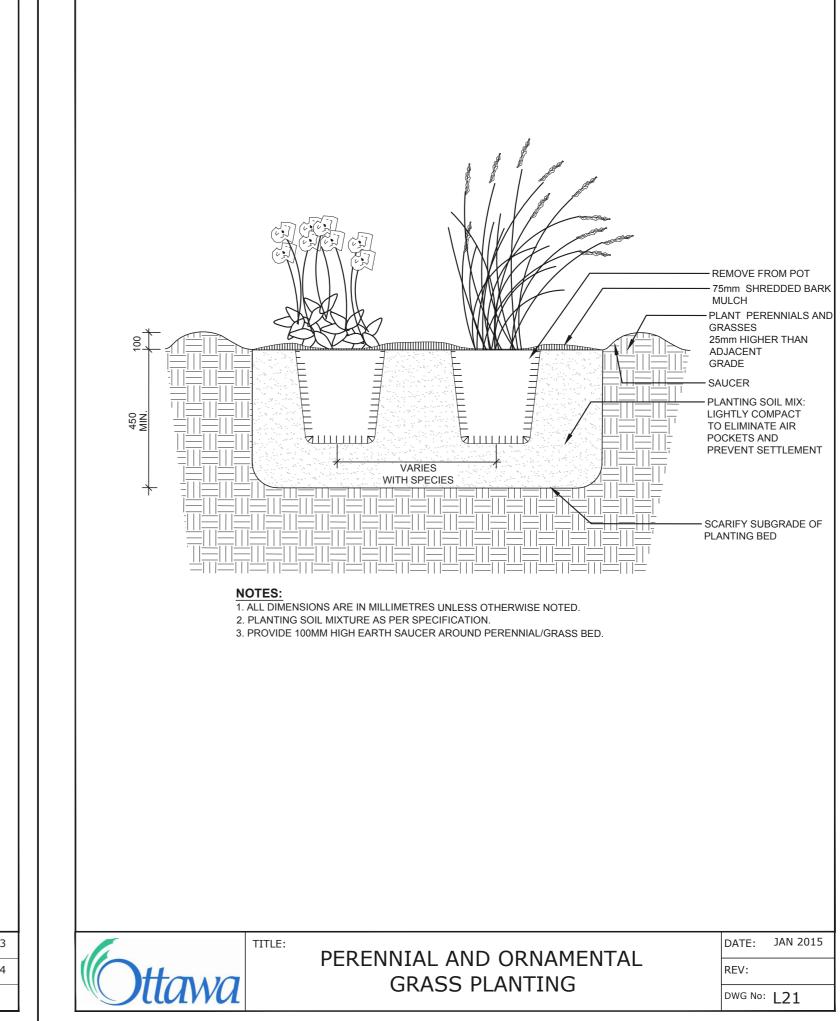

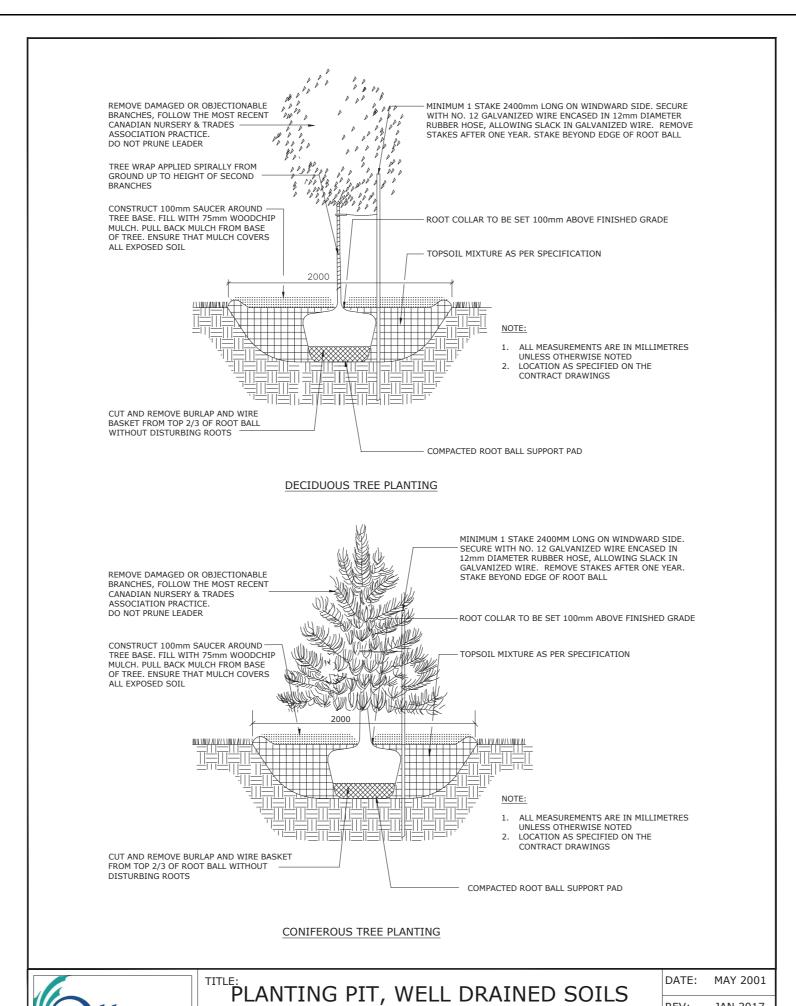


(ROAD ALLOWANCE)

REV: JAN 2017


DWG No: L3


RECOMMENDATIONS.

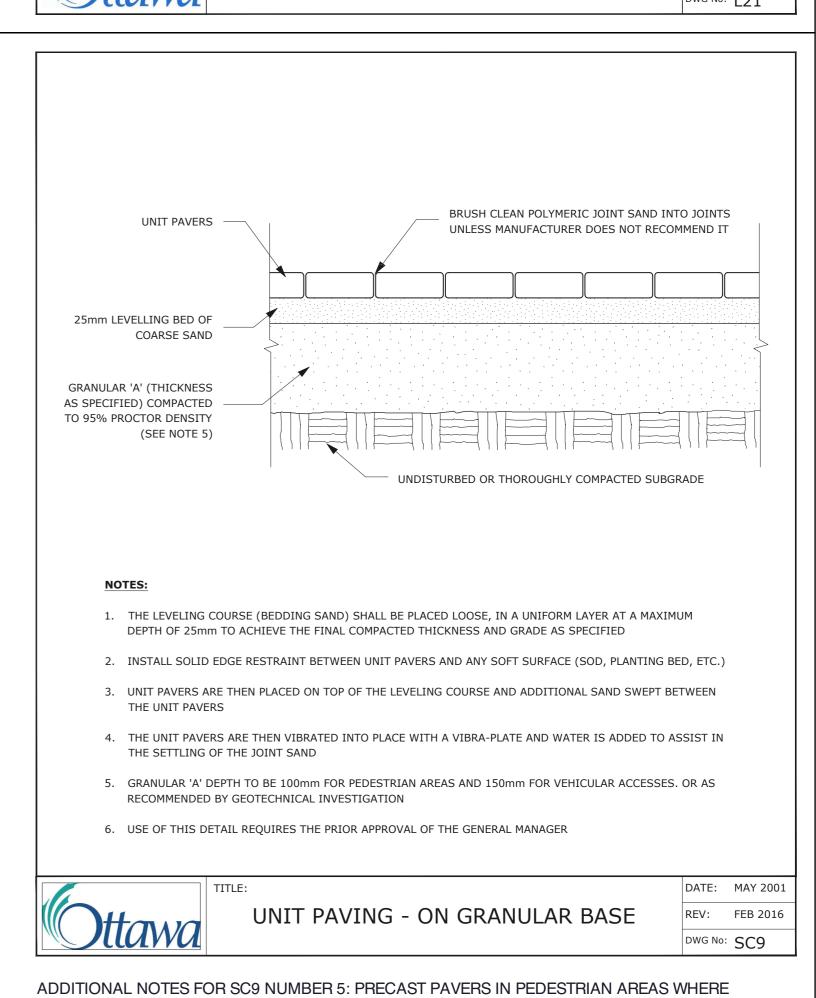

NORMAL SNOW REMOVALS ARE DONE IS TO RECEIVE A MINIMUM 200mm GRANULAR 'A'. FURTHER

ADJUSTMENTS TO BE SPECIFIED IN RELATION TO SITE CONDITIONS AND GEOTECHNICAL

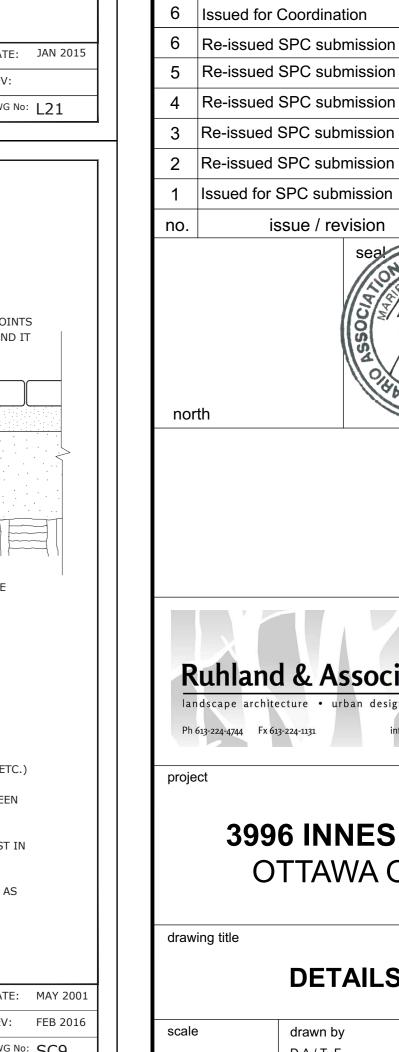

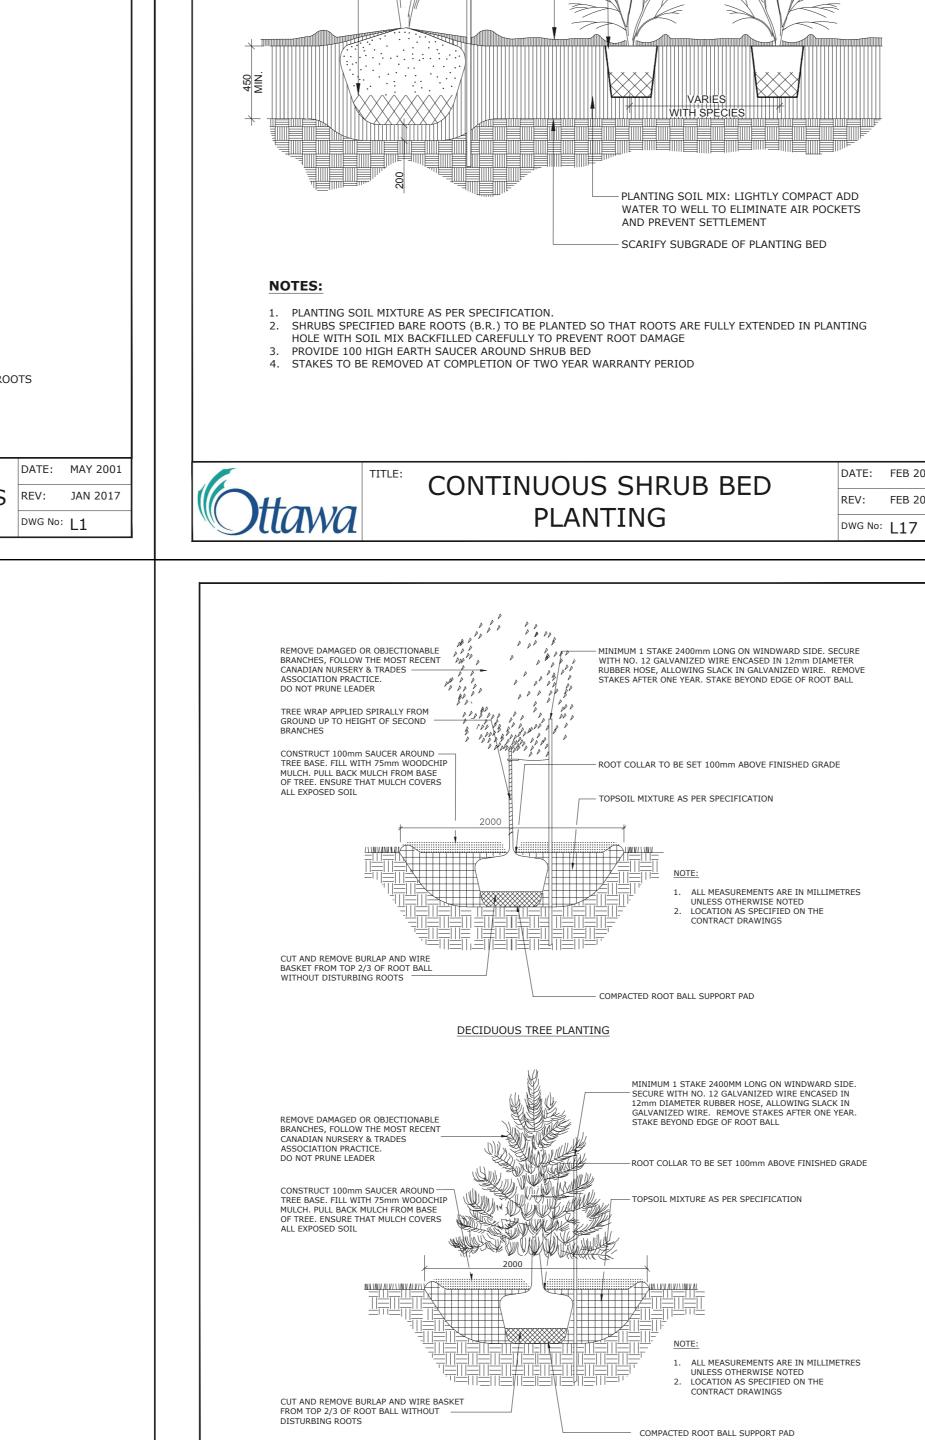

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.10 Reinstate all areas and items damaged as a result of

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issue / revision

date

2021/11/22

Ruhland & Associates Ltd

3996 INNES RD, OTTAWA ON

drawing title

DETAILS

drawn by designed by D.A / T. F M. Ruhland checked by M. Ruhland drawing number

Contractor to check and verify all dimensions on the job


City Plan Number 18675

1 METALLIC GUARD RAIL
L-03 Scale: NTS

REFER TO SITE PLAN FOR LOCATIONS

SECTION ALONG EAST PROPERTY LINE

2 SECTION Scale: NTS

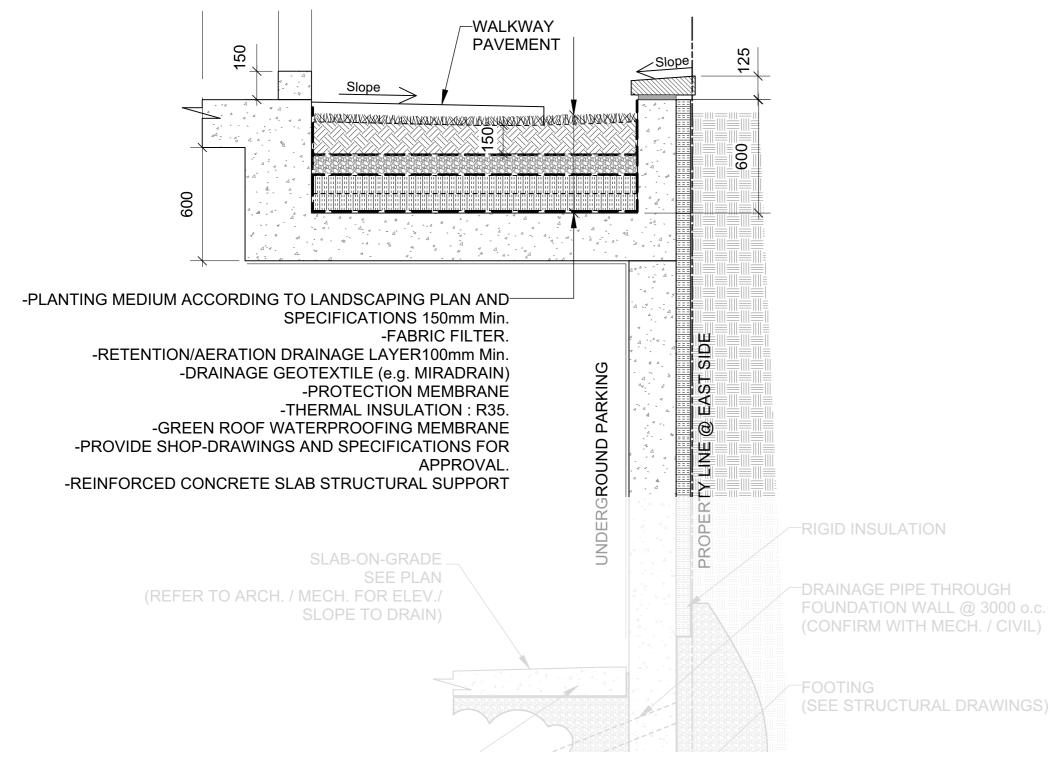




3 SKYLINE OUTDOOR PATIO HARD-TOP GAZEBO Canvas, w/ Bug Net, Black 10'x12'

- PROVIDE MOCKUP SAMPLE.



4 GLOBAL INDUSTRIAL 4' PARK BENCH Tan, w/Backrest

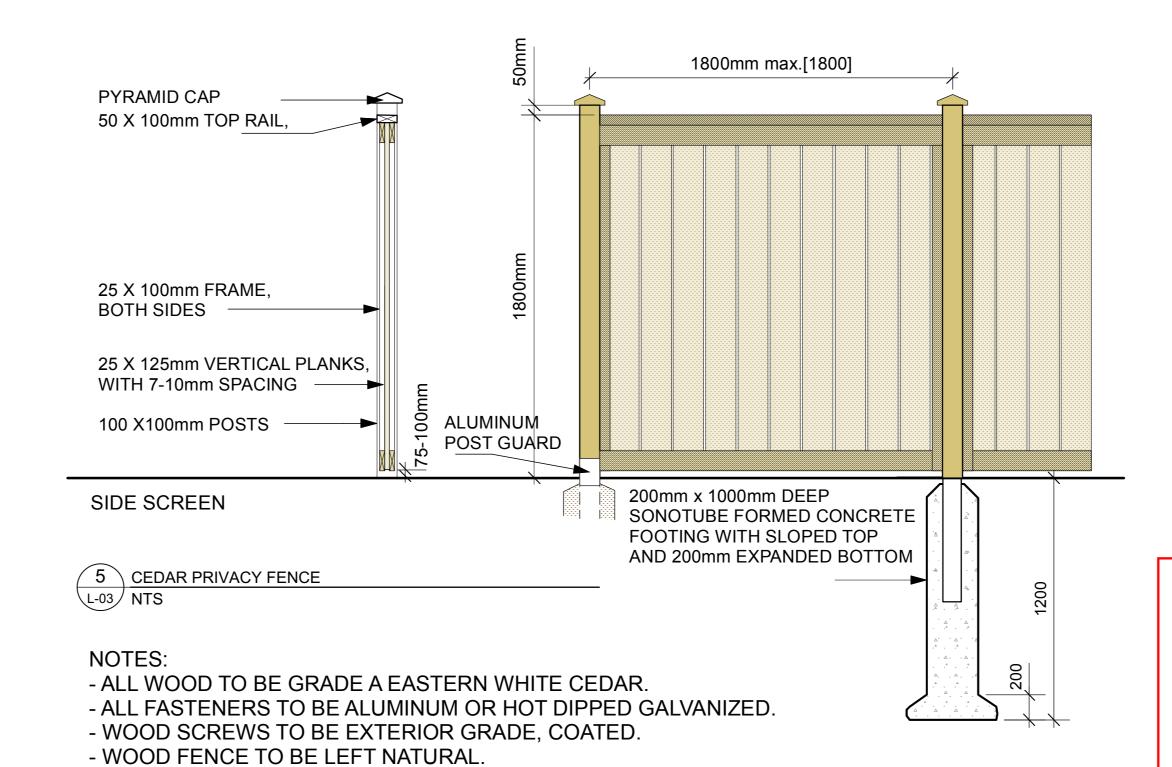

John Long

JOHN SEVIGNY C.E.T.

MANAGER (A), DEVELOPMENT REVIEW EAST
PLANNING, DEVELOPMENT & BUILDING SERVICES
DEPARTMENT, CITY OF OTTAWA

APPROVED

By sevignyjo at 4:05 pm, May 27, 2025

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Seal OF LANDS CO. MEMBER THE PROPERTY OF LANDS CO. MEMBER THE PROP

north

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scale	drawn by	designed by	
	D.A / T. F	M. Ruhland	
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