

SCALE 1:300



GENERAL NOTES:

- ALL PLANT MATERIAL SHALL BE NURSERY GROWN STOCK UNLESS OTHERWISE NOTED.
 - 2. TREES TO HAVE A MINIMUM 1800 CLEAR STEM ABOVE
 - 3. CONTRACTOR TO MAKE GOOD ALL EXISTING AREAS DAMAGED BY HIS WORK TO THE SATISFACTION OF THE CONTRACTOR.
- 4. ALL PLANT MATERIAL SHALL BE WARRANTIED FOR TWO YEARS FROM THE DATE OF SUBSTANTIAL COMPLETION.
- 5. CONTRACTOR TO VERIFY LOCATION OF ALL SERVICES PRIOR TO ANY EXCAVATION.

LANDSCAPE ARCHITECT.

6. ANY PROPOSED SUBSTITUTIONS OF PLANT SPECIES SHALL BE MADE WITH PLANTS OF EQUIVALENT OVERALL FORM, HEIGHT, BRANCHING HABIT, FLOWER, LEAF, COLOR, FRUIT AND CULTURE AND ONLY AFTER APPROVAL OF THE

	RANGE (III)	` ′				
LARGE (29)	135-250*	192				
MEDIUM (30)	35-135*	85		CANOPY (W.		
SMALL (11)	5-35*	20		OVERLAP): 4,837m ²		
CONIFER (3)	45-96*	70				
PROPOSED STREET TREE PROJECTED CANOPY						
PROPOSED STREET TREE CANOPY (BY OTHERS), m ² CALCULATION BASED ON PROPOSED TREE SPECIES PROJECTIONS				CANOPY (W. OVERLAP): 432m ²		
*RANGE OF CROWN AREAS	S IS IN ACCORDANCE WIT	TH PROPOSED TREES				
SPECIES				SITE: 14,522m ²		
**CROWN AREAS ARE ACC SIZE OF THE RESPECTIVE DETERMINED IN REFEREN BOTANICAL SOURCES, SU RESOURCES & FORESTRY TREES IN CANADA, UNIVER PUBLICATIONS	SPECIES. CANOPY SIZIN CE TO VARIOUS ARBORIO CH AS: ONTARIO MINISTF (OMNRF); US FOREST SE	G HAS BEEN CULTURAL AND RY OF NATURAL ERVICE; FARRAR, J.L.		TOTAL PERCENT COVER: 36.28%		

PROPOSED TREE CANOPY PROJECTIONS

STANDARD

TREE TYPE/SIZE

PER TREE USED

FOR CALC. (m²)

SITE CANOPY

COVER

Contractor shall check all dimensions on the work and report any discrepancy to the Landscape Architect before proceeding. All drawings and specifications are the property of the Landscape Architect and must be returned at the completion of the work. This drawing is not to be used for construction until signed by the Landscape Architect.


FENCING	PROPERTY LINE
	1.8m HT. WOOD PRIVACY FENCE
	- DECORATIVE FENCE
PLANTING	
	LARGE DECIDUOUS TREE
	MEDIUM DECIDUOUS TREE
	SMALL DECIDUOUS TREE
E TO THE TOTAL OF	CONIFEROUS TREE
\odot	TREE FORM SHRUB
	DECIDUOUS/CONIFEROUS SHRUB
6€	GRASSES/PERENNIALS
	SODDING
	PRECAST EDGER
STREETSCAPE - B	OTHERS
	ORIGINAL STREET TREE LOCATION
PAVING	REVISED STREET TREE LOCATION (TOTAL QUANTITY/SPECIES TO REMAIN UNCHANGE)
	CIP CONCRETE PAVING
	RIVERSTONE PAVING
	UNIT PAVING
PLANTING KEY	
XX	— TREE SPECIES
00	— QUANTITY
XX	— SHRUB SPCIES
00	— QUANTITY
DETAIL KEY	

6	Issued for Third Submission	25-05-15		
5	Issued for Second Submission	25-04-15		
4	Issued for Coordination	25-03-13		
3	Issued for Revised First Submission	25-01-24		
2	Issued for First Submission	24-10-30		
1	Issued for Client Review	24-10-25		
No.	Description	Date		
Revi	Revision			

City Approval Stamp

PROPERTY INFORMATION
BLOCK 167 REGISTERED PLAN 4M-1728



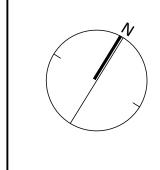



1285 WELLINGTON STREET, OTTAWA, ON K1Y 3A8 CANADA T 613.237.2345 NAKDESIGNSTRATEGIES.COM


955 BORBRIDGE AVENUE OTTAWA, ON

LANDSCAPE SITE PLAN

Date 2024-10-09 Scale 1:300 Drawn SW Checked MK

Job No. 24-251

L1.0

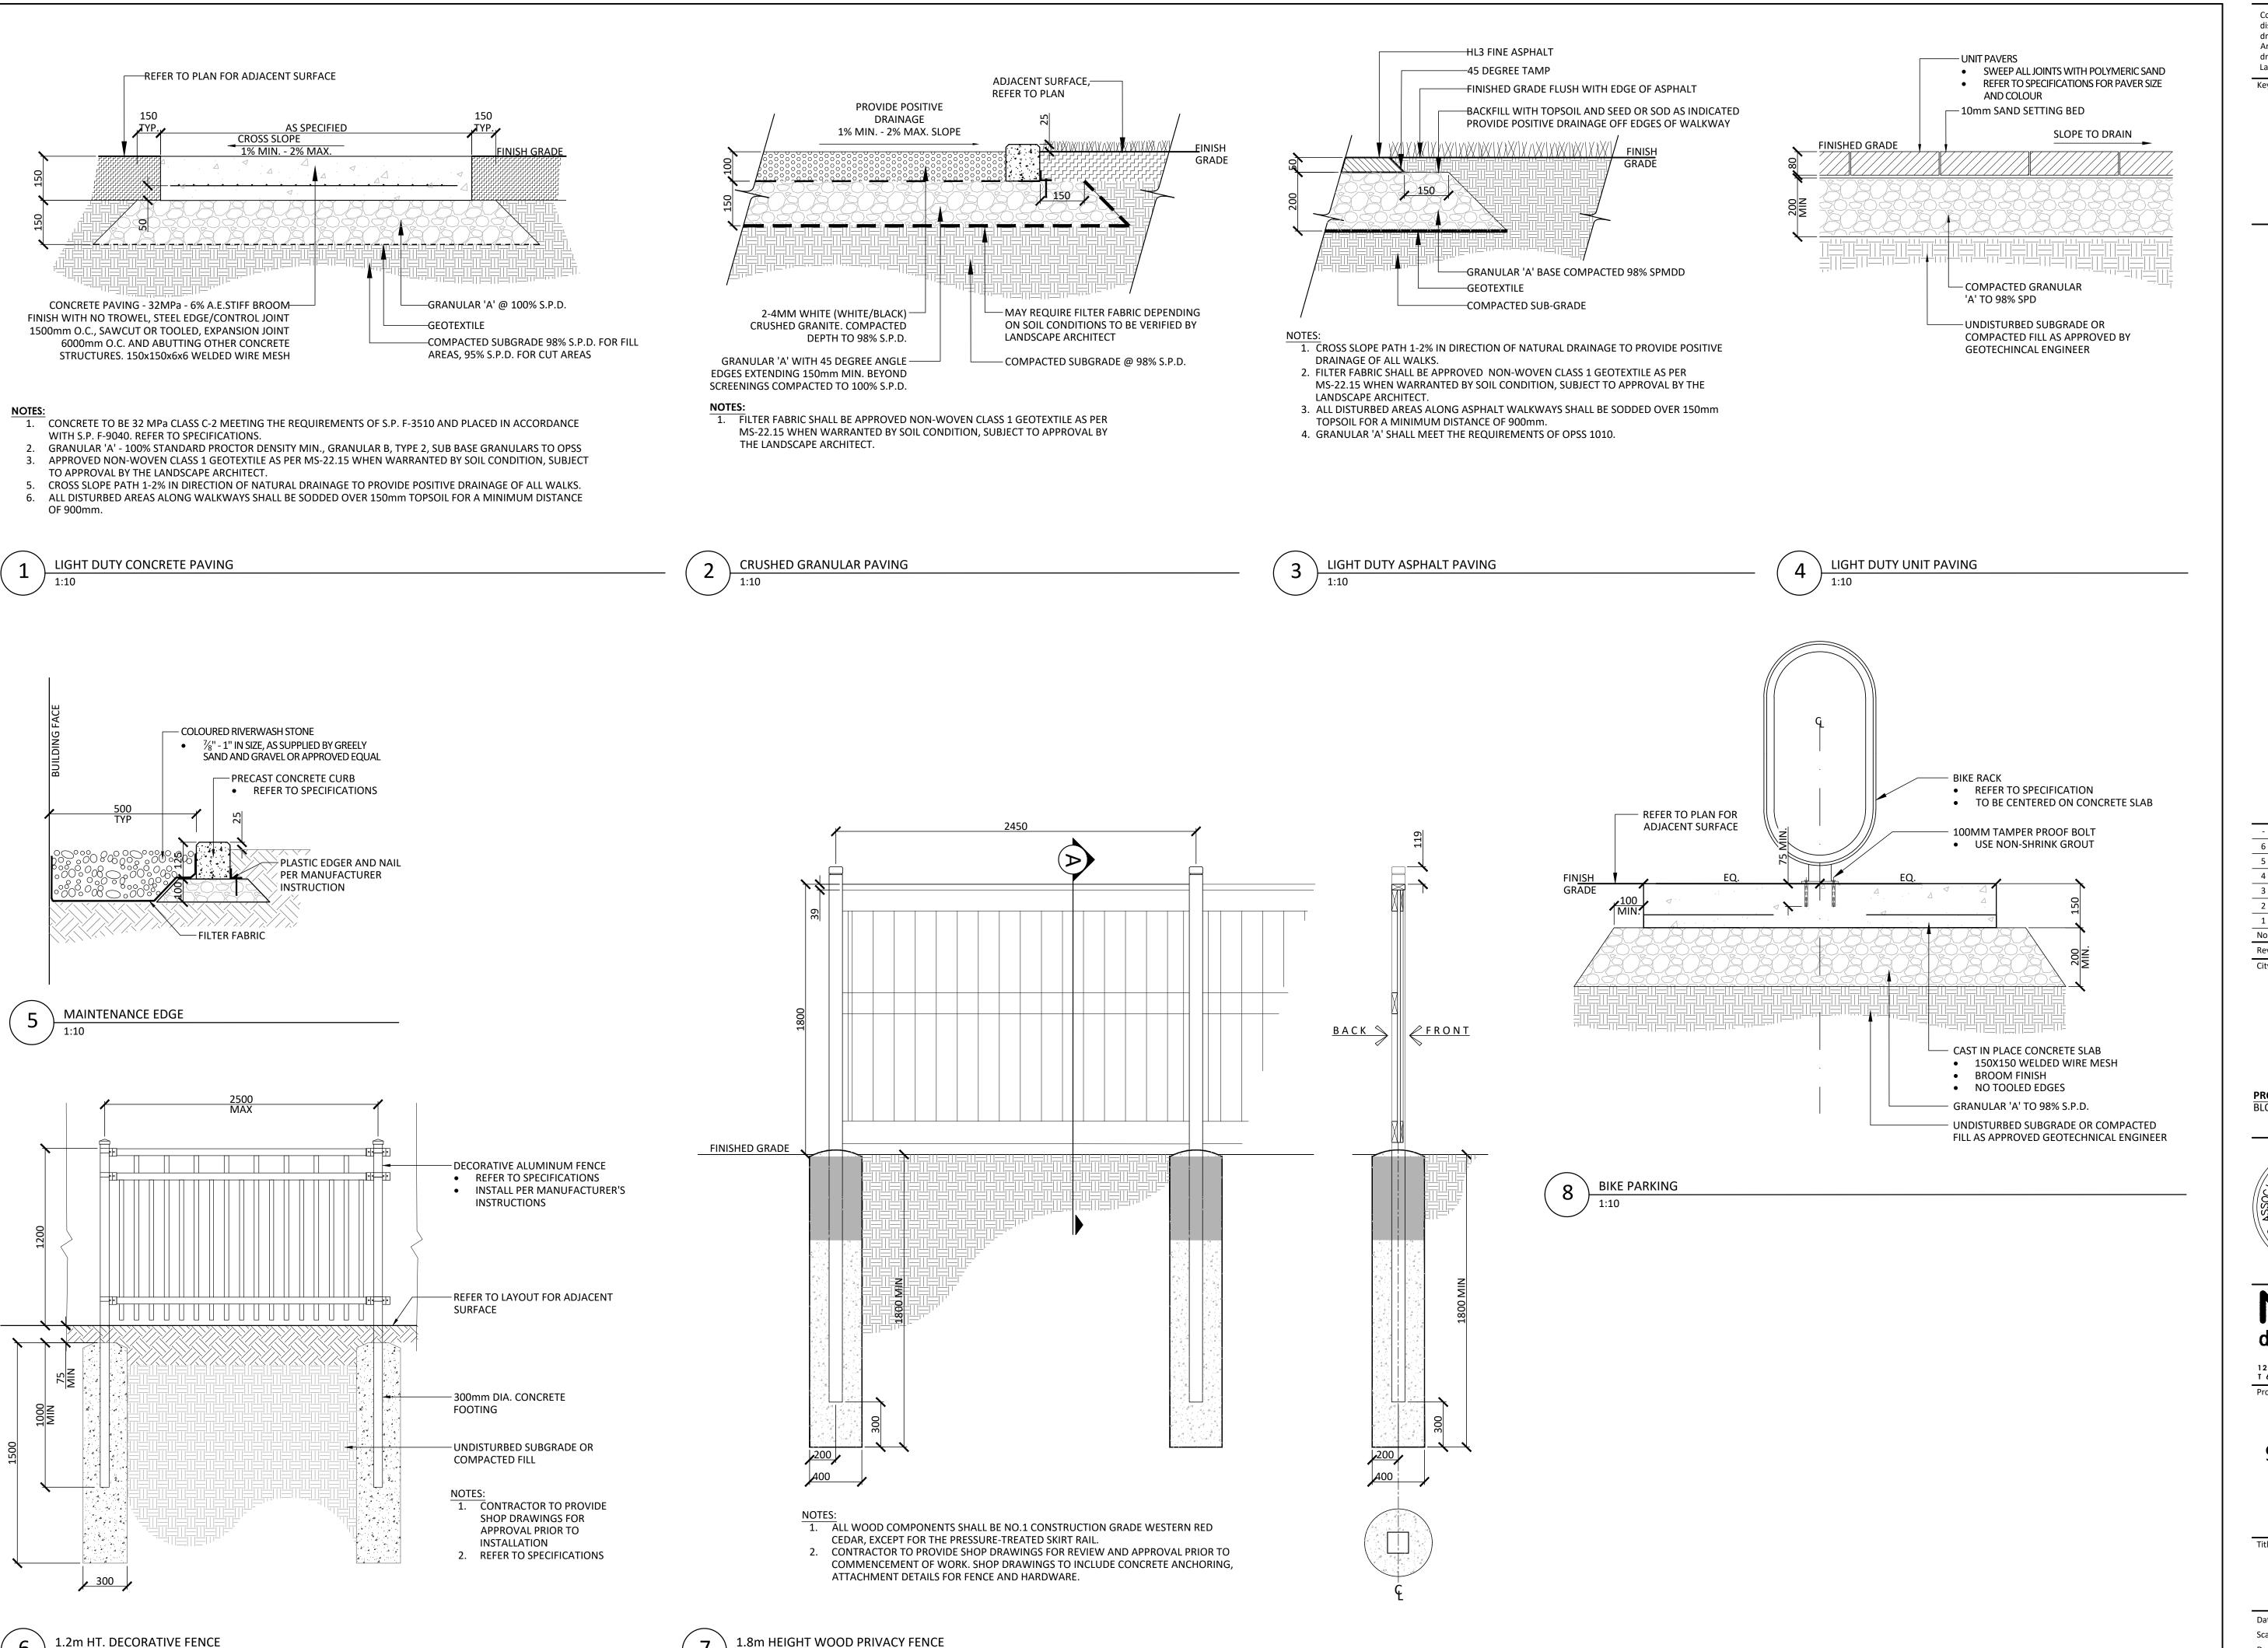

Contractor shall check all dimensions on the work and report any discrepancy to the Landscape Architect before proceeding. All drawings and specifications are the property of the Landscape Architect and must be returned at the completion of the work. This drawing is not to be used for construction until signed by the Landscape Architect.

Key Plan

-		
6	Issued for Third Submission	25-05-15
5	Issued for Second Submission	25-04-15
4	Issued for Coordination	25-03-13
3	Issued for Revised First Submission	25-01-24
2	Issued for First Submission	24-10-30
1	Issued for Client Review	24-10-25
No.	Description	Date
Revi	sion	

City Approval Stamp

PROPERTY INFORMATION BLOCK 167 REGISTERED PLAN 4M-1728



design strategies

1285 WELLINGTON STREET, OTTAWA, ON K1Y 3A8 CANADA T 613.237.2345 NAKDESIGNSTRATEGIES.COM


955 BORBRIDGE AVENUE OTTAWA, ON

LANDSCAPE DETAILS

Date 2024-10-09 Scale AS NOTED Drawn SW Checked MK

Job No. 24-251


L2.0

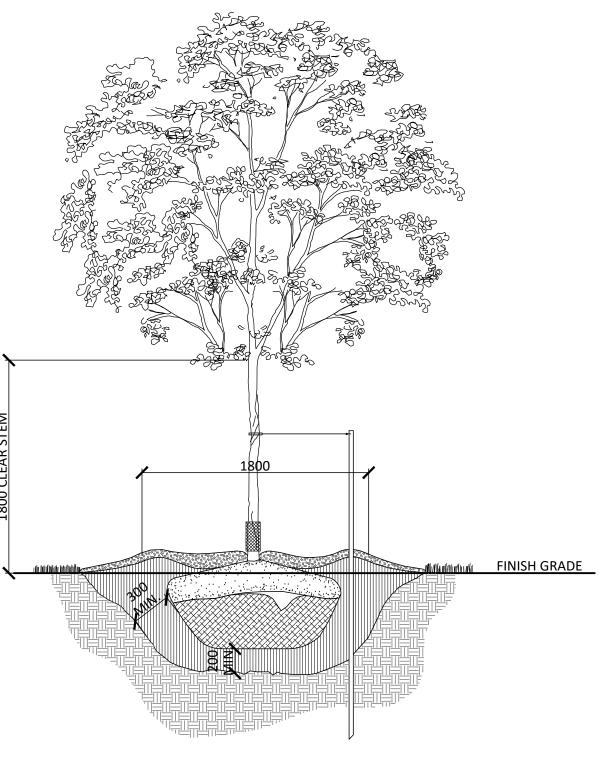


1. REMOVE STAKE AFTER ONE YEAR OR UNTIL TAKEOVER, UNLESS OTHERWISE DIRECTED BY THE LANDSCAPE

- ARCHITECT. 2. TOPSOIL MIXTURE AND SHREDDED MULCH AS PER SPECIFICATION
- 3. REMOVE TREE WRAP AFTER PLANTING 4. CALIPER TO BE MEASURED AT THE BASE OF TREE AT ROOT BALL.
- DECIDUOUS TREE PLANTING (ONE STAKE W/ARBOR TIES)

TREE FORM SHRUB PLANTING

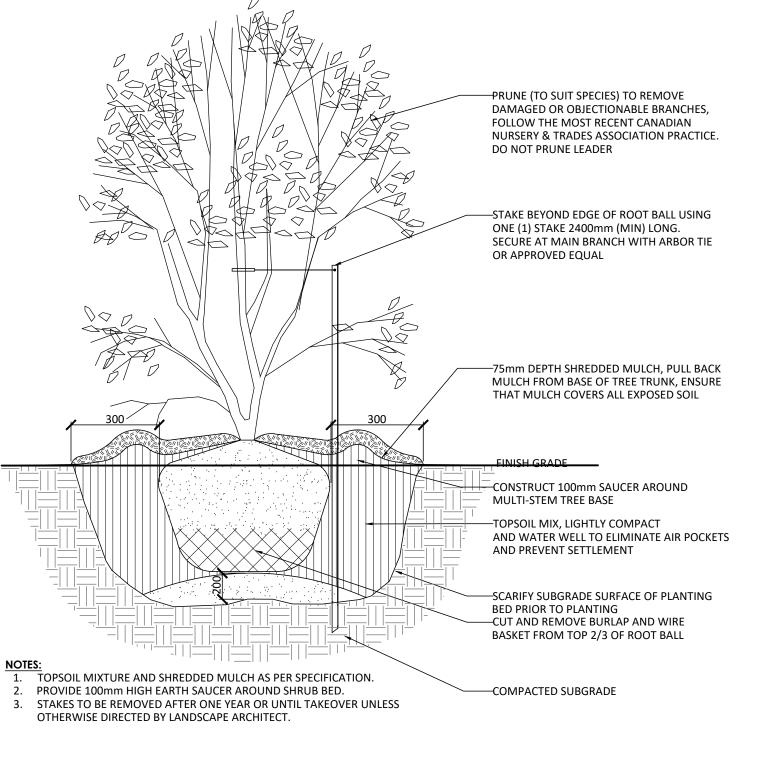


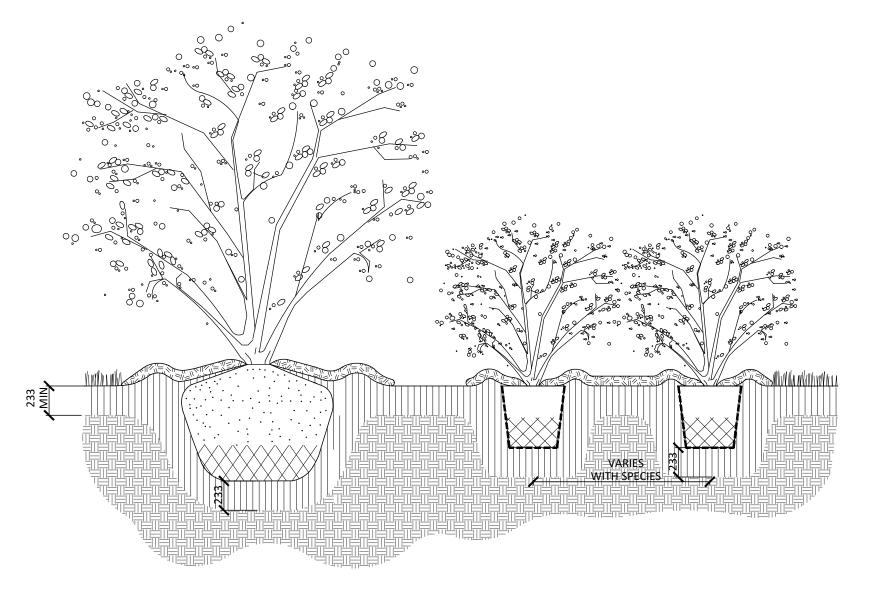

TOPSOIL MIXTURE AND SHREDDED MULCH AS PER SPECIFICATION.
 SHRUBS SPECIFIED TO BE PLANTED SO THAT ROOTS ARE FULLY EXTENDED IN PLANTING HOLE WITH SOIL MIX BACKFILLED CAREFULLY TO PREVENT ROOT DAMAGE.
 PROVIDE 100mm HIGH EARTH SAUCER AROUND SHRUB BED.



PERENNIAL AND ORNAMENTAL GRASS PLANTING

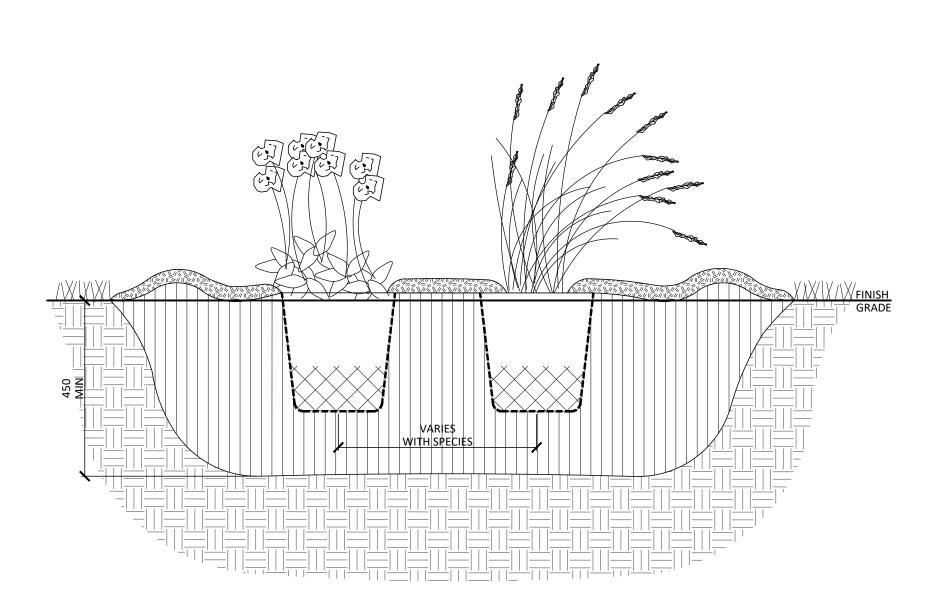

TOPSOIL MIXTURE AND SHREDDED MULCH AS PER SPECIFICATION.
 PROVIDE 100mm HIGH EARTH SAUCER AROUND PERENNIAL/GRASS BED.

-		
6	Issued for Third Submission	25-05-15
5	Issued for Second Submission	25-04-15
4	Issued for Coordination	25-03-13
3	Issued for Revised First Submission	25-01-24
2	Issued for First Submission	24-10-30
1	Issued for Client Review	24-10-25

Contractor shall check all dimensions on the work and report any discrepancy to the Landscape Architect before proceeding. All drawings and specifications are the property of the Landscape Architect and must be returned at the completion of the work. This

drawing is not to be used for construction until signed by the Landscape Architect.

No. Description
Revision City Approval Stamp

> PROPERTY INFORMATION BLOCK 167 REGISTERED PLAN 4M-1728



design strategies

1285 WELLINGTON STREET, OTTAWA, ON K1Y 3A8 CANADA T 613.237.2345 NAKDESIGNSTRATEGIES.COM

955 BORBRIDGE AVENUE OTTAWA, ON

LANDSCAPE DETAILS

Date 2024-10-09 Scale AS NOTED Drawn SW Checked MK Job No. 24-251