

1 BASEMENT FLOOR PLAN - SPC
A.120 1:125

GENERAL NOTES - CONSTRUCTION PLAN


- INTERIOR FINISHES (INCLUDING FLOORS AND BASEBOARDS): REFER TO FINISH PLANS FOR DETAILS OF COMPOSITION
- PROVIDE NAILERS ON ALL WALLS TO RECEIVE BUILT-IN FURNITURE, SHELVING, SCREENS, ETC.
- UNLESS NOTED OTHERWISE, ALL DIMENSIONS ARE TAKEN FROM FACE OF STUDS AND CENTER OF DOORS AND WINDOWS. REQUIRED CLEARANCES WILL BE DIMENSIONED AND SHOWN TO FACE OF WALL OR DOOR OPENING
- SEE A800 FOR DOOR SCHEDULE
- UNLESS OTHERWISE INDICATED, ALL EQUIPMENT IS PROVIDED AND INSTALLED BY THE CONTRACTOR. THE CONTRACTOR MUST COORDINATE AND PROVIDE THE SERVICES REQUIRED TO POWER THE EQUIPMENT.
- FILL ALL GAPS AND JOINTS WITH ACOUSTIC INSULATION AND SEAL WITH ACOUSTIC CAULKING WHEN ACOUSTIC PERFORMANCE IS REQUIRED.
- COORDINATE WALL OPENINGS WITH MECHANICAL (SEE MECHANICAL DRAWINGS).
- PLYWOOD PANELS USED AS NAILERS IN THE ELECTRICAL ROOMS MUST BE FIRE-TREATED.
- PROVIDE ROD AND SHELF TYP. FOR ALL CLOSETS AS SHOWN.
- ALL WINDOW AND DOOR DIMENSIONS ARE TO ROUGH STUD OPENING.
- ALL OUTSIDE DIMENSIONS ARE TO OUTSIDE FACE OF STUD SHEATHING.
- REFER TO STRUCTURAL DRAWINGS FOR BEAMS, LINTELS, POSTS, FLOOR, AND ROOF FRAMING.
- ALL ELECTRICAL AND MECHANICAL ITEMS SHOWN ON DRAWINGS ARE FOR LOCATION PROPOSED ONLY. COORDINATE WITH M&E DRAWINGS.
- CAULK AND SEAL AT ALL MECHANICAL AND ELECTRICAL PENETRATIONS.
- PROVIDE FIRE STOPPING FOR MECHANICAL AND ELECTRICAL PENETRATIONS THROUGH FIRE-RATED ASSEMBLIES. INFILL ANY UNUSED PENETRATIONS WITH FIRE-STOPPING TO SUIT ASSEMBLY.
- REFER TO RCP PLANS FOR BULKHEAD LOCATIONS AND DEPTHS.
- FURNITURE SHOWN FOR REFERENCE PURPOSE ONLY.
- ALL ELECTRICAL CONTROL HEIGHTS WITHIN BARRIER-FREE UNITS AND PATHS OF TRAVEL THROUGHOUT THE BUILDING TO COMPLY WITH CSA B-851
- PROVIDE SOUNDPROOF FIBERGLASS BATT IN ALL PARTITIONS WITH SUPPLY PIPES, SANITARY DRAIN OR RAINWATER LEADERS. COORDINATE WITH MECH.
- UNIT NAME: "XBD-BF" INDICATES BARRIER-FREE REQUIREMENTS AS PER CAN/CSA NATIONAL STANDARD OF CANADA, AND ACTION OTTAWA'S ACCESSIBLE UNIT REQUIREMENTS.

GENERAL NOTES - PARTITIONS

- UNLESS INDICATED OTHERWISE, ALL NEW GYPSUM PARTITIONS ARE WOOD-FRAMED. REFER TO WALL TAGS FOR DETAILS OF COMPOSITION.
- PARTITIONS CONTINUING TO THE SLAB MUST BLEND PERFECTLY WITH ITS GEOMETRY TO ENSURE THAT THE FULL PERIMETER IS CAULKED TO MEET THE REQUIRED U/LC FIRE RESISTANCE AND/OR TO ENSURE THE REQUIRED ACOUSTIC PERFORMANCE.
- UNLESS NOTED OTHERWISE, DOOR FRAMES ARE INSTALLED 4" FROM THE ADJACENT WALL.
- WATER-REPELLENT GYPSUM PANELS ARE REQUIRED IN ROOMS WITH WATER OR MOISTURE EXPOSURE (BATHROOMS, JANITOR'S LODGE, KITCHENS WALL ABOVE MILLWORK, ETC.).
- CONTRACTION JOINTS ON GYPSUM PANELS TO BE USED AT MAXIMUM 9,100mm (30'-0").
- WALLS TO RECEIVE TILE FINISH MUST BE PROVIDED WITH FIBERBOARD BACKING WITHOUT COMPROMISING THE FIRE RESISTANCE RATING WHERE REQUIRED.

LEGEND - CONSTRUCTION PLAN

	NEW WALL
	WALL TYPE
	NUMBER OF WALL TYPE FIRE RATING
	0h = FIRE SEPARATION WITHOUT RATING 45 min. = FIRE RESISTANCE RATING OF 45 MIN. 1h = FIRE RESISTANCE RATING OF 1h
	NUMBER AND CEILING HEIGHT
	ROOF TYPE
	NUMBER AND ROOM NAME
	WINDOW NUMBER
	REVISION NUMBER
	CENTRE LINE

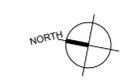

No.	Date	Issued for
1	04/04/2025	SITE PLAN CONTROL

Architecte Paysagiste/Landscape Architect

NAK design strategies

Ingenieur / Engineer (Civil / Civil)

Stantec

Ingenieur / Engineer (Mécanique & Électrique / Mechanical & Electrical)

Smith + Andersen

Ingenieur / Engineer (Structure / Structure)

D+M STRUCTURAL ENGINEERING

Client / Client

Centretown Citizens Ottawa Corporation

Architecte / Architect

Collectif d'architectes

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Ontario Association of Architects

ROBERTO CRAMPOS
LICENCE 7401

Note:
L'entrepreneur doit vérifier toutes les dimensions et informations sur le site et aviser immédiatement l'architecte de toutes erreurs ou omissions.
Contractor shall verify all information and dimensions on site and immediately report any errors or omissions to the architect.

Project / Project

6 STOREY APARTMENT BUILDING

240 PRESLAND ROAD

Title / Titre

BASEMENT

Dessiné par / Drawn by: GM
No. projet / Project number: 2424

Vérifié par / Verified by: ZK
No. dessin / Drawing number: [blank]

Echelle / Scale: As indicated

Date de création du dessin / Drawing creation date: 04/04/25

Revision / Revision: 1

A.120

GENERAL NOTES - CONSTRUCTION PLAN

- INTERIOR FINISHES (INCLUDING FLOORS AND BASEBOARDS); REFER TO FINISH PLANS FOR DETAILS OF COMPOSITION
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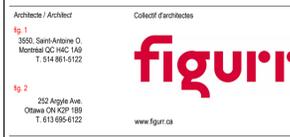
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	WINDOW NUMBER
	REVISION NUMBER
	CENTRE LINE

No.	Date	Émis pour / Object
1	04/04/2025	SITE PLAN CONTROL



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Project / Projet
6 STOREY APARTMENT BUILDING

240 PRESLAND ROAD

Title / Titre
LEVEL 1

Dessiné par / Drawn by
GM

No. projet / Project number
2424


Vérifié par / Verified by
ZK

No. dessin / Drawing number
A.121


Échelle / Scale
As indicated


Date de création du dessin / Drawing creation date
04/04/25

A.121

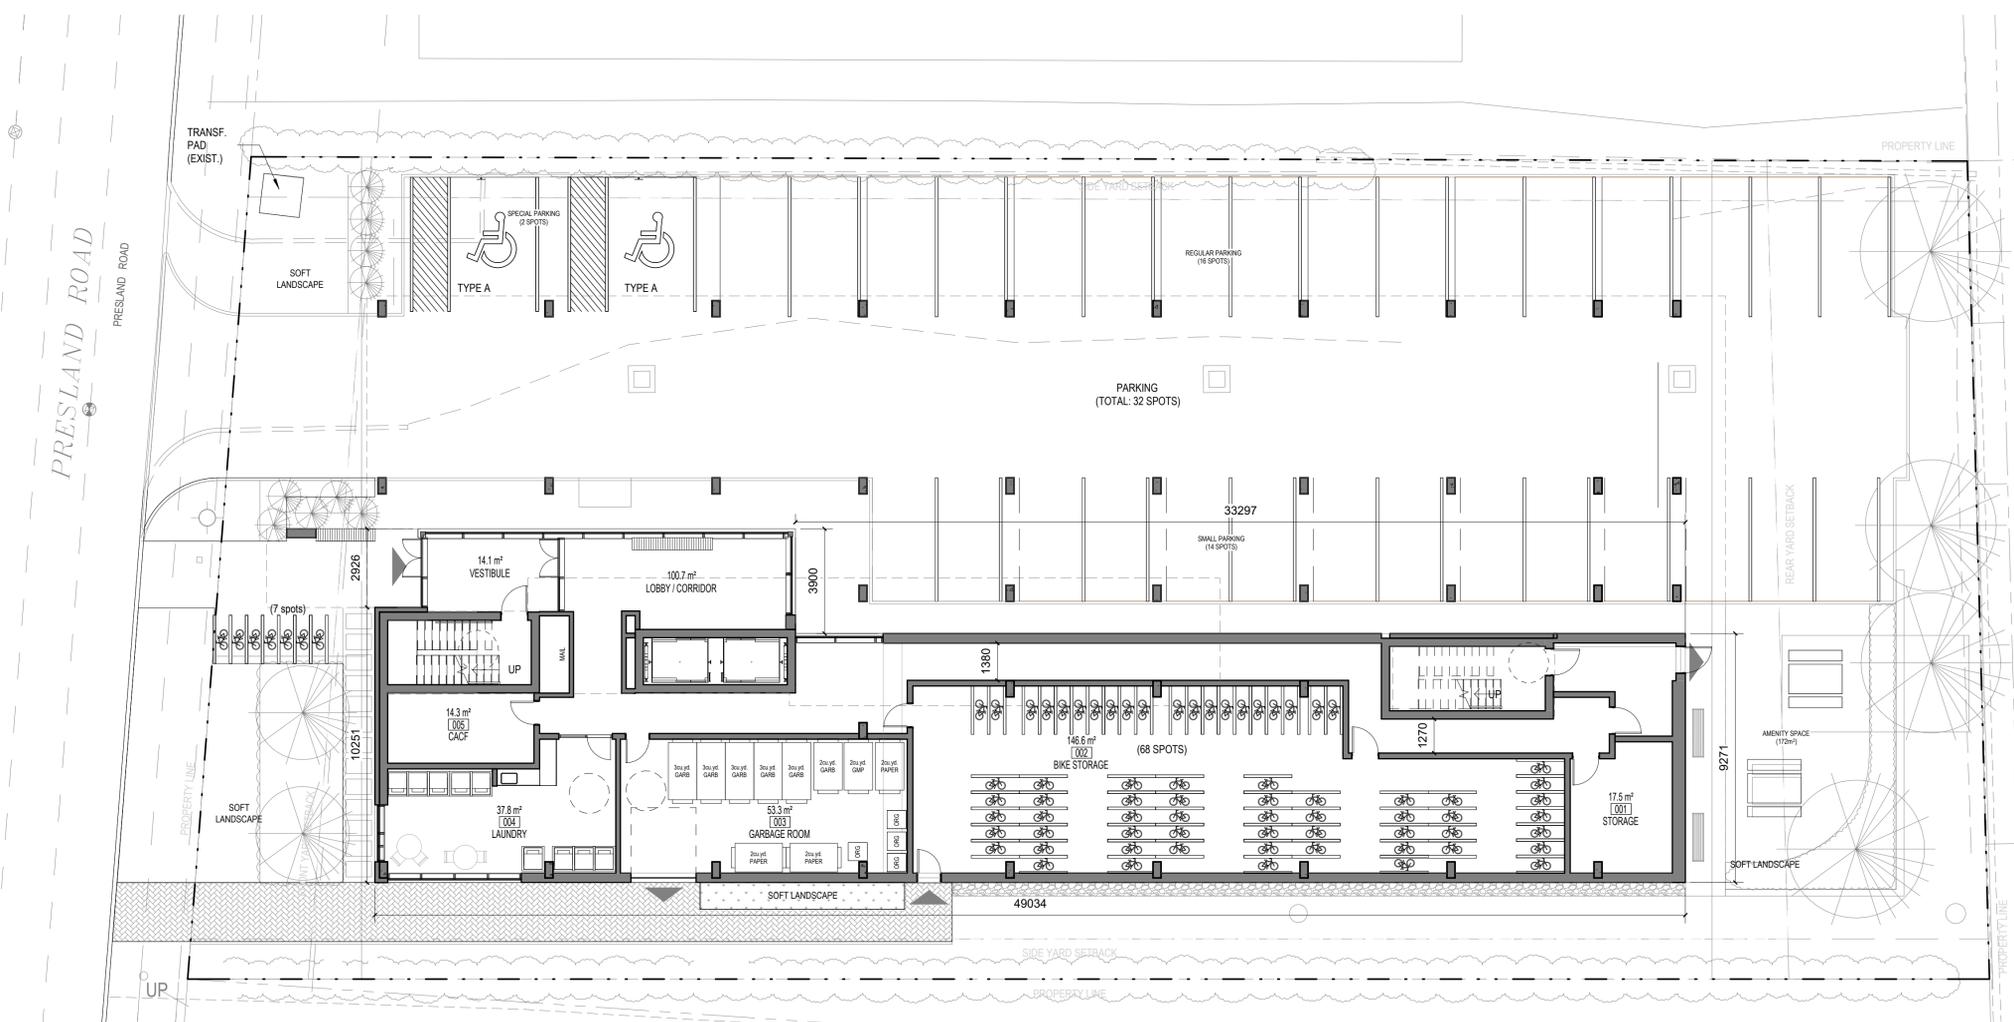

1 LEVEL 1 FLOOR PLAN - SPC
A.121 1:125

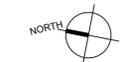

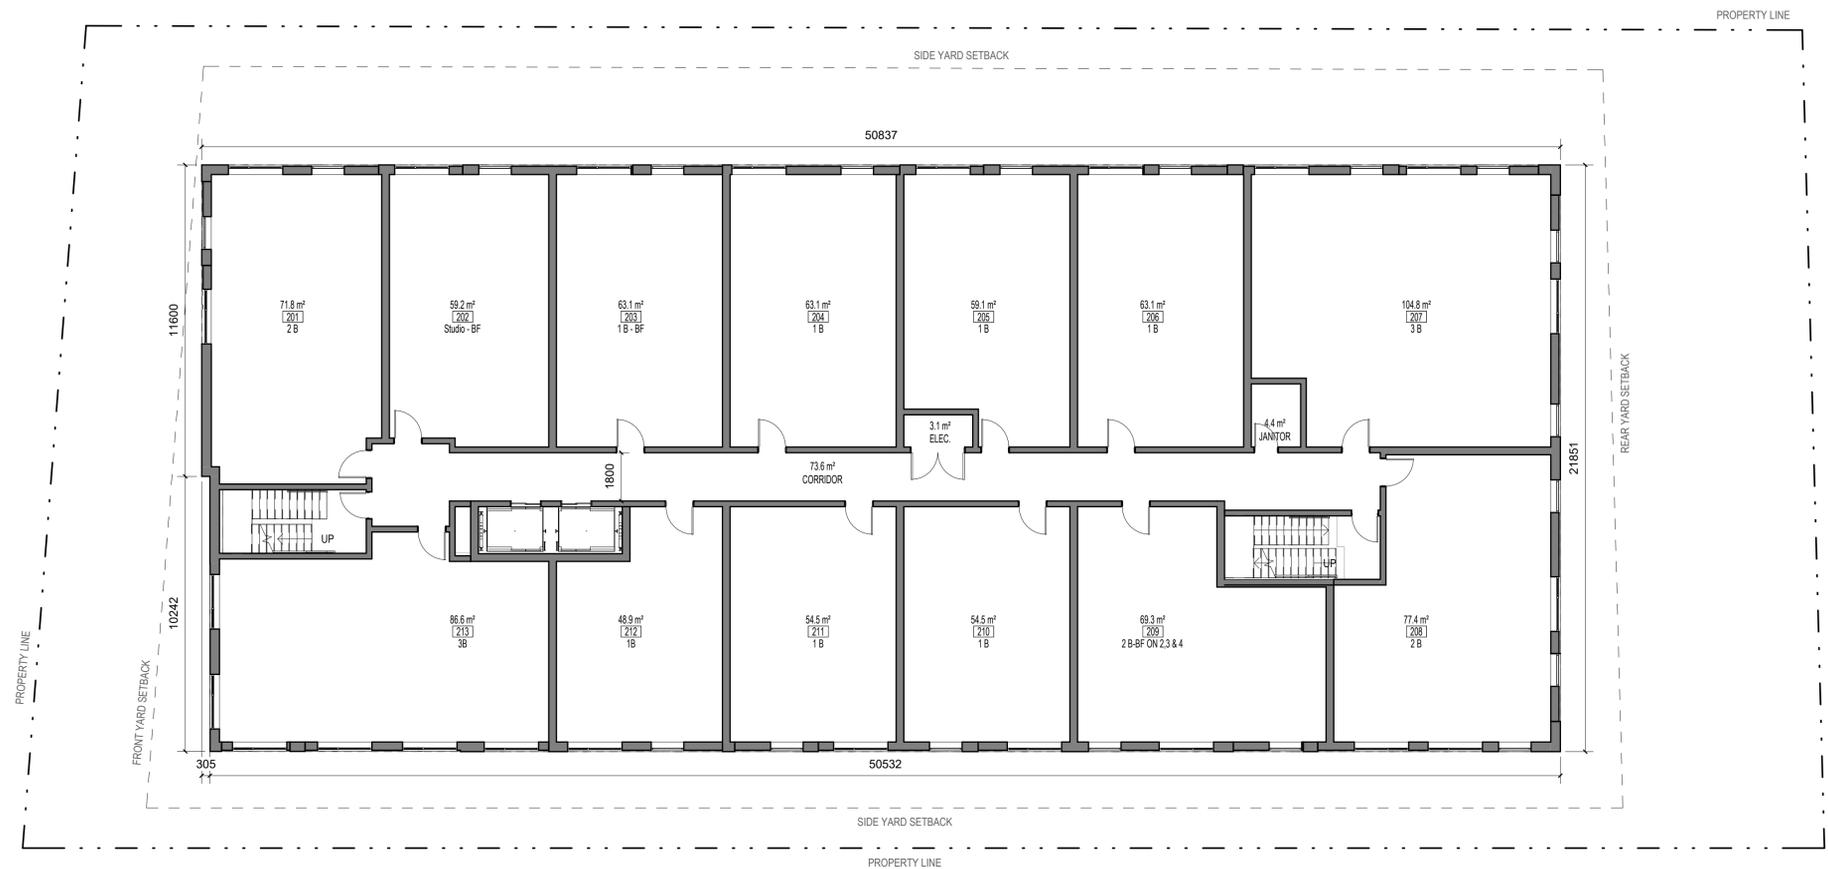

1 LEVELS 2 & 3 FLOOR PLAN (TYP.) - SPCL
A.122 1:125

GENERAL NOTES - CONSTRUCTION PLAN


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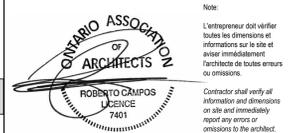
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	REVISION NUMBER
	CENTRE LINE



No. Date Issued for
1 04/04/2025 SITE PLAN CONTROL



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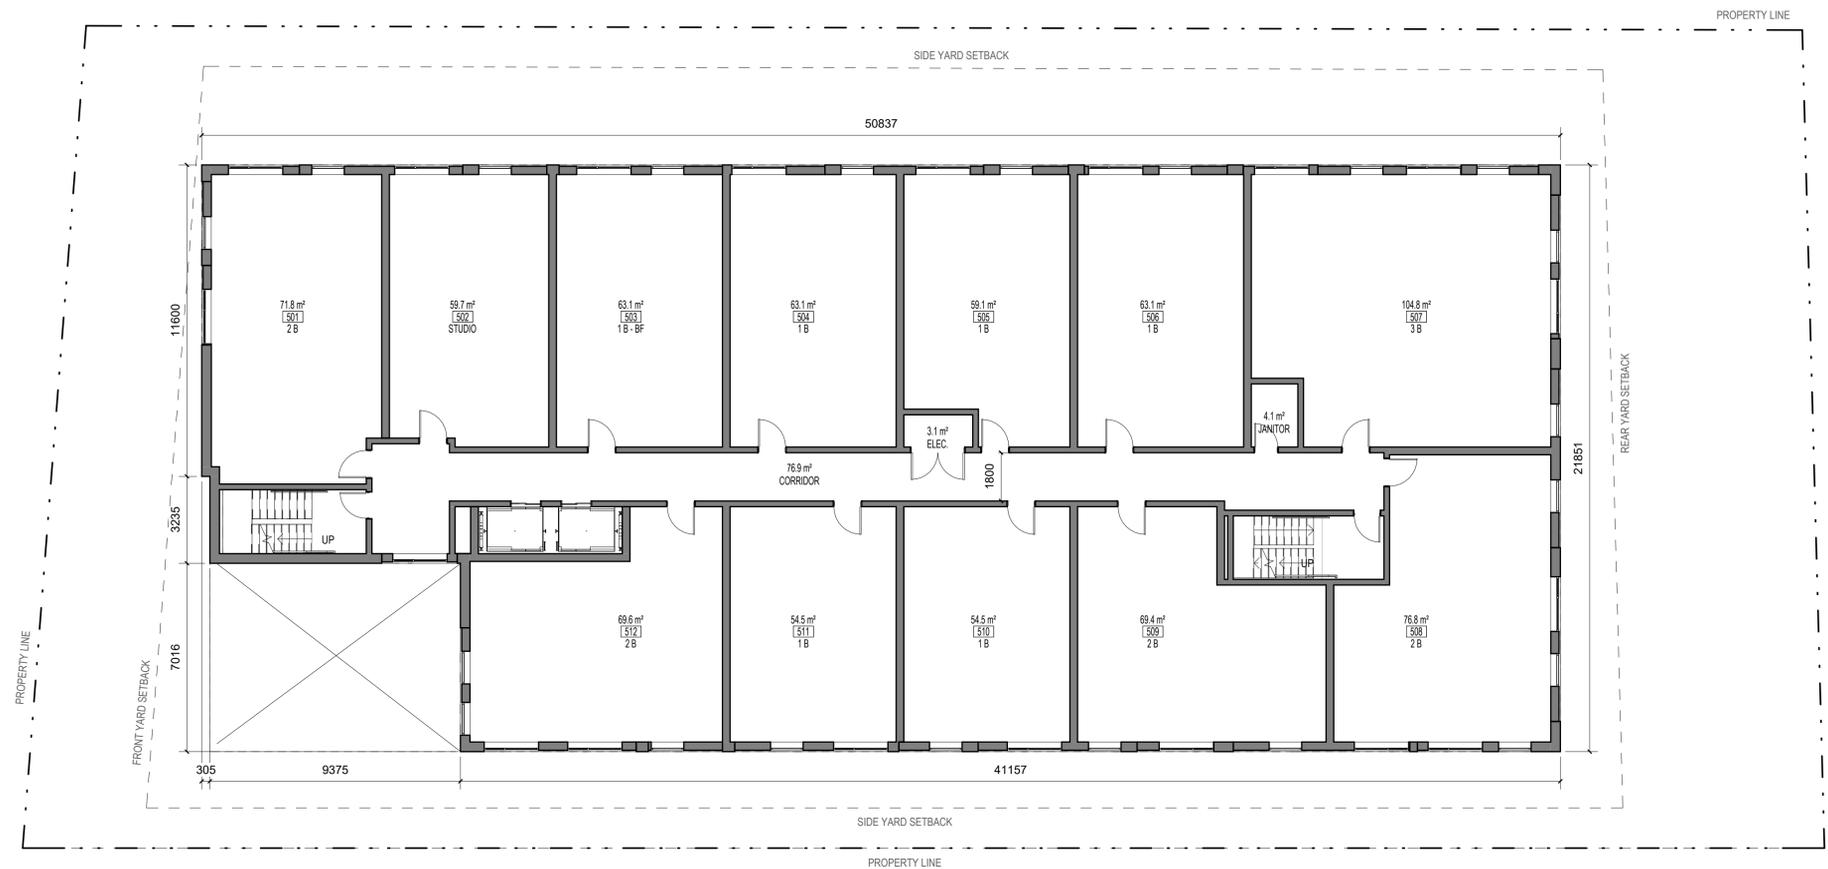


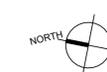Project / Project
6 STOREY APARTMENT BUILDING

240 PRESLAND ROAD
Title / Title
LEVELS 2 & 3 (TYP.)

Dessiné par / Drawn by: GM
No. projet / Project number: 2424
Vérifié par / Verified by: ZK
No. dessin / Drawing number: [blank]
Echelle / Scale: As indicated
Date de création du dessin / Drawing creation date: 04/04/25

A.122



1
A.124
LEVELS 5 & 6 FLOOR PLAN (TYP.) - SPCL
1:125

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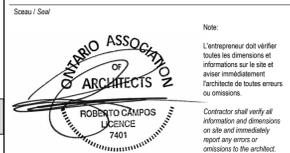
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Architect / Architect
3550, Saint-Antoine O.
Montreal QC H4C 1M6
T. 514 861-6122



Project / Project
6 STOREY APARTMENT BUILDING

240 PRESLAND ROAD
Title / Title
LEVELS 5 & 6 (TYP.)

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Date de création du dessin / Drawing creation date
04/04/25
Revision / Revision
1
A.124

GENERAL NOTES

- ALL WINDOW AND DOOR DIMENSIONS ARE TO ROUGH STUD/MASONRY OPENING
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- ALL ELECTRICAL AND MECHANICAL ITEMS SHOWN ON DRAWINGS FOR LOCATIONS ONLY. COORD. w/ MECH. & ELEC. DRAWINGS.
- CAULK AND SEAL AT ALL MECHANICAL AND ELECTRICAL PENETRATIONS.
- PROVIDE FIRE-STOPPING FOR ALL MECHANICAL AND ELECTRICAL PENETRATIONS THROUGH FIRE-RATED ASSEMBLIES. INFILL ANY UNUSED PENETRATIONS WITH FIRESTOPPING TO SUIT ASSEMBLY.
- VERIFY ALL DOOR AND WINDOW SIZES PRIOR TO FRAMING OF OPENINGS
- SOILS CONSULTANT TO REVIEW AND VERIFY SOILS CONDITIONS PRIOR TO POURING FOOTINGS.
- BACKFILL MATERIAL TO BE APPROVED. CLEAR SAND TO MEET REQUIREMENTS OF A DRAINAGE LAYER
- REFER TO RCP FOR BULKHEAD LOCATIONS AND DEPTHS.
- SEE WINDOW SCHEDULE FOR TYPICAL WINDOW TIE-IN DETAILS.
- FURNITURE SHOWN FOR REFERENCE PURPOSES ONLY.
- PROVIDE PREFINISHED TRANSITION STRIPS AT JOINTS OF DISSIMILAR MATERIALS.
- ALL ELECTRICAL CONTROL HEIGHTS WITHIN BARRIER-FREE PATH OF TRAVEL AREAS THROUGHOUT THE BUILDING AND UNITS TO COMPLY WITH OBC 3.8.1.5
- REFER TO CIVIL & MECHANICAL DRAWINGS FOR WEEPING TILE DRAINAGE CONNECTIONS
- PROVIDE SOUNDPROOF FIBERGLASS MATS IN ALL PARTITIONS WITH SUPPLY PIPES, SANITARY DRAIN OR RAINWATER LEADERS. COORD. w/ MECH.
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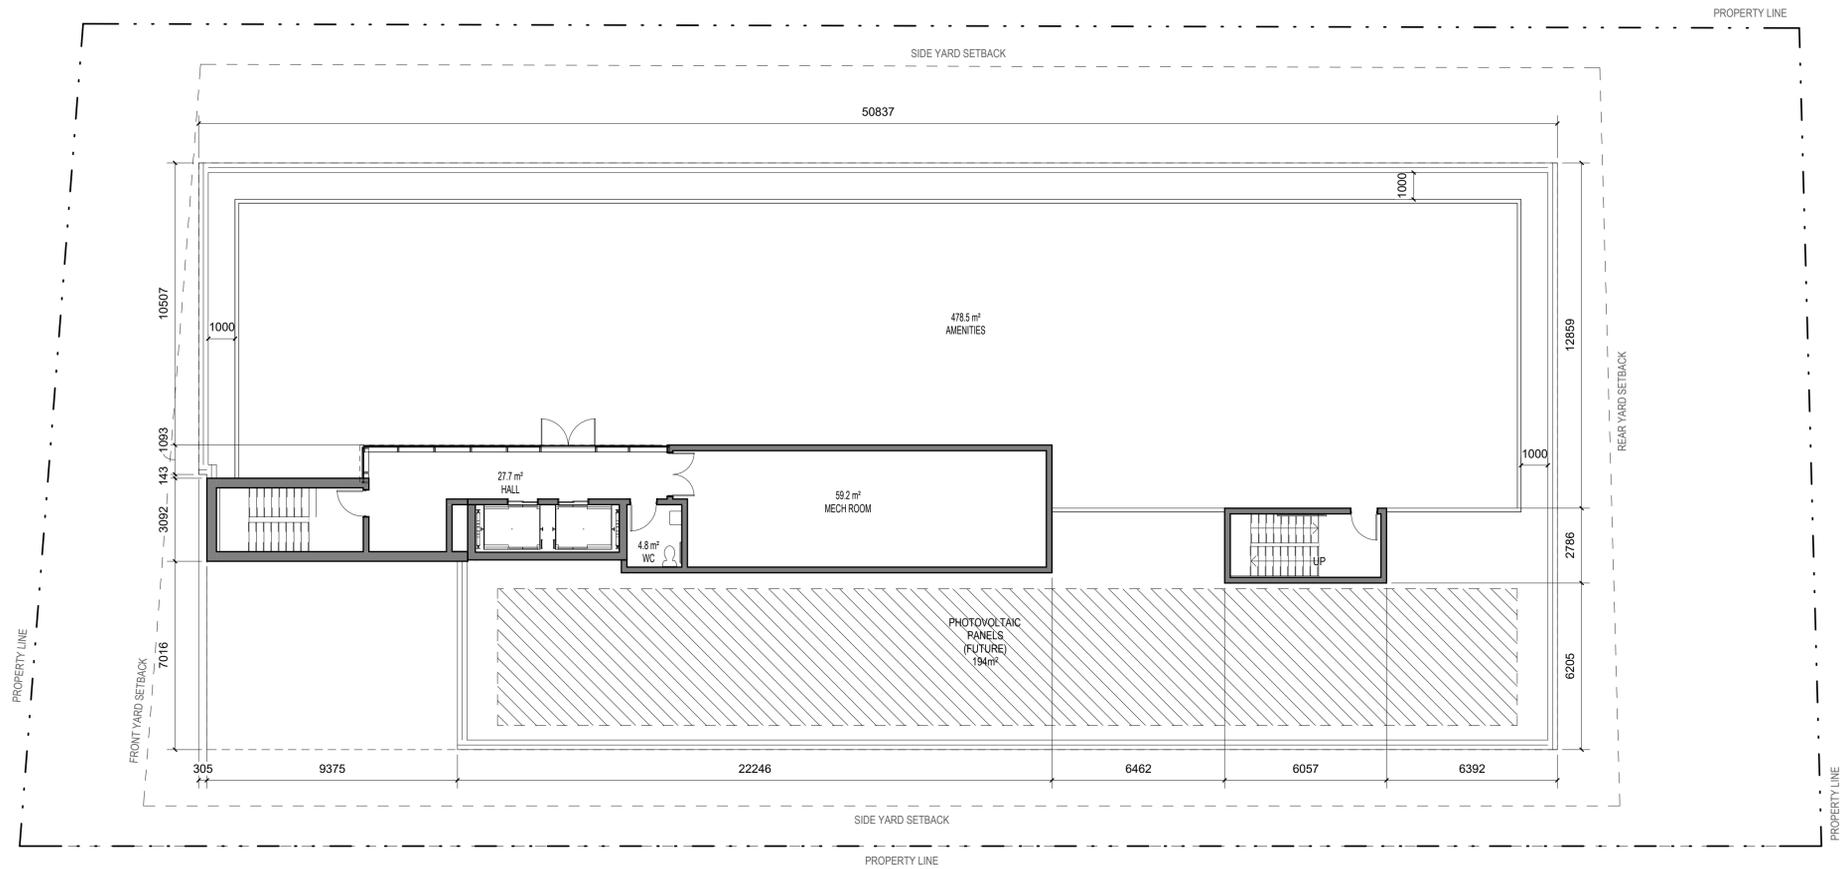
GENERAL NOTES - PARTITION

- EXCEPT AS OTHERWISE INDICATED, DOORS ARE INSTALLED 4" FROM ADJACENT WALLS.
- PROVIDE BLOCKING AND NAILERS FOR ALL PARTITIONS SUPPORTING MILLWORK, SHELVES ETC.
- COORDINATE DIMENSIONS OF OPENINGS WITH SPECIFICATIONS FOR EQUIPMENT SUPPLIED AND INSTALLED.
- WATER RESISTANT GYPSUM BOARD, 1219 AFF REQUIRED IN ALL LOCATIONS WITH EXPOSURE TO WATER OR HUMIDITY. THIS INCLUDES BUT IS NOT LIMITED TO WASHROOMS, JANITOR ROOMS & KITCHEN WALLS ABOVE MILLWORK, CABINETS, INCLUDING SINKS UP TO UNDERSIDE OF UPPER CABINETS.
- ALL PARTITIONS THAT EXTEND FROM SUBFLOOR TO UNDERSIDE FLOOR ASSEMBLY ABOVE ARE TO BE ALIGNED WITH GEOMETRY OF THE ASSEMBLIES TO ENSURE THAT THE ENTIRE PERIMETER IS SEALED AS REQUIRED TO ATTAIN THE NECESSARY FIRE RESISTANCE RATING AND ACOUSTICAL PERFORMANCE.

LEGEND - CONSTRUCTION

ALI	ALIGN DESIGNATED SURFACES		TACTILE ATTENTION INDICATOR AS PER OBC 3.8.3.18		RECESSED ENTRANCE FLOOR GRILLE. DIMENSIONS AS INDICATED ON DRAWINGS. PROVIDE 64 mm DEPRESSION. ENSURE SLAB DEPRESSION IS 76 mm LARGER THAN FLOOR GRILLE SIZE.		LOAD-BEARING WALL REFER TO STRUCTURE
DIM CLEAR	INDICATED CLEAR DIMENSION REQUIRED BETWEEN FINISHED SURFACES		BARRIER-FREE OPERATOR - REFER TO ELEC.		FIRE DEPARTMENT CONNECTION COORD w/ MECH		SHEARWALL REFER TO STRUCTURE
FD	FLOOR DRAIN (REFER TO MECH.)		152 DIA. GEOTEXTILE ENCAPSULATED WEEPING TILE - SEE GENERAL NOTES	FDC			
RD	ROOF DRAIN (REFER TO MECH.)		HATCH INDICATED LOCATION OF FOUNDATION CHECK TO ACCOMMODATE EXTERIOR DOORS. COORD. W/ DOOR SCHEDULE				
EP	ELECTRICAL PANEL (REFER TO ELEC.)						

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 1 04/04/25 SITE PLAN CONTROL



Architecte Paysagiste/Landscape Architect

NAK
design strategies

Ingenieur / Engineer (Civil / Civil)

Stantec

Ingenieur / Engineer (Mécanique & Électrique / Mechanical & Electrical)

Smith + Andersen

Ingenieur / Engineer (Structure / Structure)

D+M STRUCTURAL ENGINEERING

Client / Client

Centretown Citizens Ottawa Corporation

Architecte / Architect

figuri

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Scale / Echelle

Note:

ONTARIO ASSOCIATION OF ARCHITECTS

ROBERTO CRAMPOS
LICENSE
7401

Contractor shall verify all information and dimensions on site and immediately report any errors or omissions to the architect.

Project / Projet

6 STOREY APARTMENT BUILDING

240 PRESLAND ROAD

Title / Titre

ROOF PLAN

Dessiné par / Drawn by: GM No. projet / Project number: 2424

Vérifié par / Verified by: ZK No. dessin / Drawing number: 1 Révision / Revision: 1

Echelle / Scale: As indicated

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A.130

1 ROOF PLAN - SPC
A.130 1 - 125

