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LEGAL DESCRIPTION: PART OF LOT 30; CONCESSION 4 (RIDEAU FRONT) GEOGRAPHIC TOWNSHIP OF GLOUCESTER CITY OF OTTAWA CIVIL ADDRESS: 5545 ALBION ROAD, OTTAWA ZONING NOTES: OFFICIAL PLAN DESIGNATION: RURAL COUNTRYSIDE ZONING - RHI

ZONE: RHI	REQUIRED/ PERMITTED	PROVIDED
PERMITTED USE (AMONG OTHERS)	ALL LAND USES PROPOSED, INCLUDING OTHER HEAVY INDUSTRIAL TYPE USEs	GAS BAR DRIVE-THROUGH FACILITY
CONDITIONAL USES PERMITTED:	ALL LAND USED PROPOSED	CONVENIENCE STORE, RESTAURANT
MIN. LOT AREA	20,000 sq.m.	23,200sq.m.
MIN. LOT WIDTH	60m	12lm
MIN. FRONT YARD SETBACK	15 m	15 m
MIN. REAR YARD SETBACK	15 m	155 m
MIN. INTERIOR SIDE YARD SETBACK	OTHER CASE:	7lm
MIN. CORNER SIDE YARD SETBACK	15m	29m
MAX. PRINCIPAL BUILDING HEIGHT	15m	8m GAS CANOPIES 5.4m BUILDING
MAX. LOT COVERAGE (%)	50%	8%
PARKING LOT LANDSCAPE AREA	MIN 15% OF INTERIOR OR PERIMETER AREA	32%
OUTDOOR STORAGE	(a) outside storage is not permitted within any required front yard or corner side yard;	NO OUTDOOR STORAGE IS PROPOSED
	(b) outside storage must be screened from abutting residential uses and public streets by an opaque screen at least 1.8 metres in height from finished grade	
GENERAL PROVISIONS FOR MOTOR VEHICLE	PARKING SPACES REQUIRED OR PROVIDED FOR A LAND USE MAY BE USED AS PART OF	4 PARKING SPACES ARE IDENTIFIED AS FUTURE ELECTRIC VEHICLE CHARGING

		must be screened from abutting residential uses and public streets by an opaque screen at least 1.6 metres in height from finished grade	
	GENERAL PROVISIONS FOR MOTOR VEHICLE PARKING	PARKING SPACES REQUIRED OR PROVIDED FOR A LAND USE MAY BE USED AS PART OF AN ELECTRIC VEHICLE CHARGING STATION	4 PARKING SPACES ARE IDENTIFIED AS FUTURE ELECTRIC VEHICLE CHARGING
	MIN. PARKING SPACES	GAS BAR = NONE CONVENIENCE STORE 3.4 / IOOM2 GFA = 6 RESTAURANT FAST FOOD PER IO(I6)(I6)(I) 20% reduction applies when operating with a drive-through IO / IOOM2 GFA = 20	TOTAL OF 32 VEHICLE PARKING SPACES PROVIDED (26 REQUIRED)
	MIN. ACCESSIBLE PARKING SPACES	WHERE 26-50 PARKING SPACES ARE PROVIDE: 2 SPACES; I TYPE A, I TYPE B	2 SPACES; I TYPE A, I TYPE B
	PARKING SPACE DIMENSIONS	MIDTH: MIN 2.6, MAX 3.1 LENGTH: MIN 5.2m	WIDTH: 2.6m LENGTH: 5.2m
	MINIMUM WIDTH OF DRIVEWAY	6M FOR TWO WAY TRAFFIC	10.8m
	MINIMUM REQUIRED AISLE WIDTH	ANGLE PARKING 71-90d 6.7m	7.2m
	OUTDOOR REFUSE	LOCATION: MIN. 9m FROM A PUBLIC ST & MIN. 3m FROM A LOT LINE. SCREENING: WHERE AN IN-GROUND REFUSE CONTAINER IS PROVIDED, THE SCREENING REQ. MAY BE ACHIEVED WITH SOFT LANDSCAPING.	LOCATION: MIN. 20M FROM A LOT LINE & PUBLIC ST SCREENING: IIN-GROUND REFUSE CONTAINER ARE PROPOSED TO BE SCREENED WITH SOFT LANDSCAPING.
	BICYCLE PARKING	N/A	4
	MIN HORIZONTAL BICYCLE PARKING SPACE DIMENSIONS	WIDTH: 0.6m LENGTH: I.8m	WIDTH: 0.6m LENGTH: 1.8m
	MINIMUM NUMBER OF QUEUING SPACES REQUIRED	RESTAURANT: II) MITH ORDER BOARD: 7 BEFORE/AT ORDER BOARD, MIN TOTAL OF II	BEFORE / AT ORDER BOARD: 10 (PLUS 3 IN SECOND LANE) TOTAL: 15 FORM THE

ALL QUEUING SPACES MUST BE:

(s) AT LEAST 3m WIDE (t) AT LEAST 5.7m LONG

MINIMUM QUEUING

SPACES DIMENSIONS

LEGEND: 3400 B.F. PARKING STALL c/w BF. SIGNAGE DEPRESSED CURB c/w 150mm DIA., 6mm THK. GALV. STEEL BOLLARD (MIN. 1.5m HIGH & 1.5m BELOW GRADE) HEAVY DUTY ASPHALT PAINTED LINE STOP ROLLED CONCRETE CURB SITE SIGNAGE ----PAINTED LINES BIKE RACK EXTERIOR LIGHTING/ REFER TO ELEC. DWGS. FOR TYPES CHAIN LINK FENCE ____ FRS FIRE ROUTE SIGNAGE EXISTING TREE* *REFER TO LANDSCAPE LI.OI FOR DETAILS NEW TREE* NEW PLANTING*

6	MAR 28, 2025	ISSUED FOR S	SITEPLAN APPLICATION		
5	JAN 29, 2025	ISSUED FOR S	SITEPLAN APPLICATION		
4	DEC 3, 2024	ISSUED FOR S	SITEPLAN APPLICATION		
3	NOV 1, 2024	ISSUED FOR P	PRE CONSULTATION		
2	OCT 9, 2024	ISSUED FOR R	REVIEW		
1	OCT 3, 2024	ISSUED FOR R	REVIEW		
no.	date	revision			
<u>'</u>					

sions on site and report all errors and/ or omissions to the architect.

It is the responsibility of the appropriate contractor to check and verify all dimen-

All contractors must comply with all pertinent codes and by—laws. Do not scale drawings.

This drawing may not be used for construction until signed.

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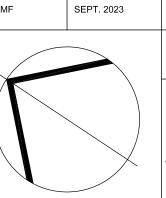
F: 613-235-2005 HOBIN E: mail@hobinarc.com ARCHITECTURE **hobinarc**.com

PROJECT/LOCATION:

W.O. Stinson & Son Ltd. Albion Road Property 5545 Albion Road

DRAWING TITLE: GAS BAR AND CARDLOCK CONVENIENCE STORE SITE PLAN

SCALE:




DRAWN BY: DATE:

MINDOW (ADDITIONAL
4 IN THE SECOND LANE,
2 IN THE BYPASS LANE,
2 POST MINDOW.)

MIN LENGTH: 5.7m

AS NOTED PROJECT: DRAWING NO.: A1.00 REVISION NO.:

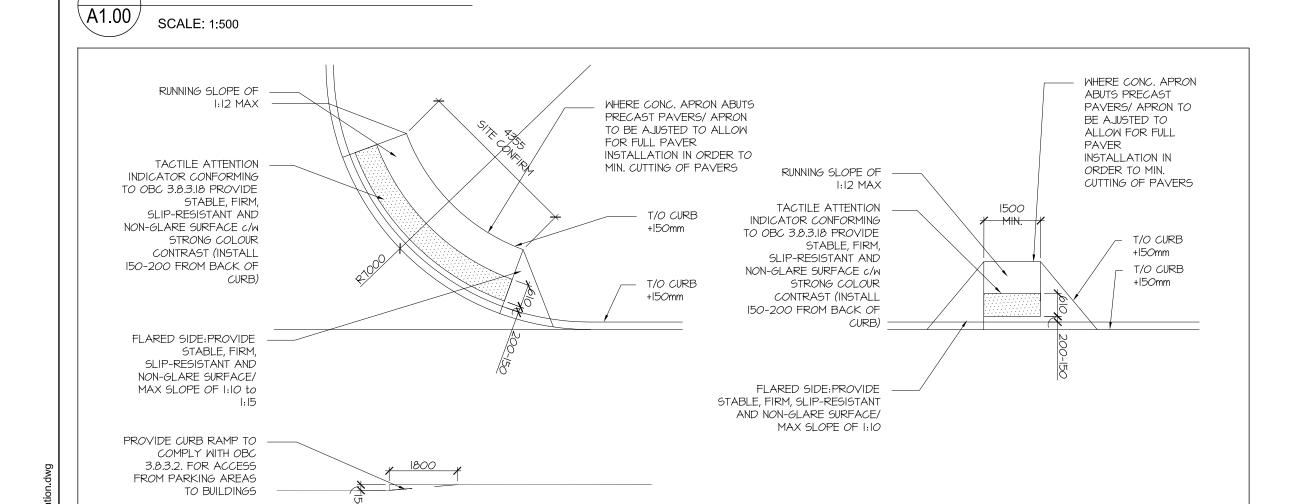

TYPICAL TWSI DETAIL

A1.00 SCALE: 1:100