



| Exist | ing T | ree | 25 | | | | | |
|----------|--------|-----|---|--------------------------|------------------|---|--|-----------------------|
| Origin | ID | | Botanical Name EXISTING TREES - GOOD CONDITION | Common Name | Size (cm DBH) | Location | Condition | Action |
| Non N | Ag | 5 | Acer ginnala | Amur Maple, tree form | 8 | | Good | Retain |
| Ntv H | Ar'AS' | 2 | Acer rubrum 'Autumn Spire' | Red Maple | 9 | | Good | Retain |
| Ntv | As | 1 | Acer saccharum | Sugar Maple | 9 | | Good | Retain |
| Ntv H | AcB | 6 | Amelanchier canadensis 'Ballerina' | Ballerina Serviceberry | 8 | | Good | Retain |
| Non N | BnR | 3 | Betula nigra 'Riversii' | River Birch | 7 | | Good | Retain |
| Ntv | Со | 9 | Celtis occidentalis | Common Hackberry | 9 | | Good | Retain |
| Ntv H | GtS | 3 | Gleditsia triacanthos inermis 'Shademaster' | Shademaster Honey Locust | 9 | | Good | Retain |
| Non N | MM | 4 | Malus x Makamik | Makamik Crabapple | 8 | | Good | Retain |
| Ntv | Ov | 3 | Ostrya virginiana | Ironwood | 8 | | Good | Retain |
| Non N | Рр | 18 | Picea pungens | Colorado Spruce | 9 | | Good | Retain |
| Ntv | Qr | 3 | Quercus rubra | Red Oak | 9 | | Good | Retain |
| Ntv H | AcB | 1 | EXISTING TREES - POOR CONDITION Amelanchier canadensis 'Ballerina' | Ballerina Serviceberry | 8 | Near east side property, south of east patio | Poor | Retain |
| Ntv | As | 1 | Acer saccharum | Sugar Maple | 9 | Near west property line, west of west patio | Scarred trunk | Retain |
| Non N | ММ | 1 | Malus x Makamik | Makamik Crabapple | 7 | At north property line, centre of property | Very poor, sprouting from roots | Retain |
| Non N | ММ | 1 | Malus x Makamik | Makamik Crabapple | 8 | At north propoerty line, centre of property | Fair to poor condition | Retain |
| Ntv | Qr | 1 | Quercus rubra | Red Oak | 9 | Near north property line, west of north parking | Trunk scarred at base | Retain |
| | | | EXISTING TREES TO REMOVE | | | | | |
| Ntv H | AcB | 1 | Amelanchier canadensis 'Ballerina' | Ballerina Serviceberry | 8 | West of main entrance | from roots only. In conflict with | Remove |
| Non N | ММ | 1 | Malus x Makamik | Makamik Crabapple | 7 | West of west patio | Very poor condition | Remove and replace |
| INVASIVE | PcC | 1 | Pyrus calleryana 'Chanticleer' | Chanticleer Pear | 9 | North of east gazebo | Fair - invasive species | Remove |
| Ntv | tCo | 1 | Celtis occidentalis | Common Hackberry | 9 | South-west corner of parking near south property line | Good, in conflict with proposed snow storage | Transplant |
| Non N | tPp | 1 | Picea pungens | Colorado Spruce | 9 | West of main entrance at south property line. | Good, in conflict with existing utilities, | Transplant |
| | | | | | | | | |

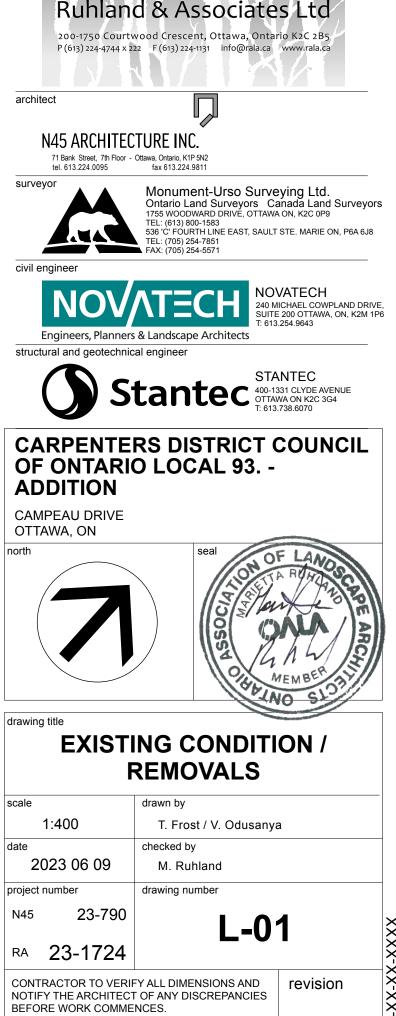

DO NOT SCALE DRAWINGS

XXXXX

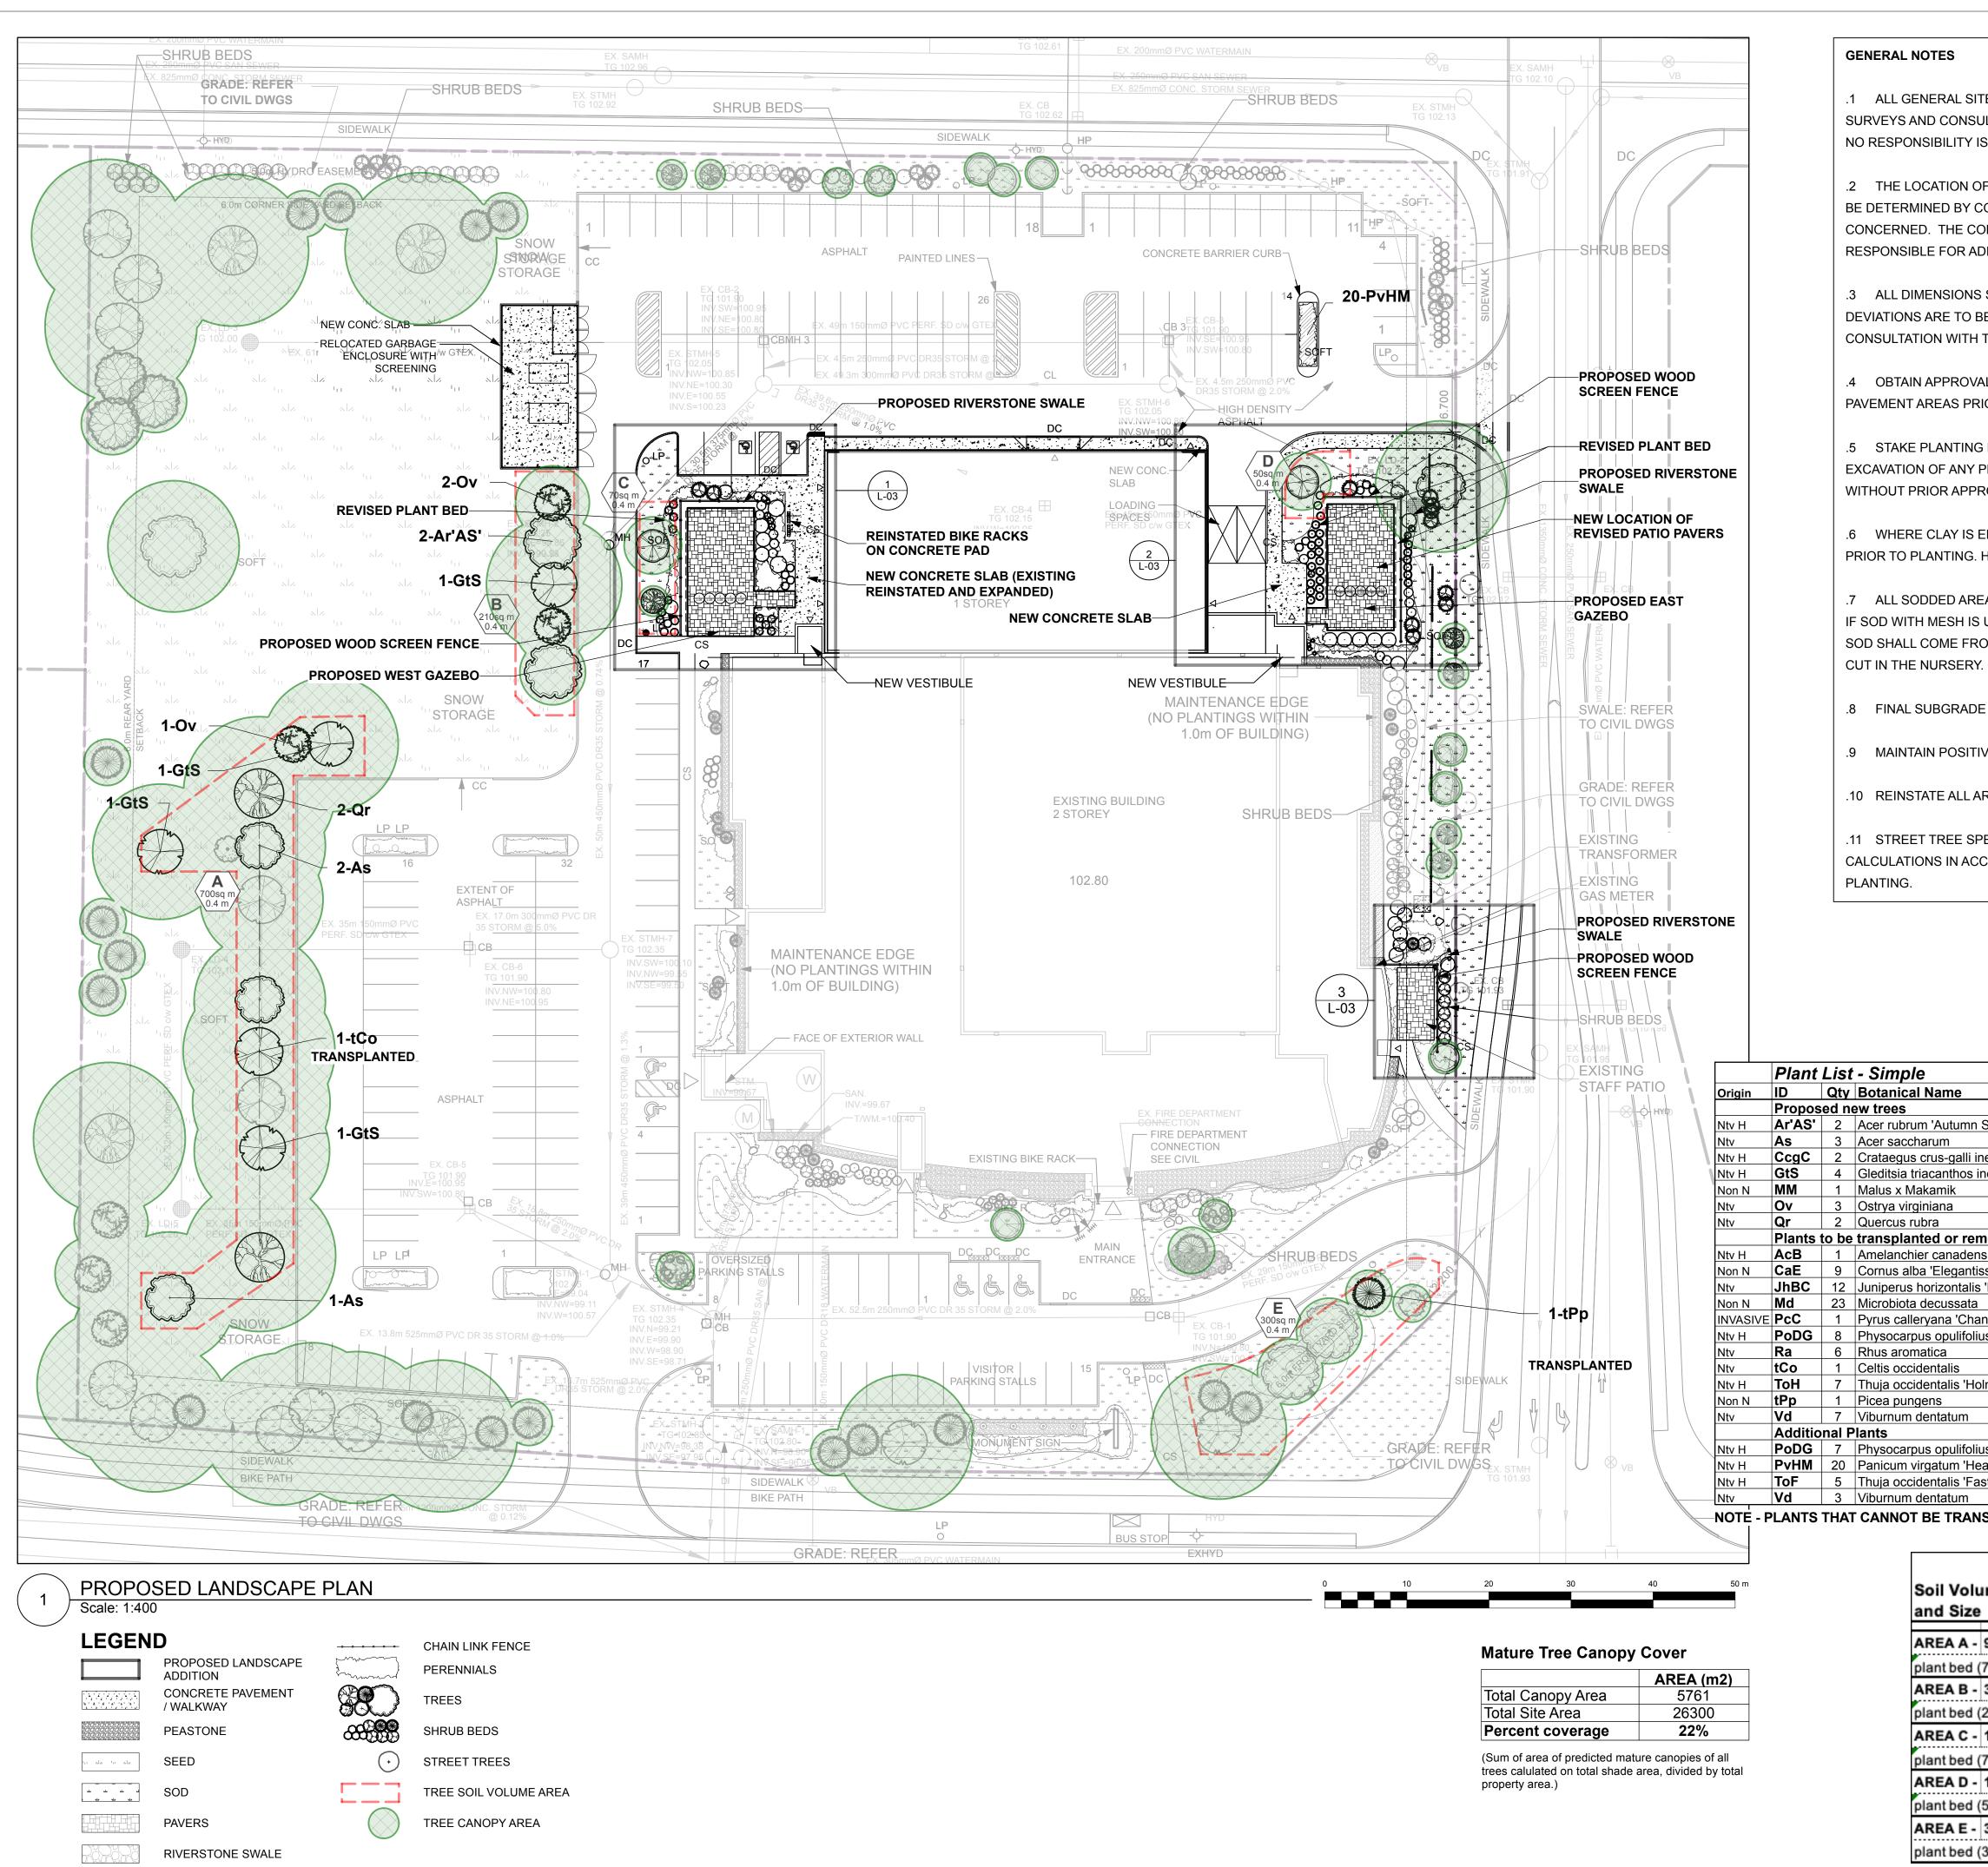

| | AREA (m2 |
|-------------------|----------|
| Total Canopy Area | 5761 |
| Total Site Area | 26300 |
| Percent coverage | 22% |
| | |

.1 ALL GENERAL SITE INFORMATION AND CONDITIONS COMPILED FROM EXISTING PLANS, SURVEYS AND CONSULTANT'S FIELD NOTES. REPORT ALL DISCREPANCIES PRIOR TO ANY WORK. NO RESPONSIBILITY IS BORN BY THE CONSULTANT FOR UNKNOWN SUBSURFACE CONDITIONS.

.2 THE LOCATION OF THE UTILITIES IS APPROXIMATE ONLY, AND THE EXACT LOCATION SHOULD BE DETERMINED BY CONSULTING THE MUNICIPAL AUTHORITIES AND UTILITY COMPANIES CONCERNED. THE CONTRACTOR SHALL PROVE THE LOCATION OF UTILITIES AND SHALL BE RESPONSIBLE FOR ADEQUATE PROTECTION FROM DAMAGE.

.3 ALL DIMENSIONS SHOWN ARE TO BE VERIFIED ON SITE PRIOR TO ANY CONSTRUCTION. NO DEVIATIONS ARE TO BE MADE FROM THE LAYOUTS AS SHOWN ON THIS PLAN WITHOUT PRIOR CONSULTATION WITH THE LANDSCAPE ARCHITECT AND OWNER.

.4 OBTAIN APPROVAL OF LANDSCAPE ARCHITECT FOR GRANULAR BASE AND LAYOUT OF ALL PAVEMENT AREAS PRIOR TO CONSTRUCTION.

.5 STAKE PLANTING LOCATIONS AND RECEIVE APPROVAL OF LANDSCAPE ARCHITECT, PRIOR TO EXCAVATION OF ANY PLANTING PITS. NO SUBSTITUTIONS OF PLANT MATERIAL SHALL BE MADE WITHOUT PRIOR APPROVAL OF THE LANDSCAPE ARCHITECT.

.6 WHERE CLAY IS ENCOUNTERED PROPER DRAINAGE MUST BE ENSURED IN TREE/SHRUB PITS, PRIOR TO PLANTING. HAVE METHOD APPROVED BY LANDSCAPE ARCHITECT.

.7 ALL SODDED AREAS TO RECEIVE A MINIMUM OF 150MM OF TOPSOIL OVER GRADED SUB-BASE. IF SOD WITH MESH IS USED, MESH TO BE REMOVED COMPLETELY DURING SODDING OPERATIONS. SOD SHALL COME FROM AN APPROVED SOURCE AND SHALL BE LAID WITHIN 24 HOURS OF BEING CUT IN THE NURSERY. ONLY NURSERY SOD SHALL BE USED.

.8 FINAL SUBGRADE IS TO APPROVED BY THE LANDSCAPE ARCHITECT PRIOR TO SOD BEING LAID.

.9 MAINTAIN POSITIVE SURFACE RUNOFF THROUGH THE ENTIRE CONSTRUCTION PERIOD.

.10 REINSTATE ALL AREAS AND ITEMS DAMAGED AS A RESULT OF CONSTRUCTION ACTIVITIES.

.11 STREET TREE SPECIES LOCATIONS AND NUMBERS WERE SELECTED BASED ON SOIL VOLUME CALCULATIONS IN ACCORDANCE WITH THE CITY OF OTTAWA'S REQUIREMENTS FOR TREE

| Common Name | Sched. Size | Remarks |
|--------------------------------------|---|--|
| | | |
| Red Maple | 70mm caliper | WB, Staked |
| Sugar Maple | 60mm caliper | WB, Staked |
| Thornless Crusader Cockspur Hawthorn | 45mm caliper | WB, Staked |
| Shademaster Honey Locust | 60mm caliper | WB, Staked |
| Makamik Crabapple | 50mm cal. | B&B / WB |
| Ironwood | 50mm caliper | WB, Staked |
| Red Oak | 60mm caliper | WB, Staked |
| | | |
| Ballerina Serviceberry REMOVE | 45mm caliper | WB, Staked |
| Silverleaf Dogwood | 50cm ht | 1.0m o.c. |
| Blue Chip Juniper | 50cm spd | 1.1m o.c. |
| Russian Cypress | 50cm spd | 0.9m o.c. |
| Chanticleer Pear REMOVE | 50cm ht | WB. Staked |
| Darts Gold Ninebark | 40cm ht | Potted |
| Fragrant Sumac | 50cm ht | Potted |
| Common Hackberry | 60mm caliper | WB, Staked |
| Holmstrup Eastern Arborvitae | 150 cm ht. | Potted |
| Colorado Spruce | 200cm ht | WB, Staked |
| Arrowwood | 80cm ht | Bare root |
| | | |
| Darts Gold Ninebark | 40cm ht | Potted |
| Heavy Metal Switch Grass | 3 year | Potted |
| Fastigiate Eastern Arborvitae | 175cm ht | specimen |
| Arrowwood | 80cm ht | Bare root |
| | Red Maple Sugar Maple Thornless Crusader Cockspur Hawthorn Shademaster Honey Locust Makamik Crabapple Ironwood Red Oak Ballerina Serviceberry REMOVE Silverleaf Dogwood Blue Chip Juniper Russian Cypress Chanticleer Pear Remove Darts Gold Ninebark Fragrant Sumac Colorado Spruce Arrowwood Darts Gold Ninebark Heavy Metal Switch Grass Fastigiate Eastern Arborvitae | Red Maple70mm caliperSugar Maple60mm caliperThornless Crusader Cockspur Hawthorn45mm caliperShademaster Honey Locust60mm caliperMakamik Crabapple50mm cal.Ironwood50mm caliperRed Oak60mm caliperBallerina ServiceberryREMOVEBallerina ServiceberryREMOVEBullerina ServiceberryREMOVESilverleaf Dogwood50cm htBlue Chip Juniper50cm spdChanticleer PearREMOVEDarts Gold Ninebark40cm htFragrant Sumac50cm htColorado Spruce200cm htArrowwood80cm htDarts Gold Ninebark40cm htHeavy Metal Switch Grass3 yearFastigiate Eastern Arborvitae175cm ht |

NOTE - PLANTS THAT CANNOT BE TRANSPLANTED ARE TO BE REPLACED WITH THE SAME SPECIES AND CULTIVAR

| ume Area, Tree Quantity e | Tree Quantity | OTTAWA Target Soil Volume (m ³) | Design Soil Volume | Soil Adequacy percentage |
|--------------------------------|------------------|---|-----------------------|--------------------------------|
| 9 large trees, 1 medium tree | , 2 large e | xisting trees | , 1 medium ex | isting tree |
| (700 sq m x 0.4m ave deep) | 13 | 228.0 | 280.0 | 123% |
| 3 large trees, 2 medium tree | s | | | |
| (210 sq m x 0.4m ave deep) | 5 | 84.0 | 84.0 | 100% |
| 1 medium tree, 1 small tree | | | | |
| (70 sq m x 0.4m ave deep) | 2 | 27.0 | 28.0 | 104% |
| 1 small tree | | | | |
| (50 sq m x 0.4m ave deep) | 1 | 20.0 | 20.0 | 100% |
| 3 large trees, 3 conifers, 1 s | mall tree | | | |
| (300 sq m x 0.4m ave deep) | 7 | 111.0 | 120.0 | 108% |



GENERAL NOTES

All general site information and conditions compiled from existing plans, surveys and consultant's field notes. Report all discrepancies prior to any work. No responsibility is born by the Consultant for unknown subsurface conditions.

.2 The location of the utilities is approximate only, and the exact location should be determined by consulting the municipal authorities and utility companies concerned. The Contractor shall prove the location of utilities and shall be responsible for adequate protection from damage.

All dimensions shown are to be verified on site prior to any construction. No deviations are to be made from the layouts as shown on this plan without prior consultation with the Landscape Architect and Owner.

Obtain approval of Landscape Architect for granular base and layout of all pavement areas prior to construction.

Stake planting locations and receive approval of Landscape Architect, prior to excavation of any planting pits. No substitutions of plant material shall be made without prior approval of the Landscape Architect.


Where clay is encountered proper drainage must be ensured in tree/shrub pits, prior to planting. Have method approved by Landscape Architect.


All sodded areas to receive a minimum of 150mm of topsoil over graded sub-base. If sod with mesh is used, mesh to be removed completely during sodding operations. Sod shall come from an approved source and shall be laid within 24 hours of being cut in the nursery. Only nursery sod shall be used.


.8 Final subgrade is to approved by the Landscape Architect prior to sod being laid.

Maintain positive surface runoff through the entire construction period.

.10 Reinstate all areas and items damaged as a result of construction activities

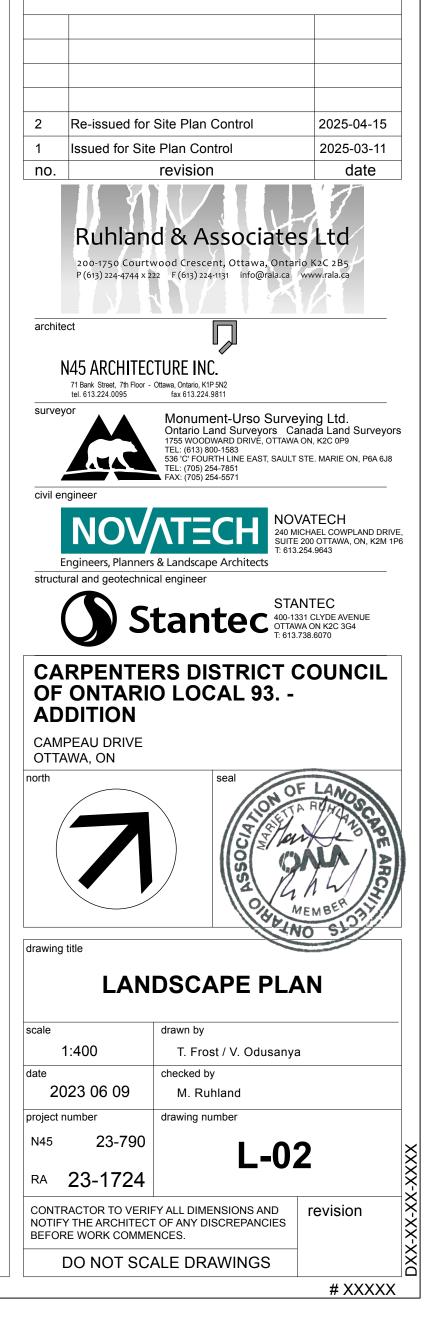

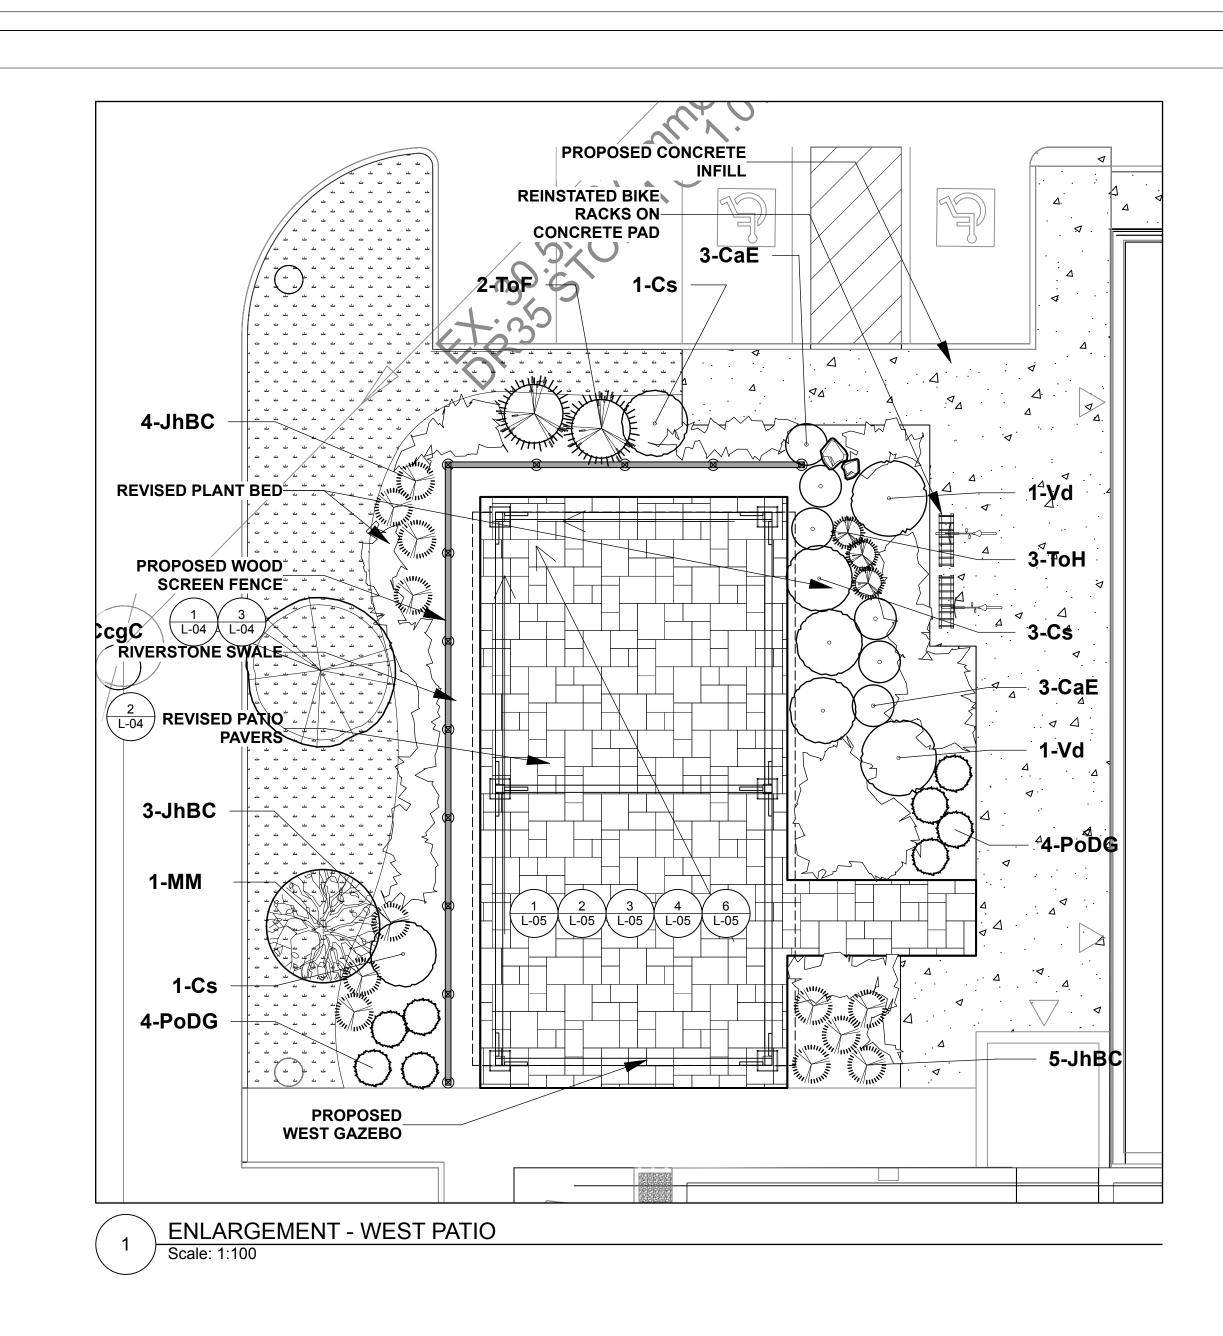

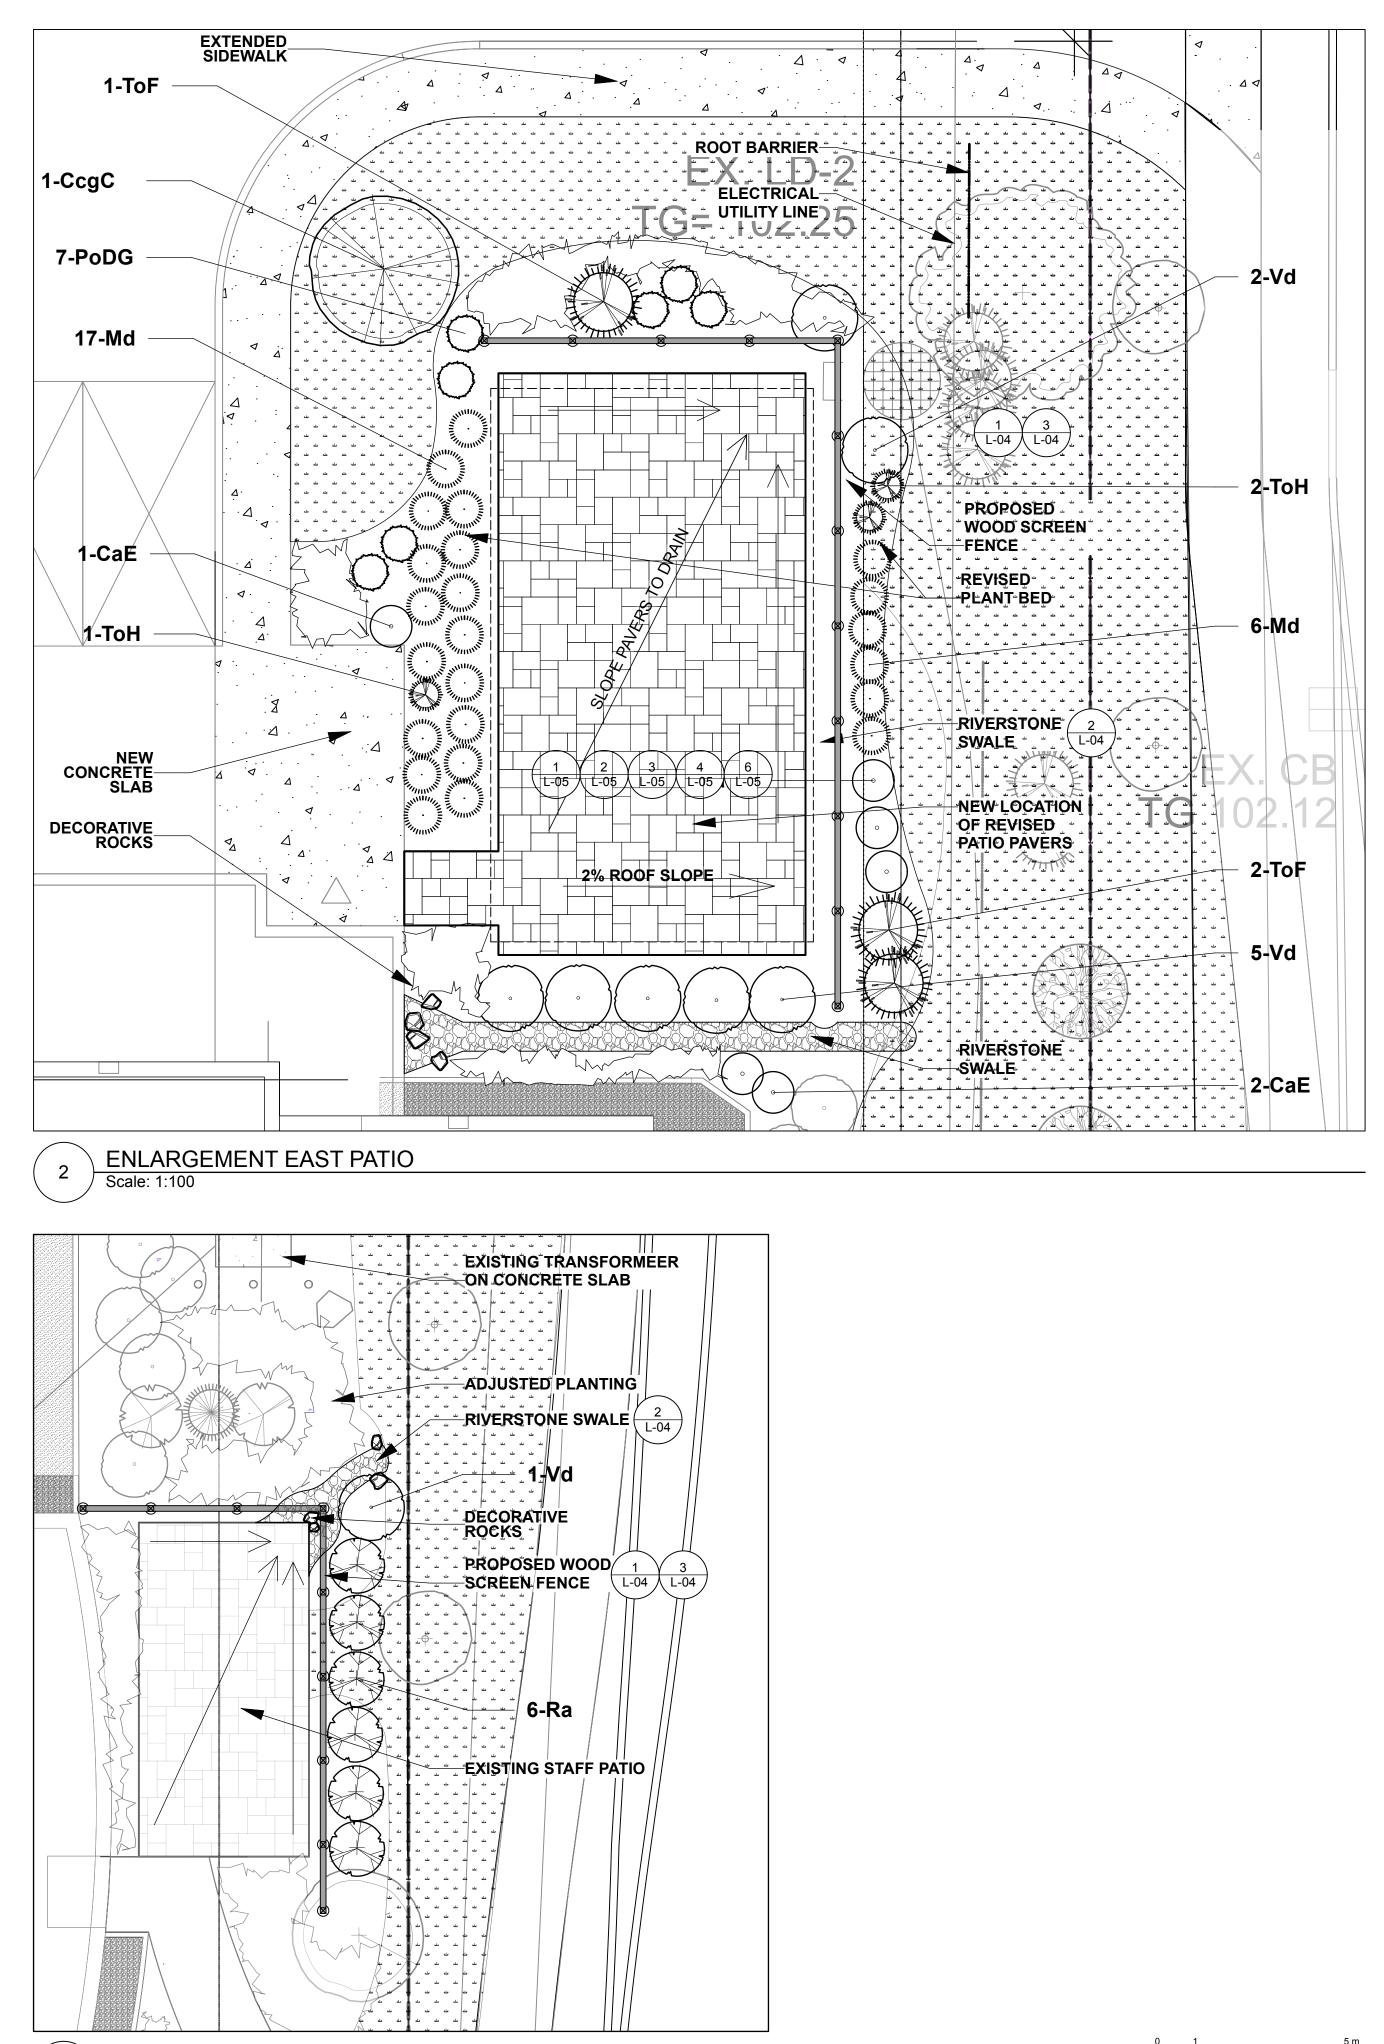





3



XXXXX

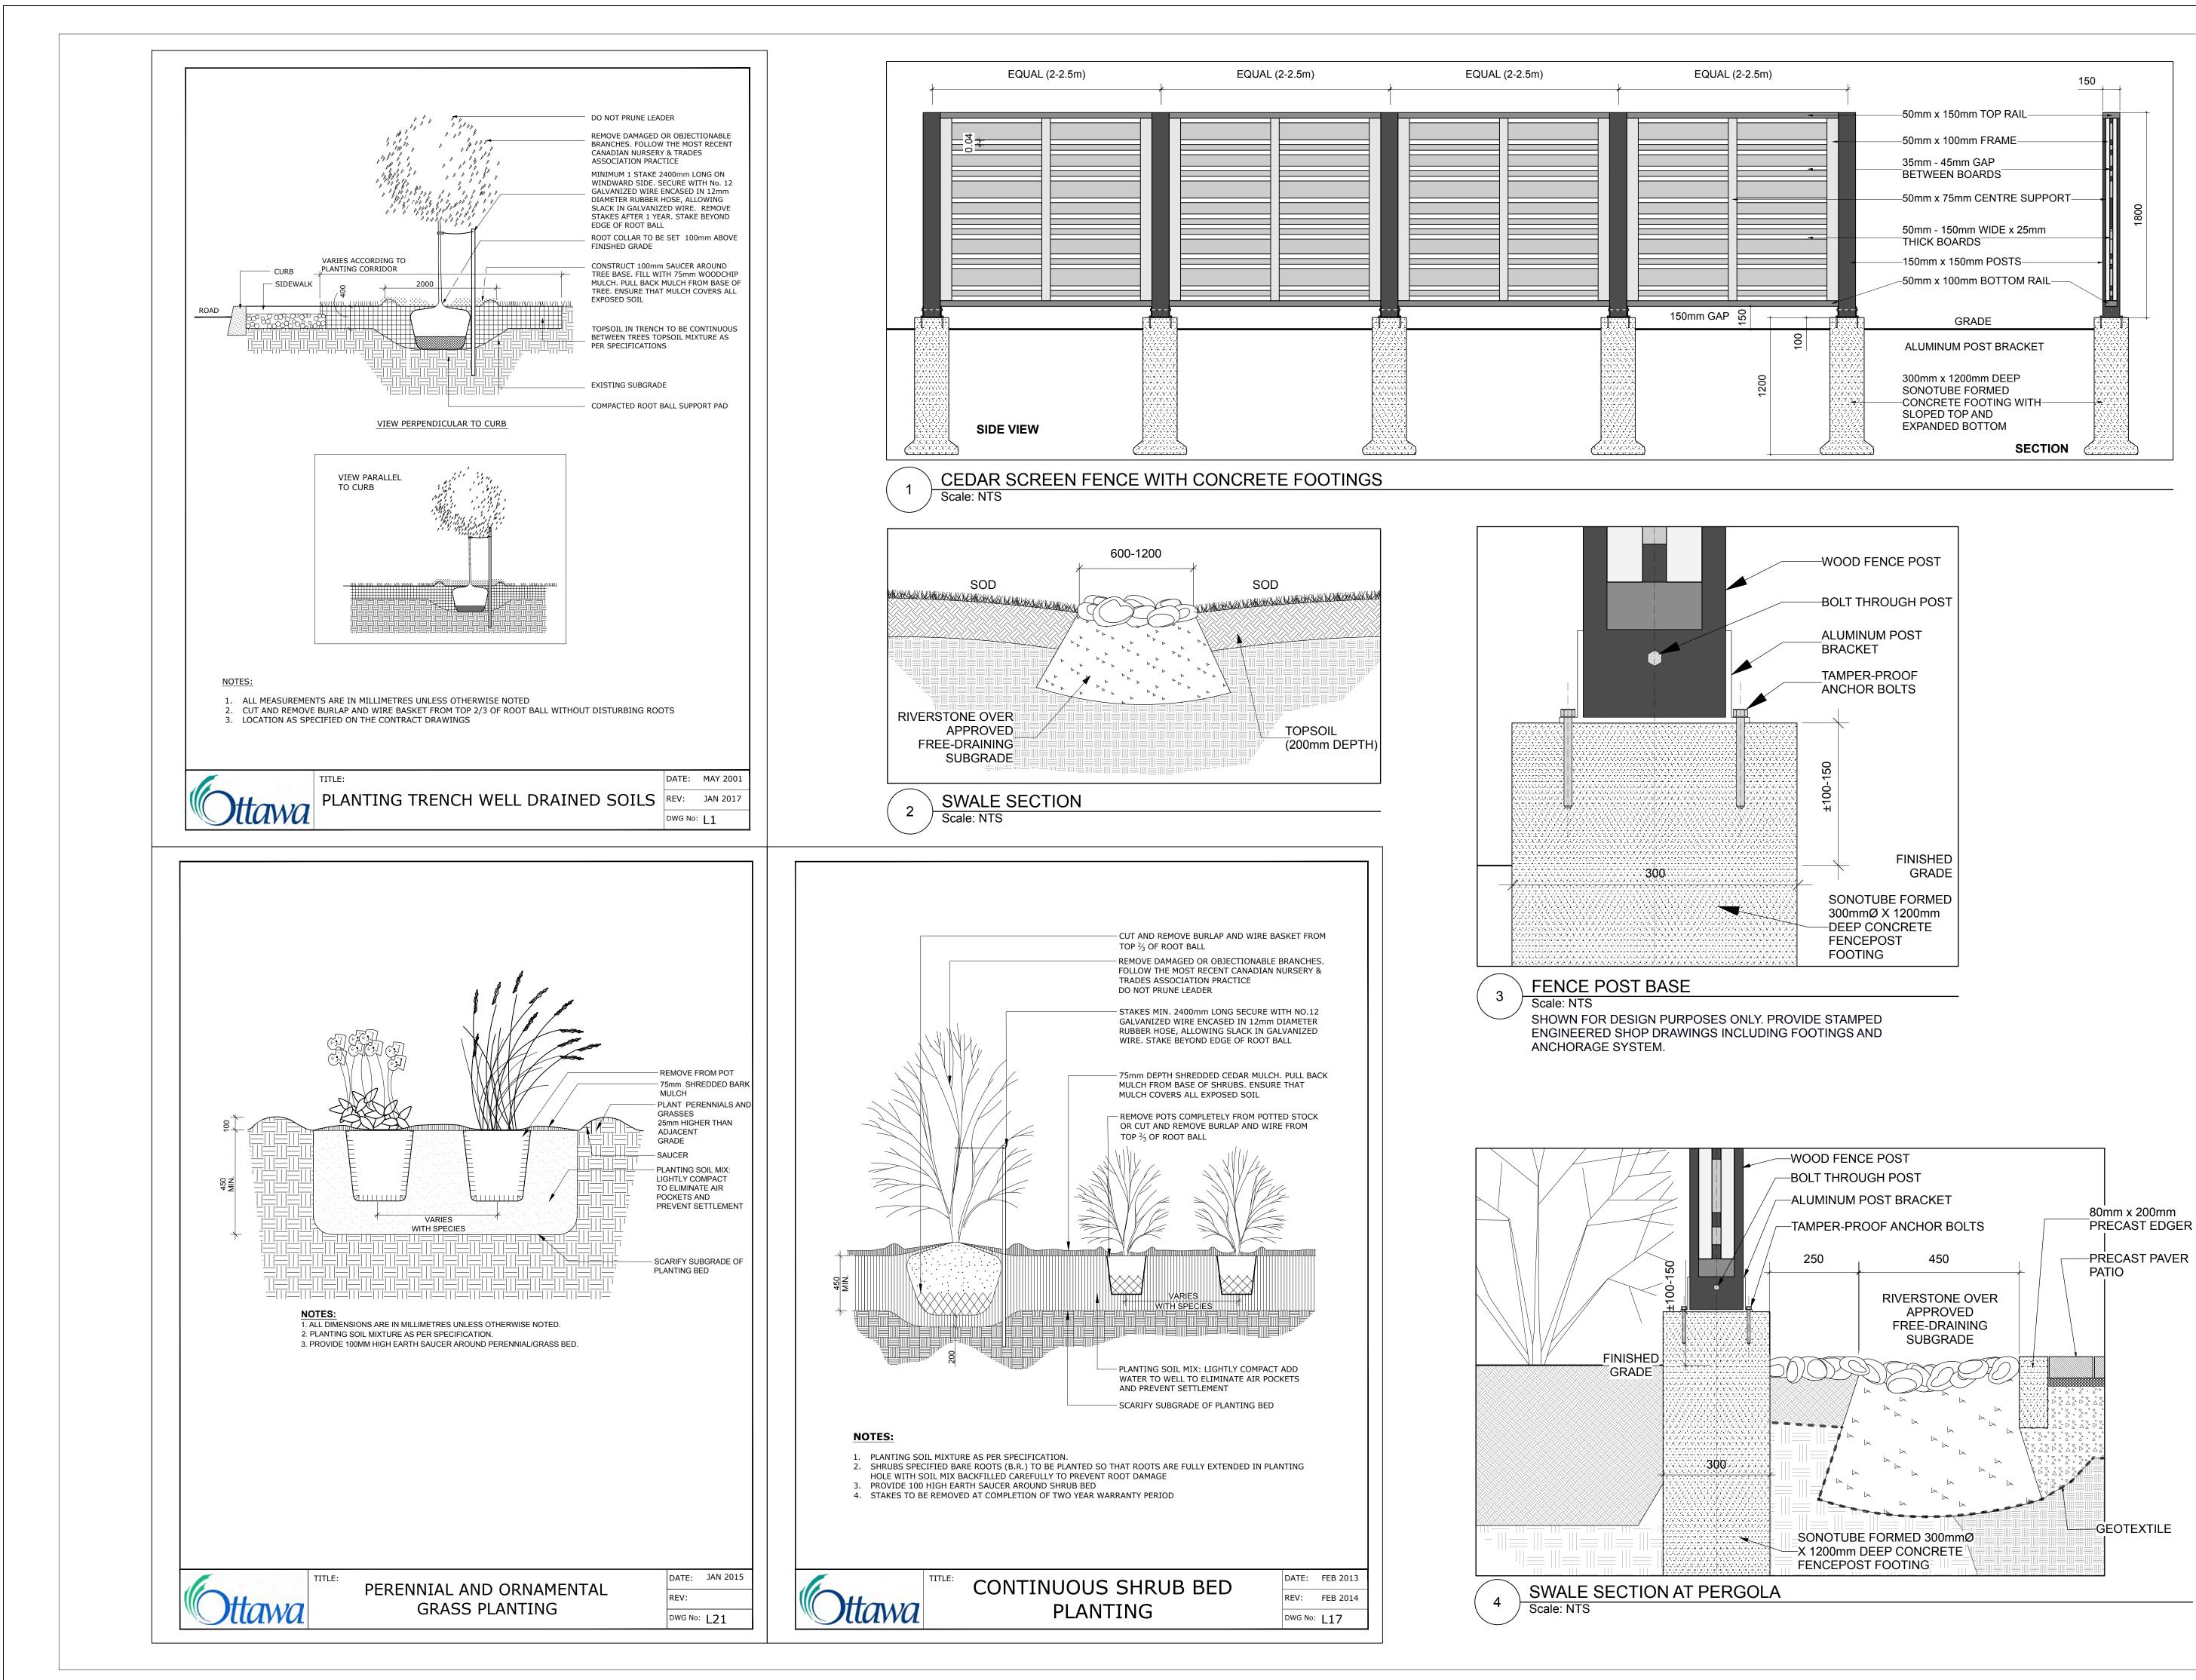



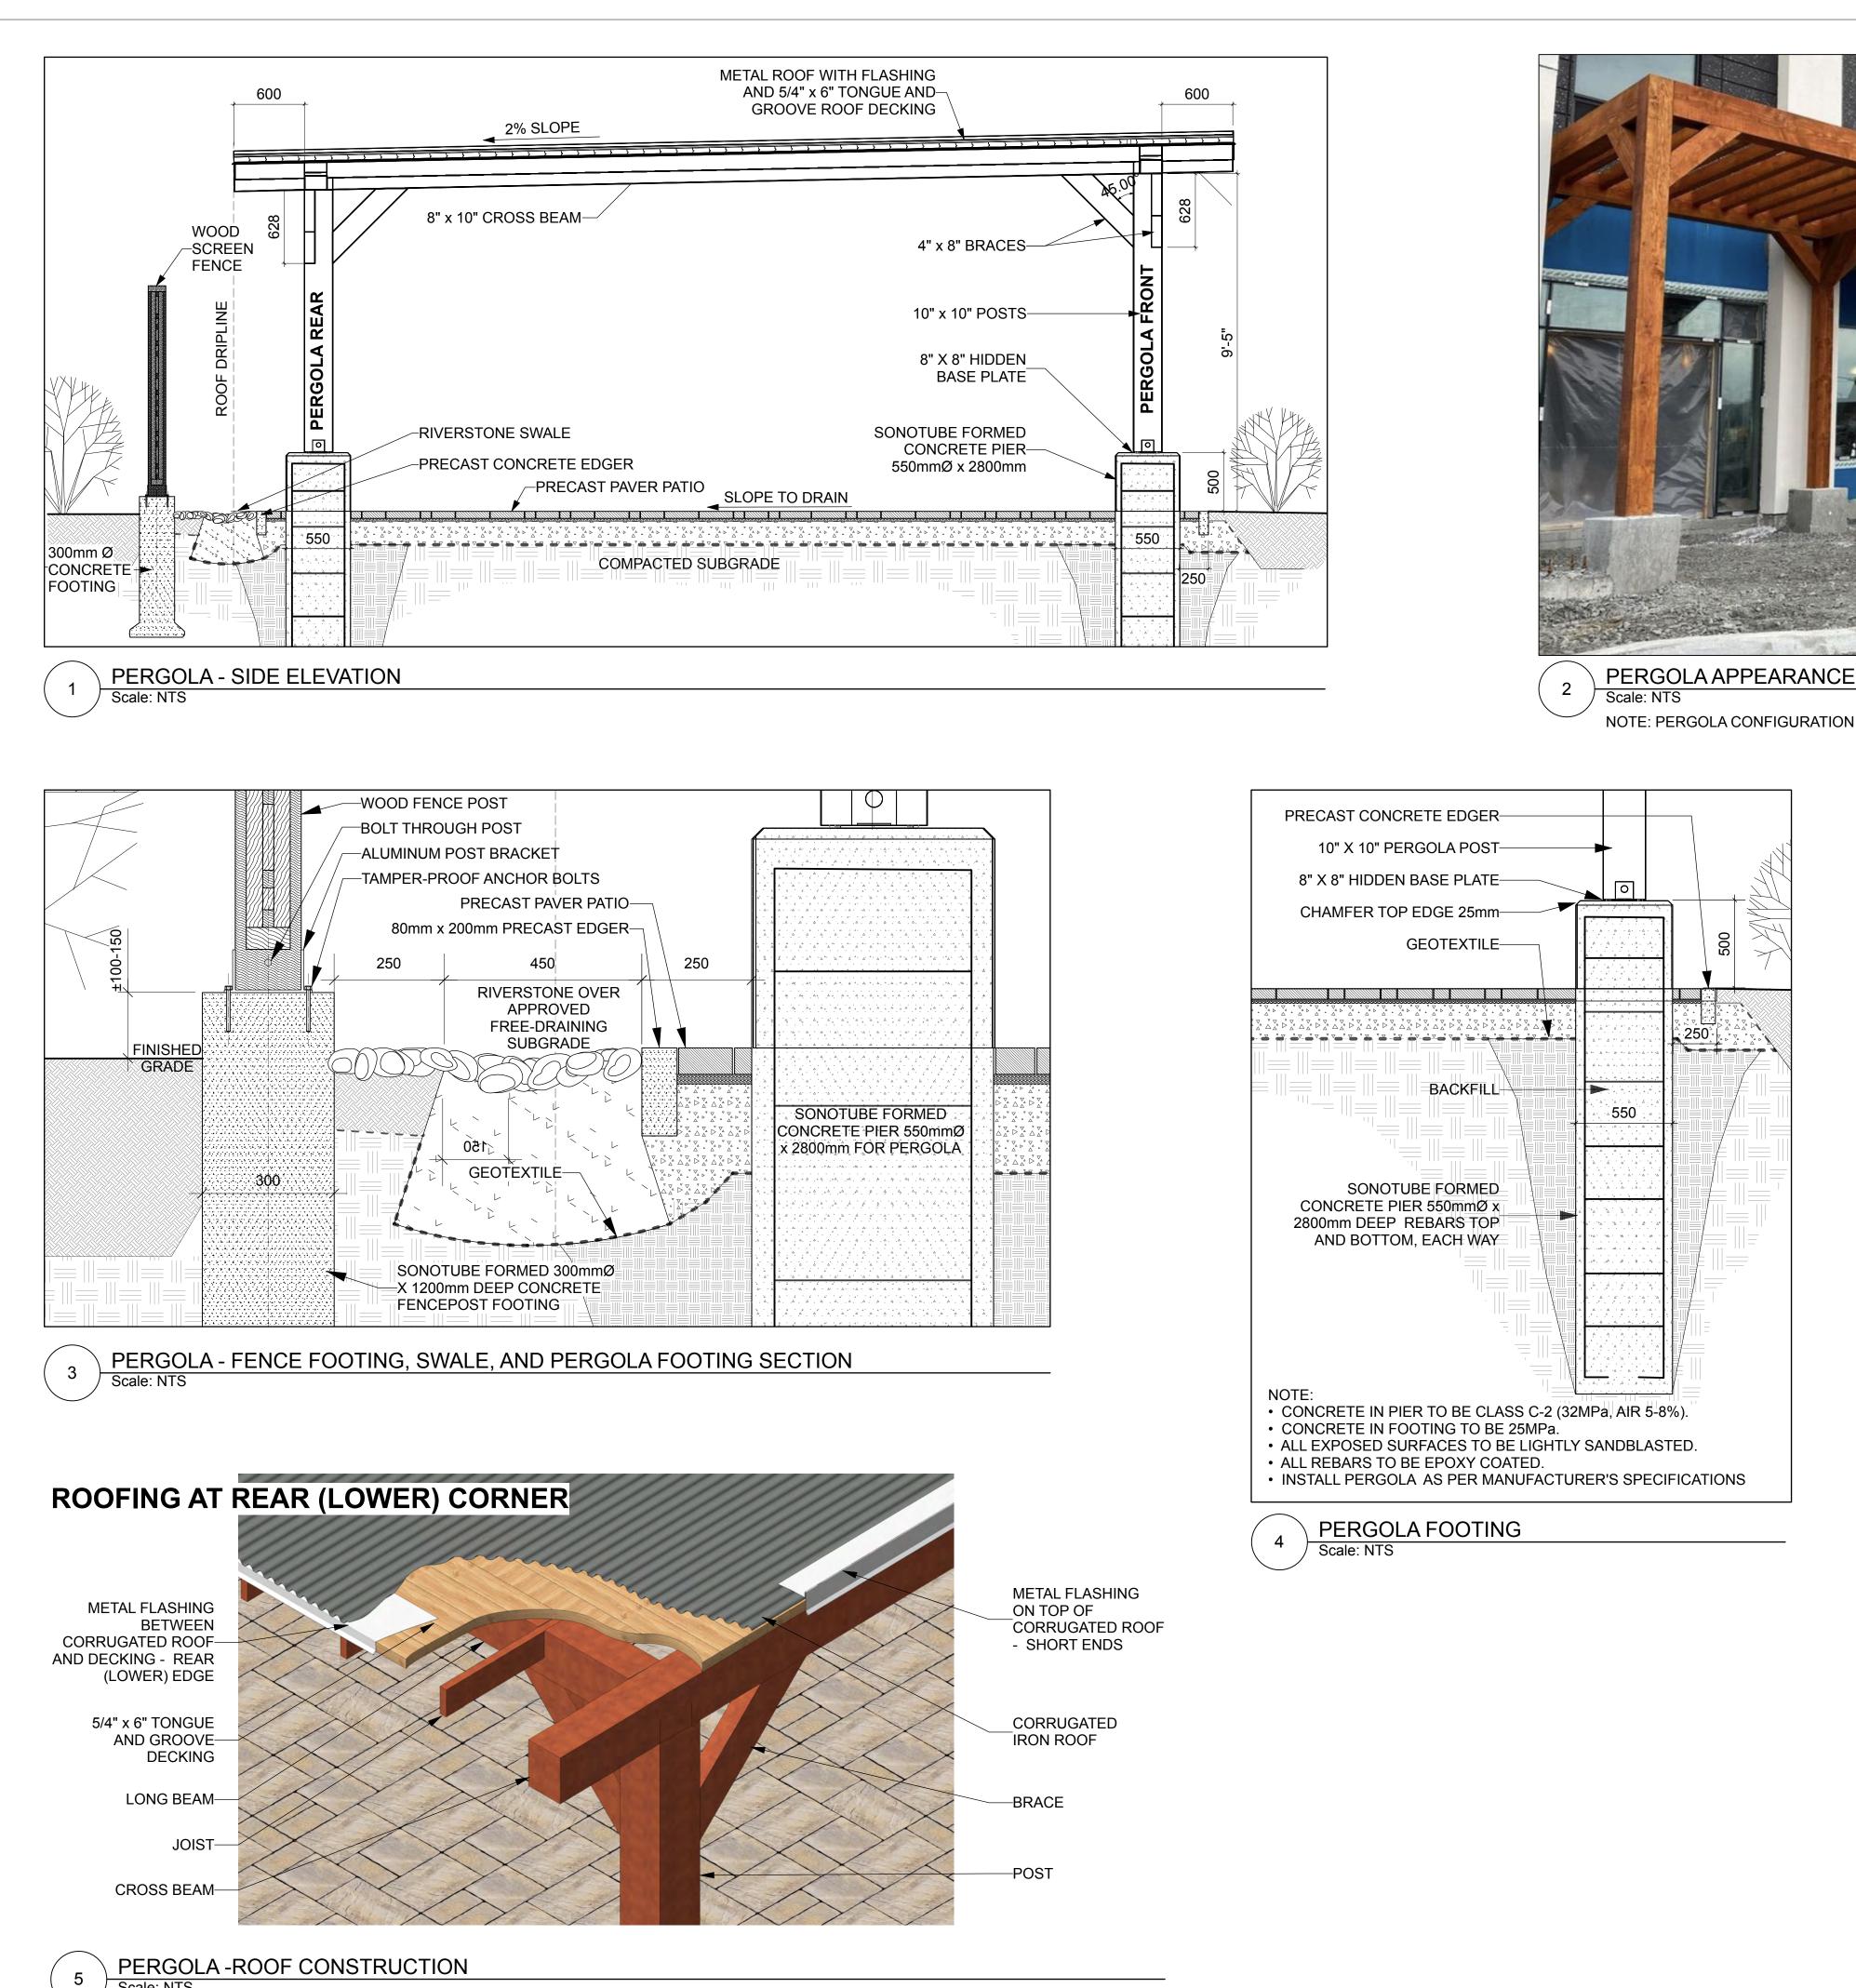

Scale: NTS



NOTE: PERGOLA CONFIGURATION TO BE ADJUSTED ACCORDING TO SITE.

NOTE: DETAILS ARE SHOWN FOR DESIGN INTENT ONLY. PROVIDE FULL SHOP DRAWINGS, STAMPED BY A PROFESSIONAL ENGINEER LICENSED IN THE PROVINCE OF ONTARIO, FOR FOOTINGS, REBAR DIMENSIONS, ANCHORAGE SYSTEM, AND STRUCTURAL COMPONENTS.



GENERAL NOTES

.1 All general site information and conditions compiled from existing plans, surveys and consultant's field notes. Report all discrepancies prior to any work. No responsibility is born by the Consultant for unknown subsurface conditions.

.2 The location of the utilities is approximate only, and the exact location should be determined by consulting the municipal authorities and utility companies concerned. The Contractor shall prove the location of utilities and shall be responsible for adequate protection from damage.

.3 All dimensions shown are to be verified on site prior to any construction. No deviations are to be made from the layouts as shown on this plan without prior consultation with the Landscape Architect and Owner.

.4 Obtain approval of Landscape Architect for granular base and layout of all pavement areas prior to construction.

.5 Stake planting locations and receive approval of Landscape Architect, prior to excavation of any planting pits. No substitutions of plant material shall be made without prior approval of the Landscape Architect.

.6 Where clay is encountered proper drainage must be ensured in tree/shrub pits, prior to planting. Have method approved by Landscape Architect.

.7 All sodded areas to receive a minimum of 150mm of topsoil over graded sub-base. If sod with mesh is used, mesh to be removed completely during sodding operations. Sod shall come from an approved source and shall be laid within 24 hours of being cut in the nursery. Only nursery sod shall be used.

8 Final subgrade is to approved by the Landscape Architect prior to sod being laid.

.9 Maintain positive surface runoff through the entire construction period.

.10 Reinstate all areas and items damaged as a result of construction activities.

| 1 Issued for S | Site Plan Control | 2025-04-15 |
|--|---|---|
| 1 Issued for S | Site Plan Control | 2025-03-11 date |
| 200-1750 Cou | nd & Associa Irtwood Crescent, Ottawa, O x 222 F (613) 224-1131 info@rala | |
| F (015) 224-4/44 | | |
| architect | | |
| | ECTURE INC. Nor - Ottawa, Ontario, K1P 5N2 fax 613.224.9811 | |
| surveyor | 1755 WOODWARD DRIVE, OT TEL: (613) 800-1583 | Canada Land Surveyor |
| | //I=CH | NOVATECH 240 MICHAEL COWPLAND DRIV SUITE 200 OTTAWA, ON, K2M 1F 17: 613.254.9643 |
| | nical engineer | STANTEC |
| | Stantec | • • • • • • • • |
| | | F: 613.738.6070 |
| CARPENT | ERS DISTRICT RIO LOCAL 93 | |
| CARPENT OF ONTAR ADDITION CAMPEAU DRIVE OTTAWA, ON | ERS DISTRICT RIO LOCAL 93 | OF LANDER |
| CARPENT OF ONTAR ADDITION CAMPEAU DRIVE OTTAWA, ON | ERS DISTRICT RIO LOCAL 93. | OF LANORON |
| CARPENT CAMPEAU DRIVE OTTAWA, ON north | ERS DISTRICT RIO LOCAL 93 | OF LANDER A RUMANA |
| CARPENT CARPENTION CAMPEAU DRIVE OTTAWA, ON north | ERS DISTRICT RIO LOCAL 93. | AILS |
| CARPENT CARPENT CAMPEAU DRIVE OTTAWA, ON north drawing title PEE scale | ERS DISTRICT RIO LOCAL 93. | AILS |
| CARPENT CARPENT CAMPEAU DRIVE OTTAWA, ON north drawing title PEE scale | ERS DISTRICT RIO LOCAL 93. | AILS |
| CARPENT CARPENTION CAMPEAU DRIVE OTTAWA, ON north drawing title Excale scale date 2023 06 09 | ERS DISTRICT RIO LOCAL 93. | AILS |
| CARPENTION CAMPEAU DRIVE OTTAWA, ON north drawing title scale date 2023 06 09 project number N45 23-790 | ERS DISTRICT NO LOCAL 93 | AILS |
| CARPENTION CAMPEAU DRIVE OTTAWA, ON north drawing title Excale scale date 2023 06 09 project number | ERS DISTRICT NO LOCAL 93 | AILS |