



REFER TO NOTES & DETAILS
ON DRAWINGS C-2 & C-4

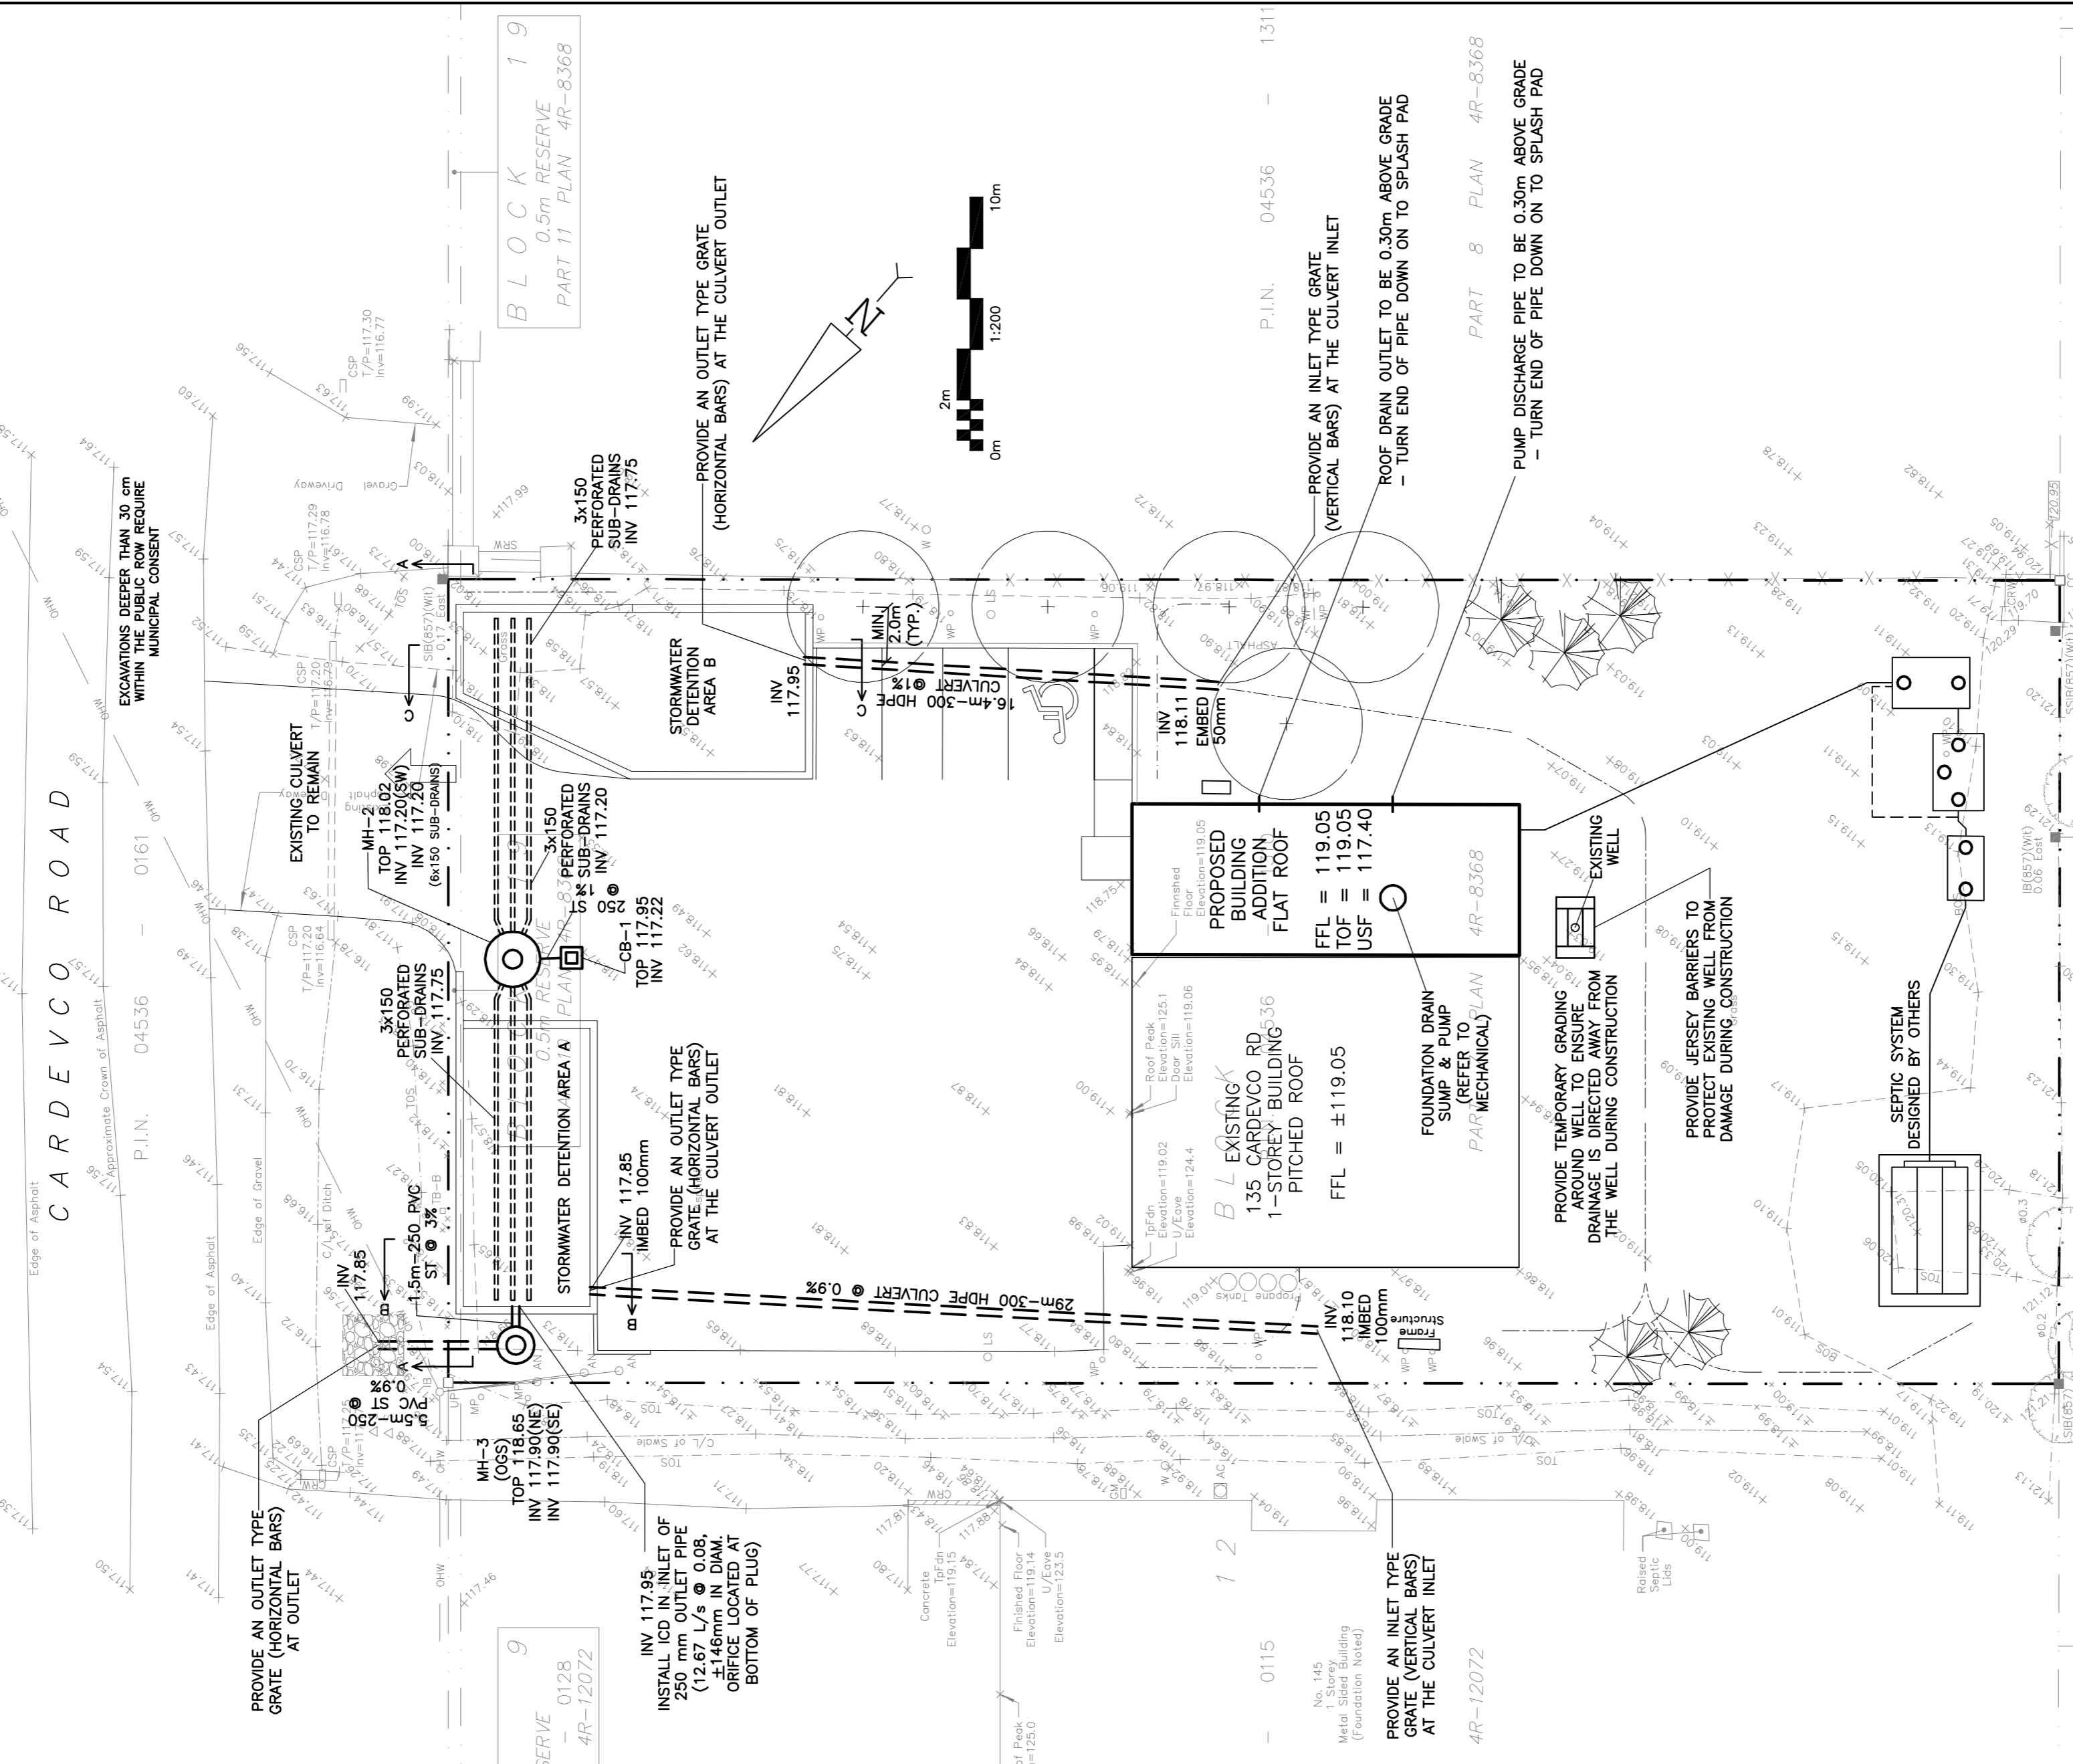

REFER TO NOTES & DETAILS
ON DRAWINGS C-2 & C-4

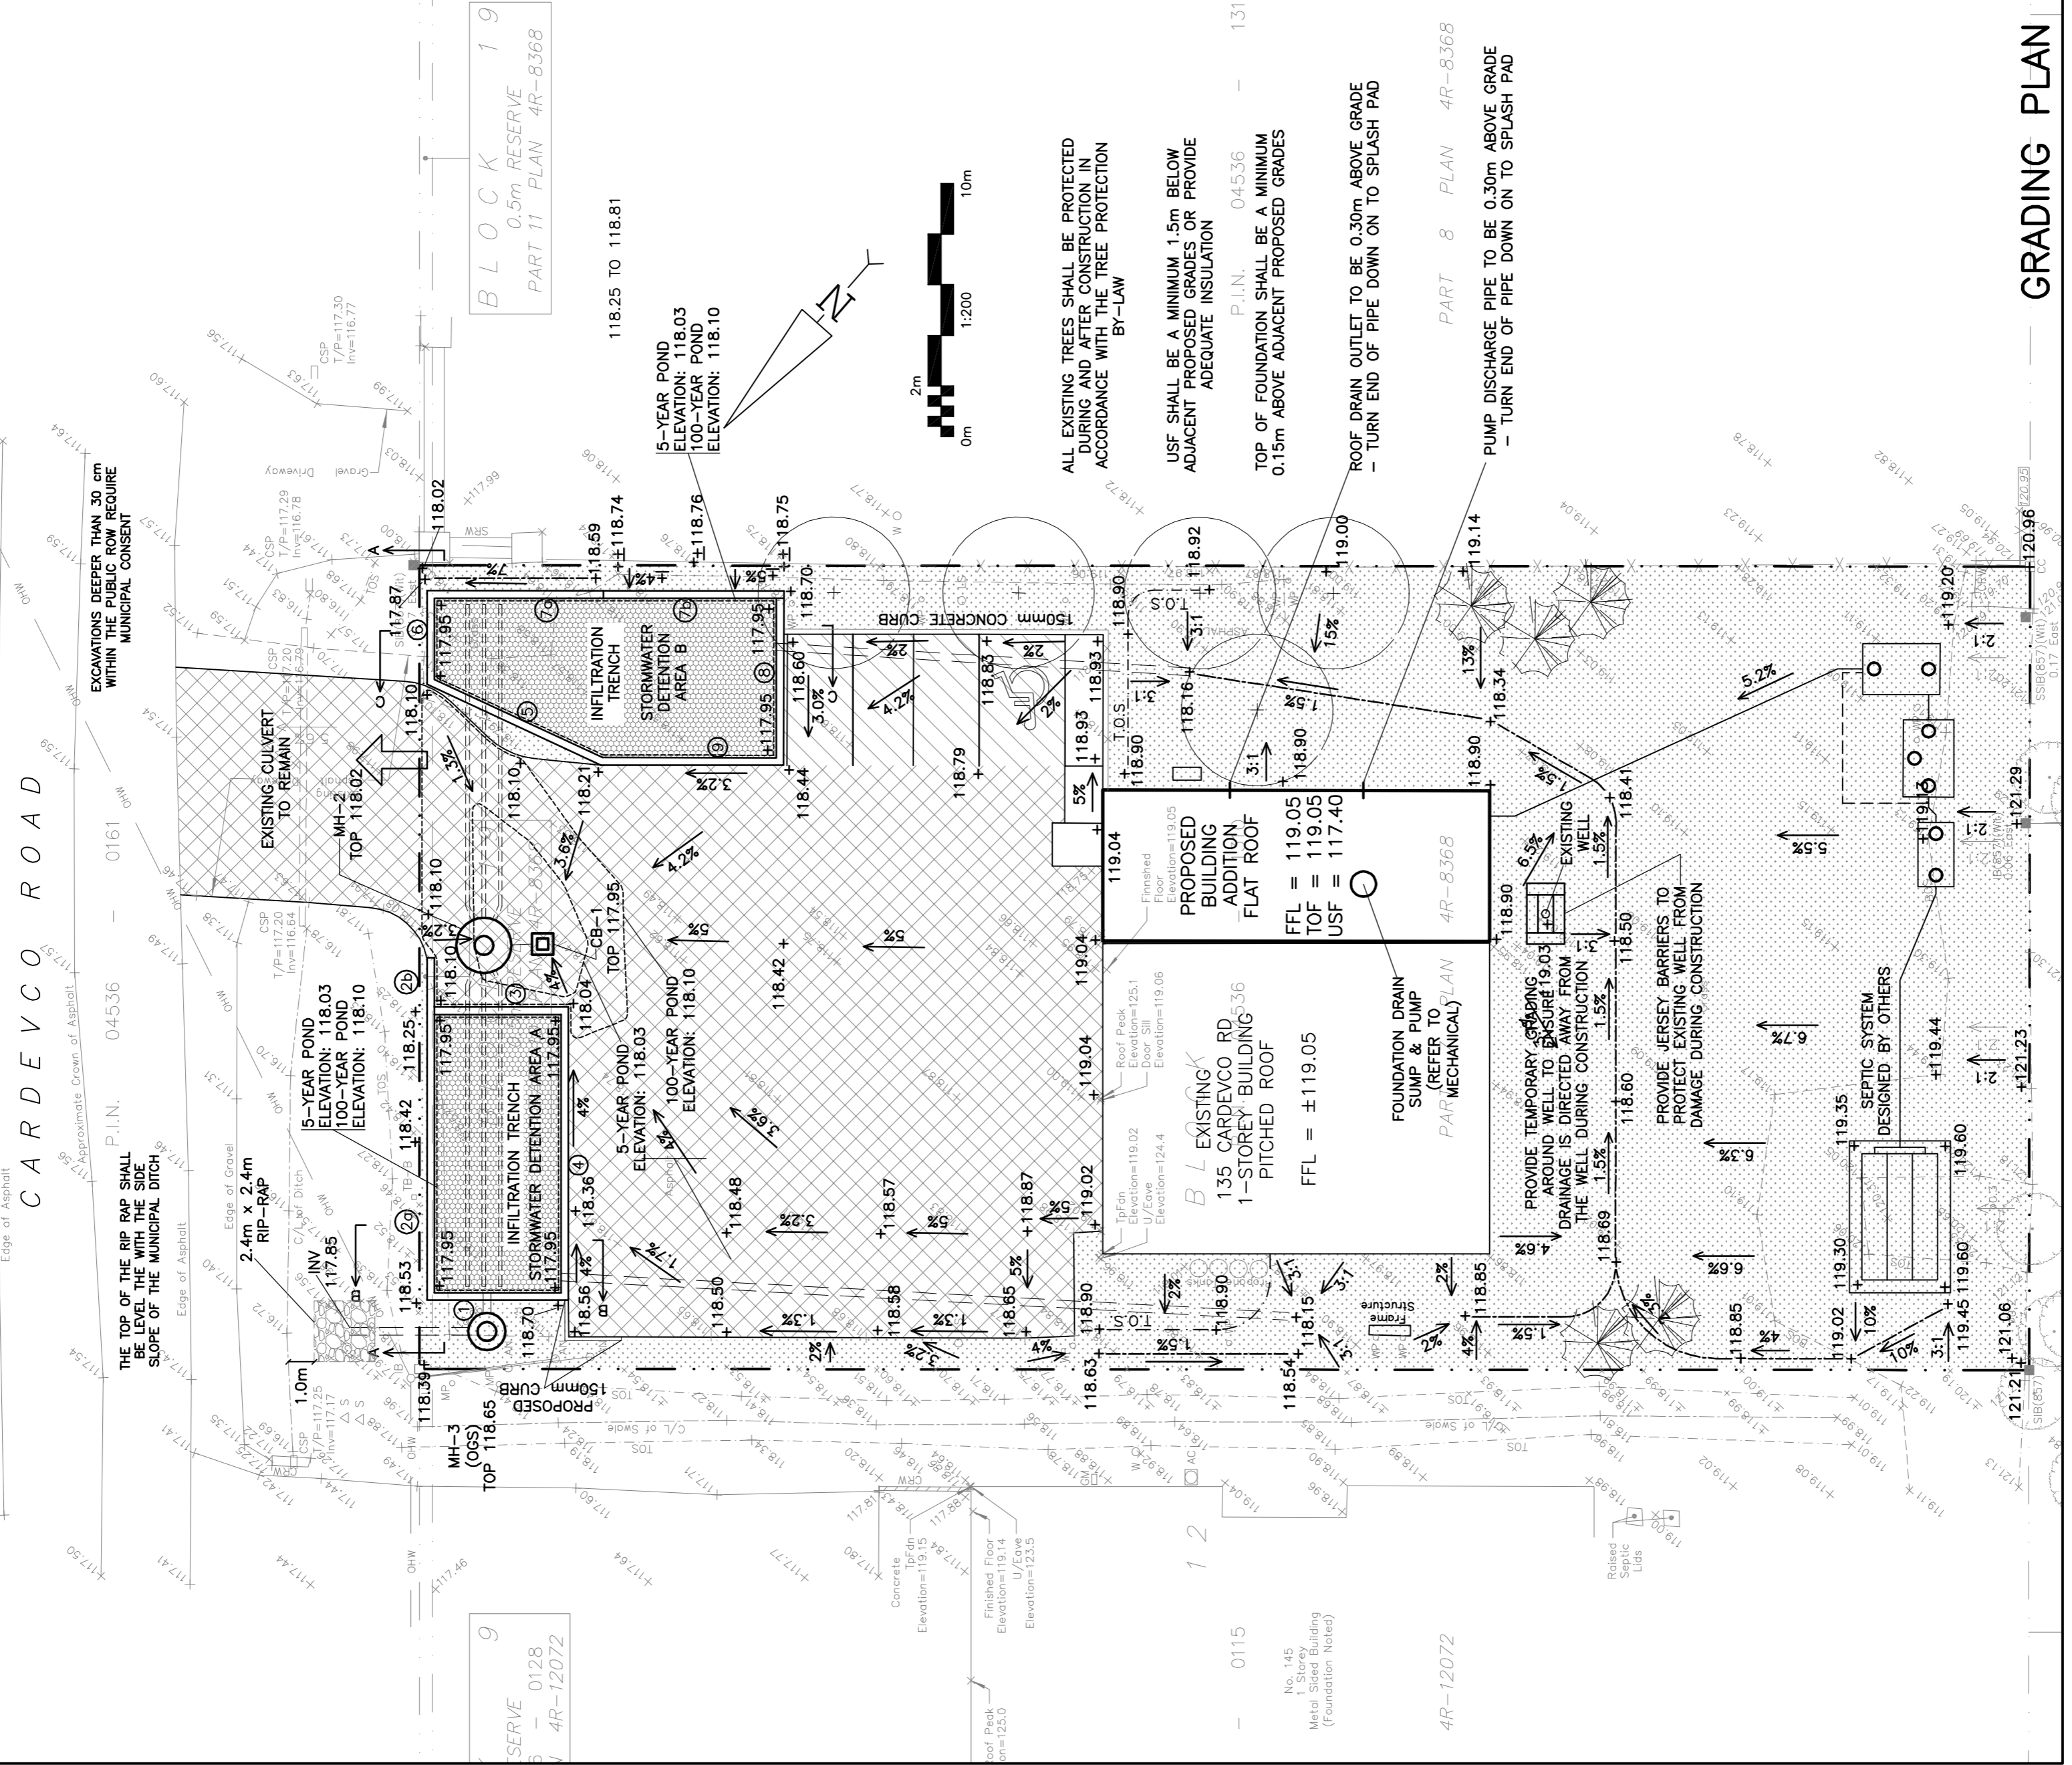

RETAINING WALL SCHEDULE


REF	TOP OF WALL	BOTTOM OF WALL	HEIGHT	NOTES	REF	TOP OF WALL	BOTTOM OF WALL	HEIGHT	NOTES
①	118.85 TO 118.68	117.95	0.90m TO 0.73m	TOP OF WALL TO BE 0.15m ABOVE PROPOSED GRADE DESIGNED BY STRUCTURAL	⑥	118.36 TO 118.25	117.95	0.41m TO 0.30m	TOP OF WALL TO BE 0.15m ABOVE PROPOSED GRADE DESIGNED BY STRUCTURAL
②	118.68 TO 118.40	117.95	0.73m TO 0.45m	TOP OF WALL TO BE 0.15m ABOVE PROPOSED GRADE DESIGNED BY STRUCTURAL	⑦	118.25	117.95	0.30m	TOP OF WALL TO BE 0.15m ABOVE PROPOSED GRADE DESIGNED BY STRUCTURAL
③	118.40 TO 118.25	118.10	0.30m TO 0.15m	ABOVE PROPOSED GRADE DESIGNED BY STRUCTURAL	⑧	118.25 TO 118.81	117.95	0.30m TO 0.86m	ABOVE PROPOSED GRADE DESIGNED BY STRUCTURAL
④	118.25 TO 118.19	117.95	0.30m TO 0.24m	ABOVE PROPOSED GRADE DESIGNED BY STRUCTURAL	⑨	118.70	117.95	0.71m TO 0.75m	TOP OF WALL TO BE 0.15m ABOVE PROPOSED GRADE DESIGNED BY STRUCTURAL
⑤	118.19 TO 118.85	117.95	0.24m TO 0.90m	TOP OF WALL TO BE 0.15m ABOVE PROPOSED GRADE DESIGNED BY STRUCTURAL	⑩	118.85 TO 118.59	117.95	0.90m TO 0.64m	TOP OF WALL TO BE 0.15m ABOVE PROPOSED GRADE DESIGNED BY STRUCTURAL
					⑪	118.59 TO 118.36	117.95	0.64m TO 0.41m	TOP OF WALL TO BE 0.15m ABOVE PROPOSED GRADE DESIGNED BY STRUCTURAL

GRADING PLAN

PART 12 PLAN 4R-7616

LEGEND

FL	FINISHED FLOOR ELEVATION
TOF	TOP OF FOUNDATION
USF	UNDERSIDE OF FOOTING
- - -	PROPERTY LINE
CB	CATCH-BASIN
MH	STORM MANHOLE
ST	STORM SEWER
INV	INVERT OF PIPE
+	EXISTING GRADE ELEVATION
199.99	PROPOSED GRADE ELEVATION
Z%	EXISTING SLOPE OF GRADE
Z%	PROPOSED SLOPE OF GRADE
↑	EMERGENCY OVERLAND FLOW
T.O.S	TOP OF SLOPE
B.O.S	BOTTOM OF SLOPE
---	CENTELINE OF SWALE
.....	SILT FENCE BARRIER
○	ROOF DRAIN
▨	LIGHT-DUTY PAVEMENT
▩	HEAVY-DUTY PAVEMENT
.....	LANDSCAPE

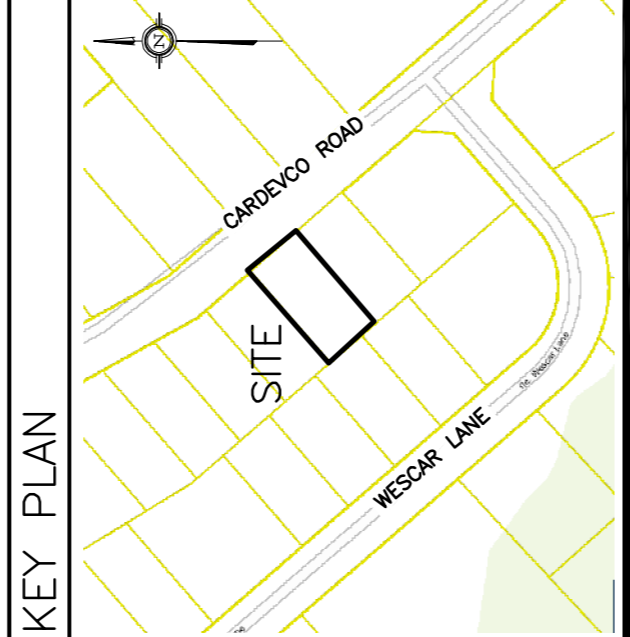

No.	DATE	REVISION
7	MAR 25-25	RE-ISSUED FOR APPROVAL
6	FEB 10-25	RE-ISSUED FOR APPROVAL
5	OCT 11-24	RE-ISSUED FOR APPROVAL
4	JUN 9-23	RE-ISSUED FOR APPROVAL
3	NOV 24-22	ISSUED FOR APPROVAL
2	NOV 15-22	ISSUED FOR COORDINATION
1	SEP 12-22	PRELIMINARY

D. B. GRAY ENGINEERING INC.
 Structural Management Consulting & Engineering
 700 Long Point Circle
 Ottawa, Ontario K1L 3B3
 613-425-8044
 d.gray@dbgrayengineering.com

PROPOSED ADDITION
 135 CARDEVCO ROAD
 OTTAWA, ONTARIO

SITE SERVICING PLAN & GRADING PLAN

Professional Engineer
 License No. 17018502
 Exp. Date: MAR 25-25

NOT VALID UNLESS SIGNED & DATED

Drawing No. **C-1**
 of **4**

Drawn: D.B.G.
 H. Scale: 1:200
 V. Scale: 1:200
 Date: SEP 12-22
 Job No.: 21081