ELEVATION	UNPROTECTED OPENINGS	EXPOSED BUILDING FACE	RATIO	SETBACK	MAX EBO 9.10.14.4(1)(a)	MAX EBO 9.10.14.4(1)(c)	MAX RATIO 9.10.14.4(1)(c)	CONSTRUCTION
FRONT	48.83 m²	123.42 m²	39.56%	14.22 m	67.88 m²	202.21 m <sup>2</sup>	55%	COMBUSTABLE CONSTRUCTION & CLADDING PERMITTED, 45 MIN FRR MIN
LEFT	11.38 m²	214.47 m²	5.30%	1.20 m	15.01 m <sup>2</sup>	1.44 m²	7%	NON-COMBUSTABLE CONSTRUCTION & CLADDING REQ'D, 1 HR FRR
REAR	52.95 m²	123.42 m²	42.90%	7.50 m	23.45 m²	56.25 m <sup>2</sup>	19%	COMBUSTABLE CONSTRUCTION PERMITTED, NON-COMBUSTABLE CLADDING REQ'D, 1 HR FRR MIN
RIGHT	15.61 m²	214.47 m²	7.28%	1.20 m	15.01 m <sup>2</sup>	1.44 m²	7%	NON-COMBUSTABLE CONSTRUCTION & CLADDING REQ'D, 1 HR FRR

NOTE:
• FOR REAR ELEVATION REFER TO A2.3 FOR LIMITING DISTANCE CALC WITH

ACCESSORY BUILDING (UNIT 002/102) VS REMAINING EBO
• FOR RIGHT ELEVATION REFER TO A2.4 FOR LIMITING DISTANCE CALC BY FIRE COMPARTMENT AS PER 9.10.14.2.1.(ii)



MATERIALS

BRICK VANEER CONCRETE PARDGING

CMP HARDIEPLANK SIDING BY JAMES HARDIE

GZG 42" GLASS GAURD

MBM METAL FRAMED BALCONY C/W WIRE SUPPORT @ 2ND AND 3RD FLOOR MF+MS METAL FLASHING/EAVESTROUGH, & METAL

MLR METAL ROOFING

MTL METAL SIDING OSG 60" HIGH OPAQUE SCREEN GUARD

# j. guy monette architecture and urban design

308a fairmont ave. 613.859.6483

ottawa, on, K1Y 1Y8 guymonette@rogers.com

4.1	FEB 25 2025
N 3.0	DEC 26 2024
2.1	DEC 17 2024
1.0	DEC 16 2024
No	DATE
	N 3.0 2.1 1.0

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370 ATHLONE AVE OTTAWA, ON

PROPOSED 16 UNIT APARTMENT

## **EAST ELEVATION**

DESIGNED: JASON GRANT-HENLEY

DRAWN: CHLOE CREW APPROVED: GUY MONETTE

FOR SITE PLAN CONTROL

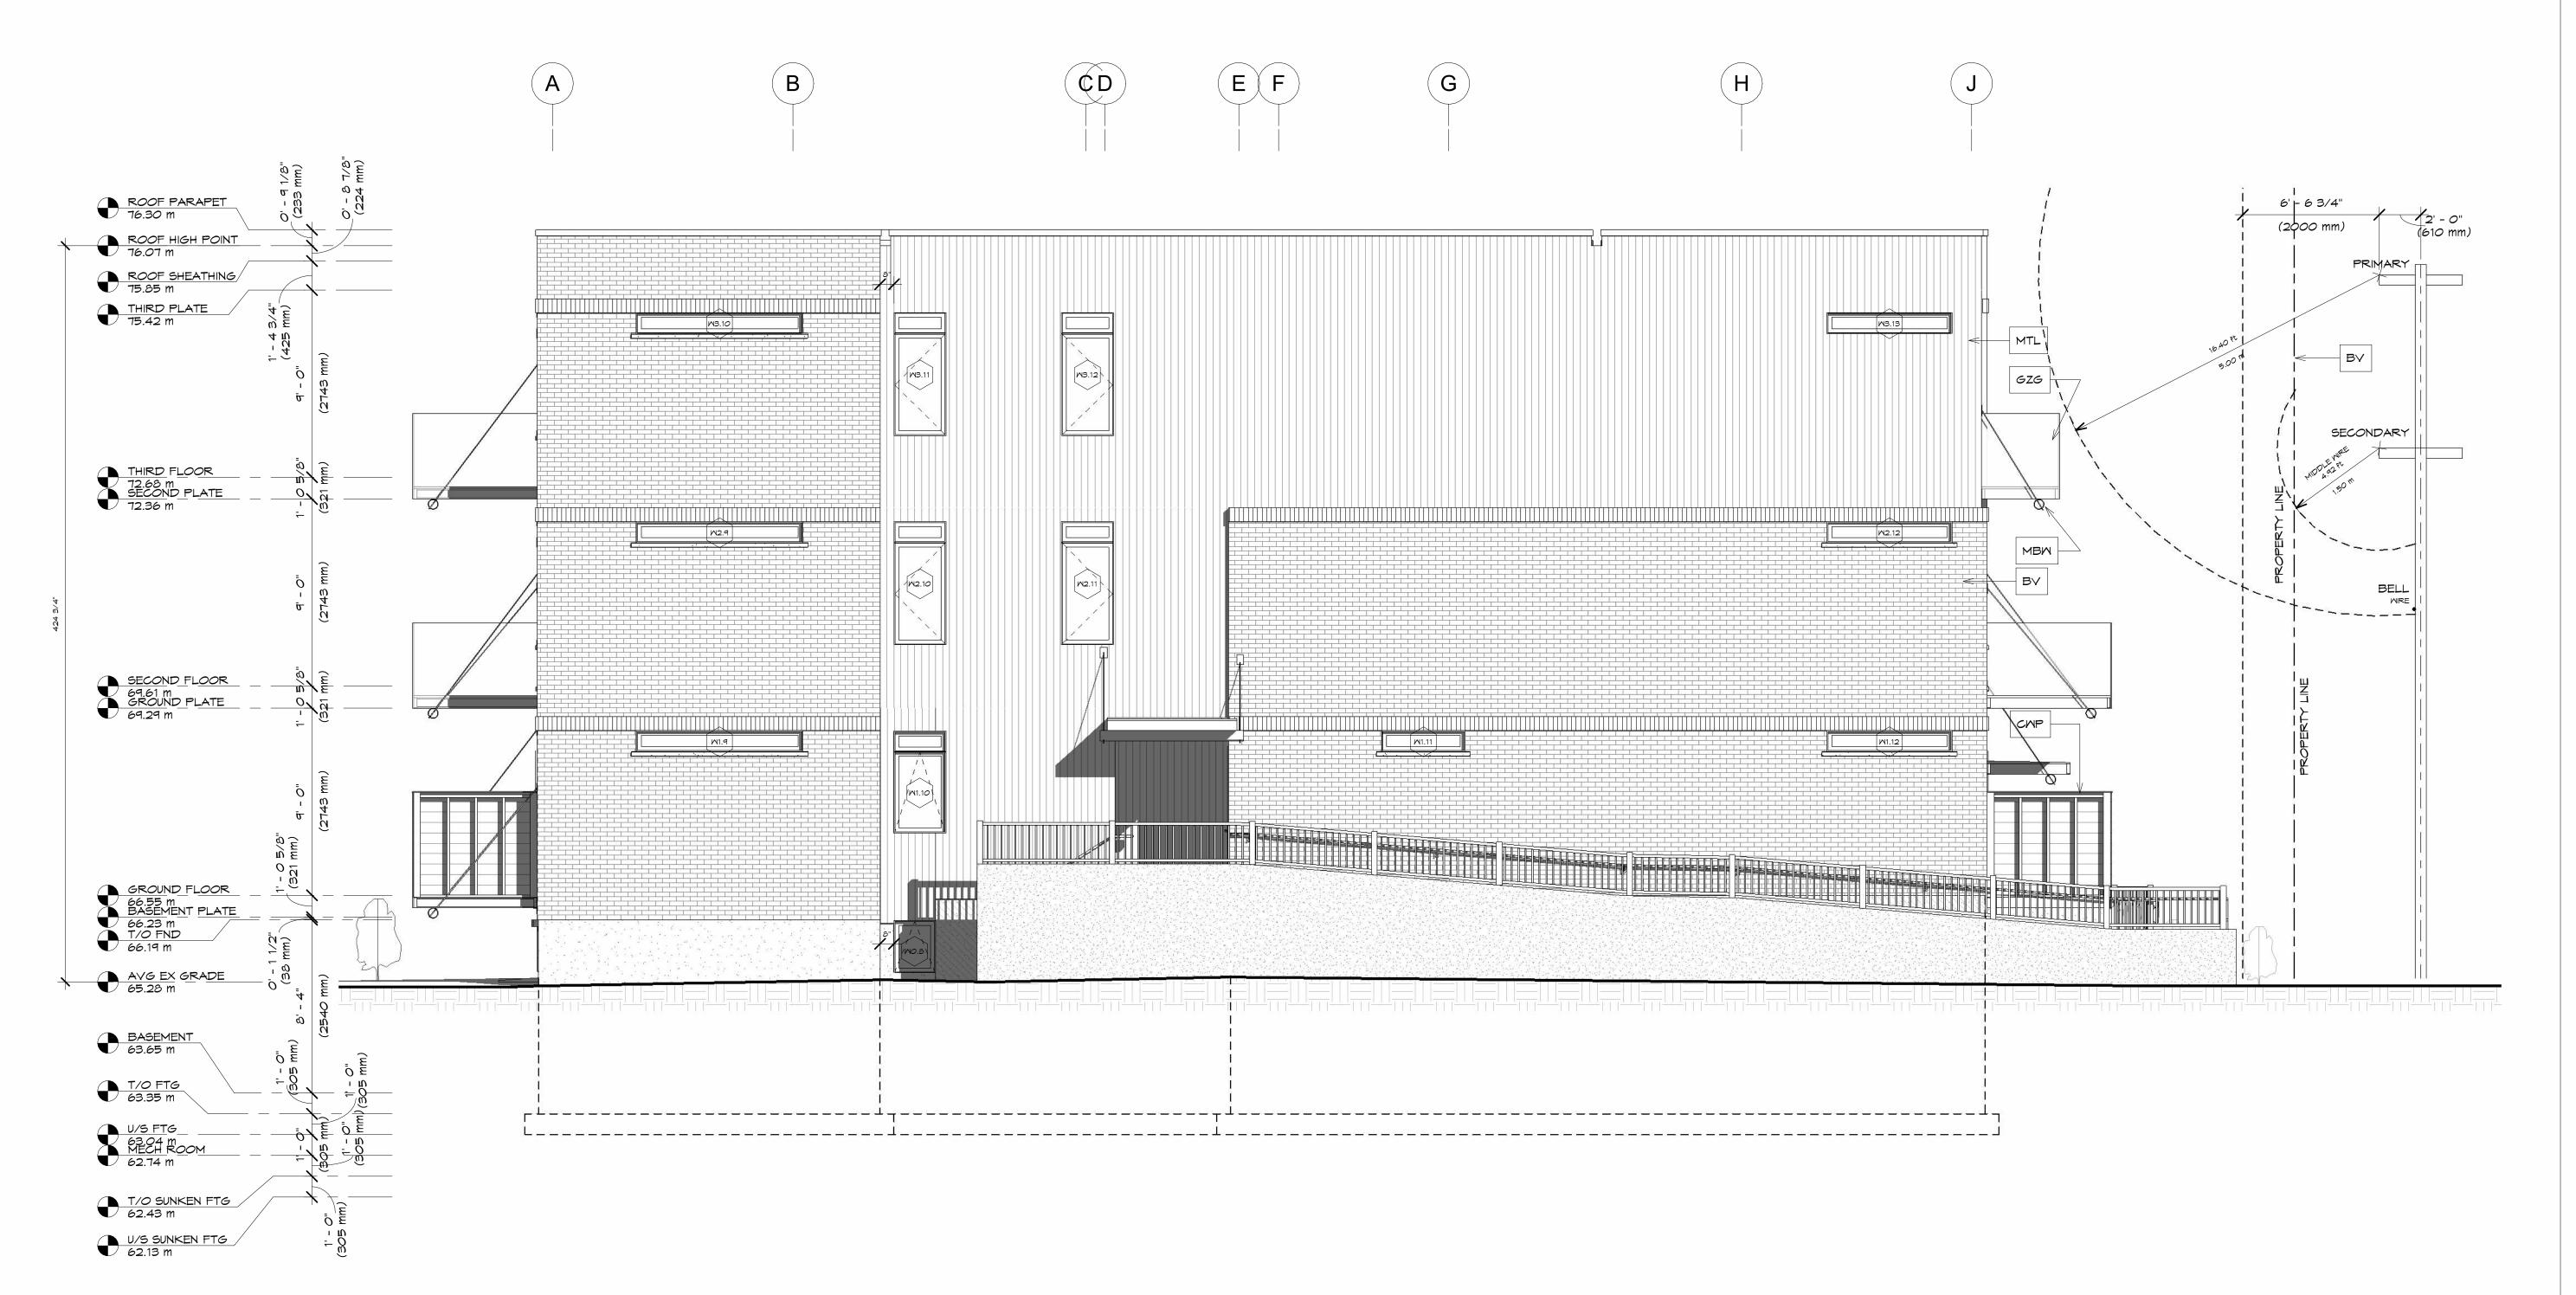
FILE NUMBER: D07-12-24-0114 SCALE: 3/8" = 1'-0" PLAN NUMBER: #19203

ELEVATION	UNPROTECTED OPENINGS	EXPOSED BUILDING FACE	RATIO	SETBACK	MAX EBO 9.10.14.4(1)(a)	MAX EBO 9.10.14.4(1)(c)	MAX RATIO 9.10.14.4(1)(c)	CONSTRUCTION
FRONT	48.83 m²	123.42 m²	39.56%	14.22 m	67.88 m²	202.21 m <sup>2</sup>	55%	COMBUSTABLE CONSTRUCTION & CLADDING PERMITTED, 45 MIN FRR MIN
LEFT	11.38 m²	214.47 m²	5.30%	1.20 m	15.01 m²	1.44 m²	7%	NON-COMBUSTABLE CONSTRUCTION & CLADDING REQ'D, 1 HR FRR
REAR	52.95 m²	123.42 m²	42.90%	7.50 m	23.45 m <sup>2</sup>	56.25 m²	19%	COMBUSTABLE CONSTRUCTION PERMITTED, NON-COMBUSTABLE CLADDING REQ'D, 1 HR FRR MIN
RIGHT	15.61 m²	214.47 m²	7.28%	1.20 m	15.01 m²	1.44 m²	7%	NON-COMBUSTABLE CONSTRUCTION & CLADDING REQ'D, 1 HR FRR

NOTE:
• FOR REAR ELEVATION REFER TO A2.3 FOR LIMITING DISTANCE CALC WITH ACCESSORY BUILDING (UNIT 002/102) VS REMAINING EBO
• FOR RIGHT ELEVATION REFER TO A2.4 FOR LIMITING DISTANCE CALC BY FIRE COMPARTMENT AS PER 9.10.14.2.1.(ii)

ELEVATION	UNPROTECTED OPENINGS	EXPOSED BUILDING FACE	RATIO	SETBACK	MAX EBO 9.10.14.4(1)(a)	MAX EBO 9.10.14.4(1)(c)	MAX RATIO 9.10.14.4(1)(c)	CONSTRUCTION
FRONT	48.83 m²	123.42 m²	39.56%	14.22 m	67.88 m²	202.21 m <sup>2</sup>	55%	COMBUSTABLE CONSTRUCTION & CLADDING PERMITTED, 45 MIN FRR MIN
LEFT	11.38 m²	214.47 m²	5.30%	1.20 m	15.01 m²	1.44 m²	7%	NON-COMBUSTABLE CONSTRUCTION & CLADDING REQ'D, 1 HR FRR
REAR	52.95 m <sup>2</sup>	123.42 m²	42.90%	7.50 m	23.45 m²	56.25 m²	19%	COMBUSTABLE CONSTRUCTION PERMITTED, NON-COMBUSTABLE CLADDING REQ'D, 1 HR FRR MIN
RIGHT	15.61 m²	214.47 m²	7.28%	1.20 m	15.01 m²	1.44 m²	7%	NON-COMBUSTABLE CONSTRUCTION & CLADDING REQ'D, 1 HR FRR

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BUILDING PERMIT APPLICATI	ON	3.0	DEC 26 2024			
ISSUED FOR FINAL REVIEW		2.1	DEC 17 2024			
ISSUED FOR MECH REVIEW		1.0	DEC 16 2024			
REVISION		No	DATE			
SEAL						
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All Contractors must comply with laws.	h all p	ertinent (	codes and by-			
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PERMIT: CITY COMMENTS

4.1 FEB 25 2025

## **SOUTH ELEVATION**

DESIGNED	2: JASON GRANT-HENLEY
DRAWN:	CHLOE CREW

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OTTAWA, ON

370 ATHLONE AVE

PROPOSED 16 UNIT APARTMENT

A2.2 APPROVED: GUY MONETTE SCALE: 1/4" = 1'-0"

FOR SITE PLAN CONTROL

FILE NUMBER: D07-12-24-0114 PLAN NUMBER: #19203

MATERIALS BRICK VANEER CONCRETE PARDGING HARDIEPLANK SIDING BY JAMES HARDIE GZG 42" GLASS GAURD METAL FRAMED BALCONY C/W WIRE SUPPORT @ 2ND AND 3RD FLOOR MF+MS METAL FLASHING/EAVESTROUGH, & METAL SOFFIT MLR METAL ROOFING MTL METAL SIDING OSG 60" HIGH OPAQUE SCREEN GUARD

ELEVATION	UNPROTECTED OPENINGS	EXPOSED BUILDING FACE	RATIO	SETBACK	MAX EBO 9.10.14.4(1)(a)	MAX EBO 9.10.14.4(1)(c)	MAX RATIO 9.10.14.4(1)(c)	CONSTRUCTION
FRONT	48.83 m²	123.42 m²	39.56%	14.22 m	67.88 m²	202.21 m <sup>2</sup>	55%	COMBUSTABLE CONSTRUCTION & CLADDING PERMITTED, 45 MIN FRR MIN
LEFT	11.38 m²	214.47 m²	5.30%	1.20 m	15.01 m²	1.44 m²	7%	NON-COMBUSTABLE CONSTRUCTION & CLADDING REQ'D, 1 HR FRR
REAR	52.95 m²	123.42 m²	42.90%	7.50 m	23.45 m²	56.25 m²	19%	COMBUSTABLE CONSTRUCTION PERMITTED, NON-COMBUSTABLE CLADDING REQ'D, 1 HR FRR MIN
RIGHT	15.61 m²	214.47 m²	7.28%	1.20 m	15.01 m²	1.44 m²	7%	NON-COMBUSTABLE CONSTRUCTION & CLADDING REQ'D, 1 HR FRR

NOTE:
• FOR REAR ELEVATION REFER TO A2.3 FOR LIMITING DISTANCE CALC WITH

ACCESSORY BUILDING (UNIT 002/102) VS REMAINING EBO

• FOR RIGHT ELEVATION REFER TO A2.4 FOR LIMITING DISTANCE CALC BY FIRE



MATERIALS

BRICK VANEER CONCRETE PARDGING

HARDIEPLANK SIDING BY JAMES HARDIE

42" GLASS GAURD METAL FRAMED BALCONY C/W WIRE

SUPPORT @ 2ND AND 3RD FLOOR MF+MS METAL FLASHING/EAVESTROUGH, & METAL

SOFFIT MLR METAL ROOFING

MTL METAL SIDING OSG 60" HIGH OPAQUE SCREEN GUARD

# j. guy monette architecture and urban design ottawa, on, K1Y 1Y8

guymonette@rogers.com

308a fairmont ave. 613.859.6483

PERMIT: CITY COMMENTS		4.1	FEB 25 2025
BUILDING PERMIT APPLICATION	N	3.0	DEC 26 2024
ISSUED FOR FINAL REVIEW	2.1	DEC 17 2024	
ISSUED FOR MECH REVIEW	1.0	DEC 16 2024	
REVISION		No	DATE
SEAL			

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370 ATHLONE AVE OTTAWA, ON

PROPOSED 16 UNIT APARTMENT

#### **WEST ELEVATION**

DESIGNED	. JASON C	JIVAINI -I ILINELI
DESIGNED	. 148081	GRANT-HENLEY

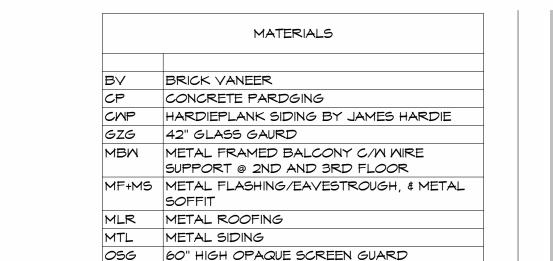
APPROVED: GUY MONETTE FILE NUMBER: D07-12-24-0114 SCALE: 3/8" = 1'-0" PLAN NUMBER: #19203

DRAWN: CHLOE CREW

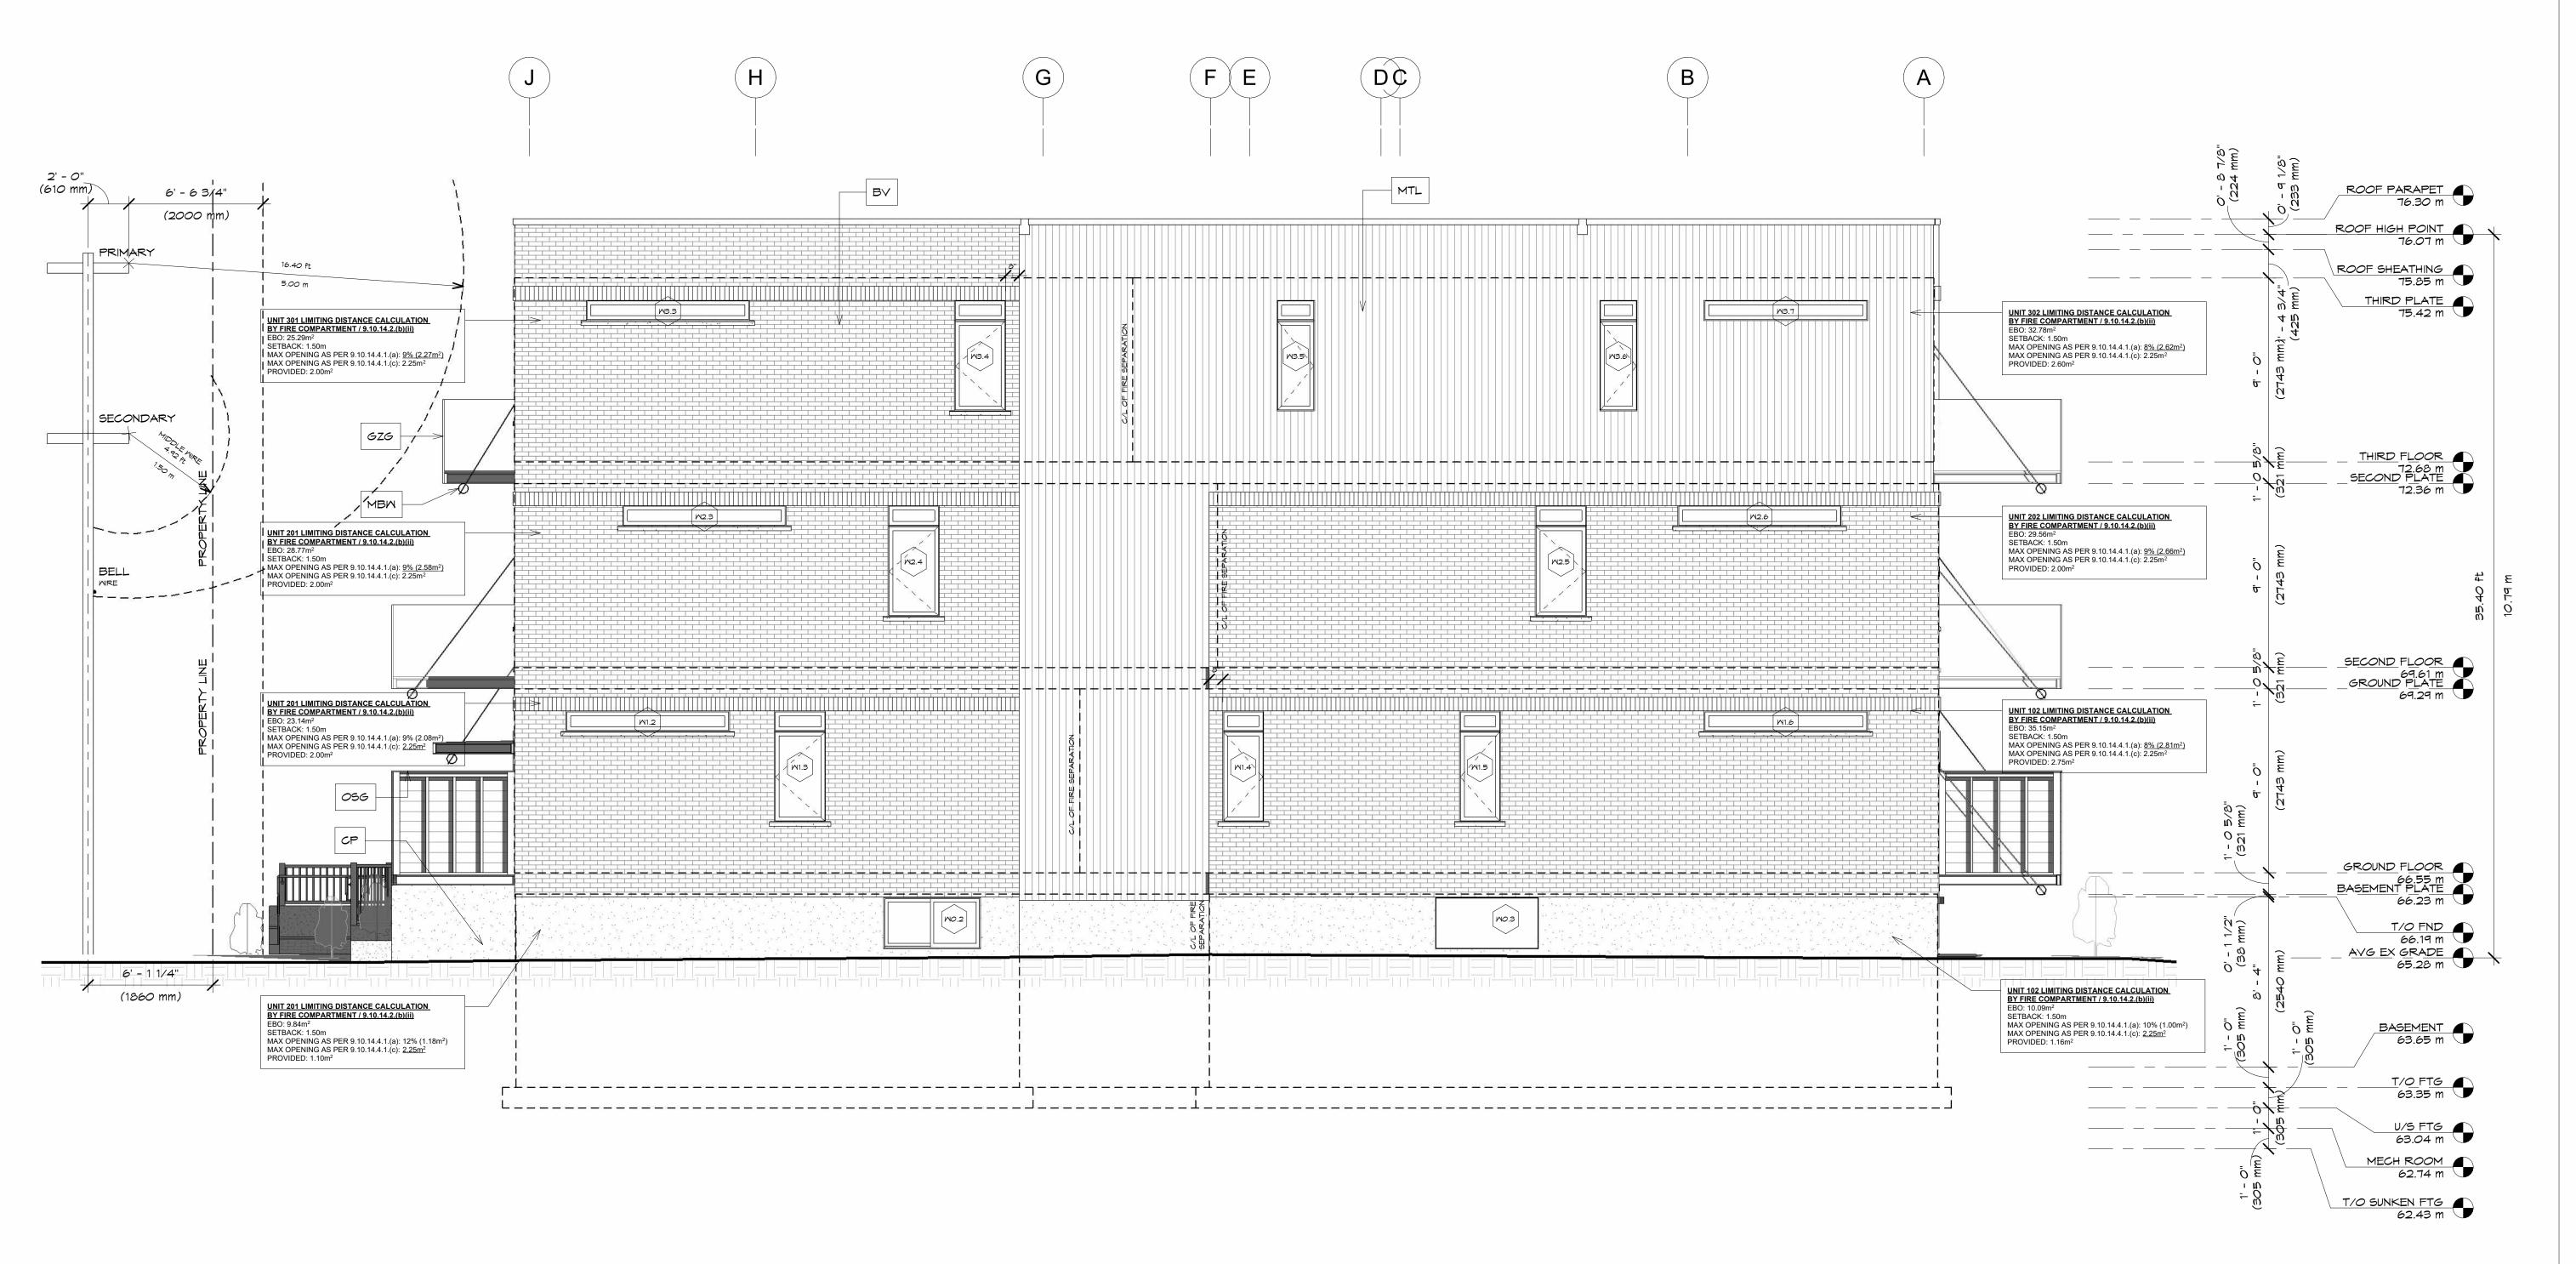
FOR SITE PLAN CONTROL

ELEVATION	UNPROTECTED OPENINGS	EXPOSED BUILDING FACE	RATIO	SETBACK	MAX EBO 9.10.14.4(1)(a)	MAX EBO 9.10.14.4(1)(c)	MAX RATIO 9.10.14.4(1)(c)	CONSTRUCTION
FRONT	48.83 m²	123.42 m²	39.56%	14.22 m	67.88 m²	202.21 m <sup>2</sup>	55%	COMBUSTABLE CONSTRUCTION & CLADDING PERMITTED, 45 MIN FRR MIN
LEFT	11.38 m²	214.47 m²	5.30%	1.20 m	15.01 m²	1.44 m²	7%	NON-COMBUSTABLE CONSTRUCTION & CLADDING REQ'D, 1 HR FRR
REAR	52.95 m <sup>2</sup>	123.42 m²	42.90%	7.50 m	23.45 m²	56.25 m²	19%	COMBUSTABLE CONSTRUCTION PERMITTED, NON-COMBUSTABLE CLADDING REQ'D, 1 HR FRR MIN
RIGHT	15.61 m²	214.47 m <sup>2</sup>	7.28%	1.20 m	15.01 m²	1.44 m²	7%	NON-COMBUSTABLE CONSTRUCTION & CLADDING REQ'D, 1 HR FRR

NOTE:
• FOR REAR ELEVATION REFER TO A2.3 FOR LIMITING DISTANCE CALC WITH



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ISSUED FOR FINAL REVIEW	2.1	DEC 17 2024			
ISSUED FOR MECH REVIEW	1.0	DEC 16 2024			
REVISION	No	DATE			
SEAL					
It is the responsibility of the appropriate Contractor to check and verify all dimensions on site and report all errors and/or omissions to the Architect.					
verify all dimensions on site and rep					
verify all dimensions on site and rep	ort all erro	rs and/or			
verify all dimensions on site and rep omissions to the Architect.  All Contractors must comply with all	ort all erro	rs and/or			

### **NORTH ELEVATION**

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370 ATHLONE AVE

PROPOSED 16 UNIT APARTMENT

DESIGNED: JASON GRANT-HENLEY DRAWN: CHLOE CREW APPROVED: GUY MONETTE

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OTTAWA, ON

SCALE: 1/4" = 1'-0" FOR SITE PLAN CONTROL

FILE NUMBER: D07-12-24-0114 PLAN NUMBER: #19203

ACCESSORY BUILDING (UNIT 002/102) VS REMAINING EBO

• FOR RIGHT ELEVATION REFER TO A2.4 FOR LIMITING DISTANCE CALC BY FIRE