
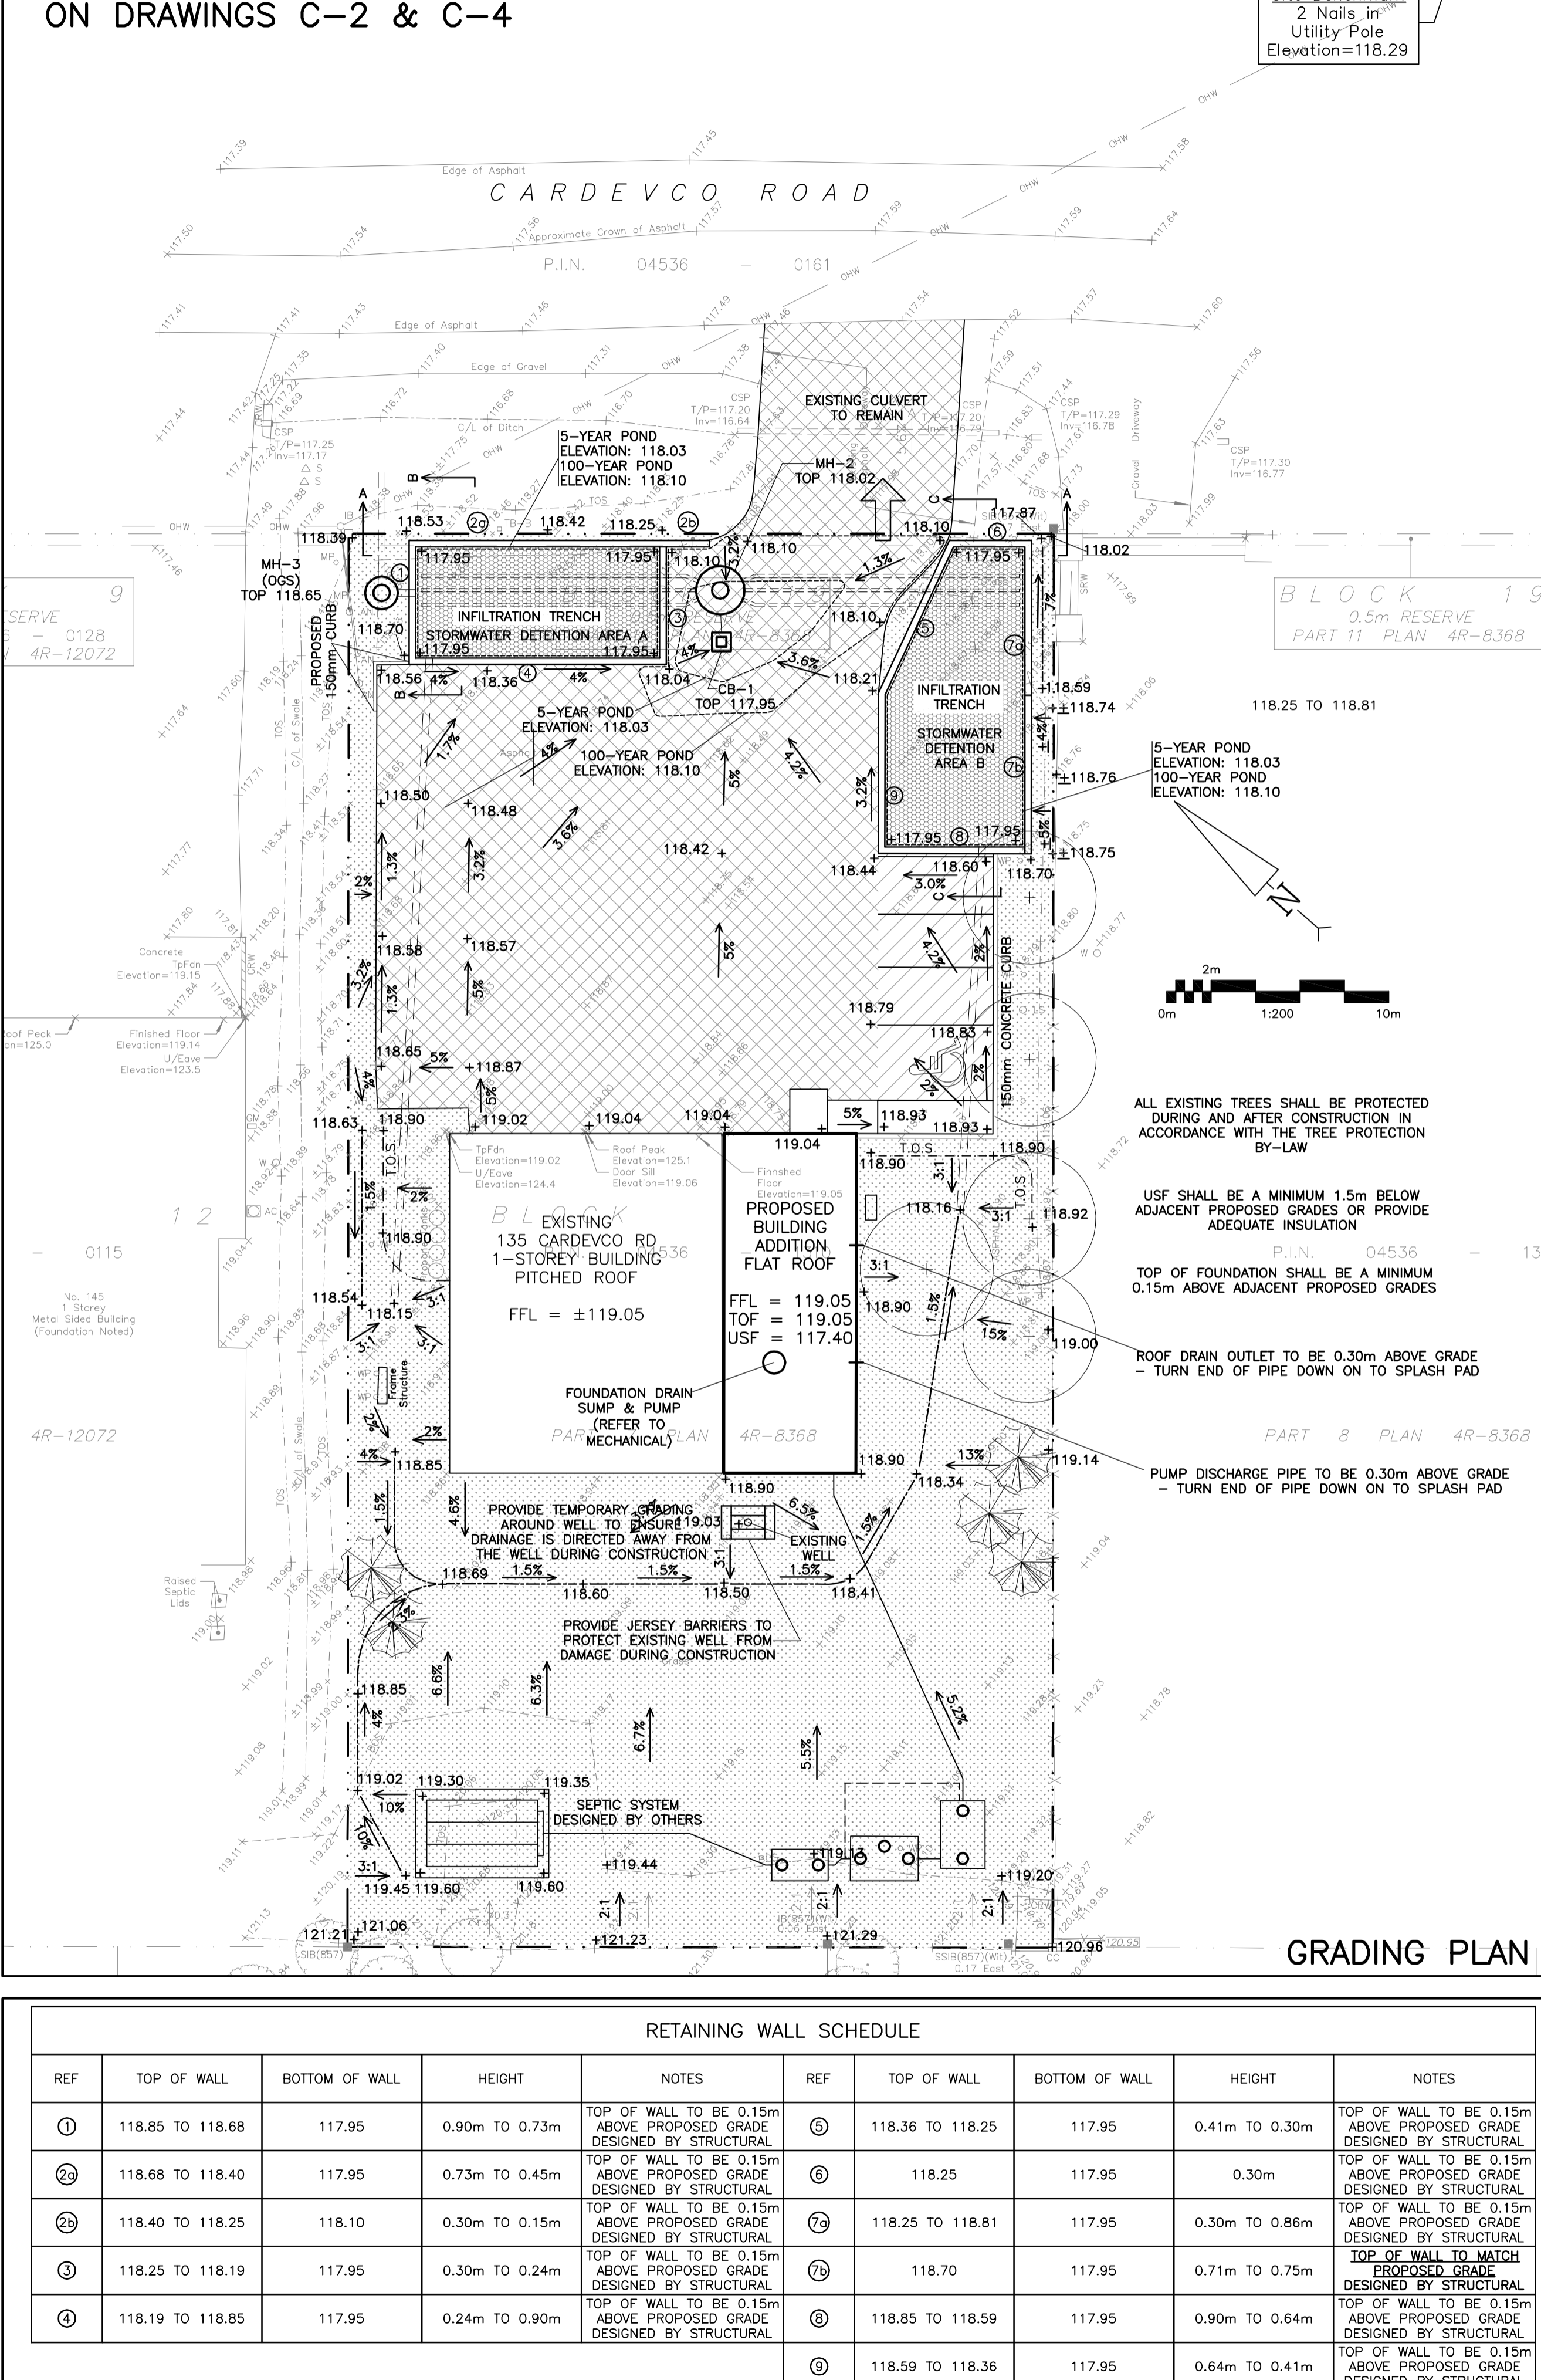



REFER TO NOTES & DETAILS
ON DRAWINGS C-2 & C-4

REFER TO NOTES & DETAILS
ON DRAWINGS C-2 & C-4

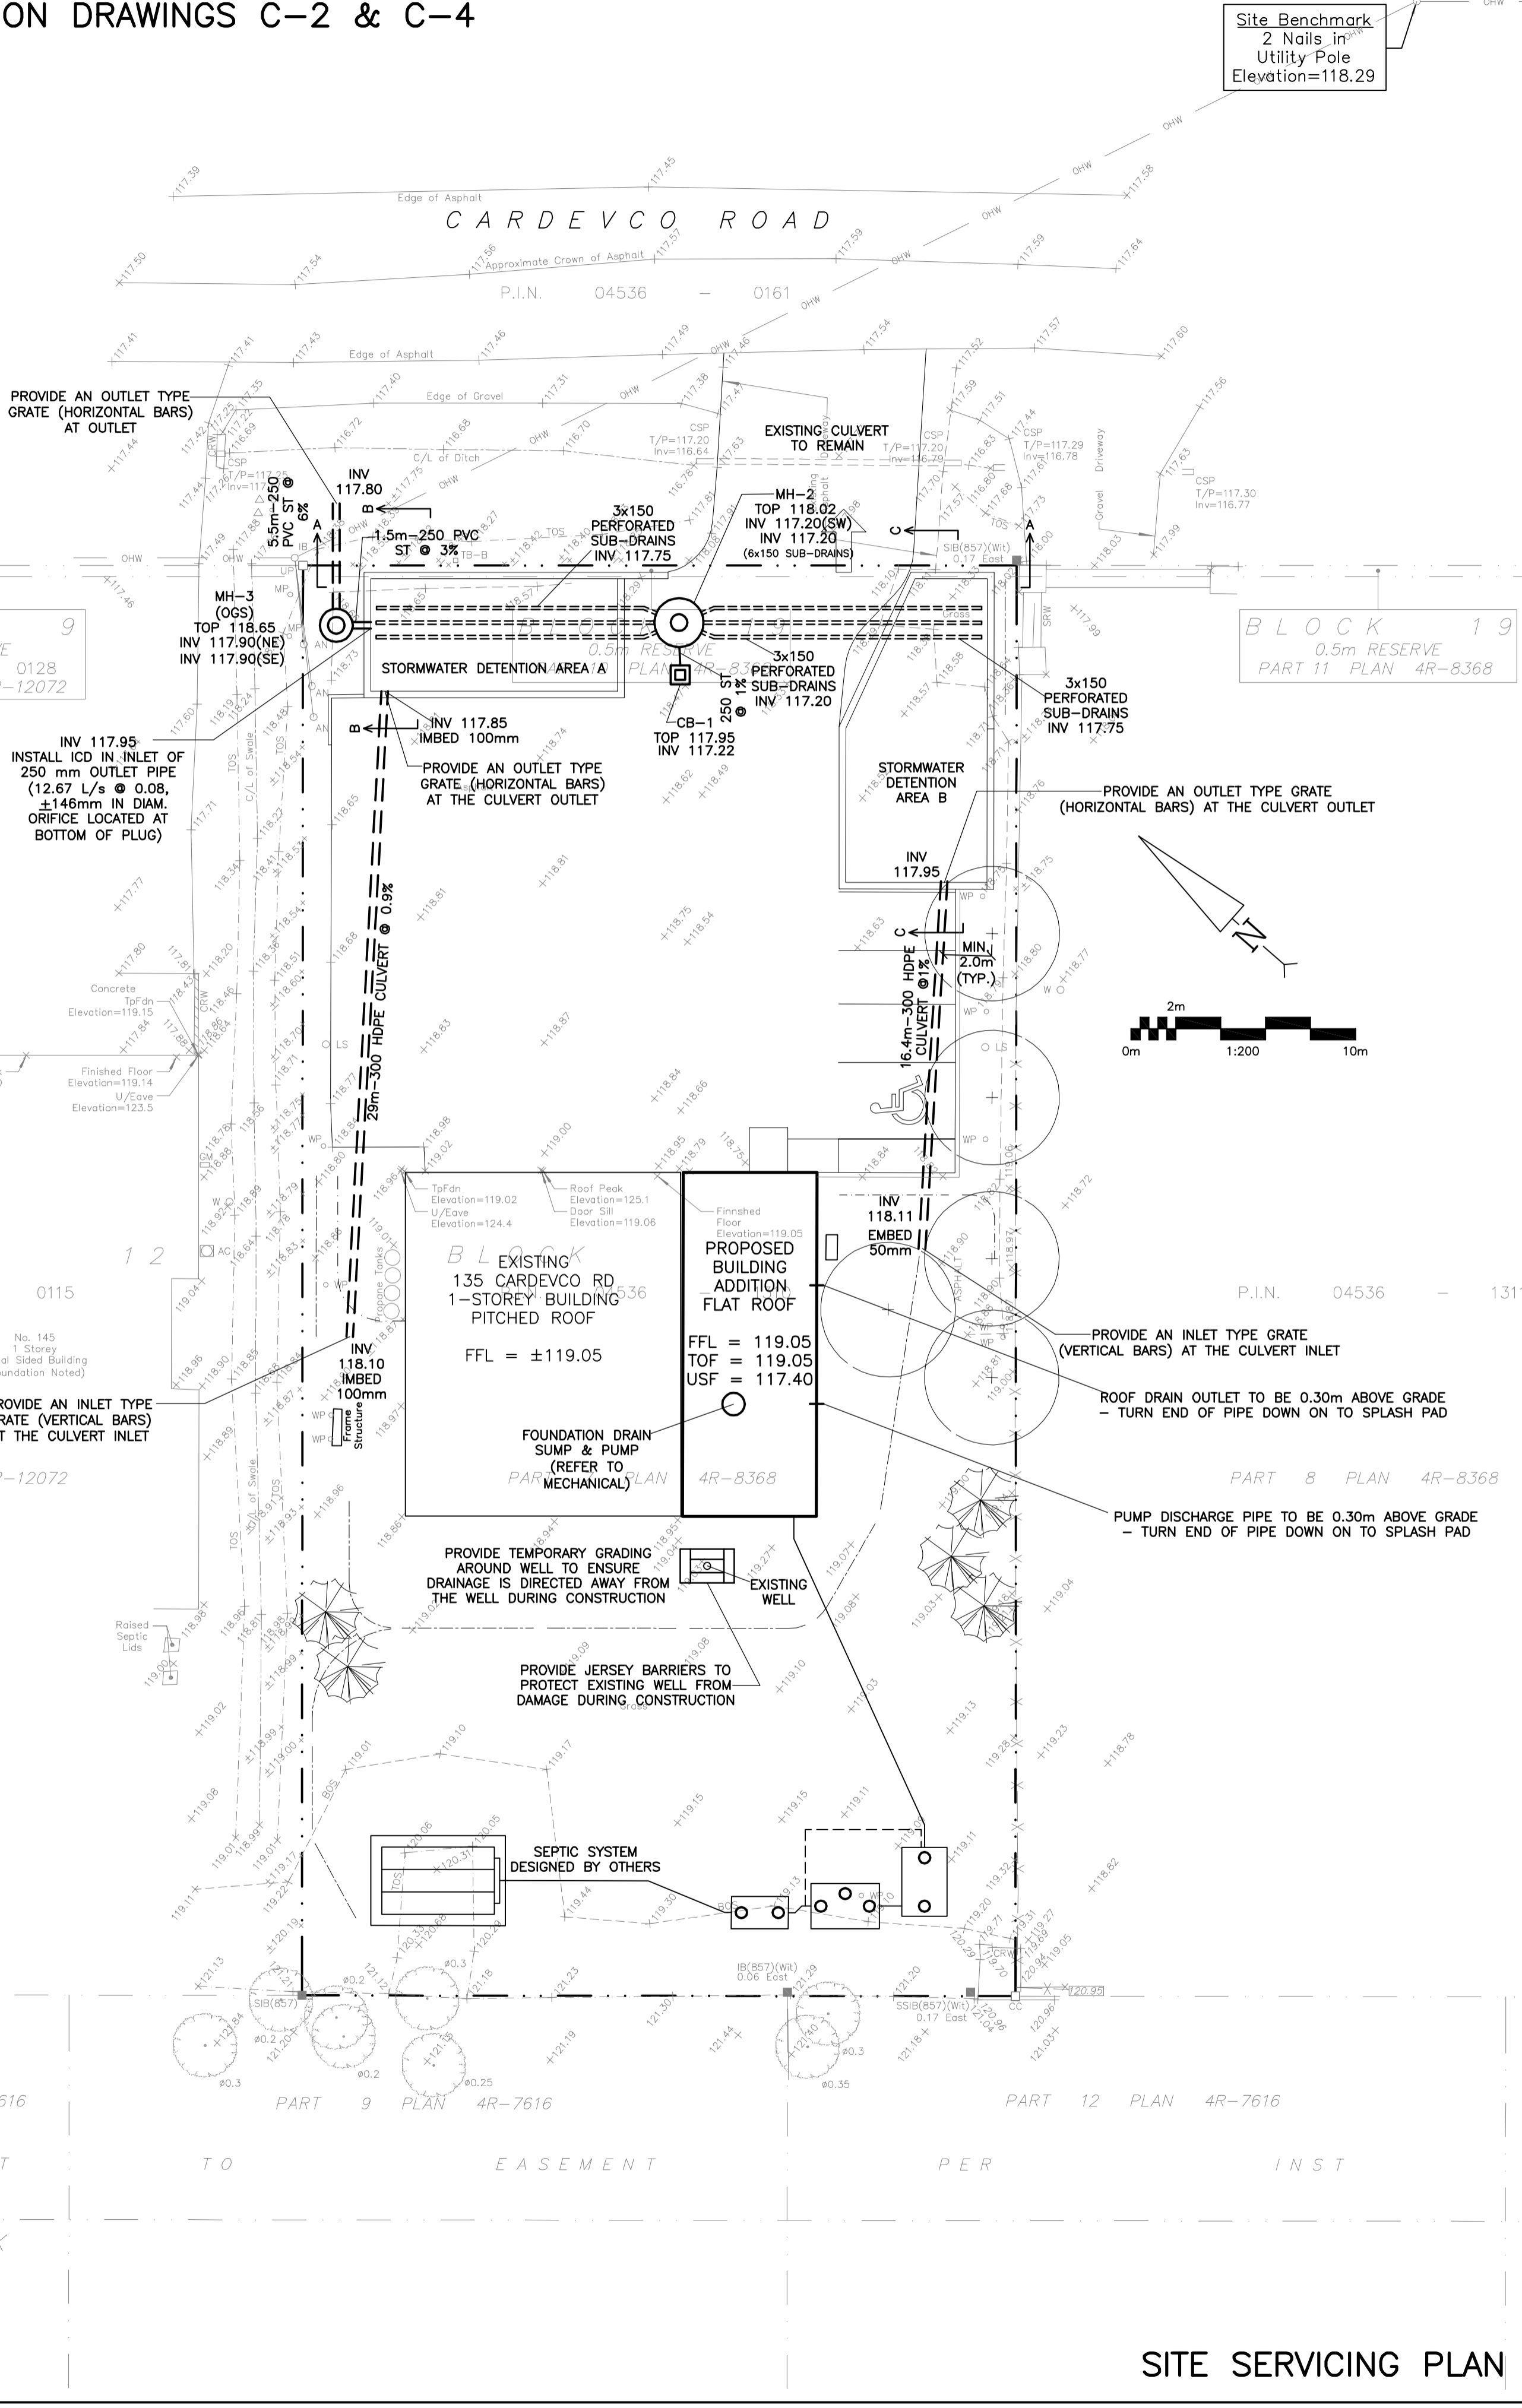

LEGEND

- FFL FINISHED FLOOR ELEVATION
- TOF TOP OF FOUNDATION
- USF UNDERSIDE OF FOOTING
- PROPERTY LINE
- CB [] CATCH-BASIN
- MH (O) STORM MANHOLE
- ST --- STORM SEWER
- INV INVERT OF PIPE
- +99.99 EXISTING GRADE ELEVATION
- +99.99 PROPOSED GRADE ELEVATION
- 2% EXISTING SLOPE OF GRADE
- 2% PROPOSED SLOPE OF GRADE
- [] EMERGENCY OVERLAND FLOW
- T.O.S. TOP OF SLOPE
- B.O.S. BOTTOM OF SLOPE
- CENTERLINE OF SWALE
- SILT FENCE BARRIER
- [] ROOF DRAIN
- [] LIGHT-DUTY PAVEMENT
- [] HEAVY-DUTY PAVEMENT
- [] LANDSCAPE

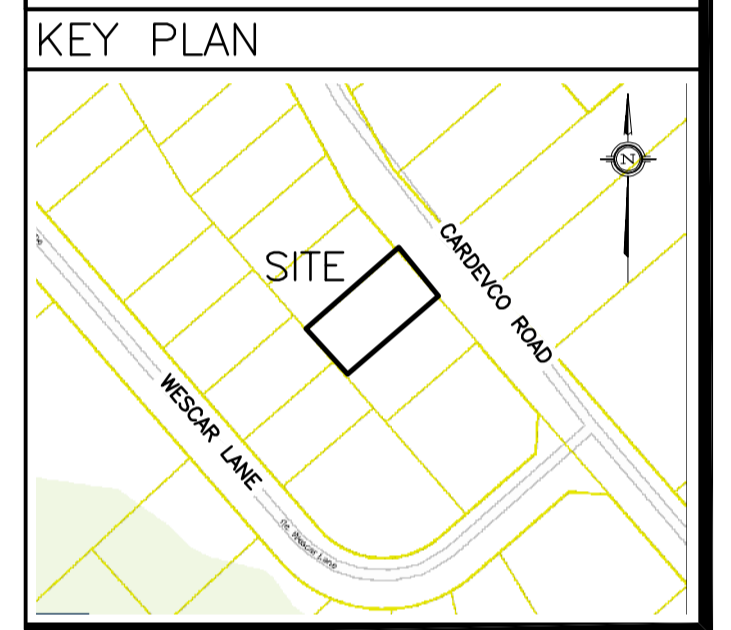


No.	DATE	REVISION
6	FEB 10-25	RE-ISSUED FOR APPROVAL
5	OCT 11-24	RE-ISSUED FOR APPROVAL
4	JUN 9-23	RE-ISSUED FOR APPROVAL
3	NOV 24-22	ISSUED FOR APPROVAL
2	NOV 15-22	ISSUED FOR COORDINATION
1	SEP 12-22	PRELIMINARY

D. B. GRAY ENGINEERING INC.
Stormwater Management - Grading & Drainage - Storm & Sanitary Sewers - Watertains
700 Long Point Circle
Ottawa, Ontario
613-425-8044
d.gray@dbgrayengineering.com

Project
**PROPOSED ADDITION
135 CARDEVCO ROAD
OTTAWA, ONTARIO**

Drawing Title
**SITE SERVICING PLAN
& GRADING PLAN**

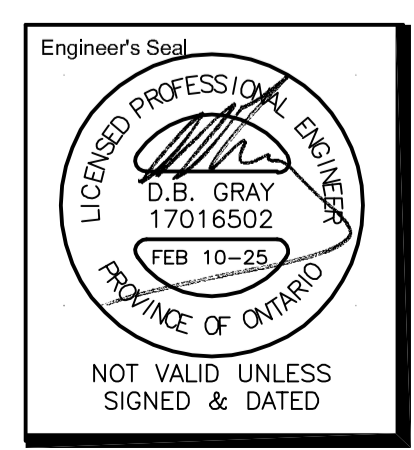

Engineer's Seal
D.B. GRAY
17016502
FEB 10-25
PROVINCE OF ONTARIO

Not Valid Unless
Signed & Dated

Drawn
D.B.G.
H. Scale 1:200
V. Scale
Date SEP 12-22
Job No. 21081

Drawing No.
**C-1
of 4**

RETAINING WALL SCHEDULE

REF	TOP OF WALL	BOTTOM OF WALL	HEIGHT	NOTES	REF	TOP OF WALL	BOTTOM OF WALL	HEIGHT	NOTES
1	118.85 to 118.68	117.95	0.90m to 0.73m	TOP OF WALL TO BE 0.15m ABOVE PROPOSED GRADE DESIGNED BY STRUCTURAL	5	118.36 to 118.25	117.95	0.41m to 0.30m	TOP OF WALL TO BE 0.15m ABOVE PROPOSED GRADE DESIGNED BY STRUCTURAL
2	118.68 to 118.40	117.95	0.73m to 0.45m	TOP OF WALL TO BE 0.15m ABOVE PROPOSED GRADE DESIGNED BY STRUCTURAL	6	118.25	117.95	0.30m	TOP OF WALL TO BE 0.15m ABOVE PROPOSED GRADE DESIGNED BY STRUCTURAL
2b	118.40 to 118.25	118.10	0.30m to 0.15m	TOP OF WALL TO BE 0.15m ABOVE PROPOSED GRADE DESIGNED BY STRUCTURAL	7a	118.25 to 118.81	117.95	0.30m to 0.86m	TOP OF WALL TO BE 0.15m ABOVE PROPOSED GRADE DESIGNED BY STRUCTURAL
3	118.25 to 118.19	117.95	0.30m to 0.24m	TOP OF WALL TO BE 0.15m ABOVE PROPOSED GRADE DESIGNED BY STRUCTURAL	7b	118.70	117.95	0.71m to 0.75m	TOP OF WALL TO MATCH PROPOSED GRADE DESIGNED BY STRUCTURAL
4	118.19 to 118.85	117.95	0.24m to 0.90m	TOP OF WALL TO BE 0.15m ABOVE PROPOSED GRADE DESIGNED BY STRUCTURAL	8	118.85 to 118.59	117.95	0.90m to 0.64m	TOP OF WALL TO BE 0.15m ABOVE PROPOSED GRADE DESIGNED BY STRUCTURAL
					9	118.59 to 118.36	117.95	0.64m to 0.41m	TOP OF WALL TO BE 0.15m ABOVE PROPOSED GRADE DESIGNED BY STRUCTURAL