


Legend				
	Proposed Deciduous Tree	Prop. Sodded Area Typ.	AAA L-2	Detail Reference Key
	Existing Coniferous Tree	Prop. Concrete Paving Typ.	<del>AAA</del> 0	Plant Material Reference Key
	Property Line	Feature Precast Unit Paving (Type 1)		Feature Heavy Duty Precast Paving (Type 3)
TPF	Tree Protection Fencing (Refer to Arborist Report)	Precast Unit Paving (Type 2)		Heavy Duty Precast Paving (Type 4)
	Prop. 1.8m HT Wood Privacy Screen Typ.	Proposed Bike Ring		Proposed Bench

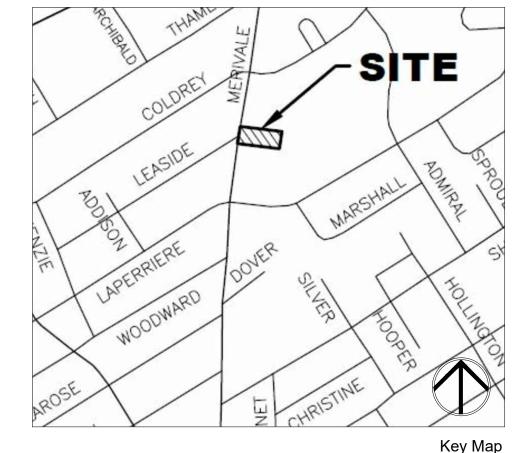



**B** BIOSIS DESIGNS


Owner:

Marc Amyot Assera Property Group 389 Hepatica Way, Orleans, Ontario, K4A0Z1 613-614-3992 marc@assera.ca



SNOW REMOVAL NOTE: Excess snow to be trucked off site.

10 Re-Issued for Resubmission 02/11/25 09 Issued for Permit 12/09/24 08 Issued for Resubmission 07 Issued for Coordination 11/15/24 06 Issued for Coordination 10/24/24 05 Issued for SPA #1 07/15/24 07/12/24 04 Revised per Amenity 07/09/24 03 Issued for Coordination 02 Issued for Coordination 05/08/24 01 Issued for Coordination 04/26/24 No. Revision

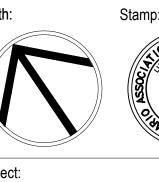

Project:

Proposed Landscape and
Site Upgrades

917 Merivale Road,
Ottawa, Ontario.
File Number: D07-12-24-0067


1:100 Date: APRIL 2024 **A.L.** Checked By: **L.M.** Drawn By:


Drawing Title:

Landscape Plan

Sheet No. 24120 L1-01

		S S S S S S S S S S S S S S S S S S S	
TS X	ORM SEWER  ST  MH-H  T/G=77.48	EX. TREES TO BE	
STORM SEWER (CITY)  STORM SEWER (CITY)	P W APPROX W	PRESERVED (REFER TO REPORT PREPARED BY IFS ASSOCIATES)  PROPOSED  S880  RETAINING WALL [17:8]  REFER TO CIVIL)  PROPOSED  (REFER TO CIVIL)  REFER TO CIVIL)  PROPOSED  S880  REFER TO CIVIL)  PROPOSED  (REFER TO CIVIL)  PROPOSED 1880 HT.  WOOD PRIVACY  FENCING (REFER TO REPORT PREPARED BY IFS ASSOCIATES))  PROPOSED 1.8M HT.  WOOD PRIVACY	
ST 450mmø CONC.	TROI GOLD BLIVOIT	LEVATED  LEVATED  THE CURB  FEATURE HEAVY DUTY PRECAST CONCRETE UNIT PAVING TYP. TYPE & COLOUR T.B.A	
	D-01 TYPE & COLOUR T.B.A  PROPOSED ROOT  BARRIER  D-02	HEAVY DUTY PRECAST CONCRETE UNIT PAVING TYP. TYPE & COLOUR T.B.A  OUTLINE OF BUILDING ABOVE  VESTIBLE  VES	
	EX. SIDEWALK TO	PROPOSED PREFAB PLANTER 11 PA PS PS SCA 5 PROPOSED PREFAB PLANTER 11 PA PS PS SCA 5 PROPOSED	
	REMAIN (TO BE REPAIRED AS NEEDED TO ACCOMMODATE DRIVEWAY ADJUSTMENTS. REFER TO CIVIL)	FIRE DEPT. CONNECTION  BIKE RING ON  CONCRETE PAD  CONCRETE PAD  CONCRETE PAD  CONCRETE PAD  CONCRETE PAD	
s — s — m	FEATURE PRECAST CONCRETE UNIT PAVING DETAIL TYP. TYPE & COLOUR T.B.A	FIRE DEPT.  CONNECTION  (REFER TO  ARCHITECTURAL  DWGS.)  18380	
	TS A M	S	
	N W W	0m 1m 5m 10m 20m	

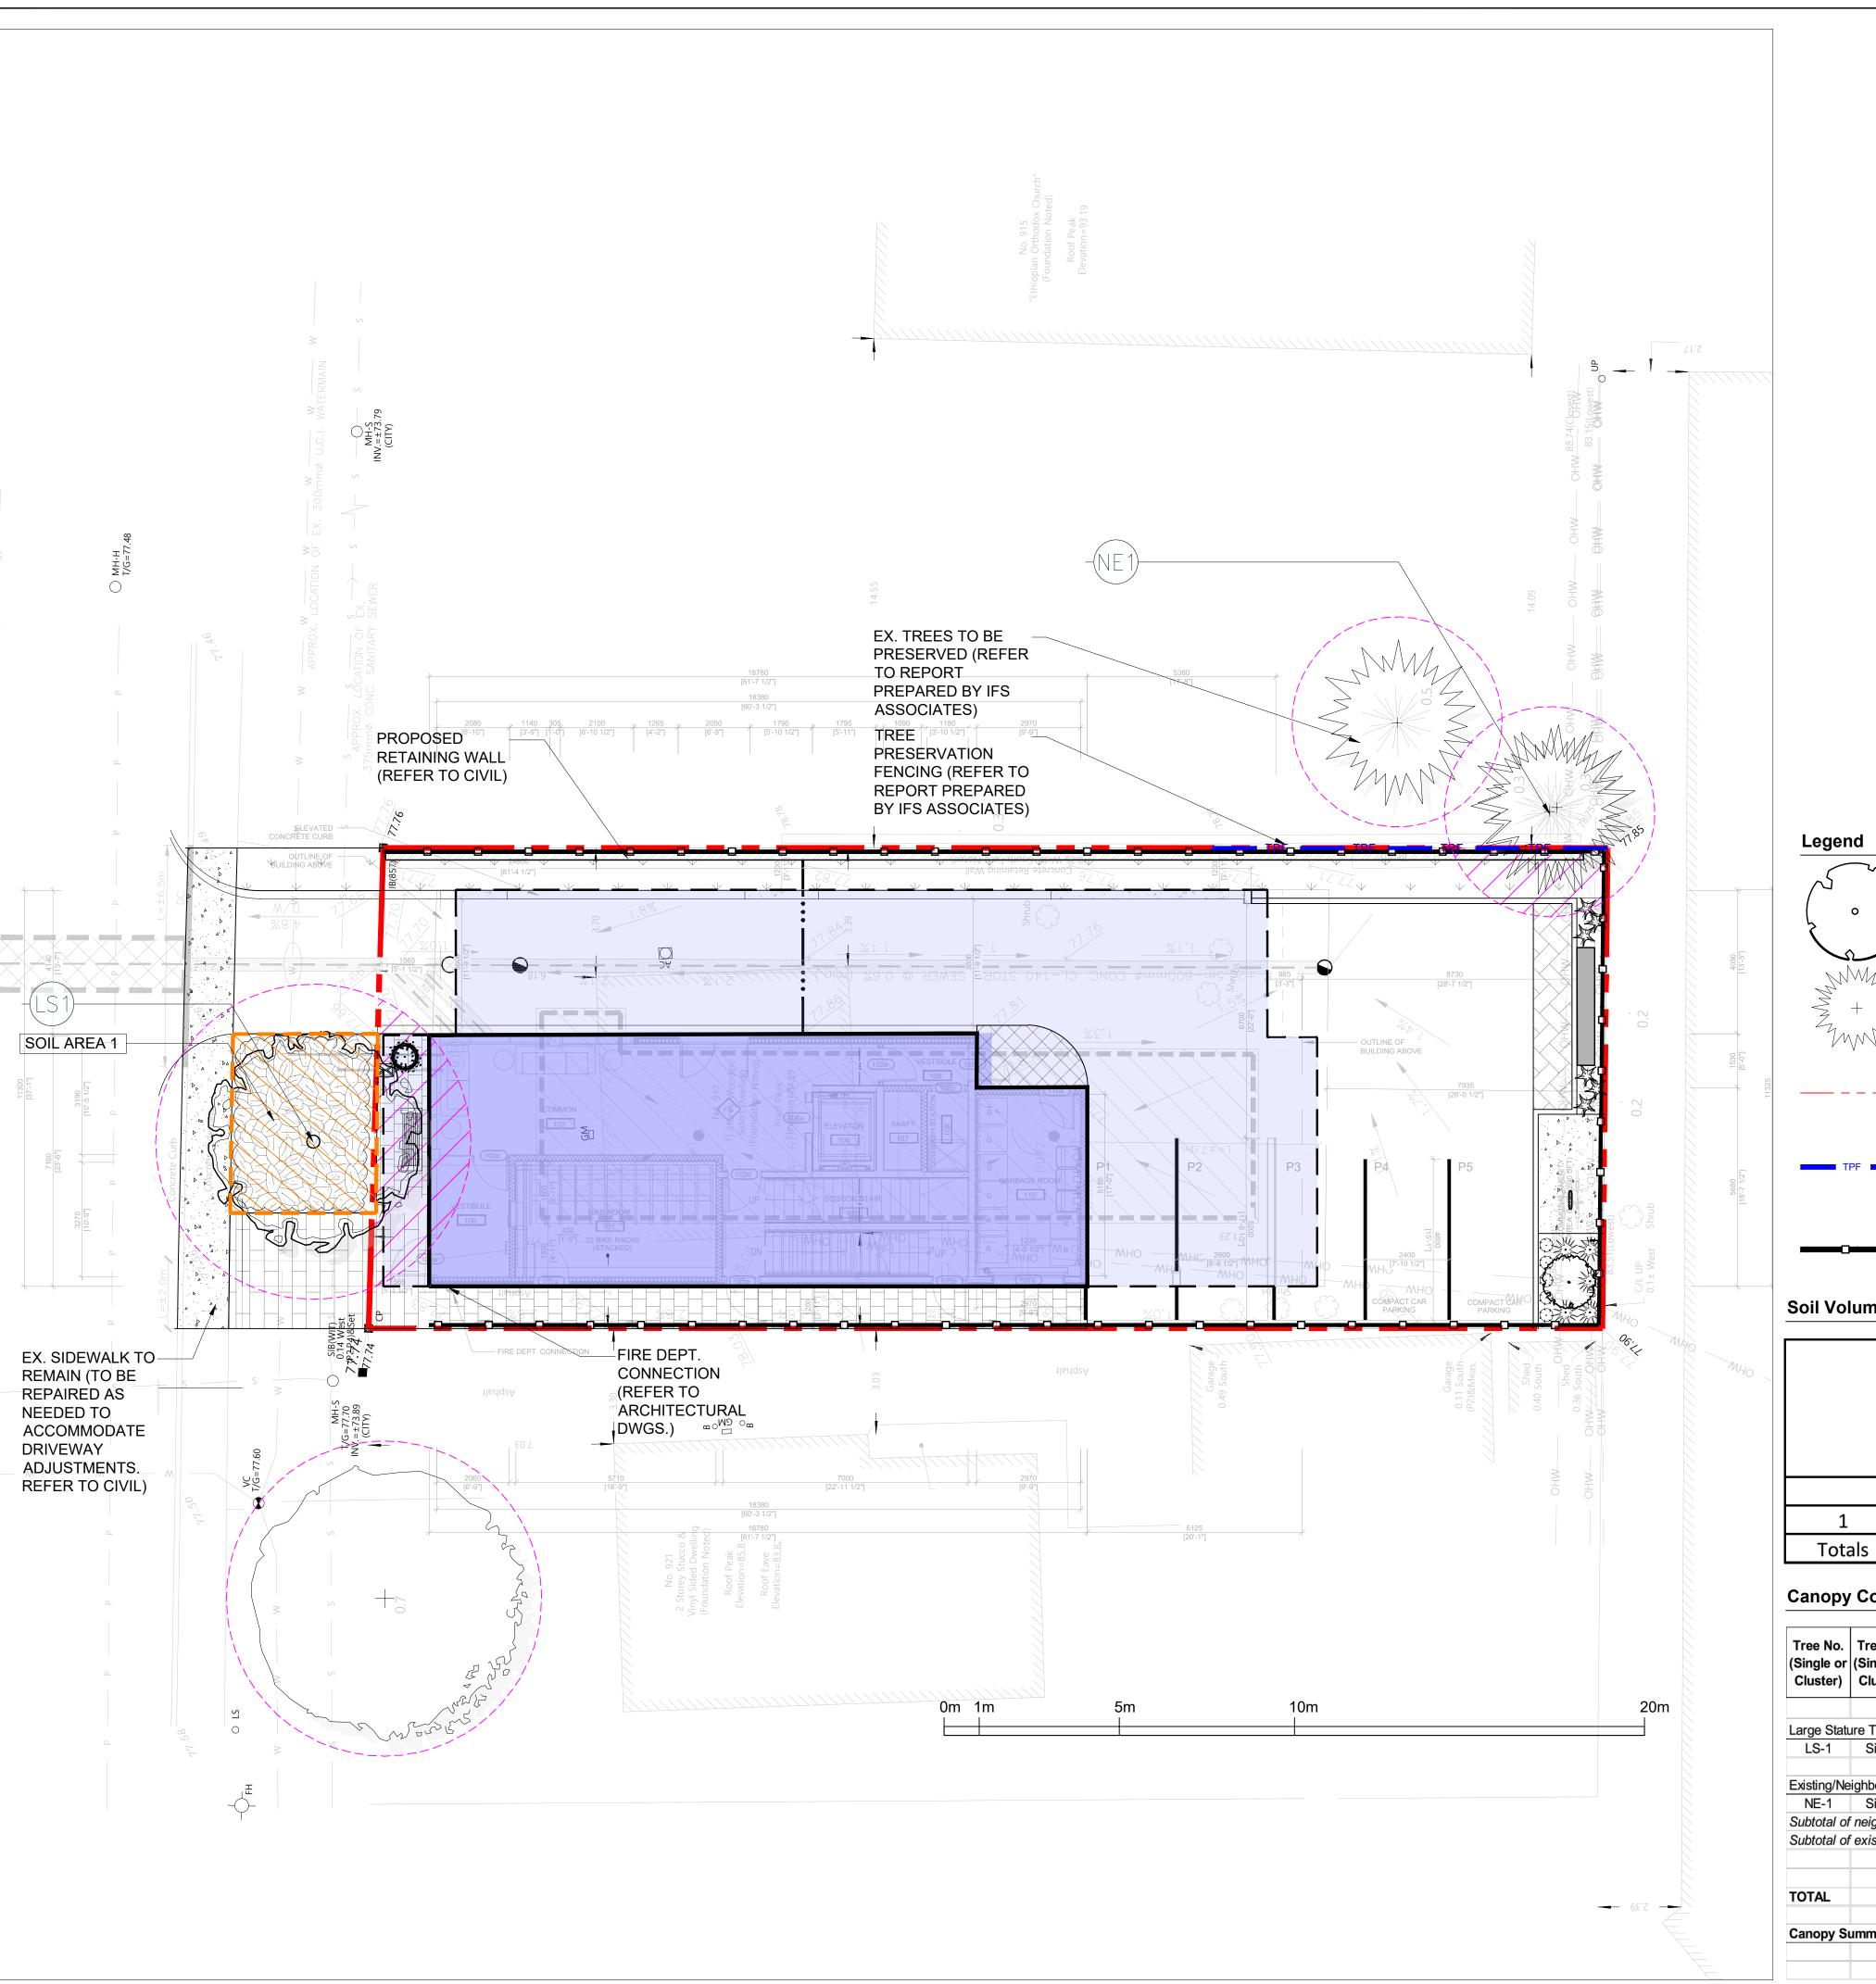

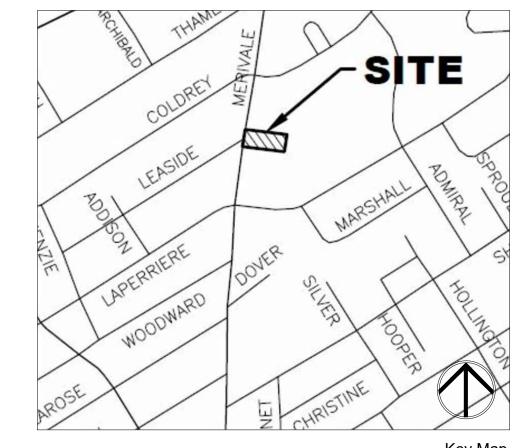



Architect:



tel. 416.492.9966 | email. info@msla.ca

Owner:

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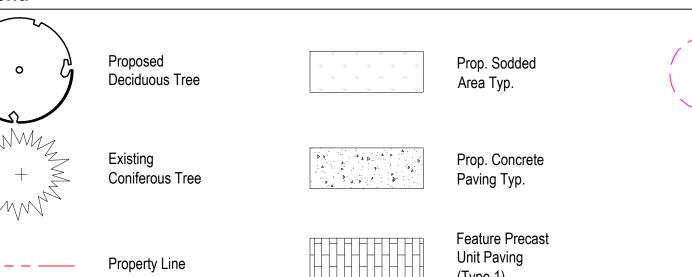
Municipality:




Potential Tree


Canopy Cover

SNOW REMOVAL NOTE: Excess snow to be trucked off site.



Tree Protection Fencing (Refer to Arborist Report)

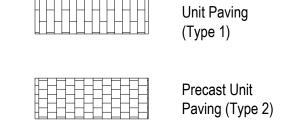

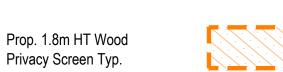

Prop. Soil Area

# **Soil Volume Chart**

	Location (City ROW, private property)	Soil Area (m²)	Soil Depth(m*)	Soil Volume (m³)	Tree Quantity	Soil Volume per tree (m³)
1	R.O.W.	21.0	1.5	31.5	1	31.5
Totals		21.0		31.5	1	

# **Canopy Cover Chart**

Tree No. (Single or Cluster)	Tree No. (Single or Cluster)	Tree Species	No. of Trees	Soil Depth of Cover (m)*	Available Soil Volume (m³)	Soil Volume per Tree (Available Soil / # of Trees)	Canopy Area (m²)
Large Statu	ıre Trees (1	4+ m spread)					
LS-1	Single	Quercus rubra	1	1.5m	31.5 m³	31.5 m³	16
Existing/Ne	ighbouring	Trees					
NE-1	Single	Emerald white cedar (Thuja occidentalis 'Smaragd')	1	-	-	-	6
Subtotal of	neighbouri	ng tree crown area					6
Subtotal of	existing tre	ee bonus factor of 1.5 (on site)					9
TOTAL			2				25
Canopy Sı	ımmarv						
ounopy of	arriiridi y	Site Area					481.5
		Site Canopy Cover				1	5.2%

North:	Stamp:			
No.	Revision	Date		
01	Issued for Coordination	04/26/24		
02	Issued for Coordination	05/08/24		
03	Issued for Coordination	07/09/24		
04	Revised per Amenity	07/12/24		
05	Issued for SPA #1	07/15/24		
06	Issued for Coordination	10/24/24		
07	Issued for Coordination	11/15/24		
08	Issued for Resubmission	12/09/24		
09	Issued for Permit	01/17/25		
10	Re-Issued for Resubmission	02/11/25		





Project:

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Site Upgrades
917 Merivale Road, Ottawa, Ontario.

File Number: D07-12-24-0067 1:100 Date: APRIL 2024 **A.L.** Checked By: **L.M.** Drawn By:

Drawing Title: Canopy Cover Plan

L2-01

## LANDSCAPE SPECIFICATIONS

CONTRACTOR MUST CONTACT ALL UTILITY COMPANIES FOR STAKE OUTS PRIOR TO ANY EXCAVATION OR PLANTING.

ROUGH GRADE AND FILL AREAS TO ESTABLISH SUBGRADE AS REQUIRED. PROVIDE DRAINAGE PATTERN AS INDICATED ON DRAWINGS. ROUND SMOOTHLY ALL TOPS AND TOES OF SLOPES. COMPACT ALL AREAS TO 95% STANDARD PROCTOR DENSITY UNLESS SPECIFIED OTHERWISE. EXISTING TREES TO REMAIN ON SITE ARE TO BE PROTECTED AS DETAILED.

FINE GRADE ALL AREAS TO FINISHED GRADES AS SHOWN ON LAYOUT OR GRADING PLAN OR ARCHITECT'S SITE PLAN. PROVIDE UNIFORM SLOPES AWAY FROM THE BUILDING, UNLESS SPECIFIED OTHERWISE. SLOPES MAY NOT EXCEED 33 1/3% (3:1).

SCARIFY THE SUBSOIL PRIOR TO THE SPREADING THE TOPSOIL. REMOVE ALL DEBRIS AND LEAVE A FINE-TEXTURED EVEN SURFACE. ALL TOPSOIL TO BE IMPORTED UNLESS PREVIOUSLY APPROVED BY LANDSCAPE ARCHITECT. OBTAIN APPROVAL FOR THE QUALITY OF ANY IMPORTED TOPSOIL BEFORE DELIVERY TO THE SITE. TOPSOIL IS TO BE COMPACTED. TO CREATE A FIRM AND EVEN SURFACE.

USE NO. 1 GRADE TURFGRASS NURSERY SOD WHICH CONFORMS WITH THE SPECIFICATIONS OF THE NURSERY SOD GROWERS ASSOCIATION OF ONTARIO. ALL LAWN AREAS SHALL RECEIVE A MINIMUM OF 100MM (4") OF COMPACTED TOPSOIL, AND SHALL BE SODDED WITH #1 KENTUCKY BLUEGRASS - FESCUE. NO SOD SLOPES ARE TO EXCEED 3:1. SLOPE IN EXCESS OF 4:1 TO BE PEGGED.

MINERAL FERTILIZER APPLY THE FOLLOWING MINERAL FERTILIZER UNLESS SOILS TESTS SHOW OTHER REQUIREMENTS:

1. SODDED AREAS - 11% NITROGEN, 8% PHOSPHORUS AND 4% POTASH (11-8-4) AT THE RATE OF 4.5 KG OVER M2 (10 LBS OVER 1000 SQ.

2. PLANTING BEDS - 7% NITROGEN, 7% PHOSPHORUS AND 7% POTASH (7-7-7) AT THE RATE OF 40 GRAMS (4 OZ.) FOR EVERY BUSHEL OF

### PREPARATION OF PLANTING BEDS

ALL PLANT BEDS TO BE CONTINUOUS. EXCAVATE ALL PLANTING BEDS TO THE DEPTH AS INDICATED ON THE DRAWINGS AND DETAILS, MIN 450mm(18"). BACKFILL ALL PLANTING BEDS WITH A SOIL MIXTURE CONSISTING OF SIX (6) PARTS OF SAND LOAM, ONE (1) PART OF FINELY PULVERIZED PEAT MOSS, TWO (2) PARTS OF WELL-ROTTED MANURE AND THE MINERAL FERTILIZER AS SPECIFIED ABOVE. ALSO ADD .58 KILOS BONEMEAL/CUBIC METER OF PLANTING SOIL (1 LB./CUBIC YARD). PREPARE THE PLANTING BEDS FOR PLANTING BEFORE THE DELIVERY OF THE PLANT MATERIAL TO THE JOB SITE.

NOTE: IF THE EXISTING SOIL CONDITIONS ARE CLAY OR WET IN NATURE, CONTACT THE LANDSCAPE ARCHITECT FOR INSTRUCTIONS OF A SUITABLE SOIL MIXTURE. FAILURE TO DO THIS MAY RESULT IN DELAY OF APPROVAL AND ACCEPTANCE. PLANT MATERIALS

ALL PLANT MATERIAL SHALL CONFORM TO THE STANDARDS OF THE CANADIAN NURSERY TRADES ASSOCIATION FOR SIZE AND

ALL SHRUB AND TREE MATERIAL SHALL BE CONTAINER GROWN, POTTED, S/B OR B/B, UNLESS OTHERWISE NOTED. BARE ROOT PLANTING SHALL BE ACCEPTABLE FOR CERTAIN SPECIES DURING EARLY SPRING OR LATE FALL PLANTING SEASON. CONTRACTOR SHALL MAKE REQUESTS FOR ROOT CONDITION SUBSTITUTION IN WRITING TO THE LANDSCAPE ARCHITECT PRIOR TO COMMENCEMENT OF PLANTING OPERATIONS. ALL PLANT MATERIAL TO BE CLAY GROWN STOCK UNLESS OTHERWISE NOTED.

## LANDSCAPE SPECIFICATIONS

## PLANT MATERIAL INSTALLATION

ALL TREES, SHRUBS AND GROUNDCOVERS SHALL BE PLANTED AS DETAILED & AS SHOWN ON THE PLANTING PLAN. ALL BEDS TO RECEIVE A COVER OF CLEAN MULCH TO A DEPTH OF 100mm(4"). FOR GUYING AND STAKING TREES, REFER TO PLANTING DETAILS. WRAP ALL DECIDUOUS TREES UNDER EXPERIENCED SUPERVISION ONLY TO THE SPECIFICATIONS OF THE ONTARIO LANDSCAPE

PLANT MATERIAL SIZES AND CONDITIONS ARE TO BE AS INDICATED ON THE LANDSCAPE DRAWING. THE INDIVIDUAL PLANT GROUPING TOTAL AS ILLUSTRATED ON THE PLANTING PLAN SUPERSEDES THE ESTIMATED QUANTITY ON THE MASTER PLANT LIST. CONTRACTOR MUST REPORT ANY DISCREPANCIES TO THE LANDSCAPE ARCHITECT IN WRITING BEFORE

COMMENCING ANY WORK. CONTRACTOR WILL ASSUME FULL RESPONSIBILITY IF LANDSCAPE ARCHITECT IS NOT NOTIFIED OF

\* MULCH - SHREDDED PINE MULCH BY "GRO BARK" OR APPROVED EQUAL. LANDSCAPE ARCHITECT TO APPROVE MULCH BEFORE INSTALLATION.

### **GENERAL MAINTENANCE**

PROPER MAINTENANCE PROCEDURES ARE TO BE FULLY ADMINISTERED FOR ALL NEWLY CONSTRUCTED LANDSCAPE WORK, IN ACCORDANCE WITH LANDSCAPE ONTARIO SPECIFICATIONS (SECTION 1E - MAINTENANCE WORK). THIS SHALL APPLY ONLY DURING THE CONSTRUCTION PERIOD, UNLESS OTHERWISE SPECIFIED. CONTRACTOR IS RESPONSIBLE FOR MAINTENANCE OF SOD AND PLANTING UNTIL FINAL ACCEPTANCE BY LANDSCAPE ARCHITECT.

### RODENT PROTECTION

THE CONTRACTOR SHALL BE RESPONSIBLE FOR THE PROTECTION OF ALL TREES AND SHRUBS FOR WINTER PROTECTION AND FROM RODENT INJURY FOR THE DURATION OF GUARANTY PERIOD. PROTECTIVE GUARDS SHALL BE EMPLOYED AROUND ALL DECIDUOUS TREES. GUARDS TO BE 150MM DIA. PVC PIPE OR AS MUNICIPAL GUIDELINES. GUARDS SHALL BE INSTALLED PRIOR TO THE

ALL SHRUBS AND CONIFEROUS TREES SHALL HAVE AN APPLICATION OF "SKOOT" OR APPROVED EQUIVALENT RODENT FORMULA, TO BE APPLIED AT THE END OF OCTOBER. FOLLOW MANUFACTURER'S DIRECTIONS FOR APPLICATION.


APPLICATION OF THE MULCH AND SHOULD BE PLACED A MINIMUM OF 50MM (2") OUT FROM THE TREE TRUNK ON ALL SIDES.


USE ABOVE SPECIFICATIONS IN CONJUNCTION WITH THE GENERAL LANDSCAPE SPECIFICATIONS OF THE ONTARIO LANDSCAPE CONTRACTORS ASSOCIATION, THE NURSERY SOD GROWERS ASSOCIATION OF ONTARIO AND WITH THE GUIDE SPECIFICATIONS FOR NURSERY STOCK OF THE CANADIAN NURSERY TRADES ASSOCIATION. USE ONLY PLANT MATERIAL TRUE TO NAME, SIZE AND GRADE AS SPECIFIED ON PLANTING PLAN: PROVIDE SUFFICIENT LABELS OR MARKINGS TO INDICATE CLEARLY THE VARIETY, SIZE AND GRADE OF EACH SPECIMEN OR BUNDLE.

OBTAIN APPROVAL FOR SUBSTITUTIONS AS TO VARIETY, SIZE OR GRADE FROM THE LANDSCAPE ARCHITECT. USE ONLY NURSERY STOCK GROWN UNDER PROPER HORTICULTURAL PRACTICES, VIABLE, FREE FROM PEST AND DISEASE AND UNDAMAGED. CHECK LOCATIONS AND OBTAIN STAKEOUTS OF ALL UTILITY LINES BEFORE EXCAVATION. OBTAIN ALL NECESSARY PERMITS BEFORE COMMENCEMENT OF CONSTRUCTION. REPORT IN WRITING ANY DISCREPANCIES IN THE DRAWINGS, SPECIFICATIONS AND CONTRACT DOCUMENTS TO THE LANDSCAPE ARCHITECT BEFORE THE END OF THE BIDDING PROCESS AND COMMENCEMENT OF CONSTRUCTION. THESE SPECIFICATIONS MAY BE SUPERCEDED BY ADDITIONAL SPECIFICATIONS SET OUT IN THE TENDER DOCUMENTS. CONTRACTOR TO REVIEW ALL DOCUMENTS

PROVIDE ONE FULL YEAR GUARANTEE ON ALL LANDSCAPE WORK FROM DATE OF FINAL ACCEPTANCE BY LANDSCAPE ARCHITECT. GUARANTEE PERIOD MAY BE EXTENDED TO TWO FULL YEARS DEPENDING ON MUNICIPAL STANDARDS. CONTRACTOR TO VERIFY WITH OWNER AND LANDSCAPE ARCHITECT.

# PLANT MATERIAL INSTALLATION

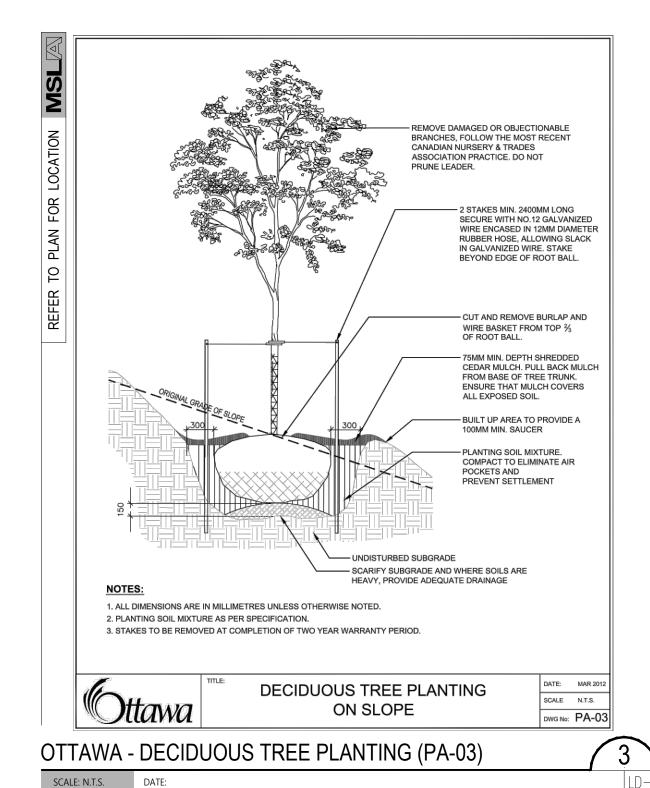

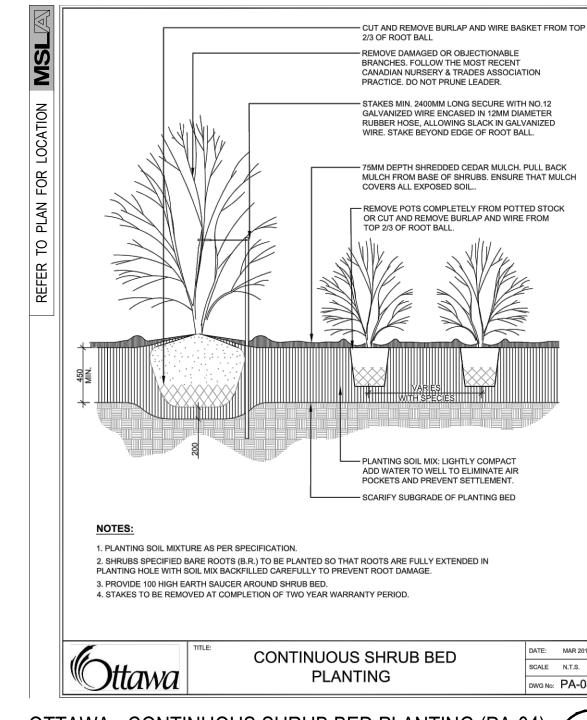

OTTAWA - CONTINUOUS SHRUB BED PLANTING (PA-04) SCALE: N.T.S. DATE:

MARTON SMITH LANDSCAPE ARCHITECTS

170 The Donway W Suite 206. Toronto, Ontario, Canada. M3C 2G3 tel. 416.492.9966 | email. info@msla.ca

Architect:



Owner:

Marc Amyot Assera Property Group 389 Hepatica Way, Orleans, Ontario, K4A0Z1 613-614-3992 marc@assera.ca

Municipality:



SNOW REMOVAL NOTE: Excess snow to be trucked off site.


Face of building Concrete unit paving - refer to plan 25 x 300 rigid foam for type and pattern of paving. insulation - continuous along building wall - 25 mm bedding sand - compact to 95% S.P.D. - 200 mm granular "A" - compact to 95% S.P.D. Expansion joints 2 to 4% minimum slope ----Refer to curb detail Thoroughly compacted subgrade SECTION ADJACENT BUILDING WITH CURB compact to 98% S.P.D. Concrete unit paving - refer to plan for NOTE: USE "POLYMERIC type and pattern of paving. JOINTING SAND" WITH ALL UNIT PAVER APPLICATIONS - 25 mm bedding sand - compact to AS PER TCHC STANDARDS 95% S.P.D. 200 mm granular "A" - compact to 95% S.P.D. 2 to 4% minimum slope — -Structure Edge aluminum paver restraint by Permoloc with 9.5mm x 254mm spiral steel spike at 305 O.C. (typ.) or 102mm O.C. min. To be installed per manufacturer's specifications. Thoroughly compacted subgrade SECTION AT GRADE WITHOUT CURB compact to 98% S.P.D. PEDESTRIAN PRECAST CONC. PAVER DETAIL

SCALE: N.T.S. WITH ALUMINUM EDGE RESTRAINT

Precast Unit paving - refer to plan for NOTE: USE "POLYMERIC type and pattern of paving. JOINTING SAND" WITH ALL (min. 80mm) UNIT PAVER APPLICATIONS 25 mm bedding sand - compact to 95% S.P.D. NOTE REGARDING SAW CUTS: NO CUT PIECES SHOULD BE Jointing sand- fill all joints with SMALLER THAN 40% OF THE sand free of organics and salts ORIGINAL PAVER SIZE 150mm granular 'A' - compact to 95% S.P.D. 250mm granular 'B' - compact to 95% S.P.D. DROPPED CURB AT ENTRANCES SLOPE TO C CATCH BASIN Adjacent paving refer to plan for type and pattern of paving -CONC. CURB (REFER TO 600.11-1 CONC. **BARRIER CURB** DETAIL) NOTE: Granular base and sub-base Thoroughly compacted subgrade information are minimum requirements. compact to 95% S.P.D. All granular base materials must meet or Undisturbed Soil the recommendations of the project soil engineering report for the vehicular VARIES - REFER TO PLAN use/loads required & to be approved by the geo-technical engineer prior to

HEAVY DUTY (VEHICULAR) PRECAST CONCRETE UNIT PAVER INSTALLATION DETAIL SCALE: N.T.S. Vehicular Detail to be approved by Civil or Geotechnical Engineer prior to construction

SCALE: N.T.S. DATE:

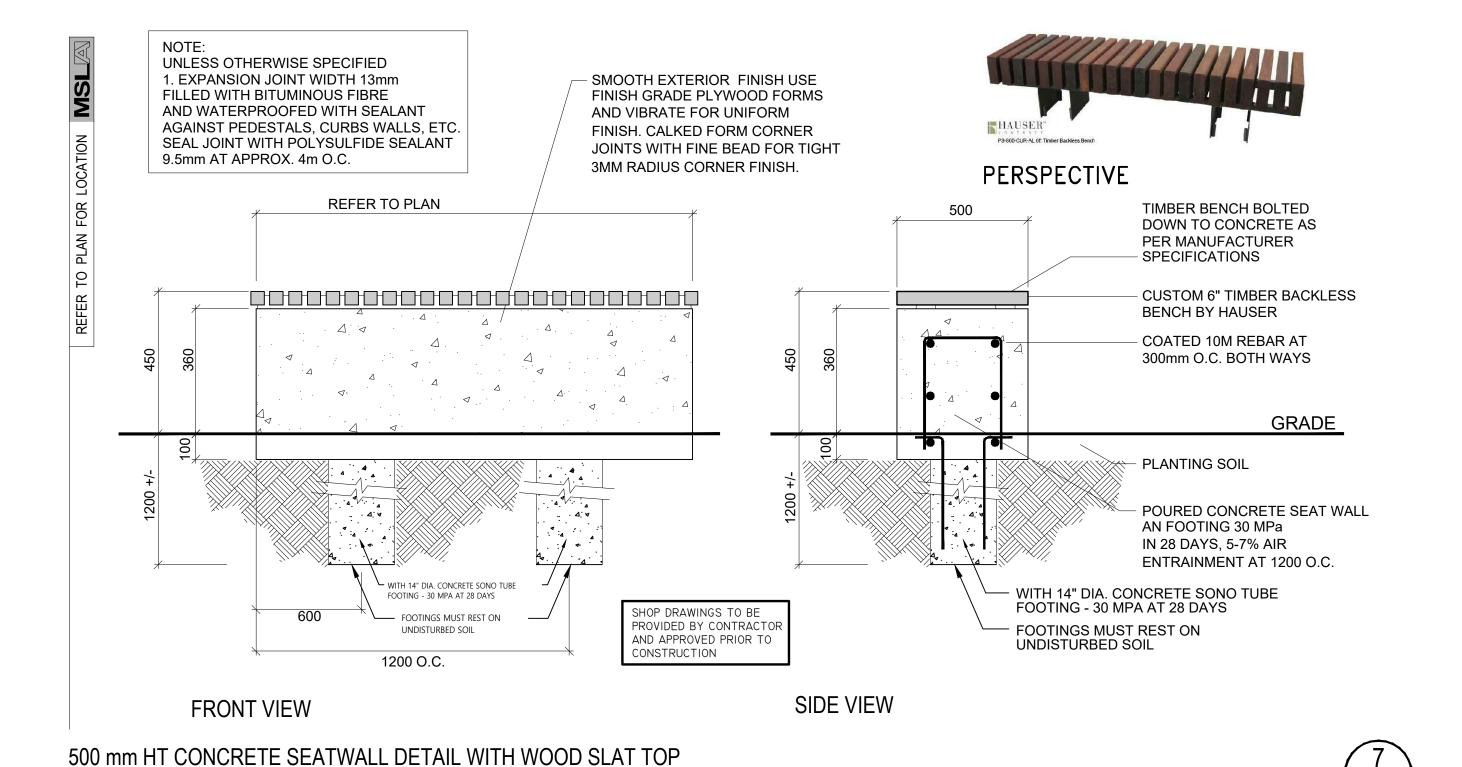

05/08/24 02 Issued for Coordination 04/26/24 Issued for Coordination No. Revision Date North:

Re-Issued for Resubmission 02/11/25

12/09/24

11/15/24

10/24/24

07/15/24

07/12/24

07/09/24

Issued for Permit

07 Issued for Coordination

06 Issued for Coordination

Revised per Amenity

03 Issued for Coordination

05 Issued for SPA #1

Issued for Resubmission

Project: **Proposed Landscape and Site Upgrades** 

917 Merivale Road, Ottawa, Ontario. File Number: D07-12-24-0067


Scale: As Shown Date: APRIL 2024 **A.L.** Checked By: **L.M.** Drawn By:


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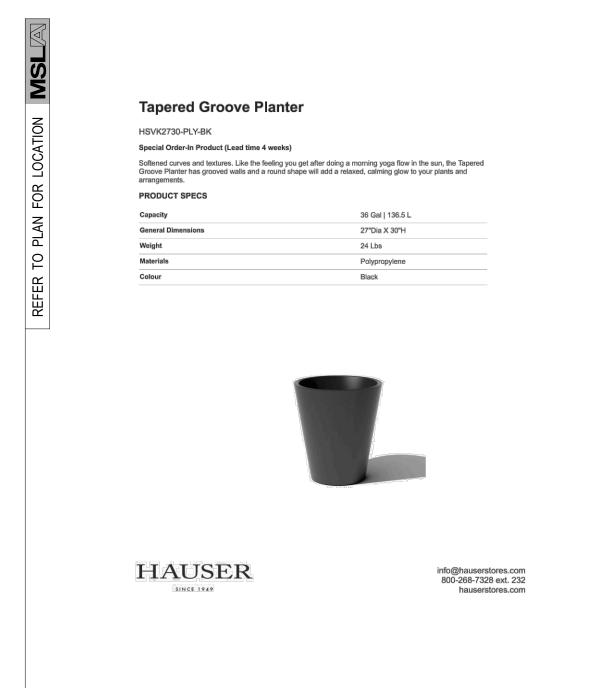
**Details** 


Project No. Sheet No. LD-01






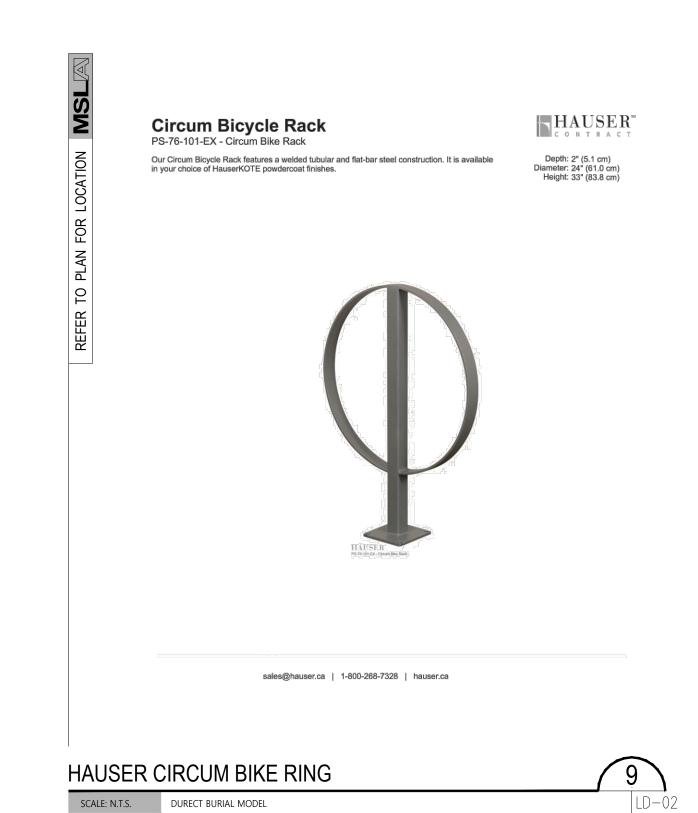

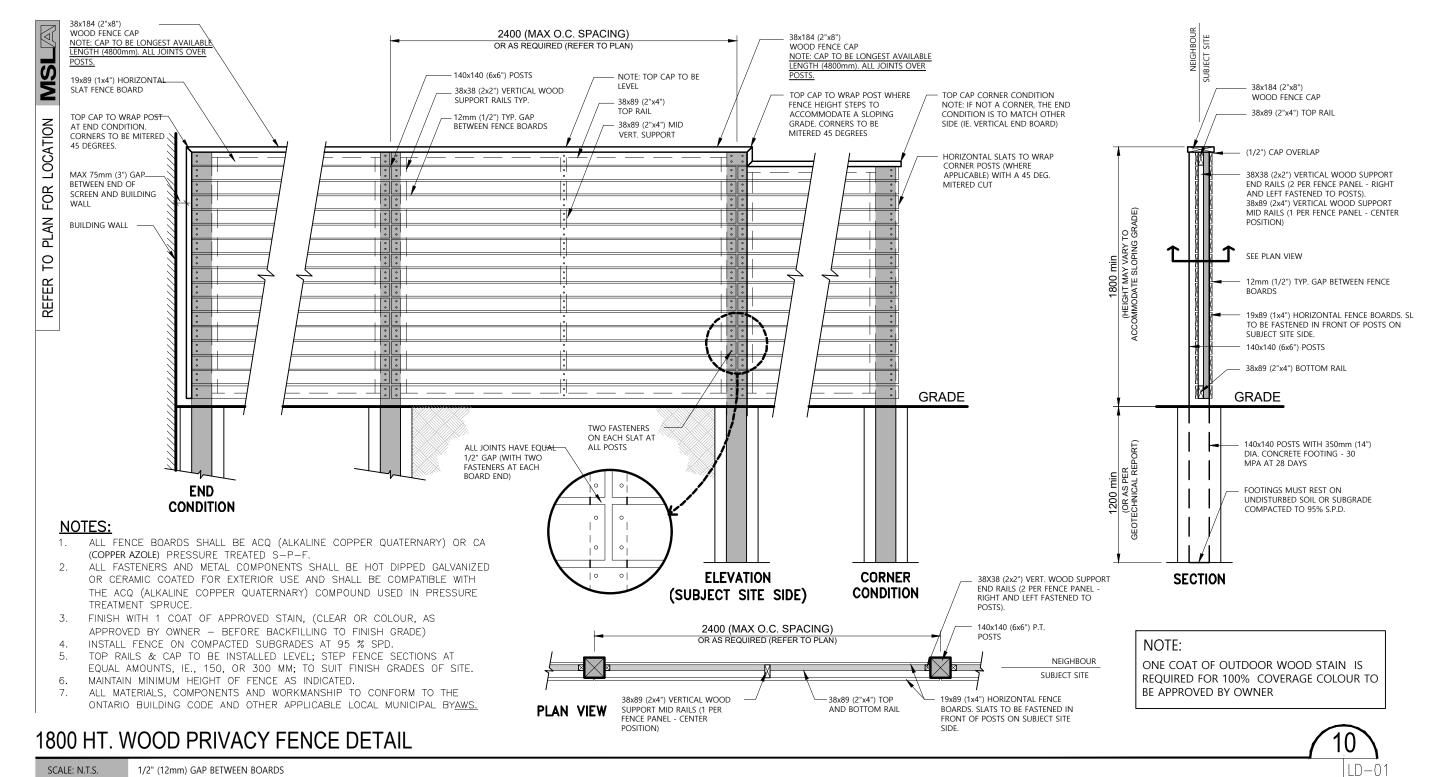

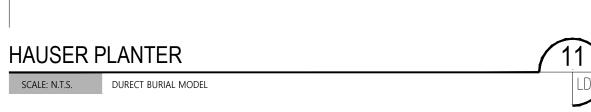

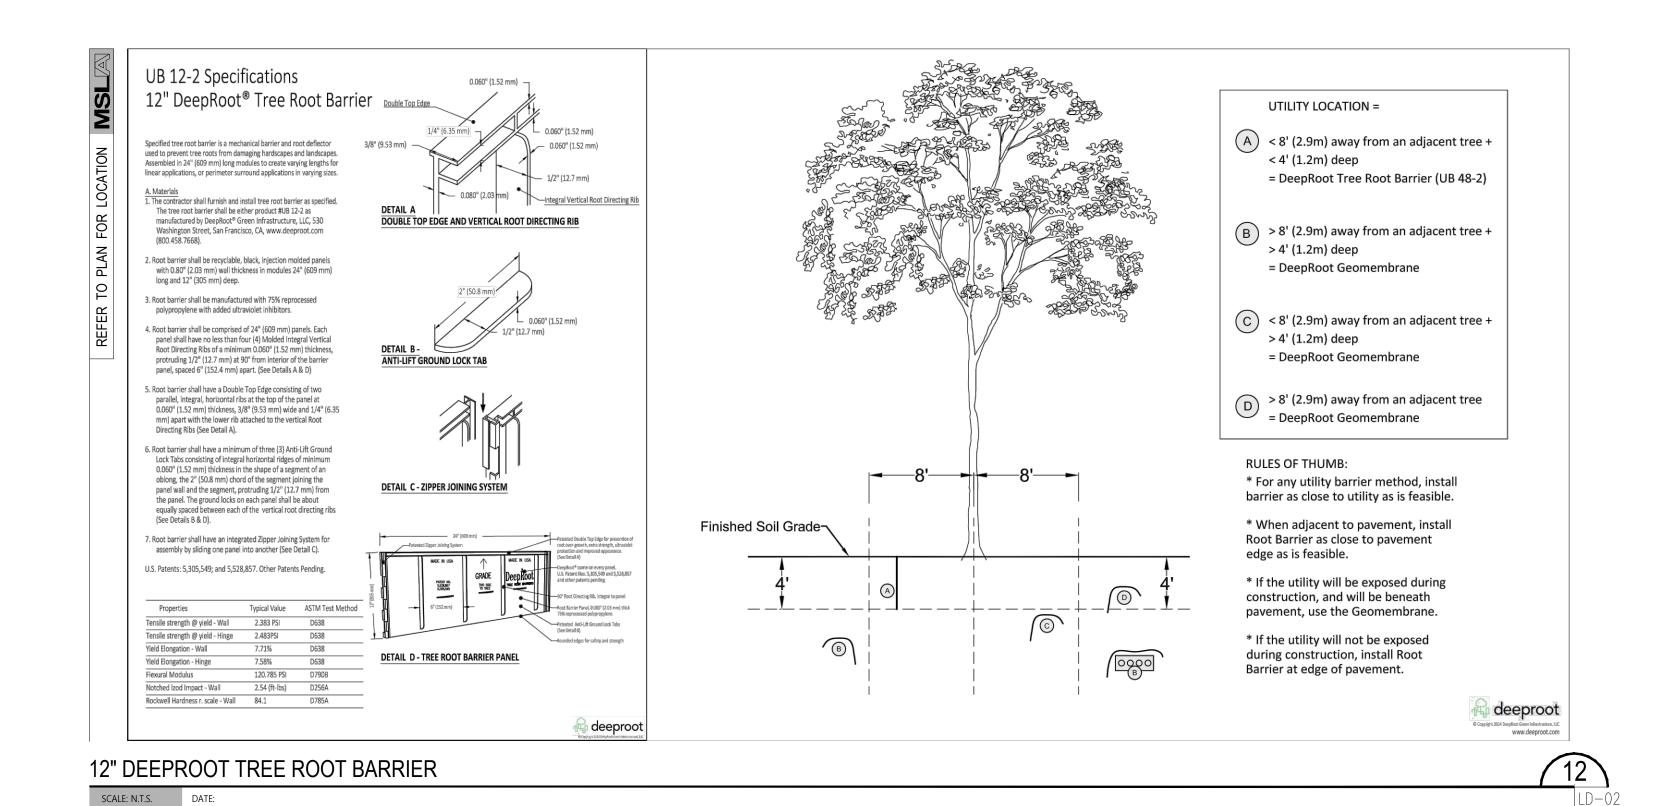



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Municipality:



Notes:

SNOW REMOVAL NOTE:

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CALA CAMBERS ON SIGN

Proposed Landscape and Site Upgrades
917 Merivale Road,

917 Merivale Road,
Ottawa, Ontario.
File Number: D07-12-24-0067

Scale: As Shown Date: APRIL 2024

Drawn By: **A.L.** Checked By: **L.M.**Drawing Title:

Landscape Details

Project No. Sheet No.

24120 LD-02