





ROADSIDE CATCH BASIN PROTECTION DETAIL: TERRAFIX SILTSACK SCALE: N.T.S.

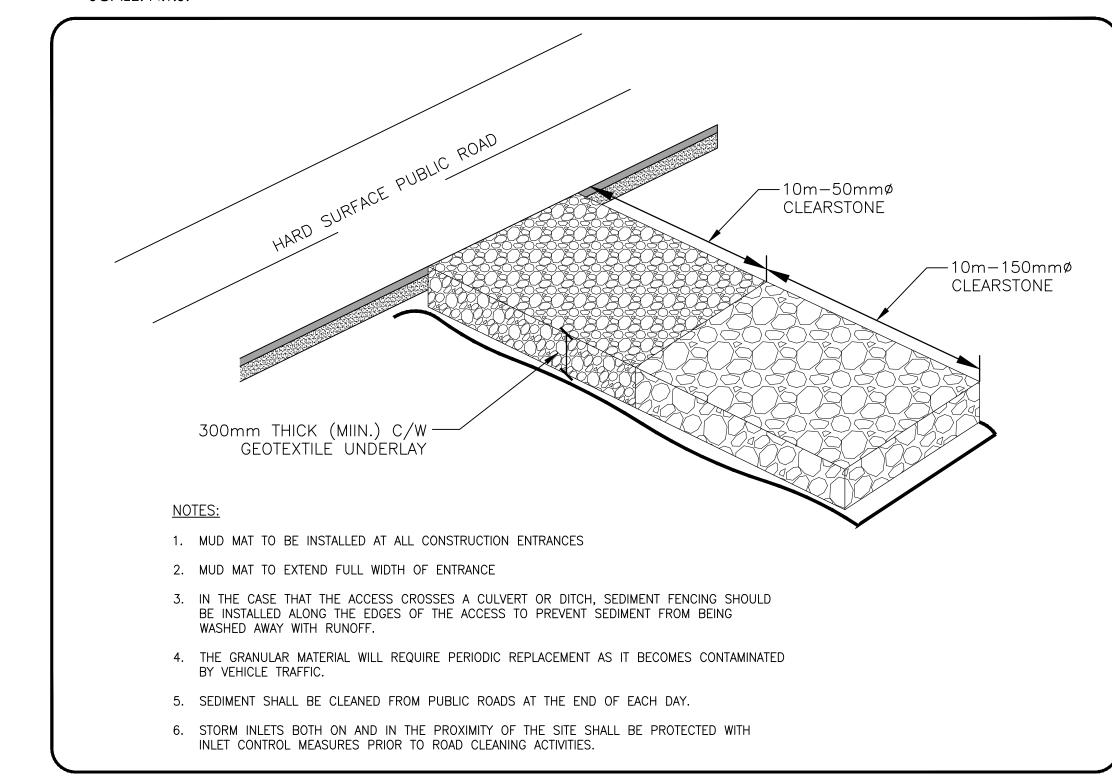



MUD MAT ENTRANCE DETAIL

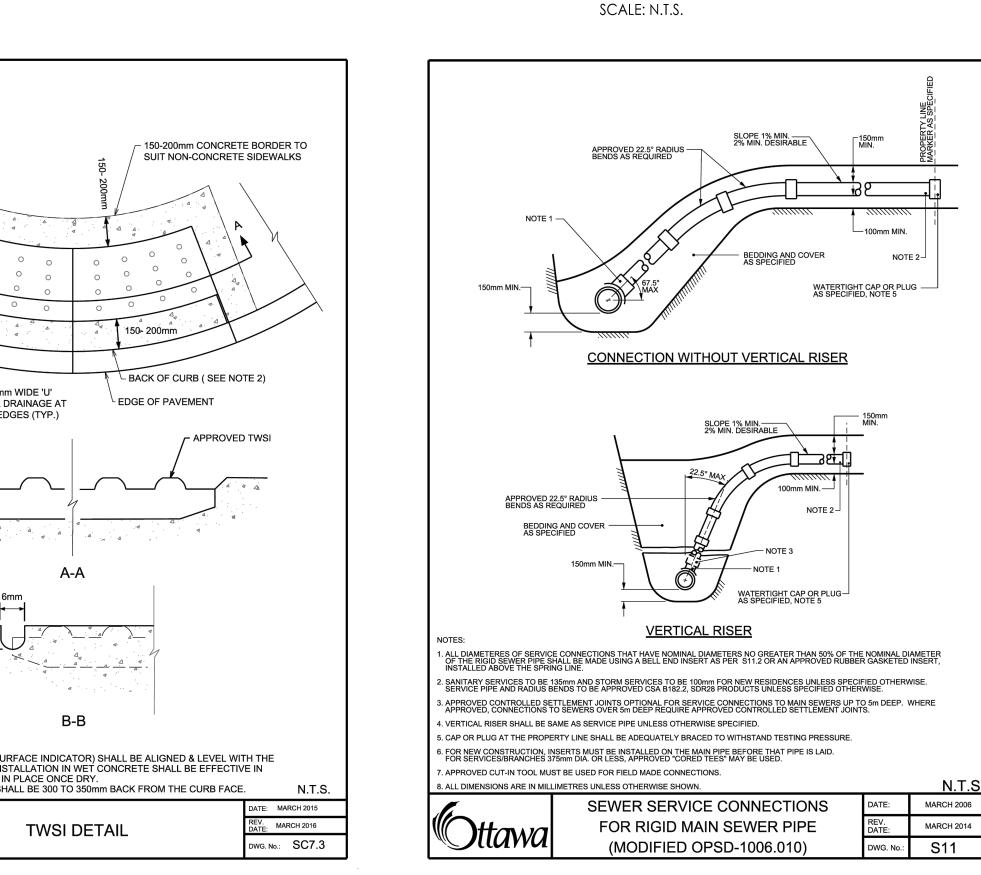


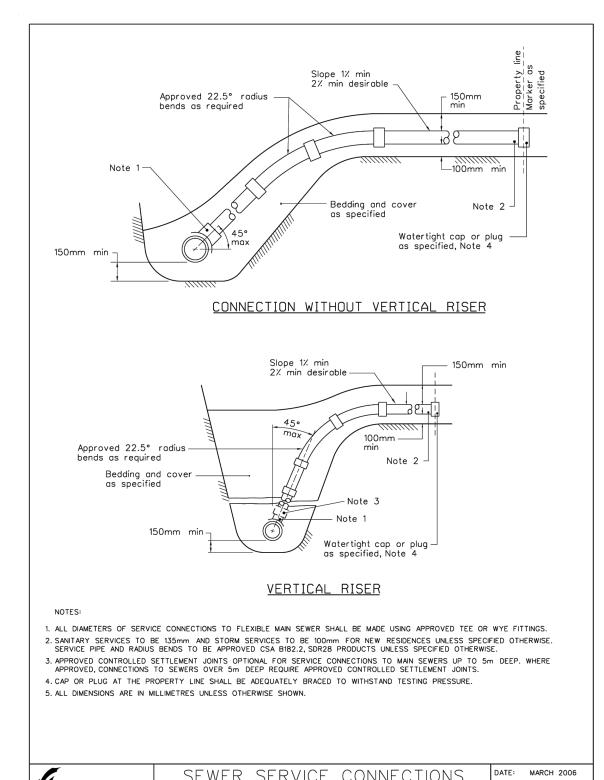

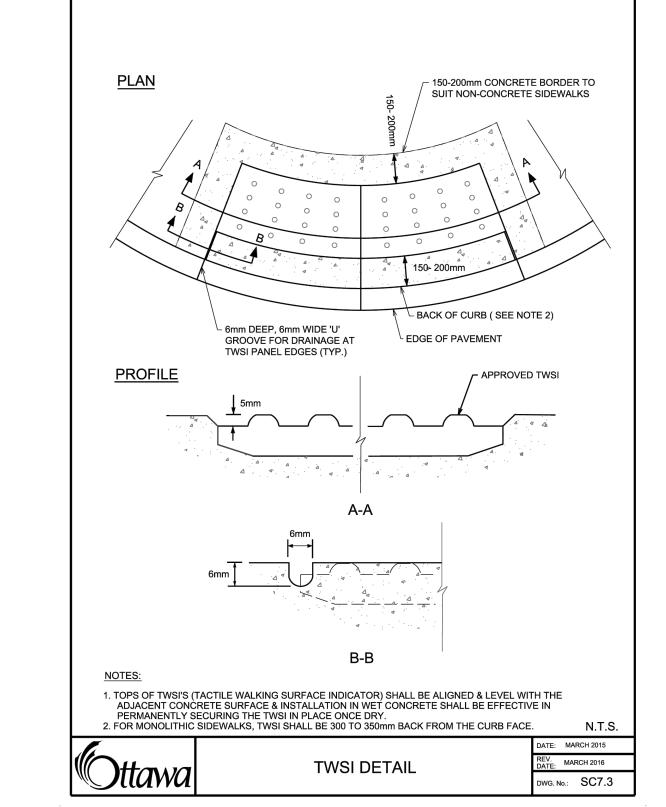

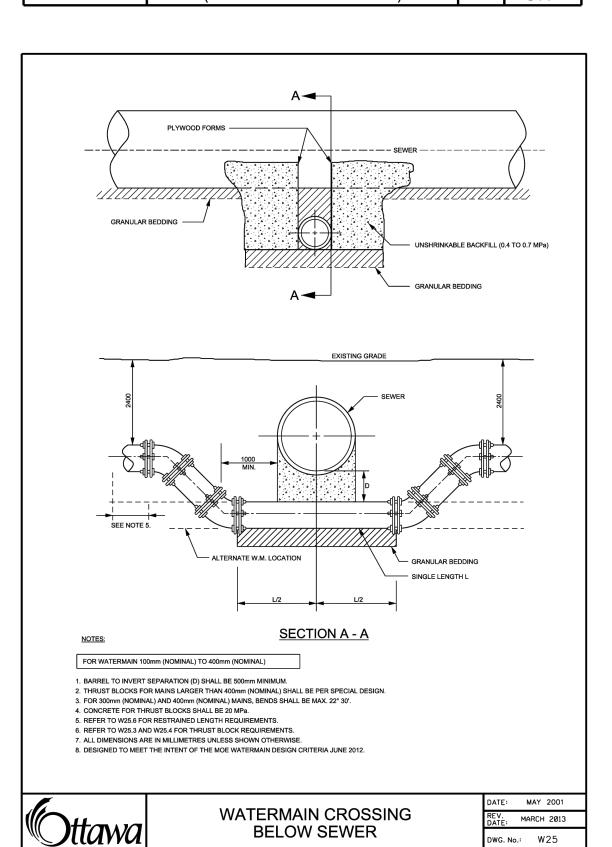

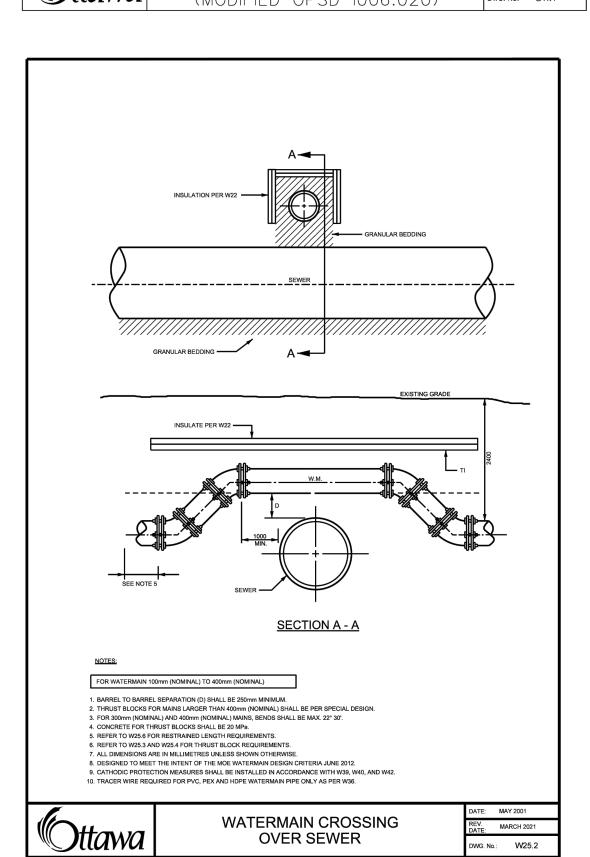

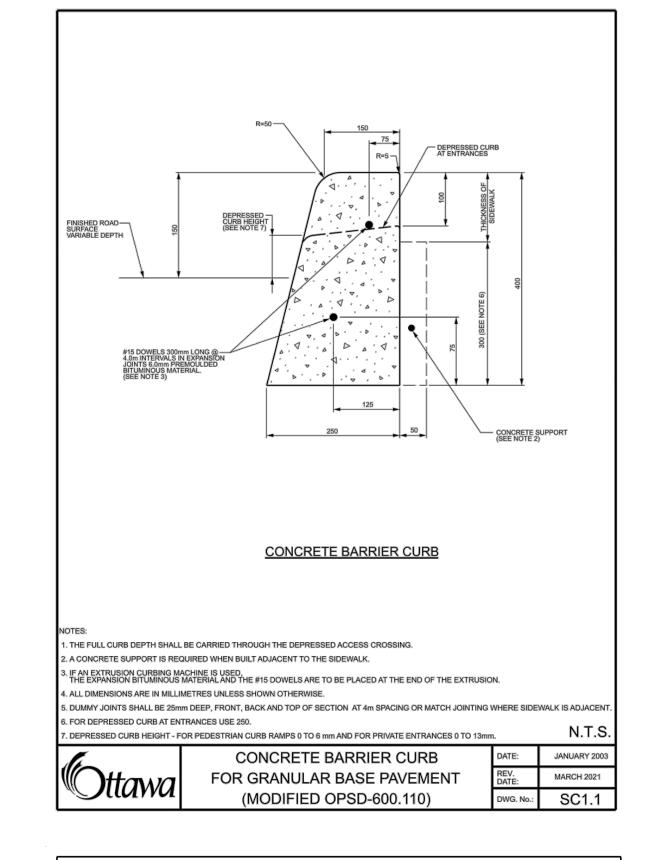

FRAME PLAN

632 —

_____ 572 _____

SECTION A-A

2. ALL DIMENSIONS ARE IN MILLIMETRES UNLESS SHOWN OTHERWISE.

3. FOR NEW CONSTRUCTION WHERE SURFACE INLETS ARE SPECIFIED.

SECTION B-B

SEE DETAIL 1

PLAN

624

o Ω | - 559 -

SECTION C-C

-| -| 25

SECTION D-D -

PERFORATED

-| | | 25 |

SECTION D-D -

. ALL DIMENSIONS SHOWN ARE FOR FINISHED CASTINGS ONLY. PATTERN MAKERS AND CASTING SHOP SHOULD MAKE ALLOWANCES ACCORDINGLY.

4. COMPANIES WITH GRATE DIMENSIONS NOT EXACTLY THE SAME AS SHOWN ABOVE WILL ALSO BE CONSIDERED.


5. ALTERNATE SOLID COVER TO HAVE EYE 25mm Dio. HOLE WITH 25mm APPROVED PLUG


SOLID ALTERNATE


HEAVY DUTY "FISH" TYPE

ROUND CATCH BASIN COVER

(MODIFIED OPSD-400.07)

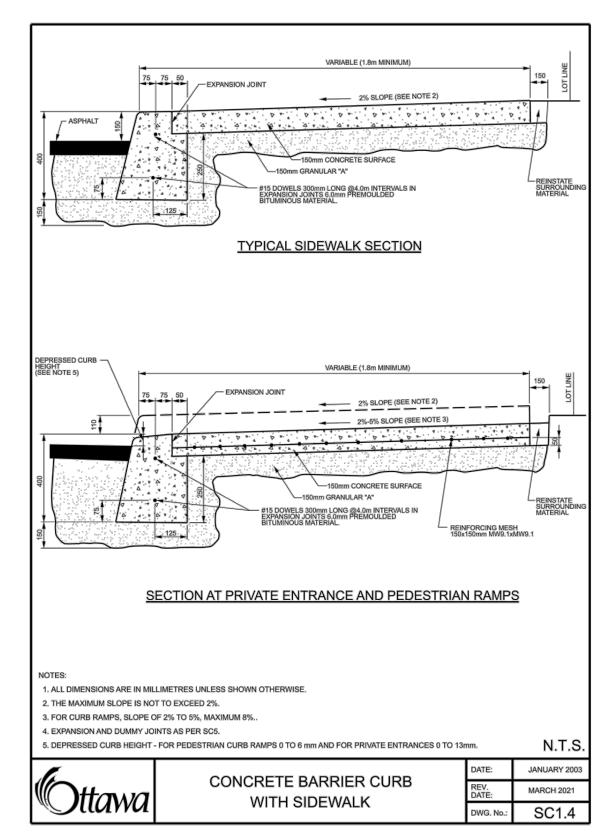

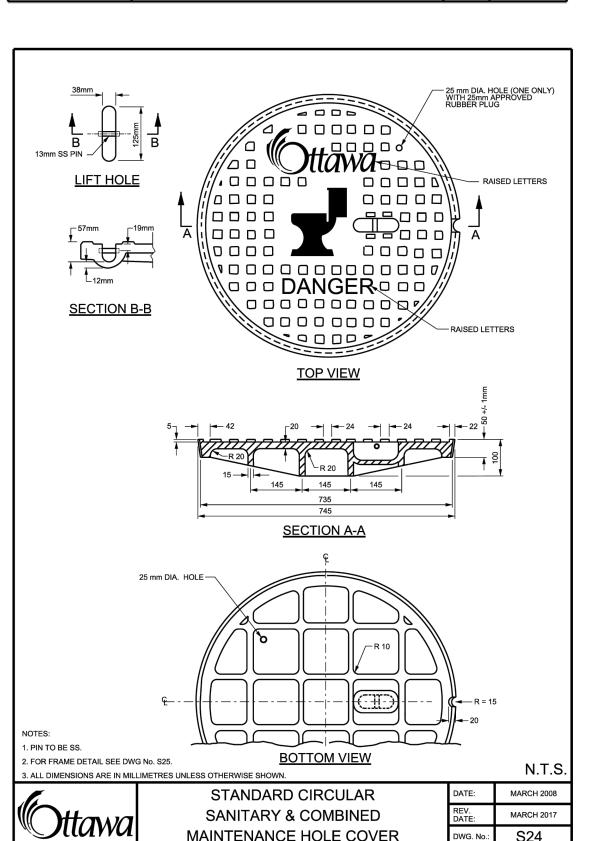

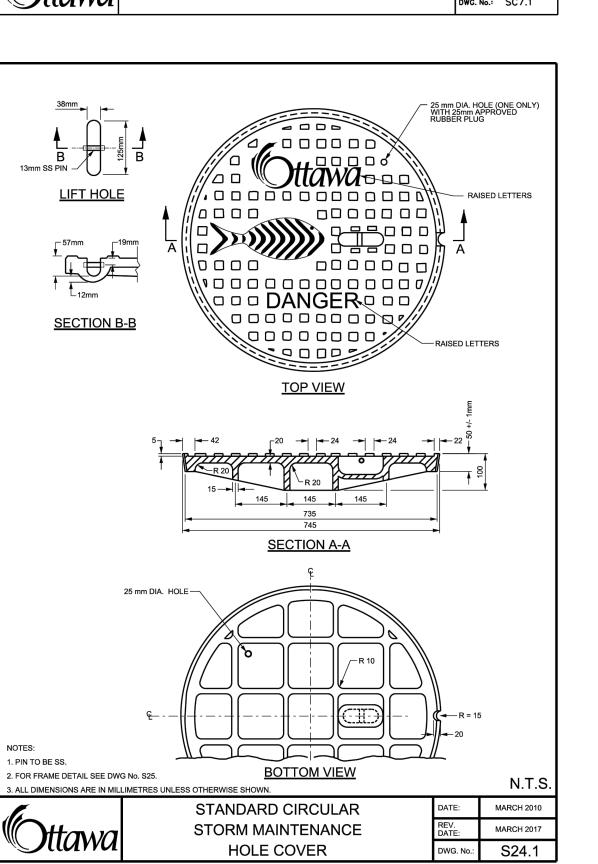

CURB RETURN AT A PRIVATE OR COMMERCIAL ENTRANCE - UNCONTROLLED INTERSECTION


CURB RETURN AT A PRIVATE OR COMMERCIAL ENTRANCE WITH BOULEVARD - UNCONTROLLED INTERSECTION


5. UNCONTROLLED INTERSECTION MEANS AN ENTRANCE NOT LOCATED AT A TRAFFIC SIGNAL OR ALL-WAY STOP CONTROL.

1. ALL DIMENSIONS ARE IN MILLIMETRES UNLESS SHOWN OTHERWISE.

2. CURB DETAILS SEE SC1.1, SC1.2 AND SC1.3.

3. SIDEWALK DETAILS SEE SC2 AND SC3.

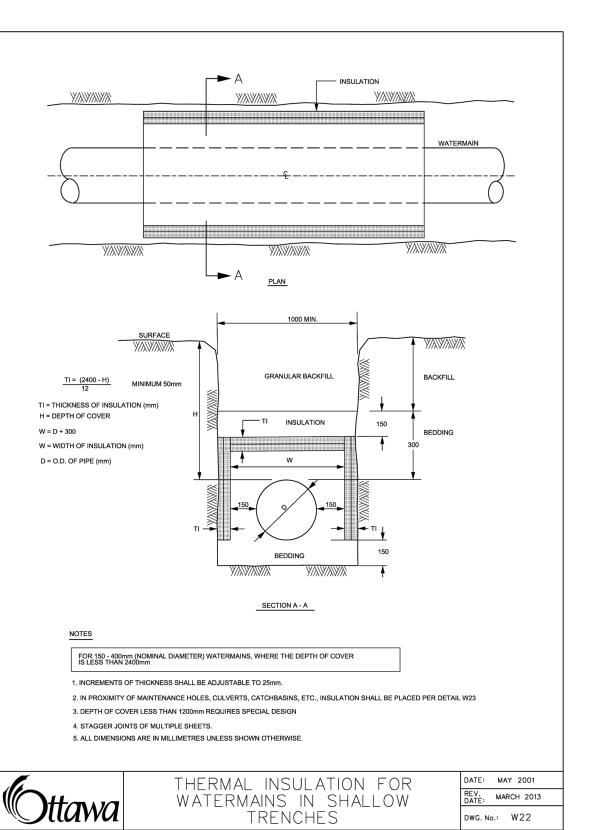

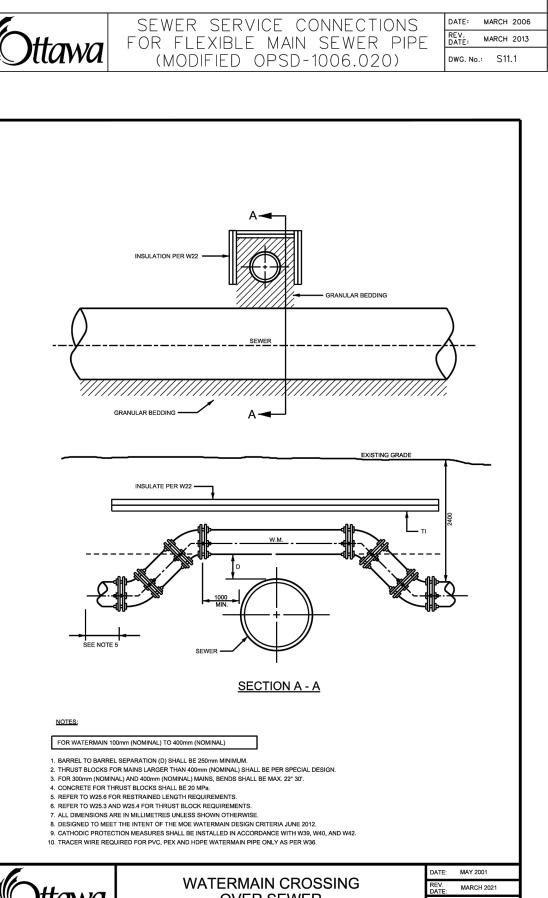



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authorized by Stantec is forbidden.

PROPOSED SILT FENCE BOUNDARY AS PER OPSD 219.110 PROPOSED STRAW BALE BARRIER AS PER OPSD 219.100 PROPOSED CATCH BASIN PROTECTION AS PER TERRAFIX SILTSACK DETAIL

PROPOSED MUD MAT LOCATION

PROPOSED CATCHBASIN

PROPOSED VALVE BOX PROPOSED VALVE CHAMBER PROPOSED FIRE HYDRANT PROPOSED SANITARY SEWER MANHOLE PROPOSED STORM SEWER MANHOLE

CONTRACTOR TO PROVIDE EROSION AND SEDIMENT CONTROLS (BEST MANAGEMENT PRACTICES) DURING CONSTRUCTION OF THIS PROJECT. EROSION MUST BE MINIMIZED AND SEDIMENTS MUST BE REMOVED FROM CONSTRUCTION SITE RUN-OFF IN ORDER TO PROTECT DOWNSTREAM AREAS. DURING ALL CONSTRUCTION, EROSION AND SEDIMENTATION SHOULD BE CONTROLLED BY THE

- LIMIT THE EXTENT OF EXPOSED SOILS AT ANY GIVEN TIME. REVEGETATE EXPOSED AREAS AND SLOPES AS SOON AS POSSIBLE.
- MINIMIZE AREA TO BE CLEARED AND GRUBBED.

RECEIVE RUN-OFF FROM THE SITE.

OR DOWNSTREAM WATERCOURSES.

- PROTECT EXPOSED SLOPES WITH PLASTIC OR SYNTHETIC MULCHES. INSTALL CATCH BASIN INSERTS OR EQUIVALENT IN ALL PROPOSED CATCH BASINS AND CATCH BASIN MANHOLES AND IN ALL EXISTING CATCH BASINS THAT WILL
- A SILT FENCE SHALL BE INSTALLED AROUND THE PERIMETER OF ALL AND ANY STOCKPILES OF MATERIAL TO BE USED OR REMOVED FROM SITE. (LOCATION TO
- A VISUAL INSPECTION SHALL BE DONE DAILY ON SEDIMENT CONTROL MEASURES AND CLEANED OF ANY ACCUMULATED SILT AS REQUIRED. THE DEPOSITS WILL BE DISPOSED OFF SITE AS PER THE REQUIREMENTS OF THE CONTRACT.
- SEDIMENT CONTROL BARRIERS MAY ONLY BE REMOVED TEMPORARILY WITH APPROVAL OF CONTRACT ADMINISTRATOR TO ACCOMMODATE CONSTRUCTION OPERATIONS, ALL AFFECTED BARRIERS MUST BE REINSTATED AT NIGHT WHEN CONSTRUCTION IS COMPLETED. NO REMOVAL WILL OCCUR IF THERE IS A SIGNIFICANT RAINFALL EVENT ANTICIPATED (>10mm) UNLESS A NEW DEVICE HAS BEEN INSTALLED TO PROTECT EXISTING STORM AND SANITARY SEWER SYSTEMS,
- NO REFUELING OR CLEANING OF EQUIPMENT IS PERMITTED NEAR ANY EXISTING CONTRACTOR SHALL REMOVE SEDIMENT CONTROL MEASURES WHEN, IN THE OPINION OF THE CONTRACT ADMINISTRATOR, THE MEASURE(S) IS NO LONGER
- REQUIRED. NO CONTROL MEASURES SHALL BE PERMANENTLEY REMOVED WITHOUT PRIOR WRITTEN AUTHORIZATION FROM THE CONTRACT
- CONTRACT ADMINISTRATOR, CLEAN OUT ACCUMULATED SEDIMENTS AS THE CONTRACTOR SHALL IMMEDIATELY REPORT TO THE ENGINEER ANY
- ACCIDENTAL DISCHARGES OF SEDIMENT MATERIAL INTO THE WATERCOURSE. APPROPRIATE RESPONSE MEASURES, INCLUDING ANY REPAIRS TO EXISTING CONTROL MEASURES OR THE IMPLEMENTATION OF ADDITIONAL CONTROL MEASURES, SHALL BE CARRIED OUT BY THE CONTRACTOR WITHOUT DELAY.

THE CONTRACTOR SHALL PERIODICALLY, OR WHEN REQUESTED BY THE

- CONTRACTOR SHALL INSTALL MUD MATS AT BOTH ENTRANCES TO THE SITE.
- STORMWATER SWALES TO BE COVERED WITH HYDRO-SEED AND MULCH.

Drawing No.

2760-2770 SHEFFIELD ROAD

NEW INDUSTRIAL BUILDING

ISSUED FOR 1ST SPA SUBMISSION

File Name: 160401916 DB.dwa

Permit-Seal

Client/Project

RICHCRAFT

OTTAWA, ONTARIO

DETAIL SHEET

EROSION CONTROL PLAN AND

MJS DT 25.01.27

MJS DT 24.06.25

MJS DT MJS 24.05.26
Dwn. Chkd. Dsgn. YY.MM.DD

By Appd. YY.MM.DD