


	Common Name	Scheduled Si	Remarks
	Sugar Maple	70mm caliper	WB, Staked
	Common Hackberry	60mm caliper	WB, Staked
	Shagbark Hickory	60mm caliper	WB, Staked
	Autumn Gold Maidenhair Tree	70mm caliper	WB, Staked
	Burr Oak	70mm caliper	WB, Staked
	Northern Red Oak	70mm caliper	WB, Staked
OUS TREES			
	Autumn Spire Red Maple	60mm caliper	WB, Staked
inel'	Prairie Sentinel Hackberry	70mm caliper	WB, Staked
raves'	Streetkeeper Honeylocust	70mm caliper	WB, Staked
6			
	Ohio Buckeye	50mm caliper	WB, Staked
	Paper Birch, Canoe Birch	60mm caliper	WB, Staked
	Malus Dolgo	60mm caliper	WB Staked
	Ironwood	50mm caliper	WB, Staked
	Mountain Ash	45mm caliper	WB, Staked
	Basswood	70mm cal.	WB, Staked
er'	Frontier Elm	70mm caliper	WB, Staked

Non Ntv

		4	SMALL DECIDUOUS TREES	
Ntv	CcgC	4	Crataegus crus-galli inermis 'Cruzam'	Thornle
		18	CONIFEROUS TREES	
Ntv	Ab	4	Abies balsamea	Balsan
Ntv	Pg	7	Picea glauca	White
Ntv	Pr	2	Pinus resinosa	Red Pi
Ntv	Ps	5	Pinus strobus	Easter

Shrubs		-		
ТоН	62	Thuja occidentalis 'Holmstrup'	Holmstrup Cedar	1
Perenni	als			
Hs	84	Helictrochon semperverens	Ornamental Oats	3
CaKF	111	Calamagrostis x acutiflora 'Karl Foerster'	Feather Reed Grass	3

AND CONS.

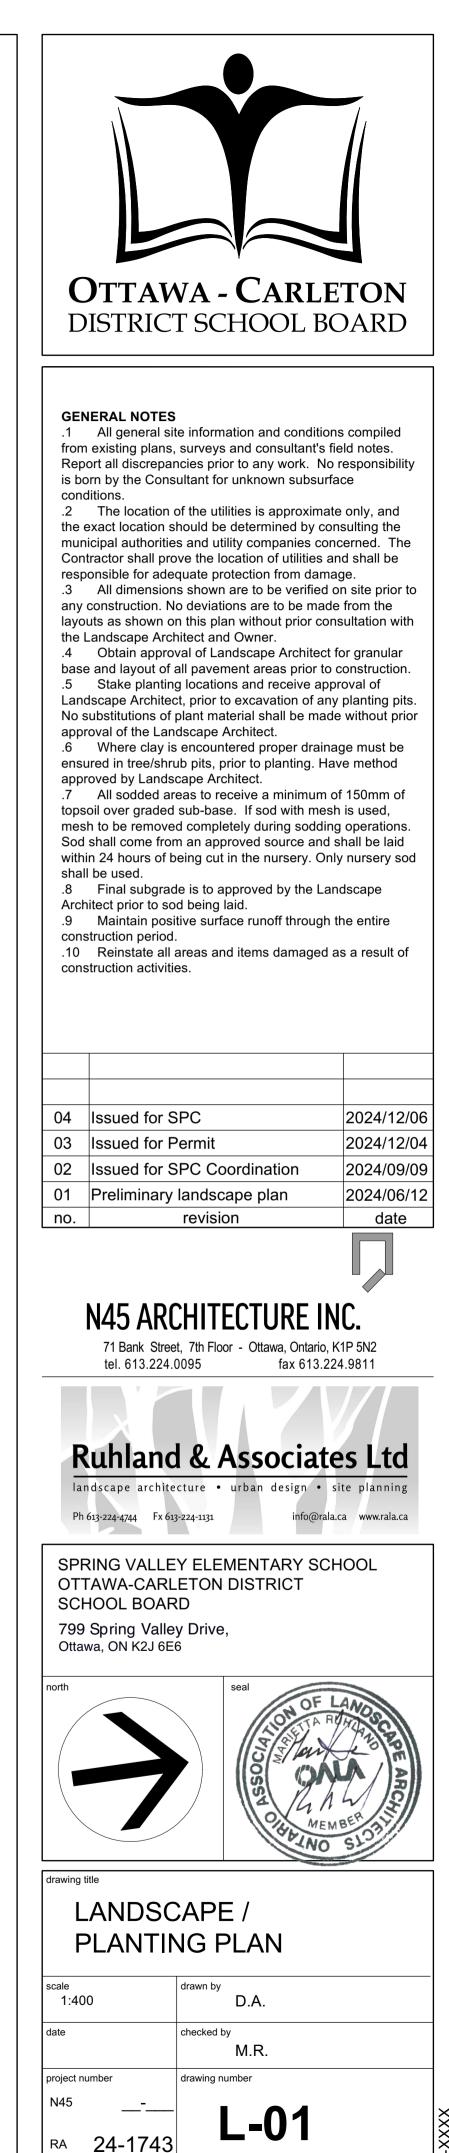


# XXXXX

CONTRACTOR TO VERIFY ALL DIMENSIONS AND

NOTIFY THE ARCHITECT OF ANY DISCREPANCIES


DO NOT SCALE DRAWINGS

BEFORE WORK COMMENCES.

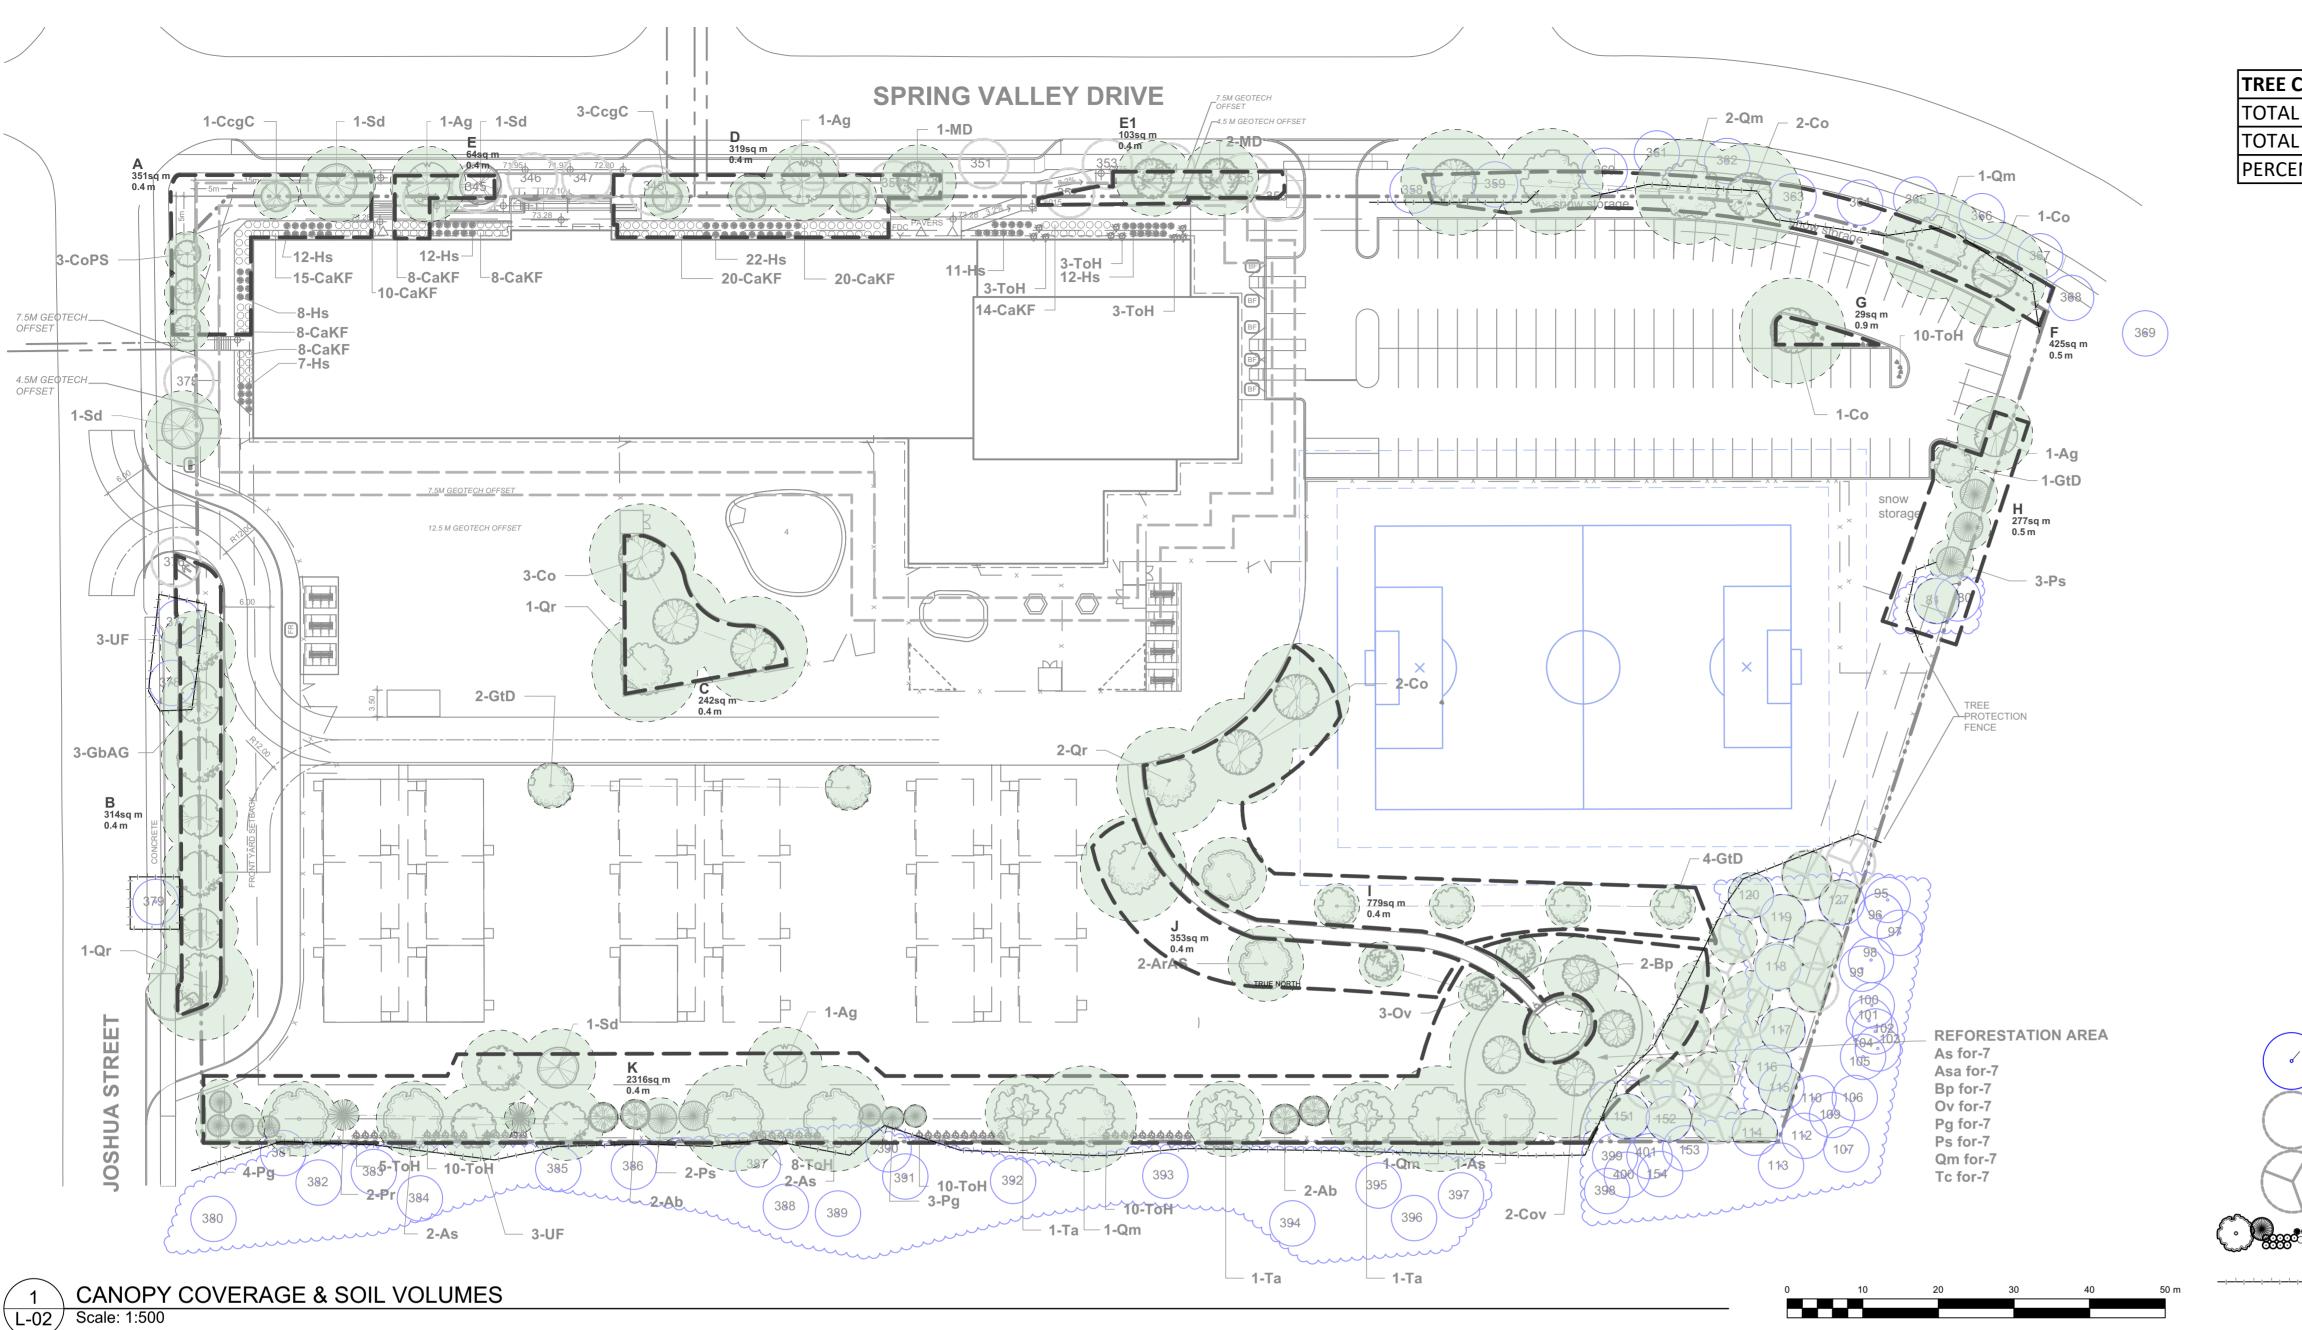

Soil Volume Area, Tree Quantity and Size	Tree Quantity	OTTAWA Target Soil Volume (m <sup>3</sup> )	Design Soil Volume	Soil Adequacy percentage
AREA A - 1 Medium, 1 Small, 3 L - Columnar Trees				
plant bed (351 sq m x 0.4 ave metre deep)	5	87.0	140.4	161%
AREA B - 1 Large, 6 Medium, 2 Ex. Trees				
plant bed (314 sq m x 0.4 ave metre deep)	8	144.0	125.6	87%
AREA C - 4 Large Trees				
plant bed (242 sq m x 0.4 ave metre deep)	4	72.0	96.8	134%
AREA D - 3 Small, 2 Medium Trees				
plant bed (319 sq m x 0.4 ave metre deep)	4	66.0	127.6	193%
AREA E - 1 Medium Tree				
plant bed (61 sq m x 0.7 ave metre deep)	2	36.0	42.7	119%
AREA E1 - 2 Medium Trees				
plant bed (103 sq m x 0.4 ave metre deep)	2	36.0	41.2	114%
AREA F - 6 Large, 3 Ex. Trees				
plant bed (425 sq m x 0.4 ave metre deep)	6	108.0	170.0	157%
AREA G - 1 Large Tree				
plant bed (29.5 sq m x 1.2ave metre deep)	1	30.0	35.4	118%
AREA H - 2 Medium Trees, 3 Conifers				
plant bed (277 sq m x 0.4ave metre deep)	5	90.0	110.8	123%
AREA I - 4 Large, 4 Medium Trees				
plant bed (779 sq m x 0.4ave metre deep)	17	306.0	311.6	102%
AREA J - 1 Large, 2 Medium Trees				
plant bed (353 sq m x 0.4ave metre deep)	3	54.0	141.2	261%
AREA K - 8 Large, 13 Medium Trees, 13 Con.				
plant bed (2316 sq m x 0.4ave metre deep)	28	504.0	926.4	184%

\* Smaller columnar trees, small ornamental trees with growth to 8-15cm DBH, large shrubs, and columnar conifers calculated using 'How much soil to grow a big tree' by DeepRoot as a guide

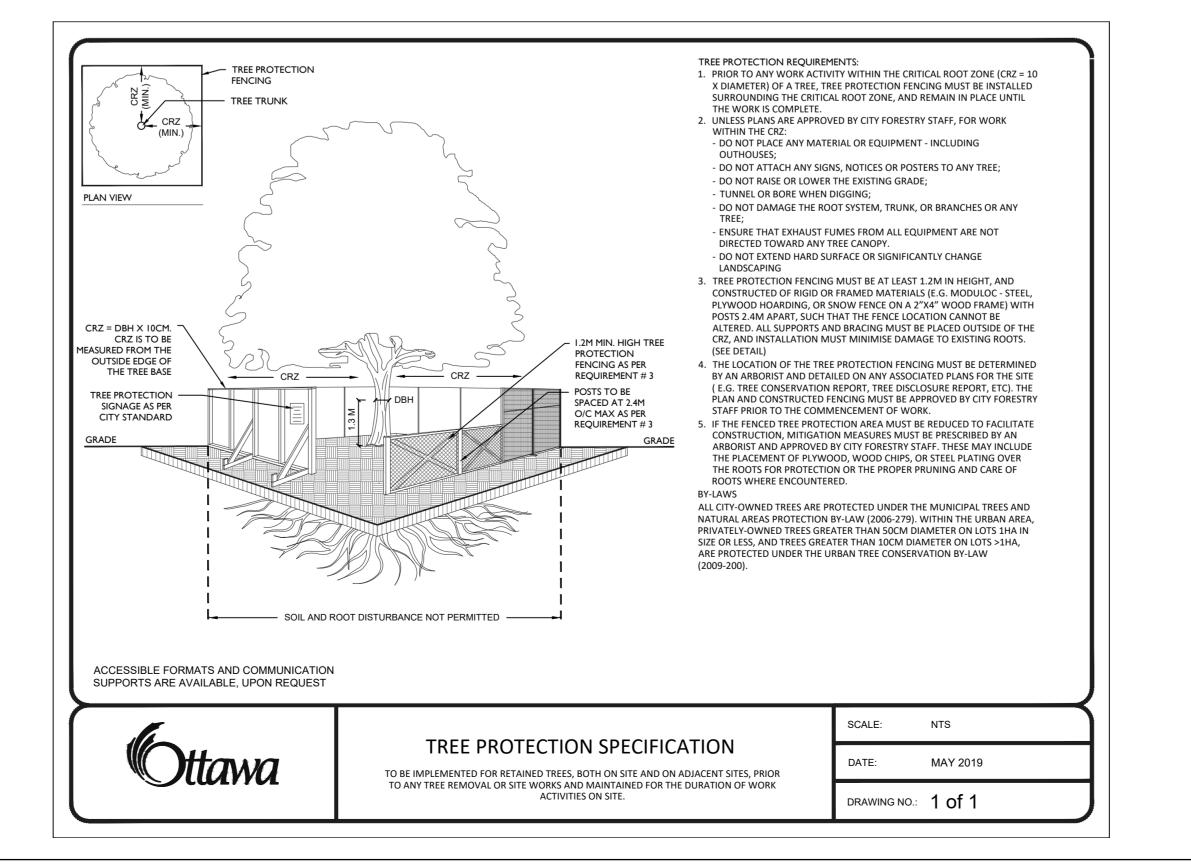

CANOPY COVERA		
CANOPY AREA	6471	m2
SITE AREA	28345	m2
NT COVERAGE	22.83%	



## GENERAL NOTES

.1 All general site information and conditions compiled from existing plans, surveys and consultant's field notes. Report all discrepancies prior to any work. No responsibility is born by the Consultant for unknown subsurface conditions.

.2 The location of the utilities is approximate only, and the exact location should be determined by consulting the municipal authorities and utility companies concerned. The Contractor shall prove the location of utilities and shall be responsible for adequate protection from damage.

.3 All dimensions shown are to be verified on site prior to any construction. No deviations are to be made from the layouts as shown on this plan without prior consultation with the Landscape Architect and Owner.

.4 Obtain approval of Landscape Architect for granular base and layout of all pavement areas prior to construction. .5 Stake planting locations and receive approval of Landscape Architect, prior to excavation of any planting pits. No substitutions of plant material shall be made without prior approval of the Landscape Architect.

.6 Where clay is encountered proper drainage must be ensured in tree/shrub pits, prior to planting. Have method approved by Landscape Architect.

.7 All sodded areas to receive a minimum of 150mm of topsoil over graded sub-base. If sod with mesh is used, mesh to be removed completely during sodding operations. Sod shall come from an approved source and shall be laid within 24 hours of being cut in the nursery. Only nursery sod shall be used.

.8 Final subgrade is to approved by the Landscape Architect prior to sod being laid.

.9 Maintain positive surface runoff through the entire construction period.

.10 Reinstate all areas and items damaged as a result of construction activities.

Issued for SPC	2024/12/0
Issued for Permit	2024/12/0
Issued for SPC Coordination	2024/09/0
Preliminary landscape plan	2024/06/1
revision	date
	Issued for Permit Issued for SPC Coordination Preliminary landscape plan


# N45 ARCHITECTURE INC.

71 Bank Street, 7th Floor - Ottawa, Ontario, K1P 5N2 tel. 613.224.0095 fax 613.224.9811



## SPRING VALLEY ELEMENTARY SCHOOL OTTAWA-CARLETON DISTRICT SCHOOL BOARD

799 Spring Valley Drive, Ottawa, ON K2J 6E6

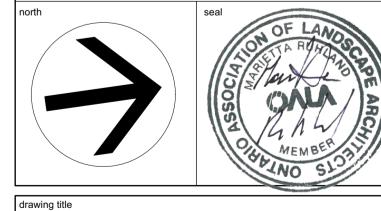

## CANOPY COVERAGE & SOIL VOLUMES

scale 1:500	drawn by D.A.	
date	checked by	
	M.R.	
project number	drawing number	
N45	L-02	
RA 24-1743		
	FY ALL DIMENSIONS AND T OF ANY DISCREPANCIES NCES.	revision

DO NOT SCALE DRAWINGS


EXISTING TREES TO BE PRESERVED


EXISTING TREES TO BE REMOVED AND REPLACED ELSEWHERE


TRANSPLANTED TREE

• PROPOSED PLANTING


------ TREE PROTECTION FENCE

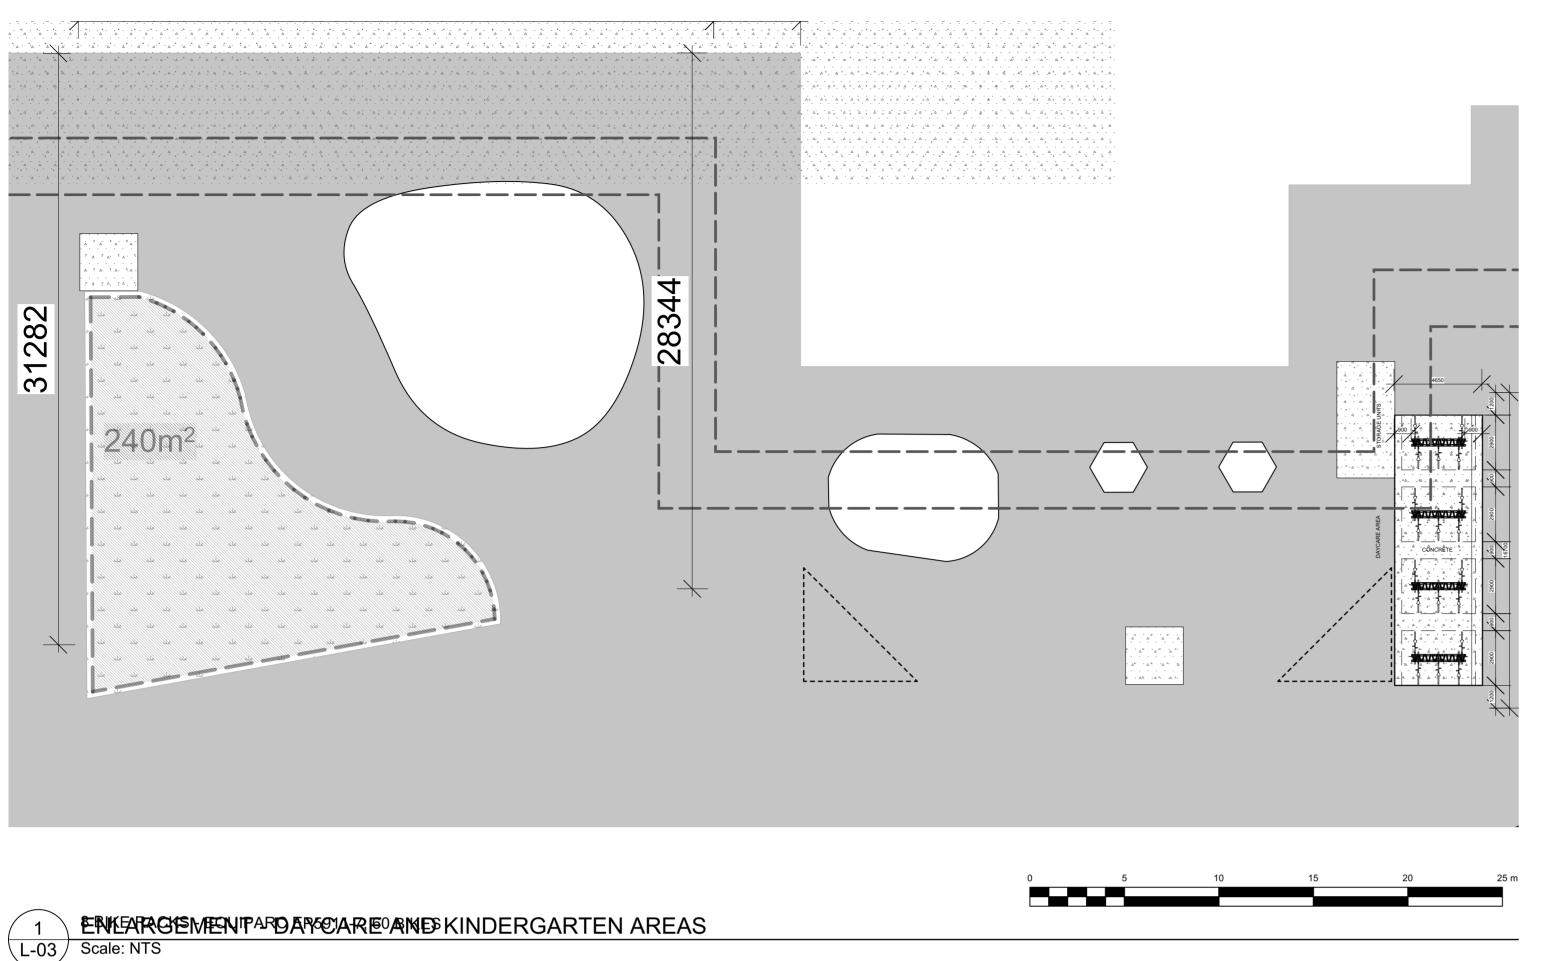


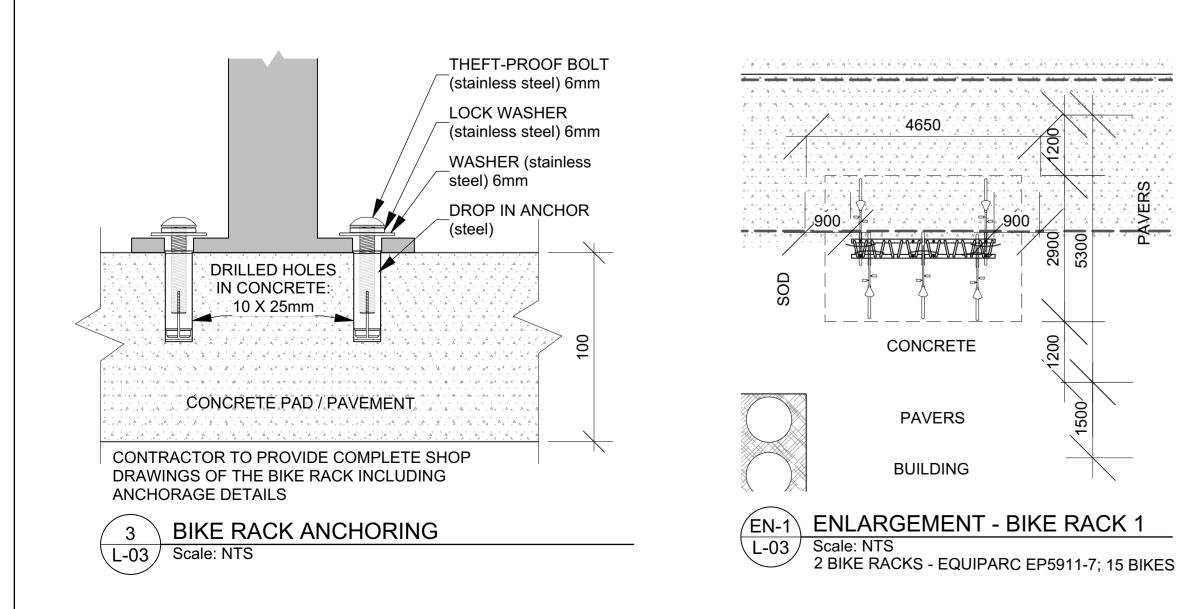

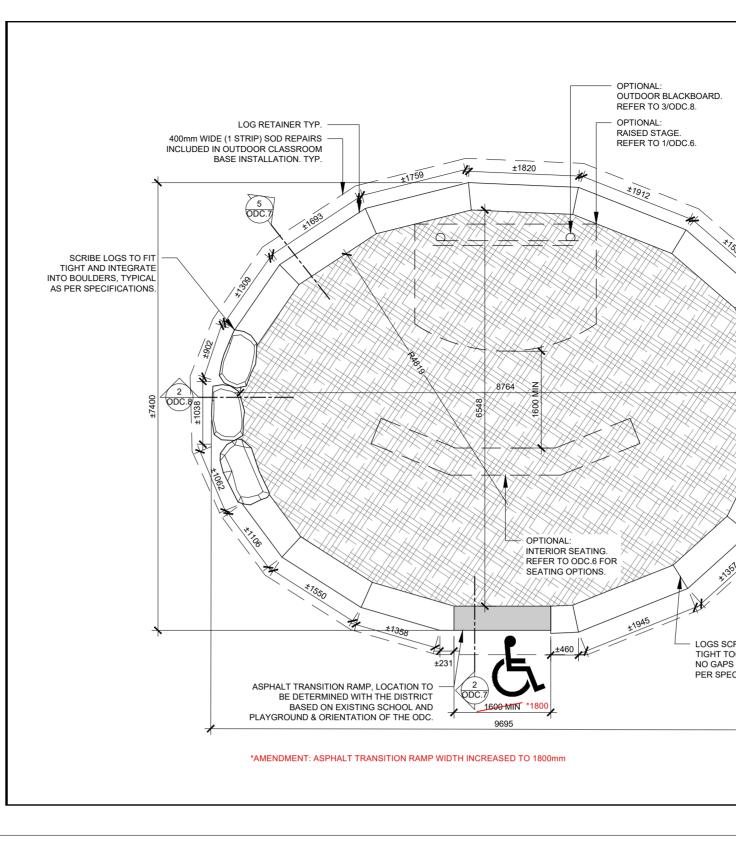



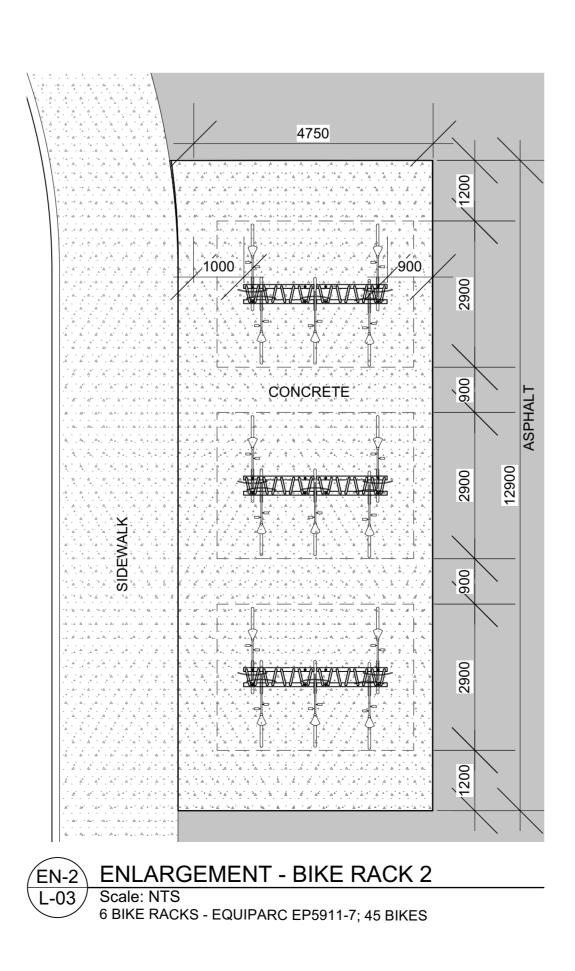

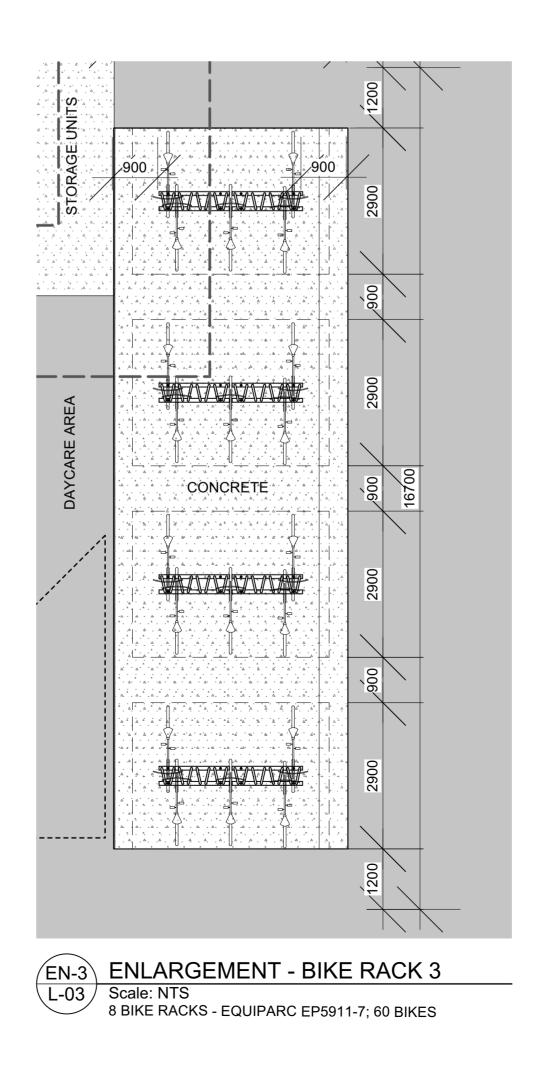

	LEGEND ASPHALT TRANSITION RAMP BOULDER SEATING	1224 ST	GN & CONSTRUCTION SERVICES ITTSVILLE MAIN STREET /ILLE, ONTARIO, K2S 0E3 TEL: (613) 596-8211 FAX: (613) 721-0045
	/ LOG RETAINER/SEATING	LOG & ROC	K LENGTHS
		TOTAL AREA	56m2
		MULCH AREA	44.5m2
	NOTES:	BOULDER LENGTH	4.7m
	1. LOCATION OF OUTDOOR BLACKBOARD, STAGE, AND SEATING	# OF BOULDERS	5
	ARE SUBJECT TO CHANGE OF LOCATION WITHIN THE	LOG LENGTH	20.6m
A LE	OUTDOOR CLASSROOM. EACH OF THE SEATING OPTIONS ARE INTERCHANGEABLE WITH ANY LAYOUT.	BASED ON THE FINIS AND DO NOT INCLUE MILLING OF MATERI/ CONSTRUCT THE OU AREA. CONTRACTO	DE ANY WASTE OR ALS REQUIRED TO JTDOOR CLASSROOM R TO REVIEW JDE ANY ADDITIONAL ED TO COMPLETE WITH SUITABLE
		5 4 3 2 1	DATE
1007		NUM MILESTONES DETAIL NUMBE DRAWING SCALE: SHEET NUMBE	I (YMD R NORTH ARROW TITLE
Solution of the second se		ARCHITECT PROJECT / LOCATION /	CONSULTANT
		OUTDOOR CLAS	SROOMS
BED TO FIT ETHER WITH IR VOIDS AS		VARIOUS SITES OTTAWA, ONTA	RIO
FICATIONS.		DRAWING OUTDOOR CLAS LAYOUT 4	SROOM
		DESIGN BY KURT BERGER	SHEET NO.
1		DRAWN BY	
			ODC.4
		CHECKED BY DAN FOURNIER	
		SCALE	1



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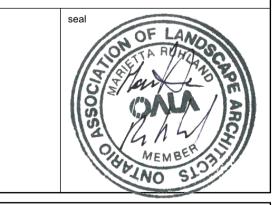
04	Issued for SPC	2024/12/06
03	Issued for Permit	2024/12/04
02	Issued for SPC Coordination	2024/09/09
01	Preliminary landscape plan	2024/06/12
no.	revision	date

# N45 ARCHITECTURE INC.

71 Bank Street, 7th Floor - Ottawa, Ontario, K1P 5N2 tel. 613.224.0095 fax 613.224.9811



799 Spring Valley Drive, Ottawa, ON K2J 6E6




## drawing title

drawn by D.A. checked by M.R. project number drawing number N45 RA 24-1743 CONTRACTOR TO VERIFY ALL DIMENSIONS AND NOTIFY THE ARCHITECT OF ANY DISCREPANCIES BEFORE WORK COMMENCES. DO NOT SCALE DRAWINGS

LANDSCAPE DETAILS

# XXXXX

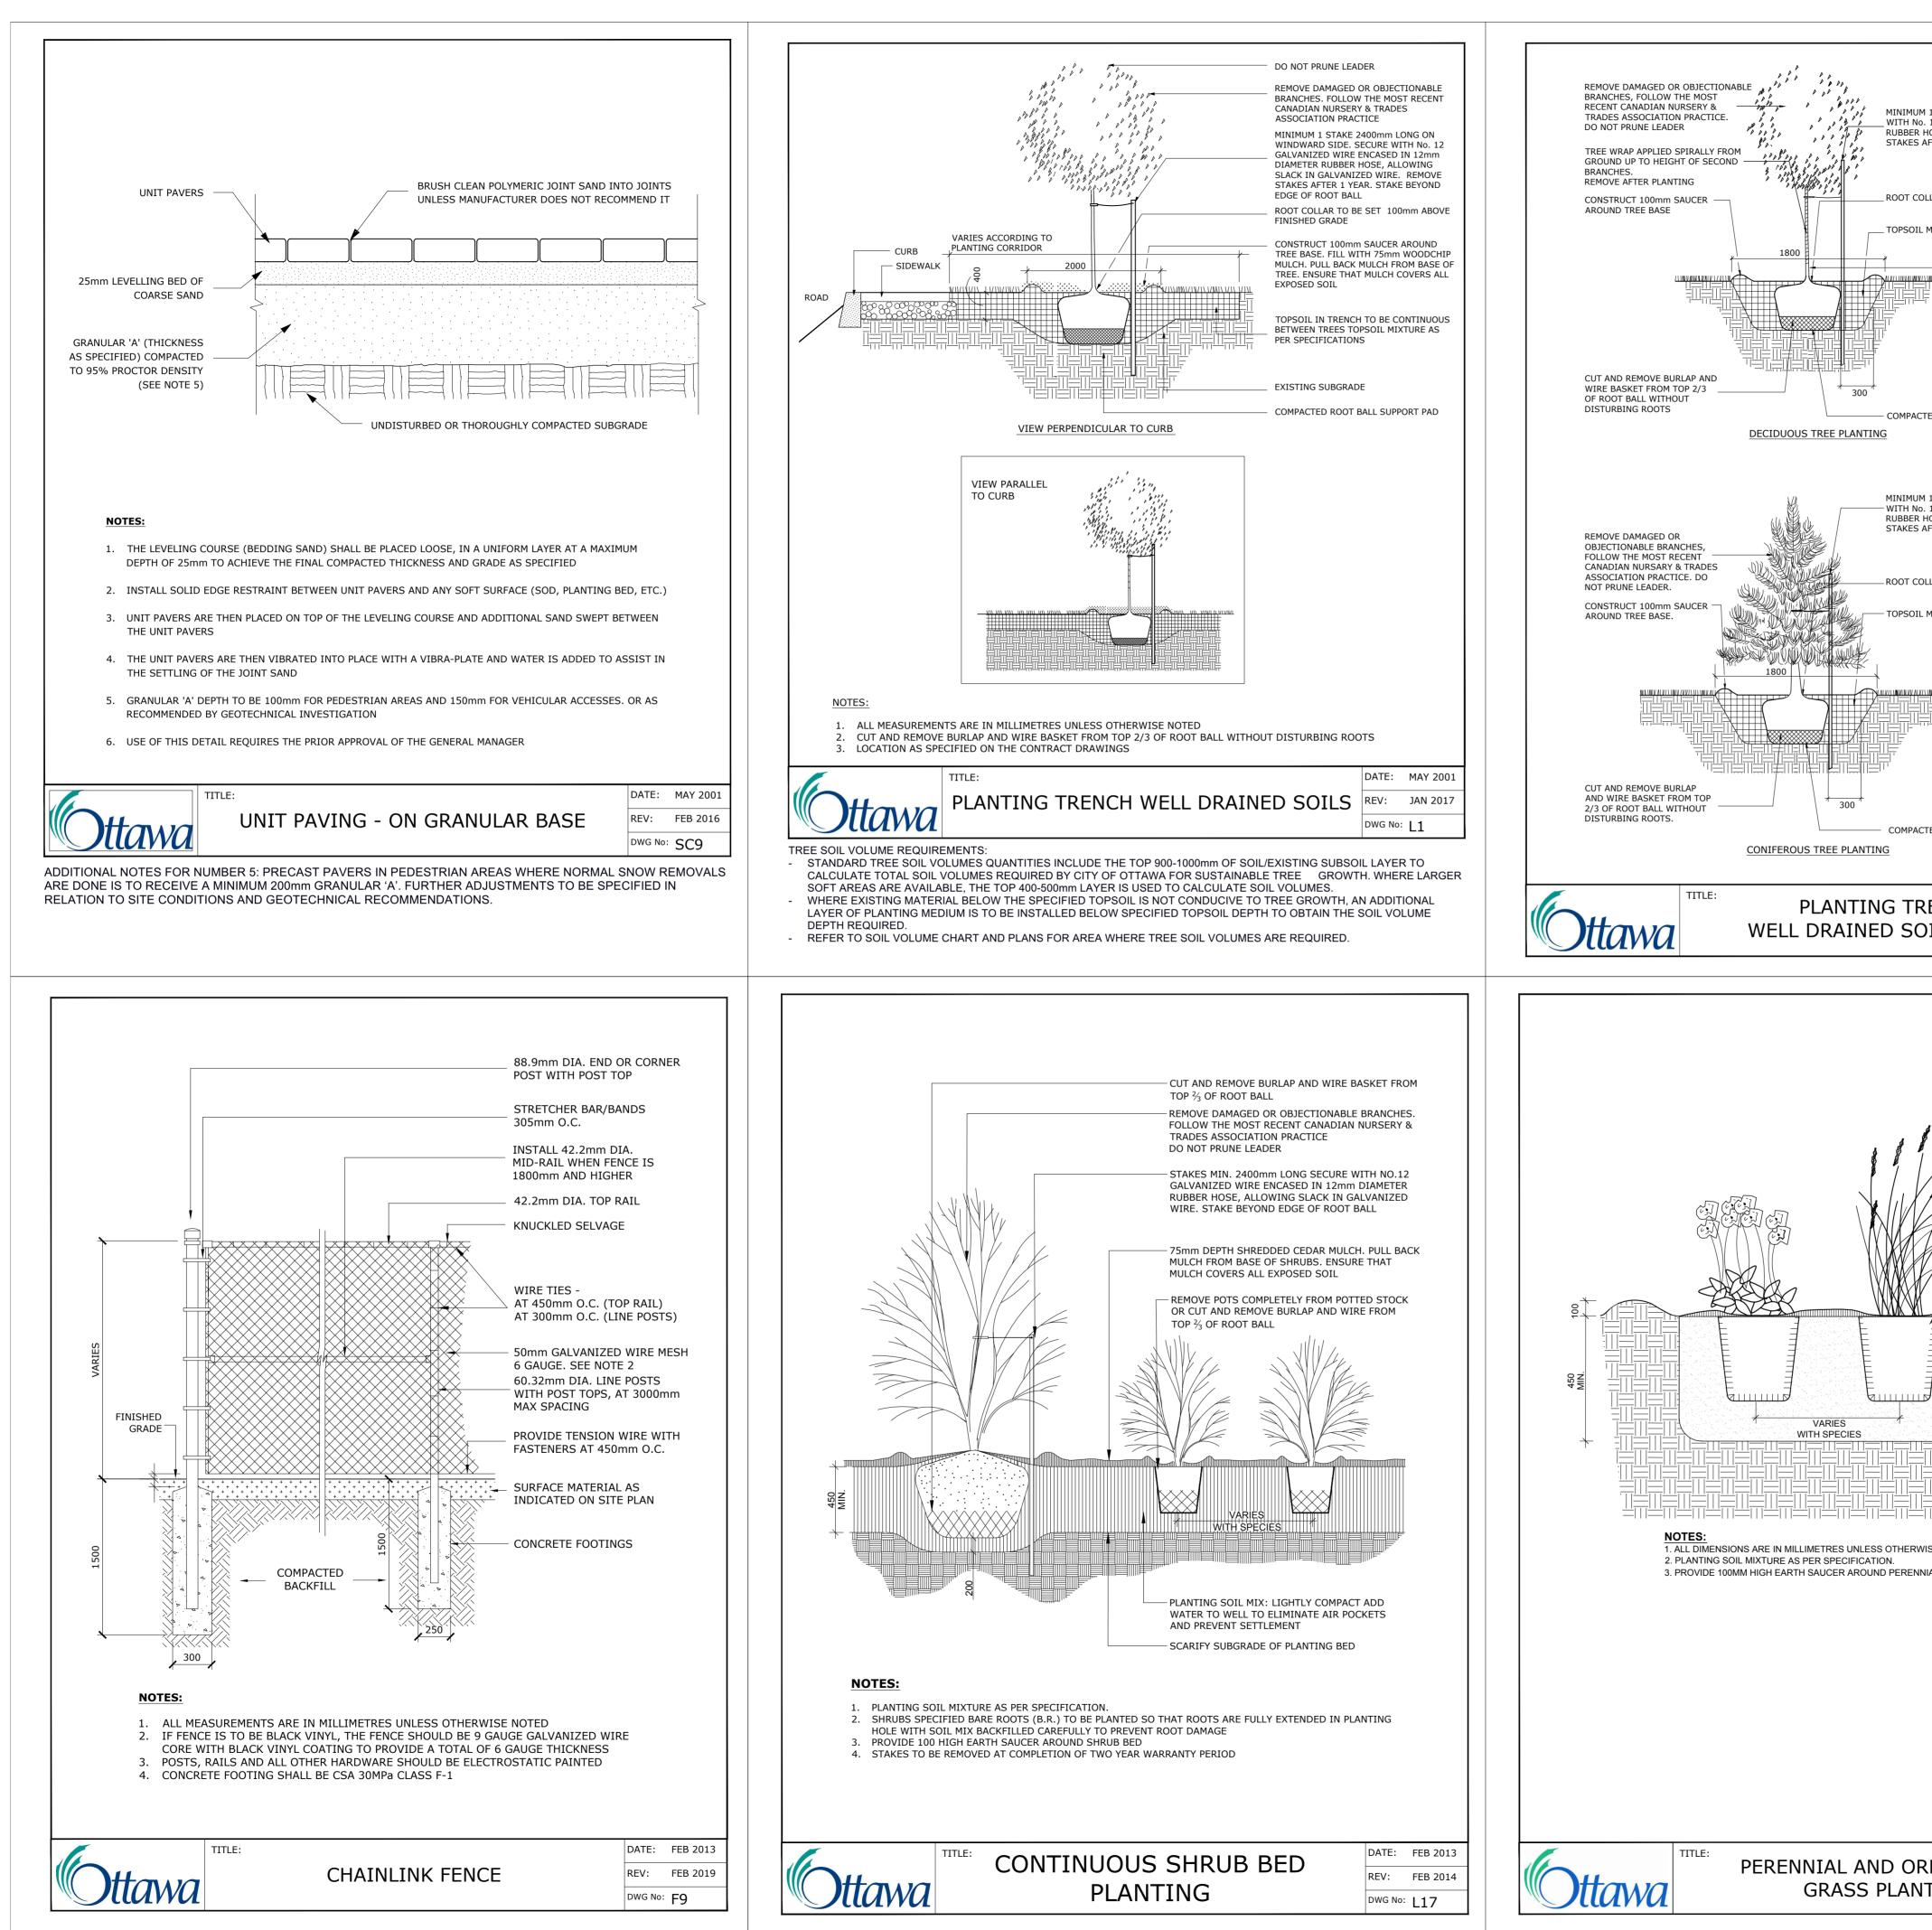

1 STAKE 2400mm LONG ON WINDWARD SIDE. SECURE 12 GALVANIZED WIRE ENCASED IN 12mm DIAMETER IOSE, ALLOWING SLACK IN GALVANIZED WIRE. REMOVE FTER ONE YEAR. STAKE BEYOND EDGE OF ROOT BALL LLAR TO BE SET 100mm ABOVE FINISHED GRADE MIXTURE AS PER SPECIFICATION APPLY APPROVED PLASTIC RODENT GUARD 450mm MINIMUM	OTTAWA - CARLE DISTRICT SCHOOL B	
NOTE: 1. ALL MEASUREMENTS ARE IN MILLIMETRES UNLESS OTHERWISE NOTED 2. LOCATION AS SPECIFIED ON THE CONTRACT DRAWINGS ED SUBGRADE	GENERAL NOTES .1 All general site information and condition from existing plans, surveys and consultant's Report all discrepancies prior to any work. N is born by the Consultant for unknown subsuit conditions. .2 The location of the utilities is approximate	field notes. lo responsibility rface ate only, and
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ENCH       DATE:       MAY 2001         PILS (LOTS)       REV:       JAN 2017         DWG No:       L2	04Issued for SPC03Issued for Permit02Issued for SPC Coordination01Preliminary landscape planno.revision	2024/12/06 2024/12/04 2024/09/09 2024/06/12 date
REMOVE FROM POT 75mm SHREDDED BARK MULCH PLANT PERENNIALS AND GRASSES 25mm HIGHER THAN ADJACENT GRADE SAUCER	N45 ARCHITECTURE         71 Bank Street, 7th Floor - Ottawa, Ontario         tel. 613.224.0095       fax 613.2         Ruhland & Associat         Jandscape architecture - urban design -         Ph 613-224-4744       Fx 613-224-1131         SPRING VALLEY ELEMENTARY SO	site planning ala.ca www.rala.ca
PLANTING SOIL MIX: LIGHTLY COMPACT TO ELIMINATE AIR POCKETS AND PREVENT SETTLEMENT SCARIFY SUBGRADE OF PLANTING BED SE NOTED. IAL/GRASS BED.	north	LANDSCHOFE ARCH
DATE: JAN 2015	drawing title LANDSCAPE DETAIL scale drawn by D.A. date checked by M.R. project number N45	_S
NAMENTAL TING DWG No: L21	RA 24-1743 L-04 CONTRACTOR TO VERIFY ALL DIMENSIONS AND NOTIFY THE ARCHITECT OF ANY DISCREPANCIES BEFORE WORK COMMENCES. DO NOT SCALE DRAWINGS	revision

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