


ANSI D 864mm x 55  
 Approved: YF  
 Checked: JNT  
 Designer: JNT  
 Project Management Initials:

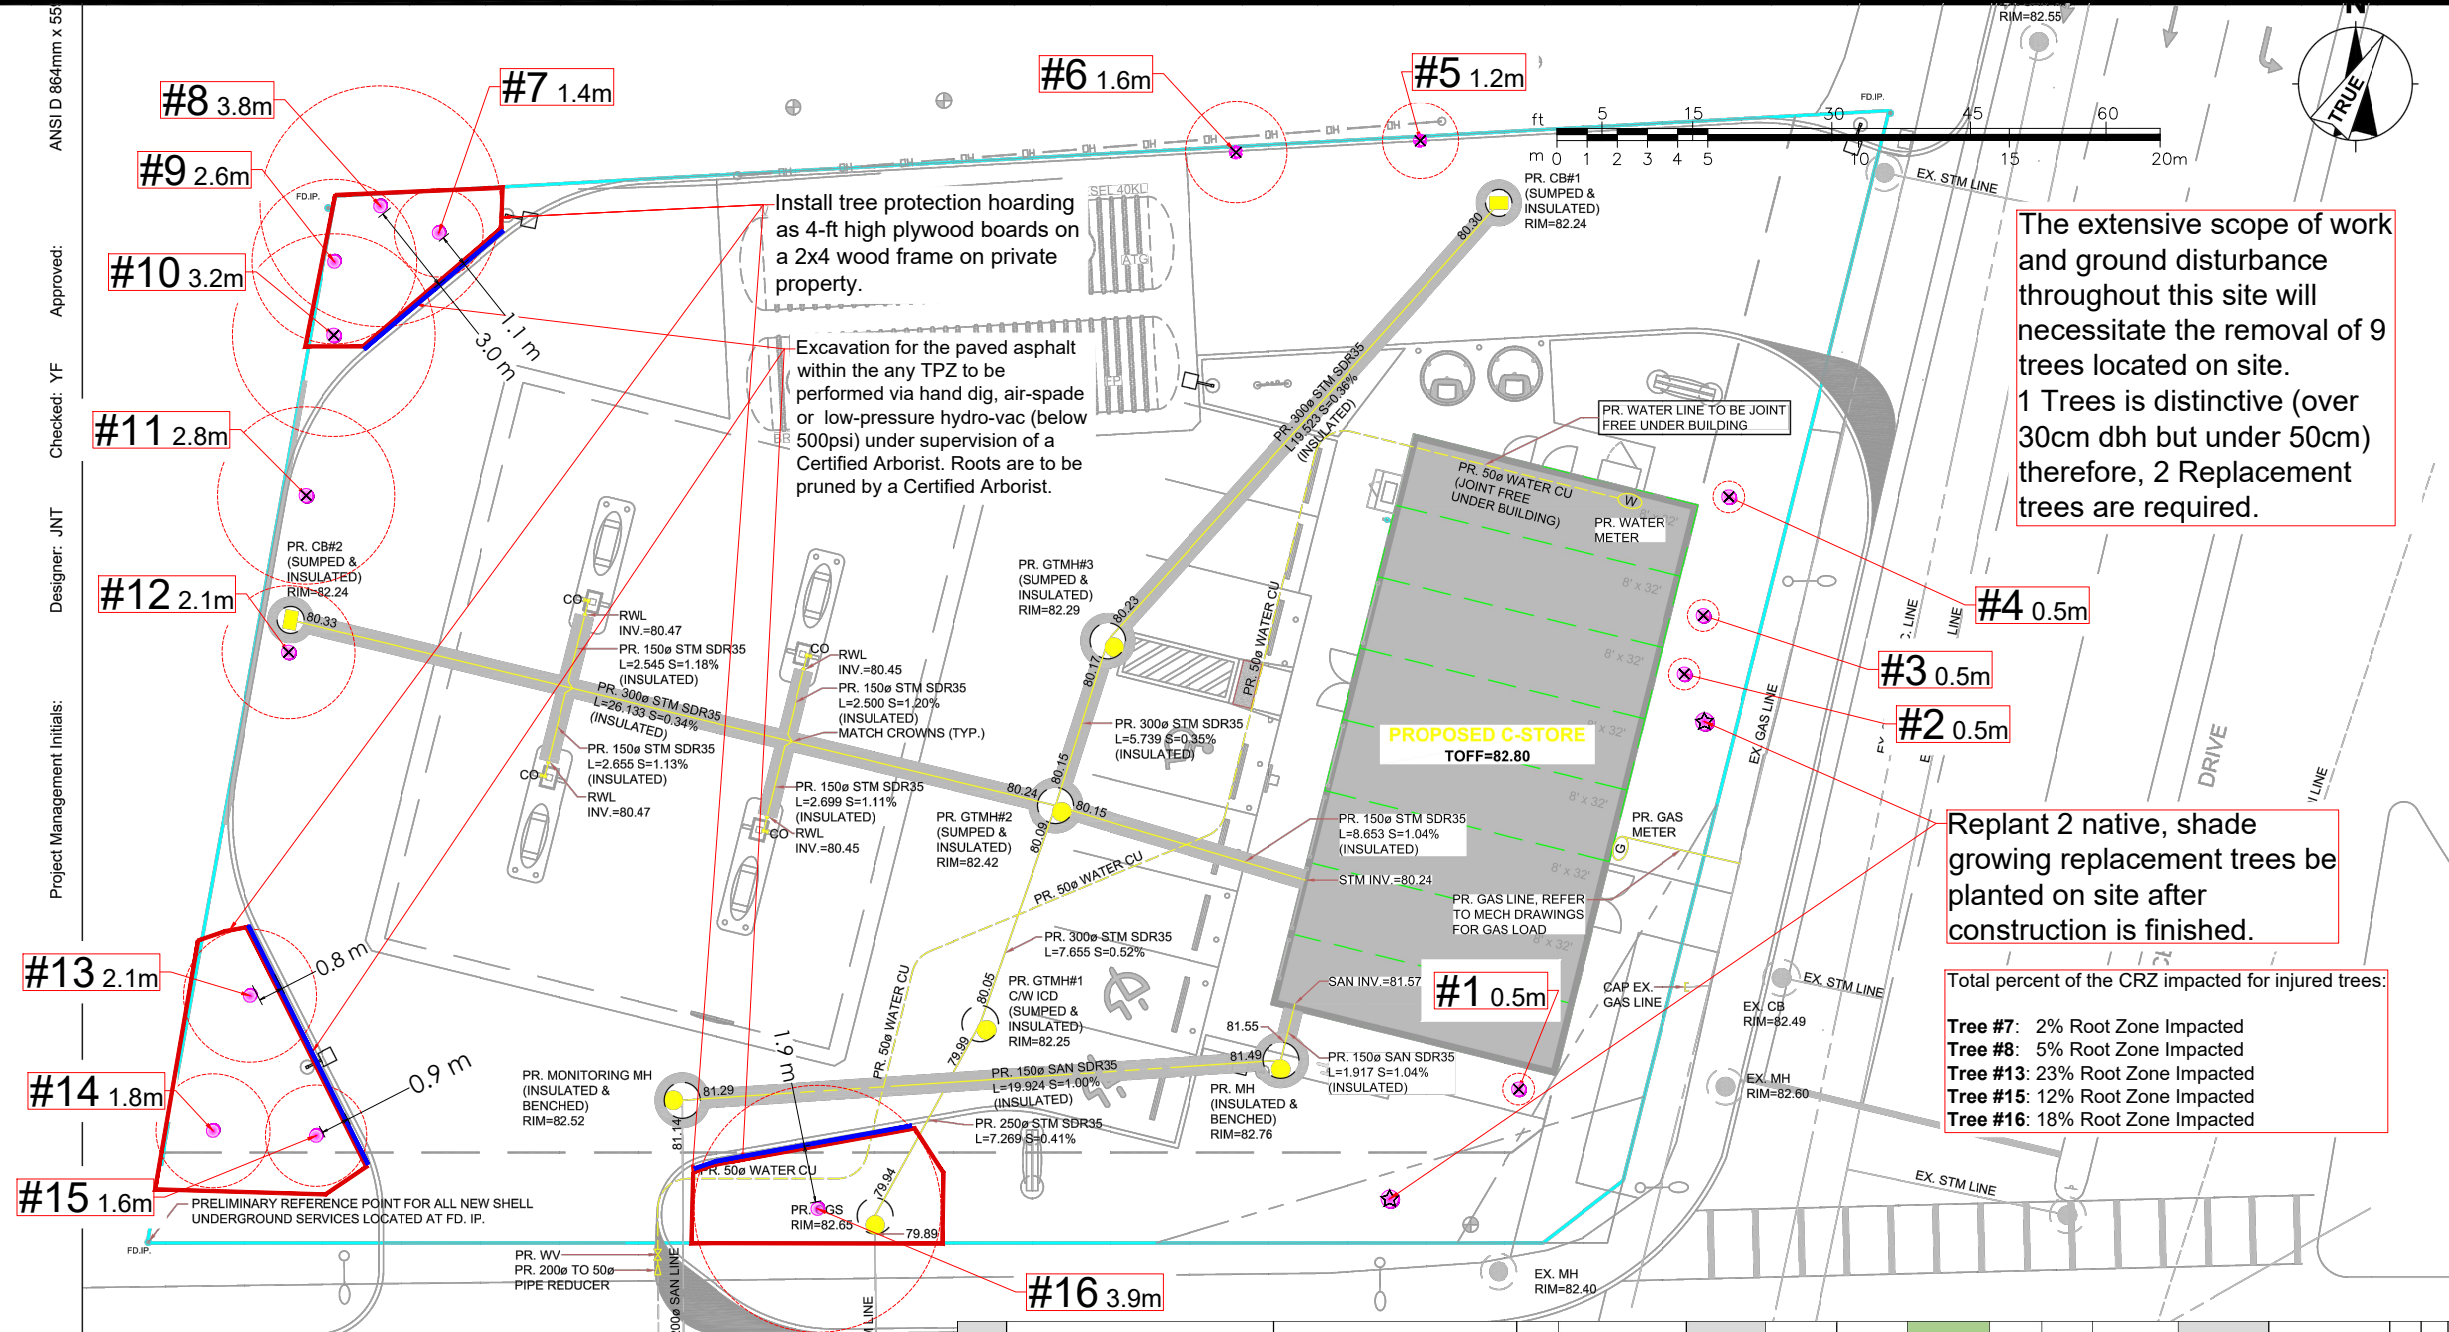

NOTES:

- All field data have been recorded by ISA Certified Arborist Matthew Tremblay (ON-2767A)
- All tree locations are based on the site plan and/or survey supplied by the client, and field observation by the arborist.
- This plan shall be used in conjunction with the Tree Protection Action Key (TPAK). Specific information regarding tree species, condition, and protection protocols are listed therein.
- Refer to the Arborist Report prepared for this project for specific instruction regarding tree protection requirements.

**PLAN KEY**

- TREE RECOMMENDED FOR REMOVAL
- RETAINED TREE
- CONIFEROUS TREE FOR REMOVAL
- RETAINED CONIFEROUS TREE
- REPLACEMENT TREE
- RETAINED HEDGEROW
- HEDGEROW FOR REMOVAL
- TREE PROTECTION FENCE
- TREE PROTECTION ZONE

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No.	DATE	BY	REVISIONS
1	07/12/24	CG	Map #1 Current Vegetation
2	10/10/24	CG	Tree Protection Plan
3	12/5/24	MT	Tree Protection Plan



TITLE:  
 Tree Conservation Report  
 1440 Prince of Wales Dr,  
 Ottawa, ON K2C 1N6


CLIENT:  
 CTM Design Services

DRAWING NO.: SCALE: 1:250

JOB NO.: SHEET: 1 of 2

Species	Botanical	DBH (cm) @ 1.4 m	Tree Ownership	Minimum Tree Protection Zone	Health	Structure	Overall Condition	Crown Width (m)	Deadwood (%)	Construction inside Min TPZ? (Y/N)	Impact: None, Low, Medium, High	Action	Permit required? (Y/N)	Distinctive Tree	Replacements Required
1 Forsythia	<i>Forsythia spp</i>	5	Private	0.5	Good	Good	Good	2	0	Y	High	Remove	N	N	
2 Forsythia	<i>Forsythia spp</i>	5	Private	0.5	Good	Good	Good	2	0	Y	High	Remove	N	N	
3 Forsythia	<i>Forsythia spp</i>	5	Private	0.5	Good	Good	Good	2	0	Y	High	Remove	N	N	
4 Forsythia	<i>Forsythia spp</i>	5	Private	0.5	Good	Good	Good	2	0	Y	High	Remove	N	N	
5 Juniper	<i>Juniperus species</i>	12	Private	1.2	Fair	Fair	Fair	4	25	Y	High	Remove	Y	N	
6 Juniper	<i>Juniperus species</i>	16	Private	1.6	Good	Good	Good	5	10	Y	High	Remove	Y	N	
7 Elm	<i>Ulmus species</i>	14	Private	1.4	Good	Fair	Fair	5	0	Y	Low	Injure	Y	N	
8 Elm	<i>Ulmus species</i>	38	Private	3.8	Good	Fair	Fair	8	15	Y	Low	Injure	Y	Y	
9 Honey Locust	<i>Gleditsia triacanthos</i>	26	Private	2.6	Fair	Fair	Fair	6	30	N	None	Preserve	N	N	
10 Honey Locust	<i>Gleditsia triacanthos</i>	32	Private	3.2	Fair	Good	Good	8	20	Y	High	Remove	Y	Y	2
11 Honey Locust	<i>Gleditsia triacanthos</i>	28	Private	2.8	Good	Good	Good	9	15	Y	High	Remove	Y	N	
12 Honey Locust	<i>Gleditsia triacanthos</i>	21	Private	2.1	Fair	Good	Good	9	20	Y	High	Remove	Y	N	
13 Honey Locust	<i>Gleditsia triacanthos</i>	21	Private	2.1	Good	Good	Good	7	10	Y	Low	Injure	Y	N	
14 Honey Locust	<i>Gleditsia triacanthos</i>	18	Private	1.8	Fair	Fair	Fair	5	45	N	None	Preserve	N	N	
15 Honey Locust	<i>Gleditsia triacanthos</i>	16	Private	1.6	Good	Fair	Good	7	15	Y	Low	Injure	Y	N	
16 Honey Locust	<i>Gleditsia triacanthos</i>	39	Private	3.9	Good	Good	Good	12	10	Y	None	Preserve	N	Y	

**1 SITE SERVICING PLAN**  
 C102.0 SCALE: 1:150



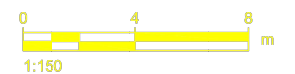


**SERVICE LOCATIONS**


INSPECTIONS BY CONSULTING ENGINEERS

- THE ENGINEER WILL INSPECT ALL UNDERGROUND MECHANICAL UTILITIES PRIOR TO COVERING.
- SPECIFIC ITEMS OF INSPECTION WILL INCLUDE THE VISUAL INSPECTION OF THE FOLLOWING ITEMS PRIOR TO AND DURING ITS INSTALLATION BY THE CONTRACTOR.

2024-12-05

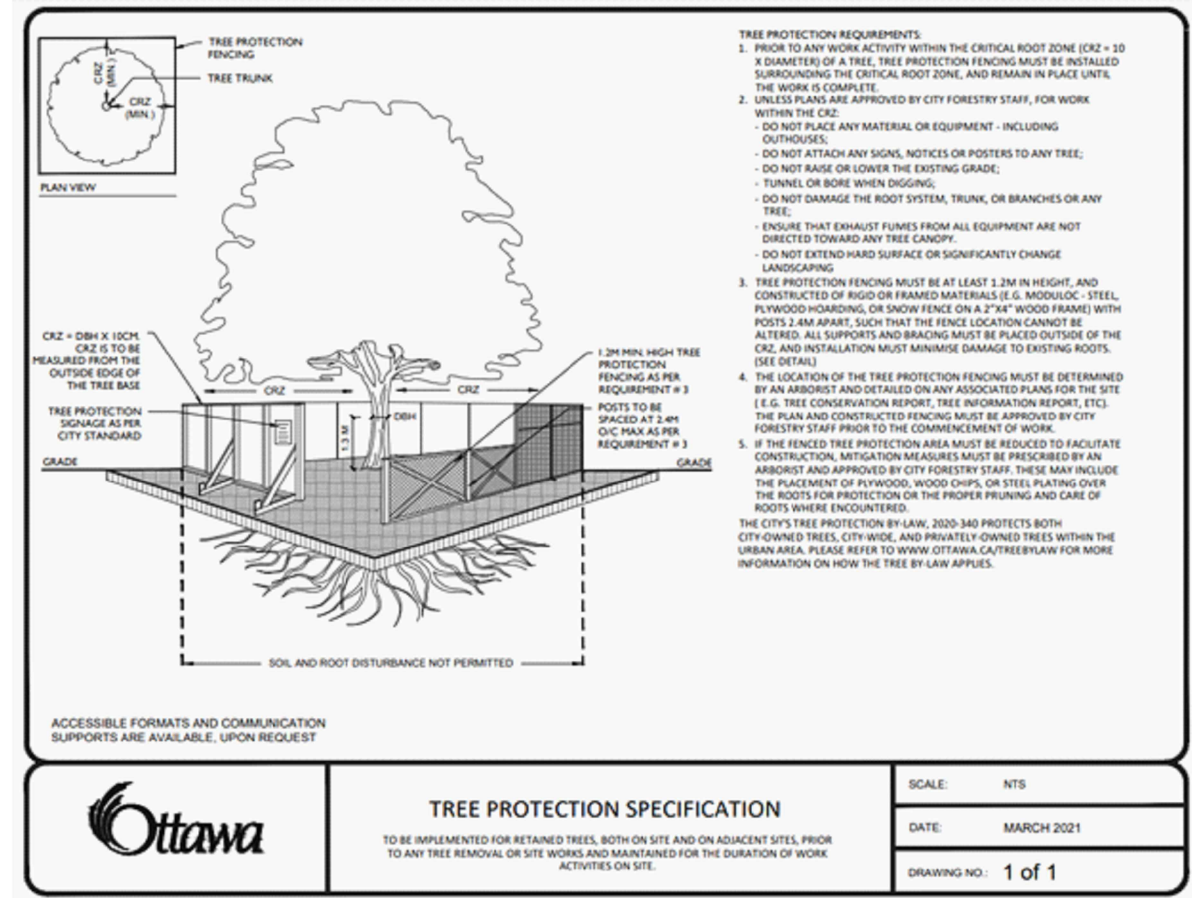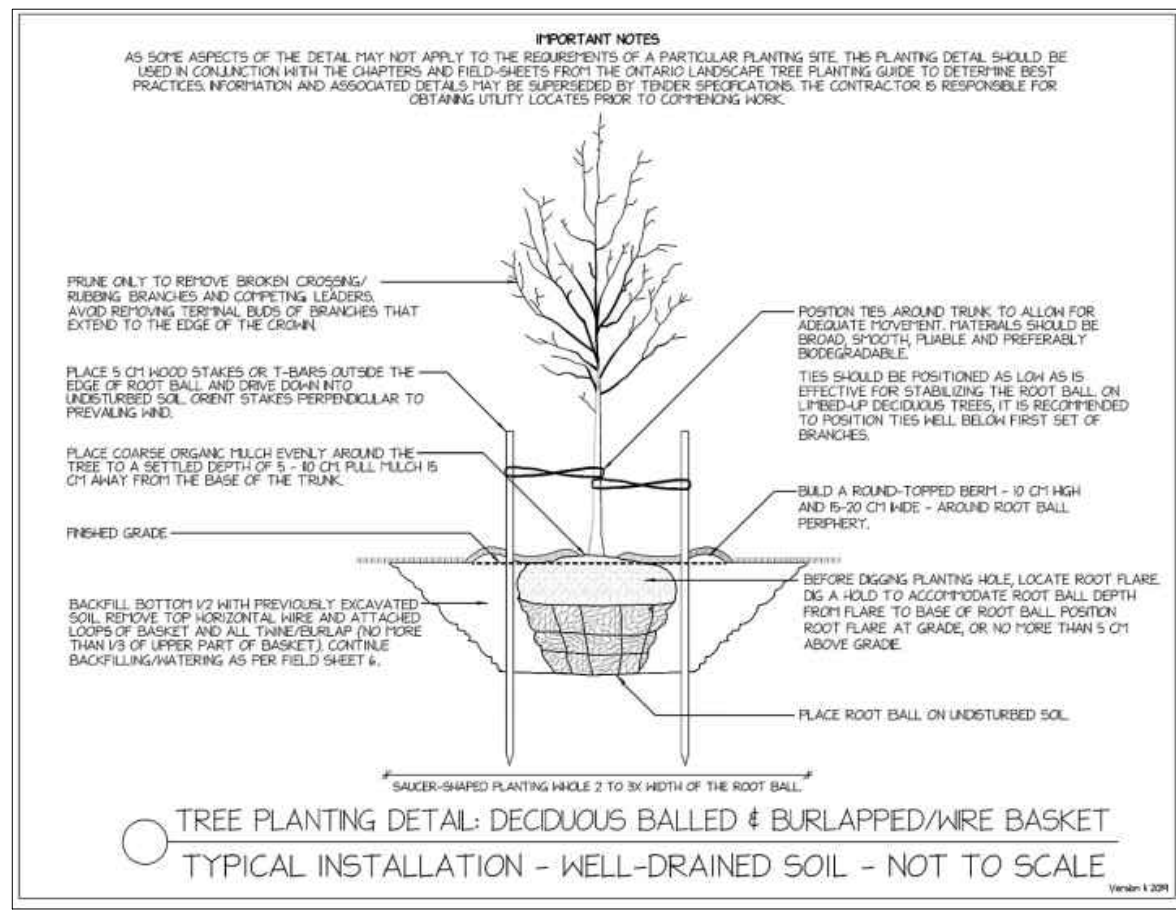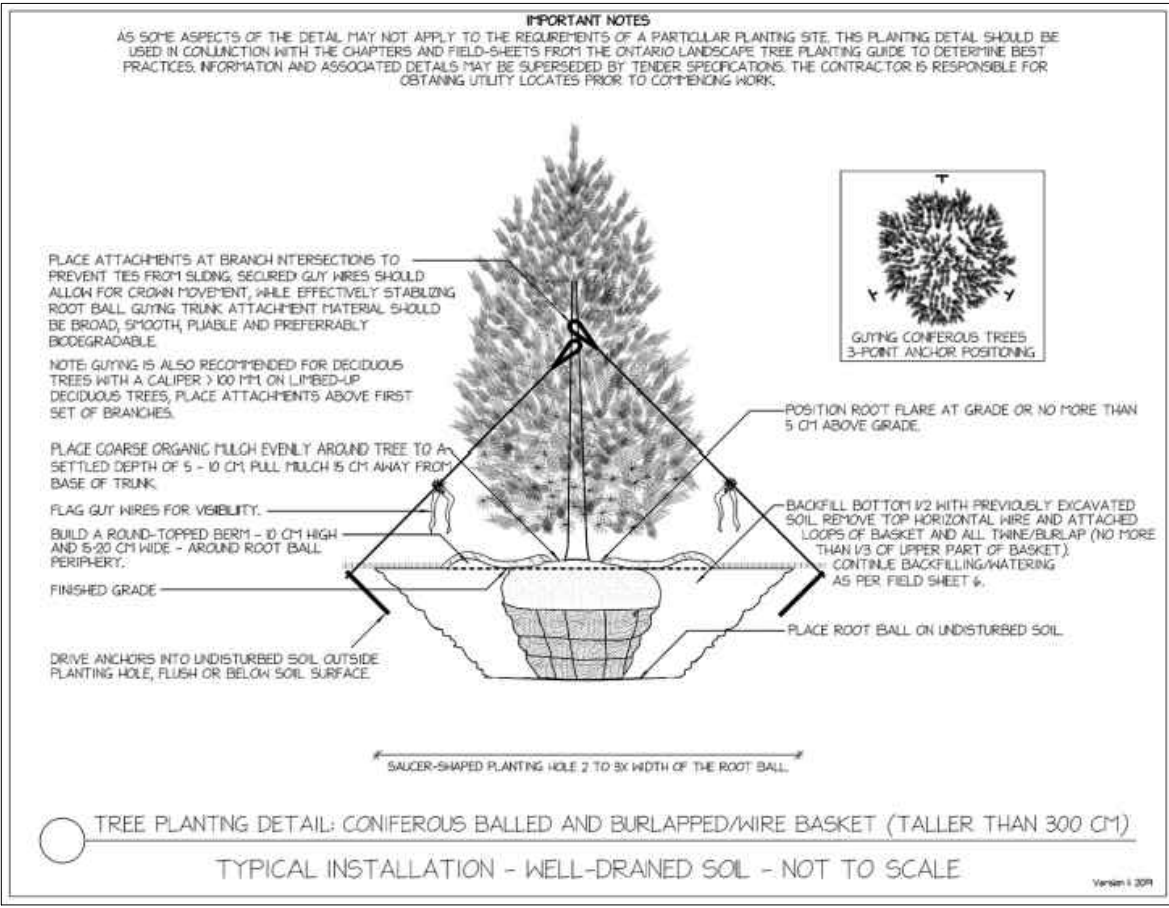

- NOTES:**
- All field data have been recorded by ISA Certified Arborist **Matthew Tremblay (ON-2767A)**
  - All tree locations are based on the site plan and/or survey supplied by the client, and field observation by the arborist.
  - This plan shall be used in conjunction with the Tree Protection Action Key (TPAK). Specific information regarding tree species, condition, and protection protocols are listed therein.
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**CLIENT:**  
CTM Design Services

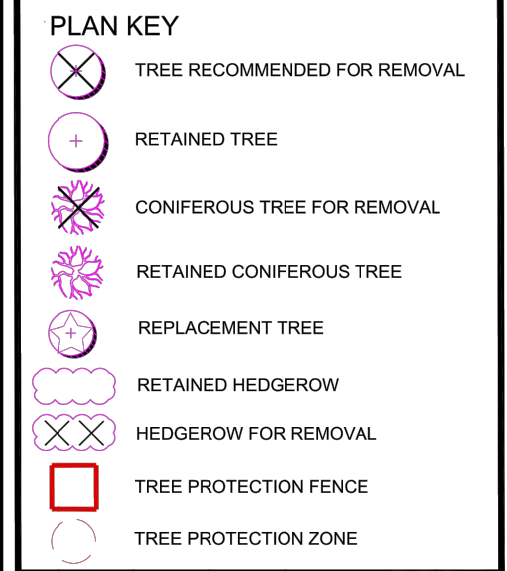**DRAWING NO.:** SCALE: 1:250

**JOB NO.:** SHEET: 2 of 2