

By Kersten Nitsche at 11:50 am, Nov 27, 2024 **KERSTEN NITSCHE, MCIP RPP** MANAGER (A), DEVELOPMENT REVIEW WEST PLANNING, DEVELOPMENT AND BUILDING SERVICES DEPARTMENT, CITY OF OTTAWA

APPROVED

(3) BOLLARDS 2000 —5 BIKE RACKS (10 PARKING SPACES) **ENLARGEMENT A** (3) BENCHES-

PROPOSED DECIDUOUS TREE

PERENNIALS

PROPOSED CONIFEROUS TREE

PROPOSED SHRUBS

EXISTING TREE TO REMAIN

BENCH

KEY ## (SEE PLANT LIST) - QUANTITY

PRODUCT INFORMATION

Install products as per manufacturer specifications. Shop drawings

EXISTING TREE TO REMOVE

PAVERS

Edge of pavers to receive edge restraint. • Industria Granitex by Techo-Bloc Size: As shown Pattern: As shown

Colour: Greyed Nickel, Onyx Black, and Shale Grey. SITE FURNITURE

Fasten all site furnishing to surface with stainless steel anti-vandal

• 2300 Series - Iconic Bench by Maglin Product Number: MBE-2300-00026 Size: 70" Length Frame colour: Gunmetal (Matte) Slats: Ipe

• 2300 Series Iconic Bike Rack by Maglin Product Number: MBR-2300-00001

Options: Backless, Armless, Skate Deterrent 1-Side

• Bollard TBD.

• Commercial Wood Planter by DeepStream Designs 72" x 24" x 21.5": Product Number: MAR-722421

> Finish: Driftwood Gray (RPL) 60" x 24" x 21.5": Product Number: MAR-602421 Finish: Driftwood Gray (RPL)

Finish: Gunmetal (Matte)

stockpile areas, etc. to the satisfaction of the Consultant. Unless otherwise noted, Contractor is to reinstate all areas to pre-construction condition or better to the satisfaction of the Contract Administrator.

PLANTING

- 1. Plant material to be No. 1 Grade and is to comply with Canadian Standards for Nursery Stock (latest edition) published by the Canadian Nursery Landscape Association.
- 2. Use structurally sound plant material with strong fibrous root system free of disease, defects, and injuries. Use trees with straight trunks, well and characteristically branched for species. Obtain approval from consultant of plant material at source prior to digging. All trees and shrubs to be container grown, potted, W/B or B/B, as indicated on Plant List. Bare root plants are only acceptable for certain species and as approved by the Landscape Architect.
- 3. Plant material substitutions are not be permitted without the written approval from the Consultant, with 48 hours notice, prior to shipping plant material. 4. Plant locations are schematic / approximate only. **Contractor**
- is to stake out locations on site for approval by the Landscape Architect prior to installation.
- 5. The illustrated number of plants shown in the Planting Plan supersedes the estimated number in the Plant List. Contractor to report any discrepancies to the Landscape Architect prior to installation. Contractor will assume full
- responsibility if the Landscape Architect is not notified. 6. Ensure trees are thoroughly watered following planting. Monitor material and ensure adequate moisture until
- 7. In heavy clay or poorly drained soils, set root ball with root collar 75-100mm higher than finished grade. 8. Approved topsoil depths are as follows:
- a. Plant Beds **450mm** continuous depth. Applies to shrubs, perennials, vines, and groundcovers. b. Sod/ Seed Areas - 100mm depth.
- 9. Sod to be No. 1 Kentucky Bluegrass Sod grown from minimum mixture of 3 Kentucky Bluegrass cultivars. Quality and source are to comply with Canadian Standards for Nursery Stock, Section 17, (latest edition) published by the Canadian Nursery Landscape Nursery Landscape Association.
- 10. Apply the following mineral fertilizer unless soil tests show other requirements:
- a. Plant Beds (8-32-16), i.e. 8% Nitrogen, 32% Phosphorus, 16% Potash per manufacturer specifications. b. Sod Areas - (8-32-16), i.e. 8% Nitrogen, 32%
- Phosphorus, 16% Potash at a rate of 350kg/ha. 12. Where applicable, for any plant areas with a mix of species/ cultivars notes, Contractor is to cluster like plants in groups of 3-5 and evenly distribute these in the noted area.

TREE PLANTING IN SENSITIVE CLAY

- 1. The landscape plans have been developed in accordance with the Geotechnical Report: Preliminary Geotechnical Investigation, Englobe, 05/10/2023, which includes figures and data sheets which confirm the categories and locations of clay soils.
- 2. The following City of Ottawa clay soils guideline applies: Guidelines for Tree Planting in Sensitive Marine Clay Soils
- 3. The soil volumes provided are sufficient for a reasonable chance of tree survival. Unless otherwise noted, all new trees on City property meet the minimum soil volume requirements of the following, based on a depth of 1.5m below finished grade, and subtracting the volume of utility
- a. Small tree (mature height up to 7.5m) 25m3/ minimum
- soil volume provided. b. Medium tree (mature height 7.5-14m) - 30m3/ minimum soil volume provided.

Where trees share a continuous greenspace:

- c. Two (2) small trees 15m3/ minimum soil volume provided
- d. Two (2) medium trees 18m3/ minimum soil volume provided per tree. PT As Shown

1g PT 30cm O.C. 1g | PT | 40cm O.C

 1g
 PT
 As Shown

 1g
 PT
 As Shown
 LOCATION CITY of OTTAWA

40 FRANK NIGHBOR PLACE DRAWING NAME LANDSCAPE PLAN

ENLARGEMENT

SIZE COND SPACING

50cm Spr PT As Shown

40cm Ht PT As Shown

50cm Ht PT As Shown

60cm Ht PT As Shown

123002-00 REV # 5

THE POSITION OF ALL POLE LINES, CONDUITS, WATERMAINS, SEWERS AND OTHER UNDERGROUND AND OVERGROUND UTILITIES AND STRUCTURES IS NOT NECESSARILY SHOWN ON THE CONTRACT DRAWINGS, AND WHERE SHOWN, THE ACCURACY OF THE POSITION OF SUCH UTILITIES AND STRUCTURES IS NOT GUARANTEED. BEFORE STARTING WORK, DETERMINE THE EXACT LOCATION OF ALL SUCH UTILITIES AND STRUCTURES AND ASSUME ALL LIABILITY FOR DAMAGE TO THEM.

NOT FOR CONSTRUCTION

SCALE 1:100 RG REVISED PER CITY COMMENTS MAR 26/24 REVISED PER CITY COMMENTS FEB 12/24 MJT REVISED PER CITY COMMENTS OCT 3/23 1:100 ISSUED FOR SITE PLAN APPLICATION MAY 12/23 ISSUED FOR COORDINATION APR 25/23 REVISION DATE

ENLARGEMENT B

Axl 11 Aronia x Low Scape Mound (UCONNAM165) Low Scape Mound Chokeberry

PLANT LIST

Coniferous Shrubs

Deciduous Shrubs

Ornamental Grasses

Groundcovers

KEY QTY BOTANICAL NAME

go | 69 | Galium odoratum

Mic 9 Microbiota decussata 'Prides

Cah 12 Clethra alnifolia 'Hummingbird'

Hyq 5 Hydrangea paniculata 'SMHPLQF'

gms 60 Geranium macrorrhizum 'Spessart'

pvn 5 Panicum virgatum 'Northwind' sht 28 Sporobolus heterolepsis 'Tara'

ckf 54 Calamagrostis acutiflora 'Karl Foerster'



COMMON NAME

Sweet Woodruff

Spessart Cranesbill

Celtic Pride Siberian Cypress

Hummingbird Summersweet


Karl Foerster Feather Reed Grass


Little Quick Fire Hydrangea


Northwind Switch Grass Tara Prairie Dropseed

> Suite 200, 240 Michael Cowpland Drive Ottawa, Ontario, Canada K2M 1P6 (613) 254-9643

> > (613) 254-5867

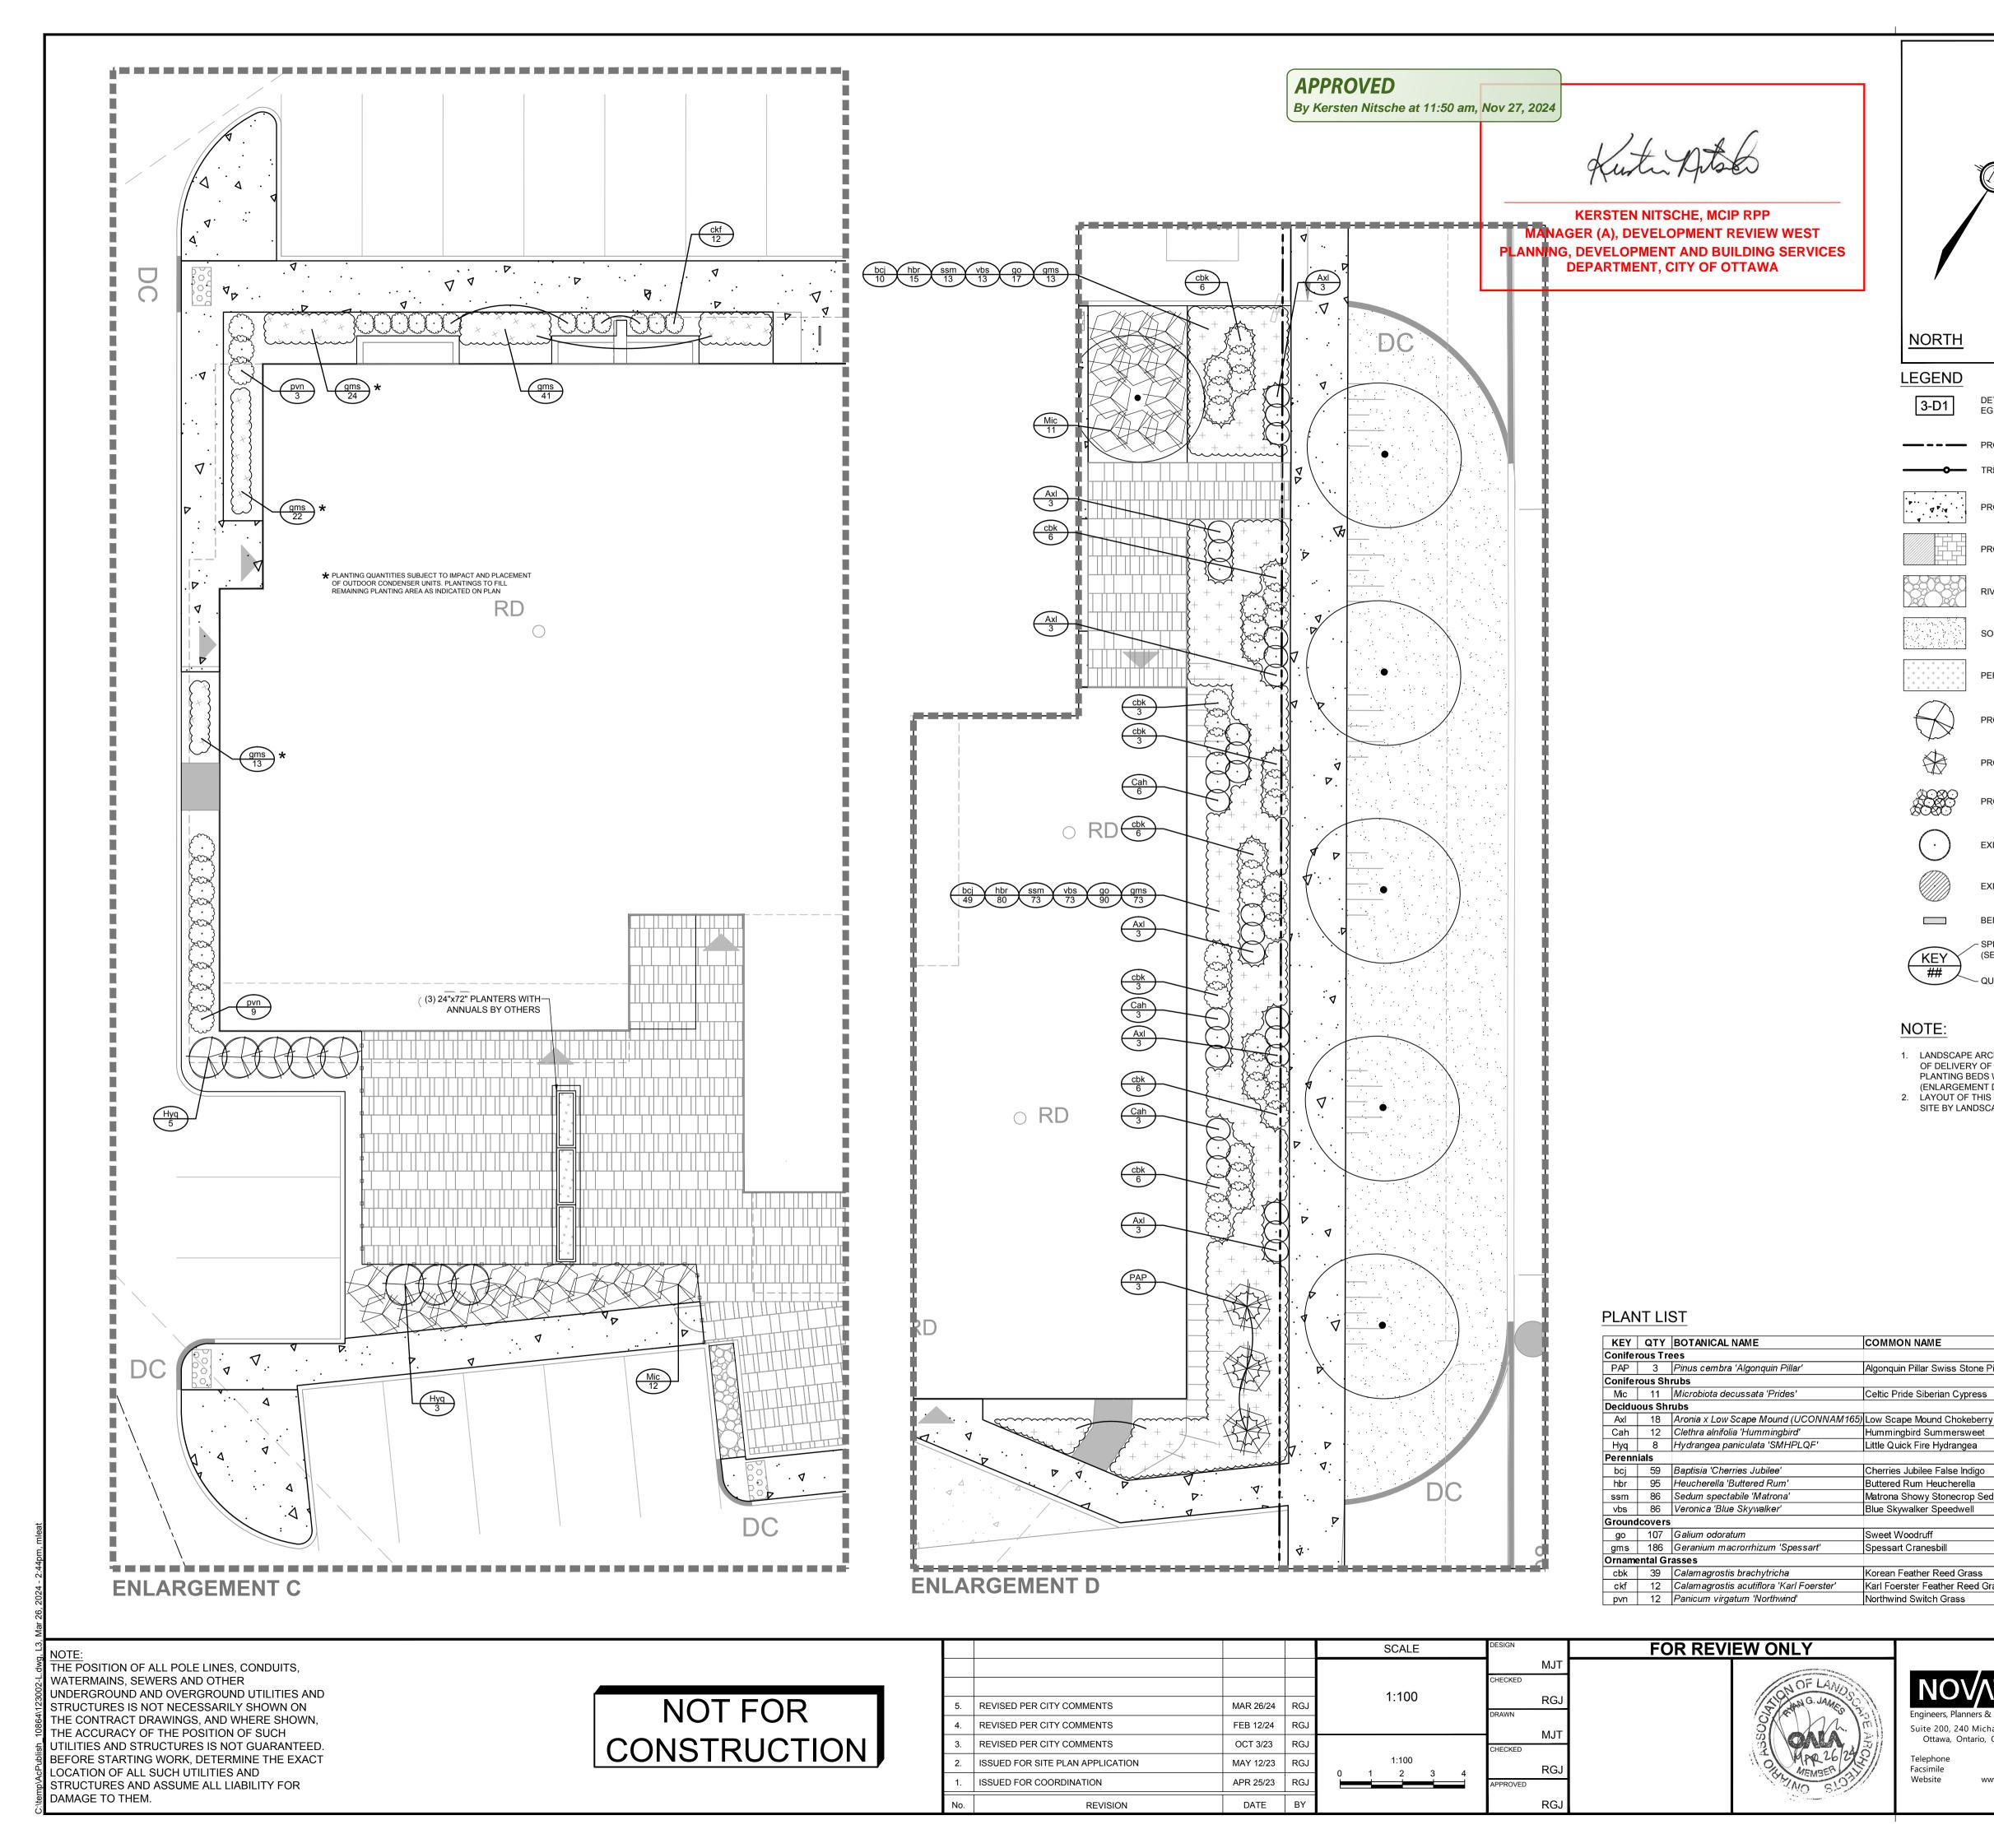

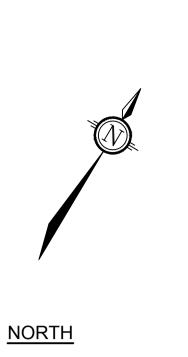

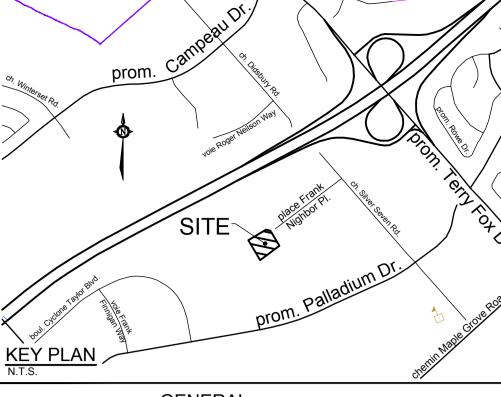

LEGEND

DETAIL SHEET #_ NOVATECH OR CITY
EG. L1, L2, ETC. DETAIL NUMBER SEE LIST
FOR CODE

PROPERTY LIMIT

PROPOSED CONCRETE

TREE PROTECTION FENCE

PROPOSED PAVERS

RIVER STONE

PERENNIALS




PROPOSED DECIDUOUS TREE

PROPOSED CONIFEROUS TREE




PROPOSED SHRUBS

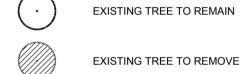

EXISTING TREE TO REMAIN



BENCH

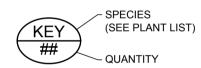

NOTE:

COMMON NAME

Algonquin Pillar Swiss Stone Pine

Celtic Pride Siberian Cypress

Hummingbird Summersweet

Little Quick Fire Hydrangea

Cherries Jubilee False Indigo

Buttered Rum Heucherella

Blue Skywalker Speedwell

Korean Feather Reed Grass

Northwind Switch Grass

Karl Foerster Feather Reed Grass

Telephone

Facsimile

Website

Suite 200, 240 Michael Cowpland Drive

Ottawa, Ontario, Canada K2M 1P6

(613) 254-9643

(613) 254-5867

www.novatech-eng.com

Sweet Woodruff

Spessart Cranesbill

Matrona Showy Stonecrop Sedum

- 1. LANDSCAPE ARCHITECT TO BE GIVEN ADVANCE NOTICE OF DELIVERY OF PLANT MATERIAL FOR PERENNIAL PLANTING BEDS WHICH INCLUDE MULTIPLE SPECIES
- (ENLARGEMENT D PERENNIALS ONLY). 2. LAYOUT OF THIS PLANT MATERIAL TO BE DIRECTED ON SITE BY LANDSCAPE ARCHITECT.

GENERAL

information.

- Read and interpret this drawing/ drawing set in conjunction with all the contract details and specifications, including related civil, utility, structural, architectural, mechanical, electrical, environmental, geotechnical, and survey
- 2. The Contractor is to determine the exact location, size, material, and elevation of all existing utilities prior to commencing construction. Protect and assume responsibility for all existing utilities regardless of being shown on the
- drawings. 3. It is essential to use the plans and details in conjunction with the specifications and notes
- 4. Do not scale drawings. Work to dimensions only. 5. Protect all existing and retained vegetation for the duration of construction according to the contract details and specifications.
- 6. Reinstate all areas and items damaged or disturbed, beyond the Limit of Work, because of construction activities, including but not limited to construction staging areas, haul roads, stockpile areas, etc. to the satisfaction of the Consultant. Unless otherwise noted, Contractor is to reinstate all areas to pre-construction condition or better to the satisfaction of the Contract Administrator.

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provided per tree.

CITY of OTTAWA 40 FRANK NIGHBOR PLACE **DRAWING NAME**

SIZE | COND | SPACING

200cm Ht | WB | As Shown |

50cm Spr PT As Shown

40cm Ht PT As Shown

50cm Ht PT As Shown

60cm Ht PT As Shown

1g PT 60cm O.C.

1g PT 40cm O.C

1g | PT | 40cm O.C.

1g PT 40cm O.C

1g PT 30cm O.0

1g PT 40cm O.0

1g PT As Shown


1g PT As Shown


1g PT As Shown


LANDSCAPE PLAN **ENLARGEMENT**


123002-00 REV # 5 123002-L3

Plan #19002

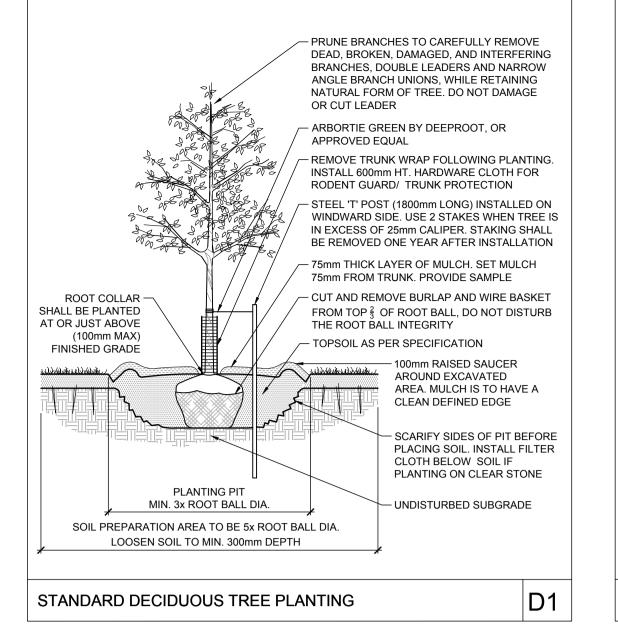

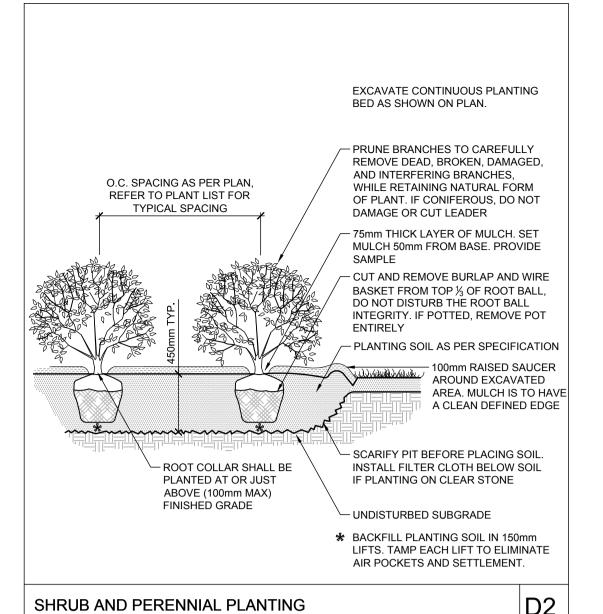

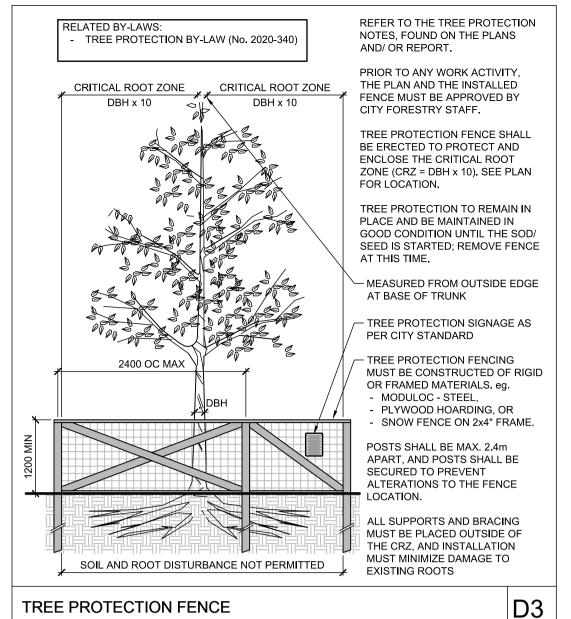


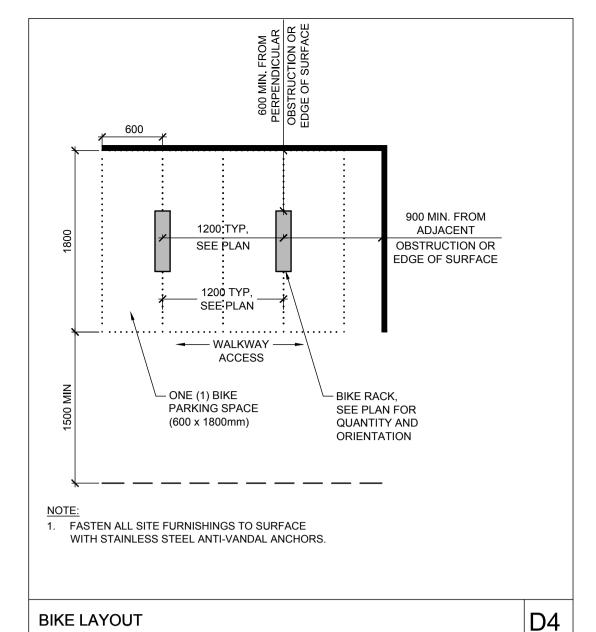


APPROVED

By Kersten Nitsche at 11:49 am, Nov 27, 2024

KERSTEN NITSCHE, MCIP RPP
MANAGER (A), DEVELOPMENT REVIEW WEST
PLANNING, DEVELOPMENT AND BUILDING SERVICES
DEPARTMENT, CITY OF OTTAWA

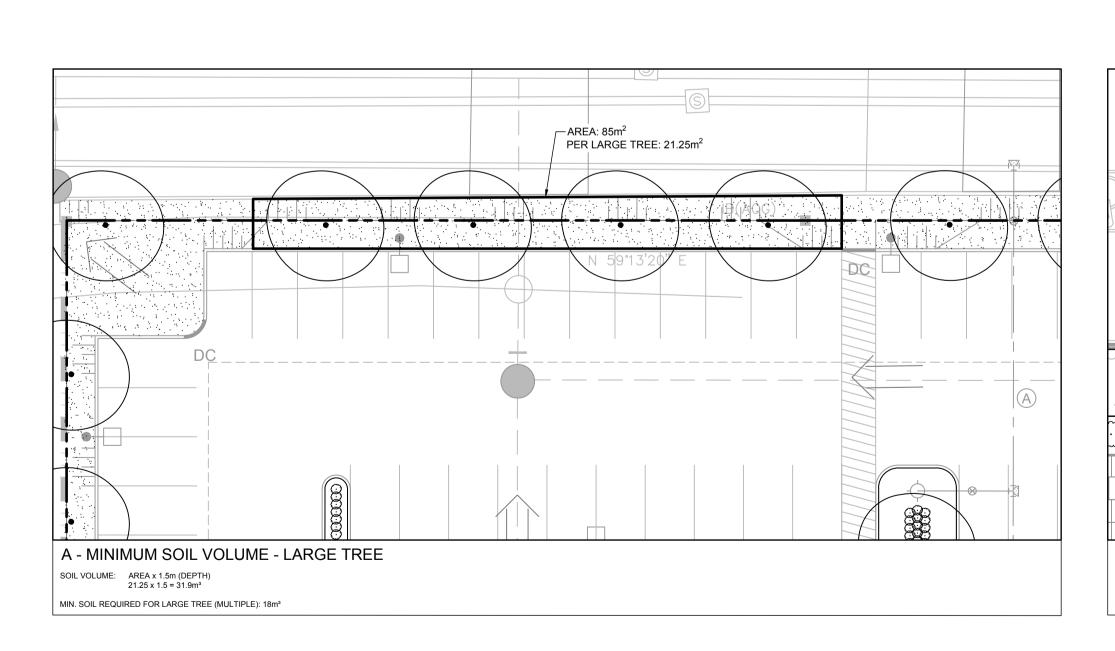

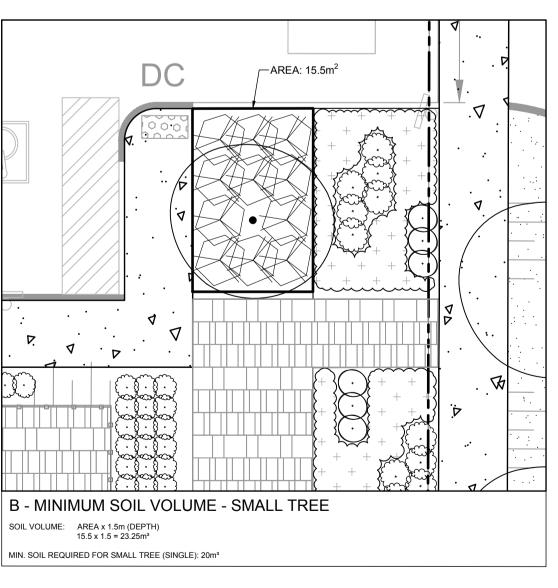


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NOT FOR CONSTRUCTION

				SCALE	DESIGN	
					Mc	JT
					CHECKED	
5	REVISED PER CITY COMMENTS	MAR 26/24	RGJ		RO DRAWN	J J
4.	REVISED PER CITY COMMENTS	FEB 12/24	RGJ		M	
3.	REVISED PER CITY COMMENTS	OCT 3/23	RGJ		CHECKED	~
2.	ISSUED FOR SITE PLAN APPLICATION	MAY 12/23	RGJ		RO	3.J
1.	ISSUED FOR COORDINATION	APR 25/23	RGJ		APPROVED	=
No.	REVISION	DATE	BY		RO	ЭJ



Engineers, Planners & Landscape Architects
Suite 200, 240 Michael Cowpland Drive
Ottawa, Ontario, Canada K2M 1P6
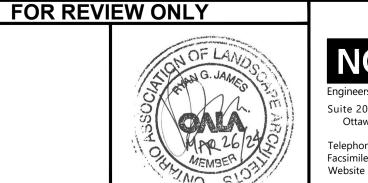
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Facsimile (613) 254-5867

www.novatech-eng.com

LOCATION
CITY of OTTAWA
40 FRANK NIGHBOR PLACE

DRAWING NAME

LANDSCAPE - DETAILS

PROJECT No.

123002-00

REV

REV # 5

DRAWING No.

123002-L4

PLANA 1. DWG - 841mmx594mm Plan #19002

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