



REFER TO NOTES & DETAILS
ON DRAWINGS C-2 & C-4

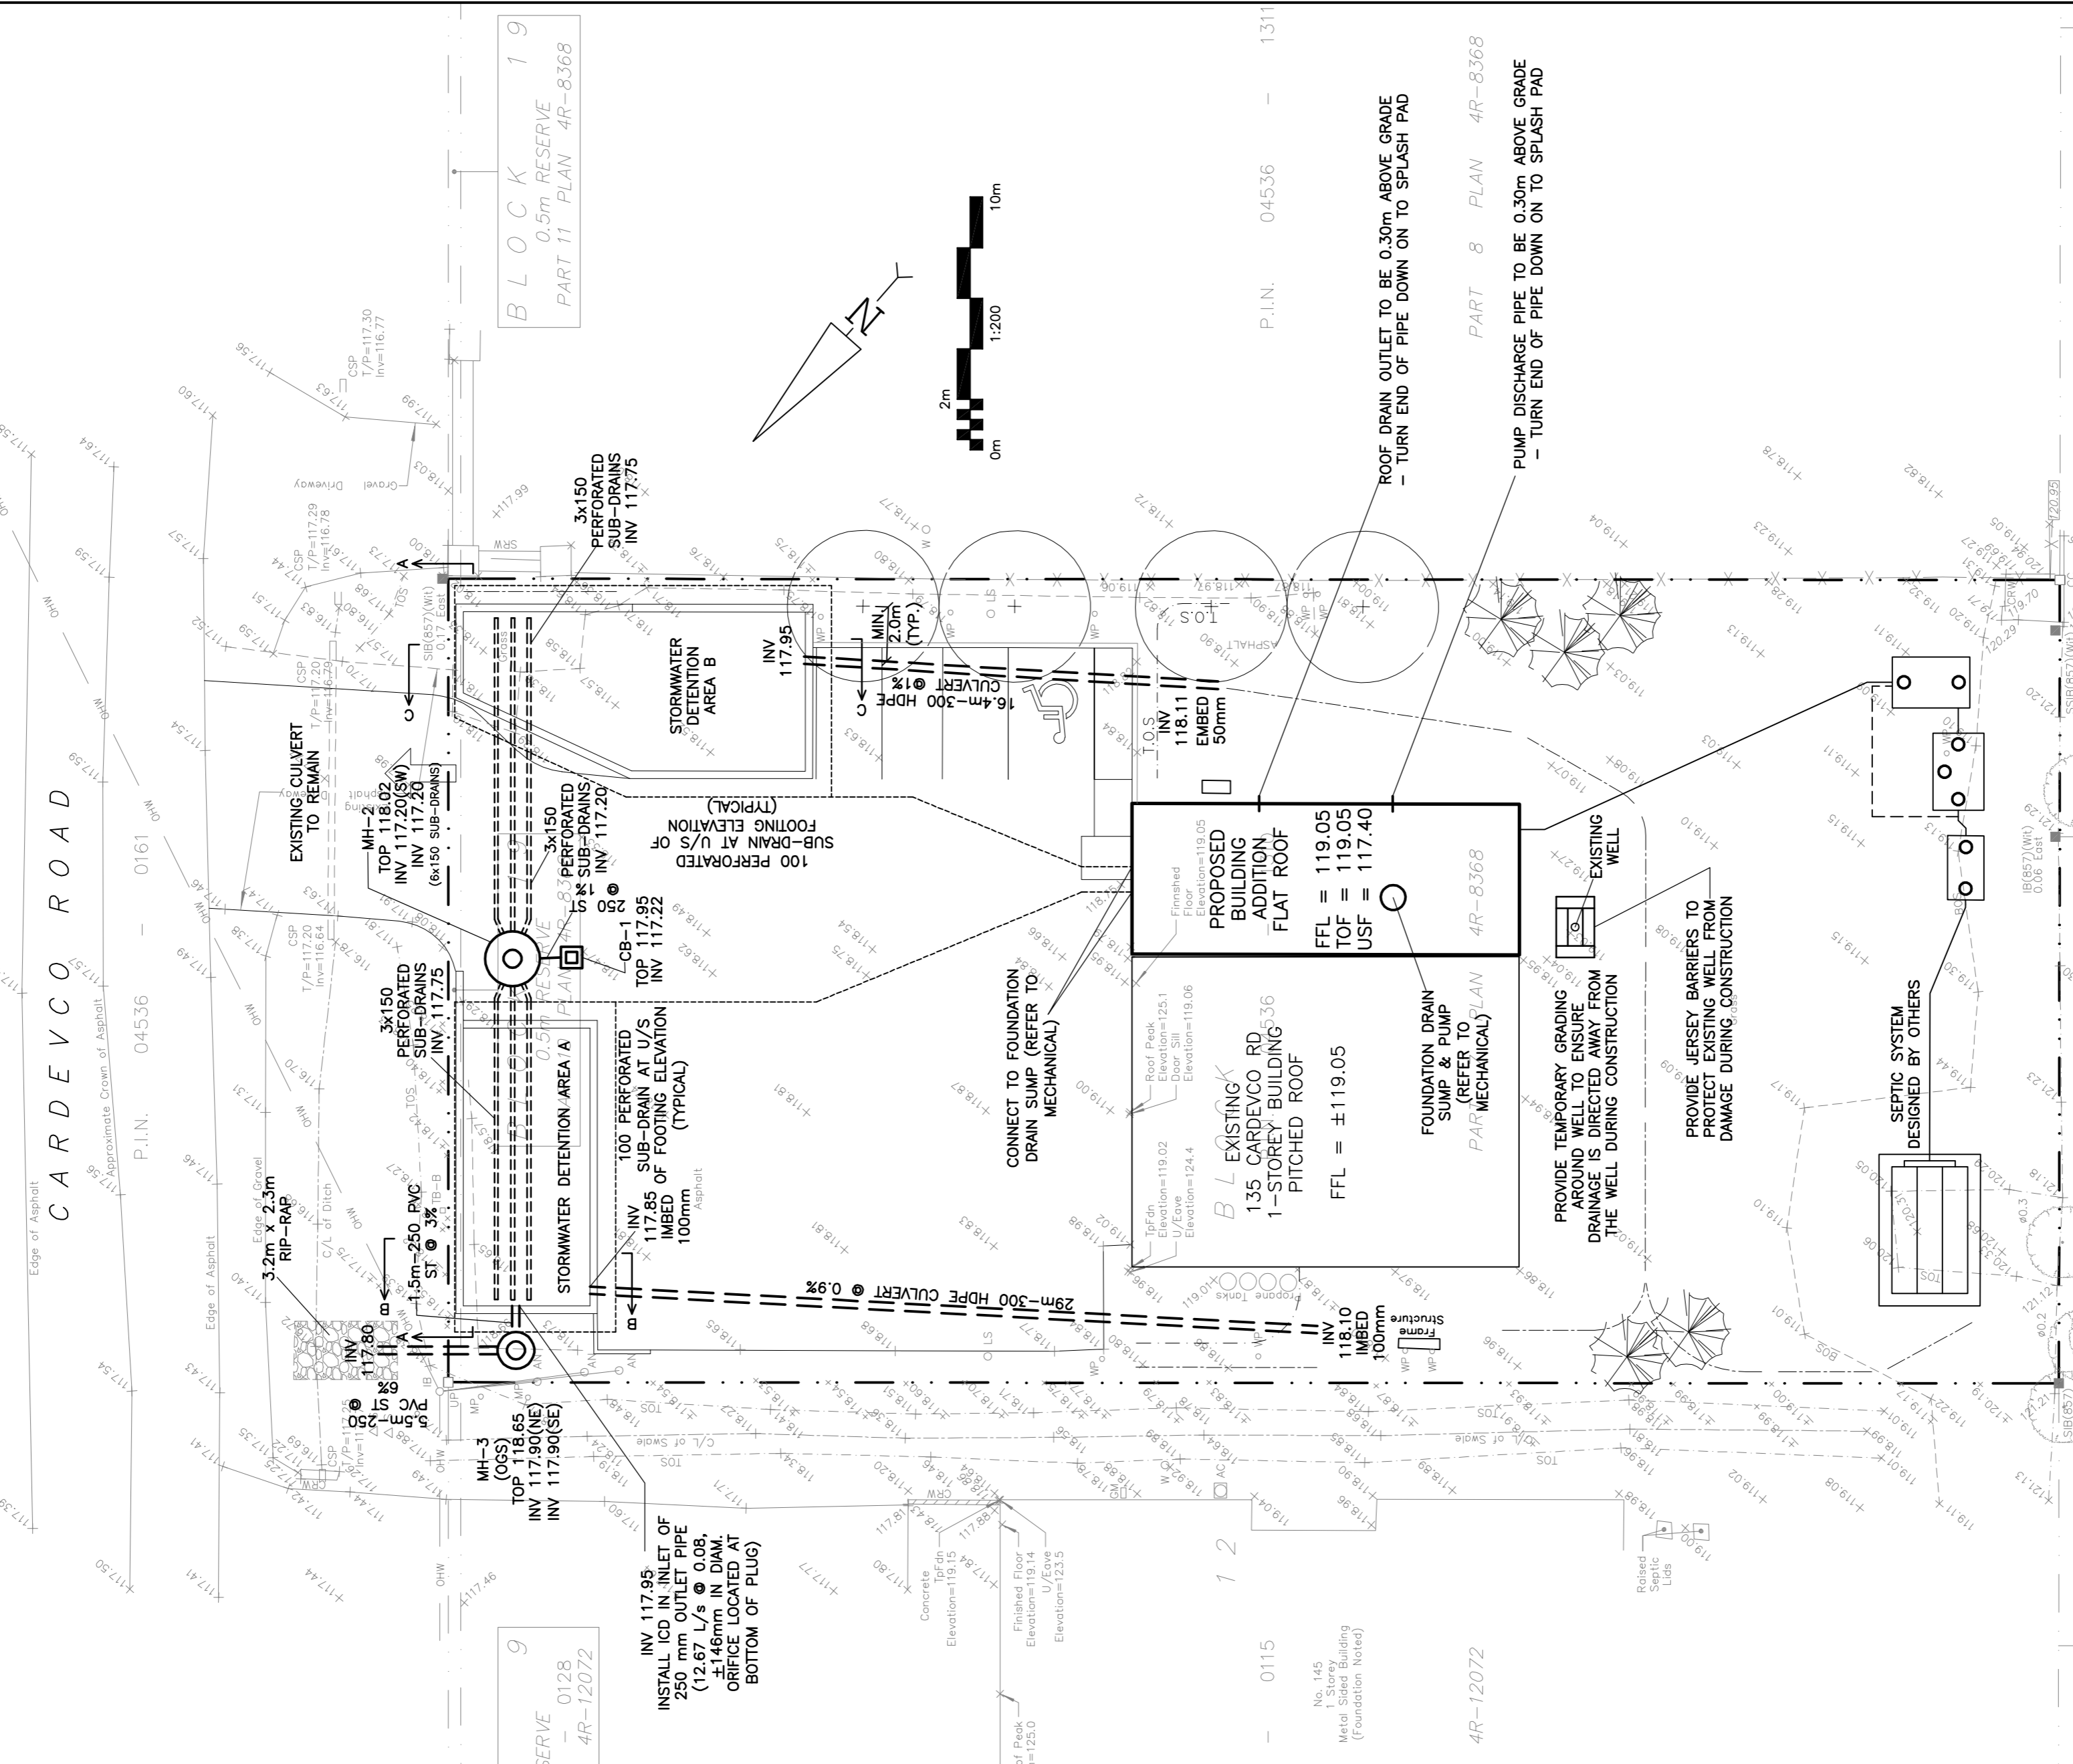

RETAINING WALL SCHEDULE

REF	TOP OF WALL	BOTTOM OF WALL	HEIGHT	NOTES
①	118.85 TO 118.68	117.95	0.90m TO 0.73m	TOP OF WALL TO BE 0.15m ABOVE PROPOSED GRADE DESIGNED BY STRUCTURAL
②	118.68 TO 118.40	117.95	0.73m TO 0.45m	TOP OF WALL TO BE 0.15m ABOVE PROPOSED GRADE DESIGNED BY STRUCTURAL
③	118.40 TO 118.25	118.10	0.30m TO 0.15m	ABOVE PROPOSED GRADE DESIGNED BY STRUCTURAL
④	118.25 TO 118.19	117.95	0.30m TO 0.24m	ABOVE PROPOSED GRADE DESIGNED BY STRUCTURAL
⑤	118.19 TO 118.85	117.95	0.24m TO 0.90m	TOP OF WALL TO BE 0.15m ABOVE PROPOSED GRADE DESIGNED BY STRUCTURAL

REFER TO NOTES & DETAILS
ON DRAWINGS C-2 & C-4

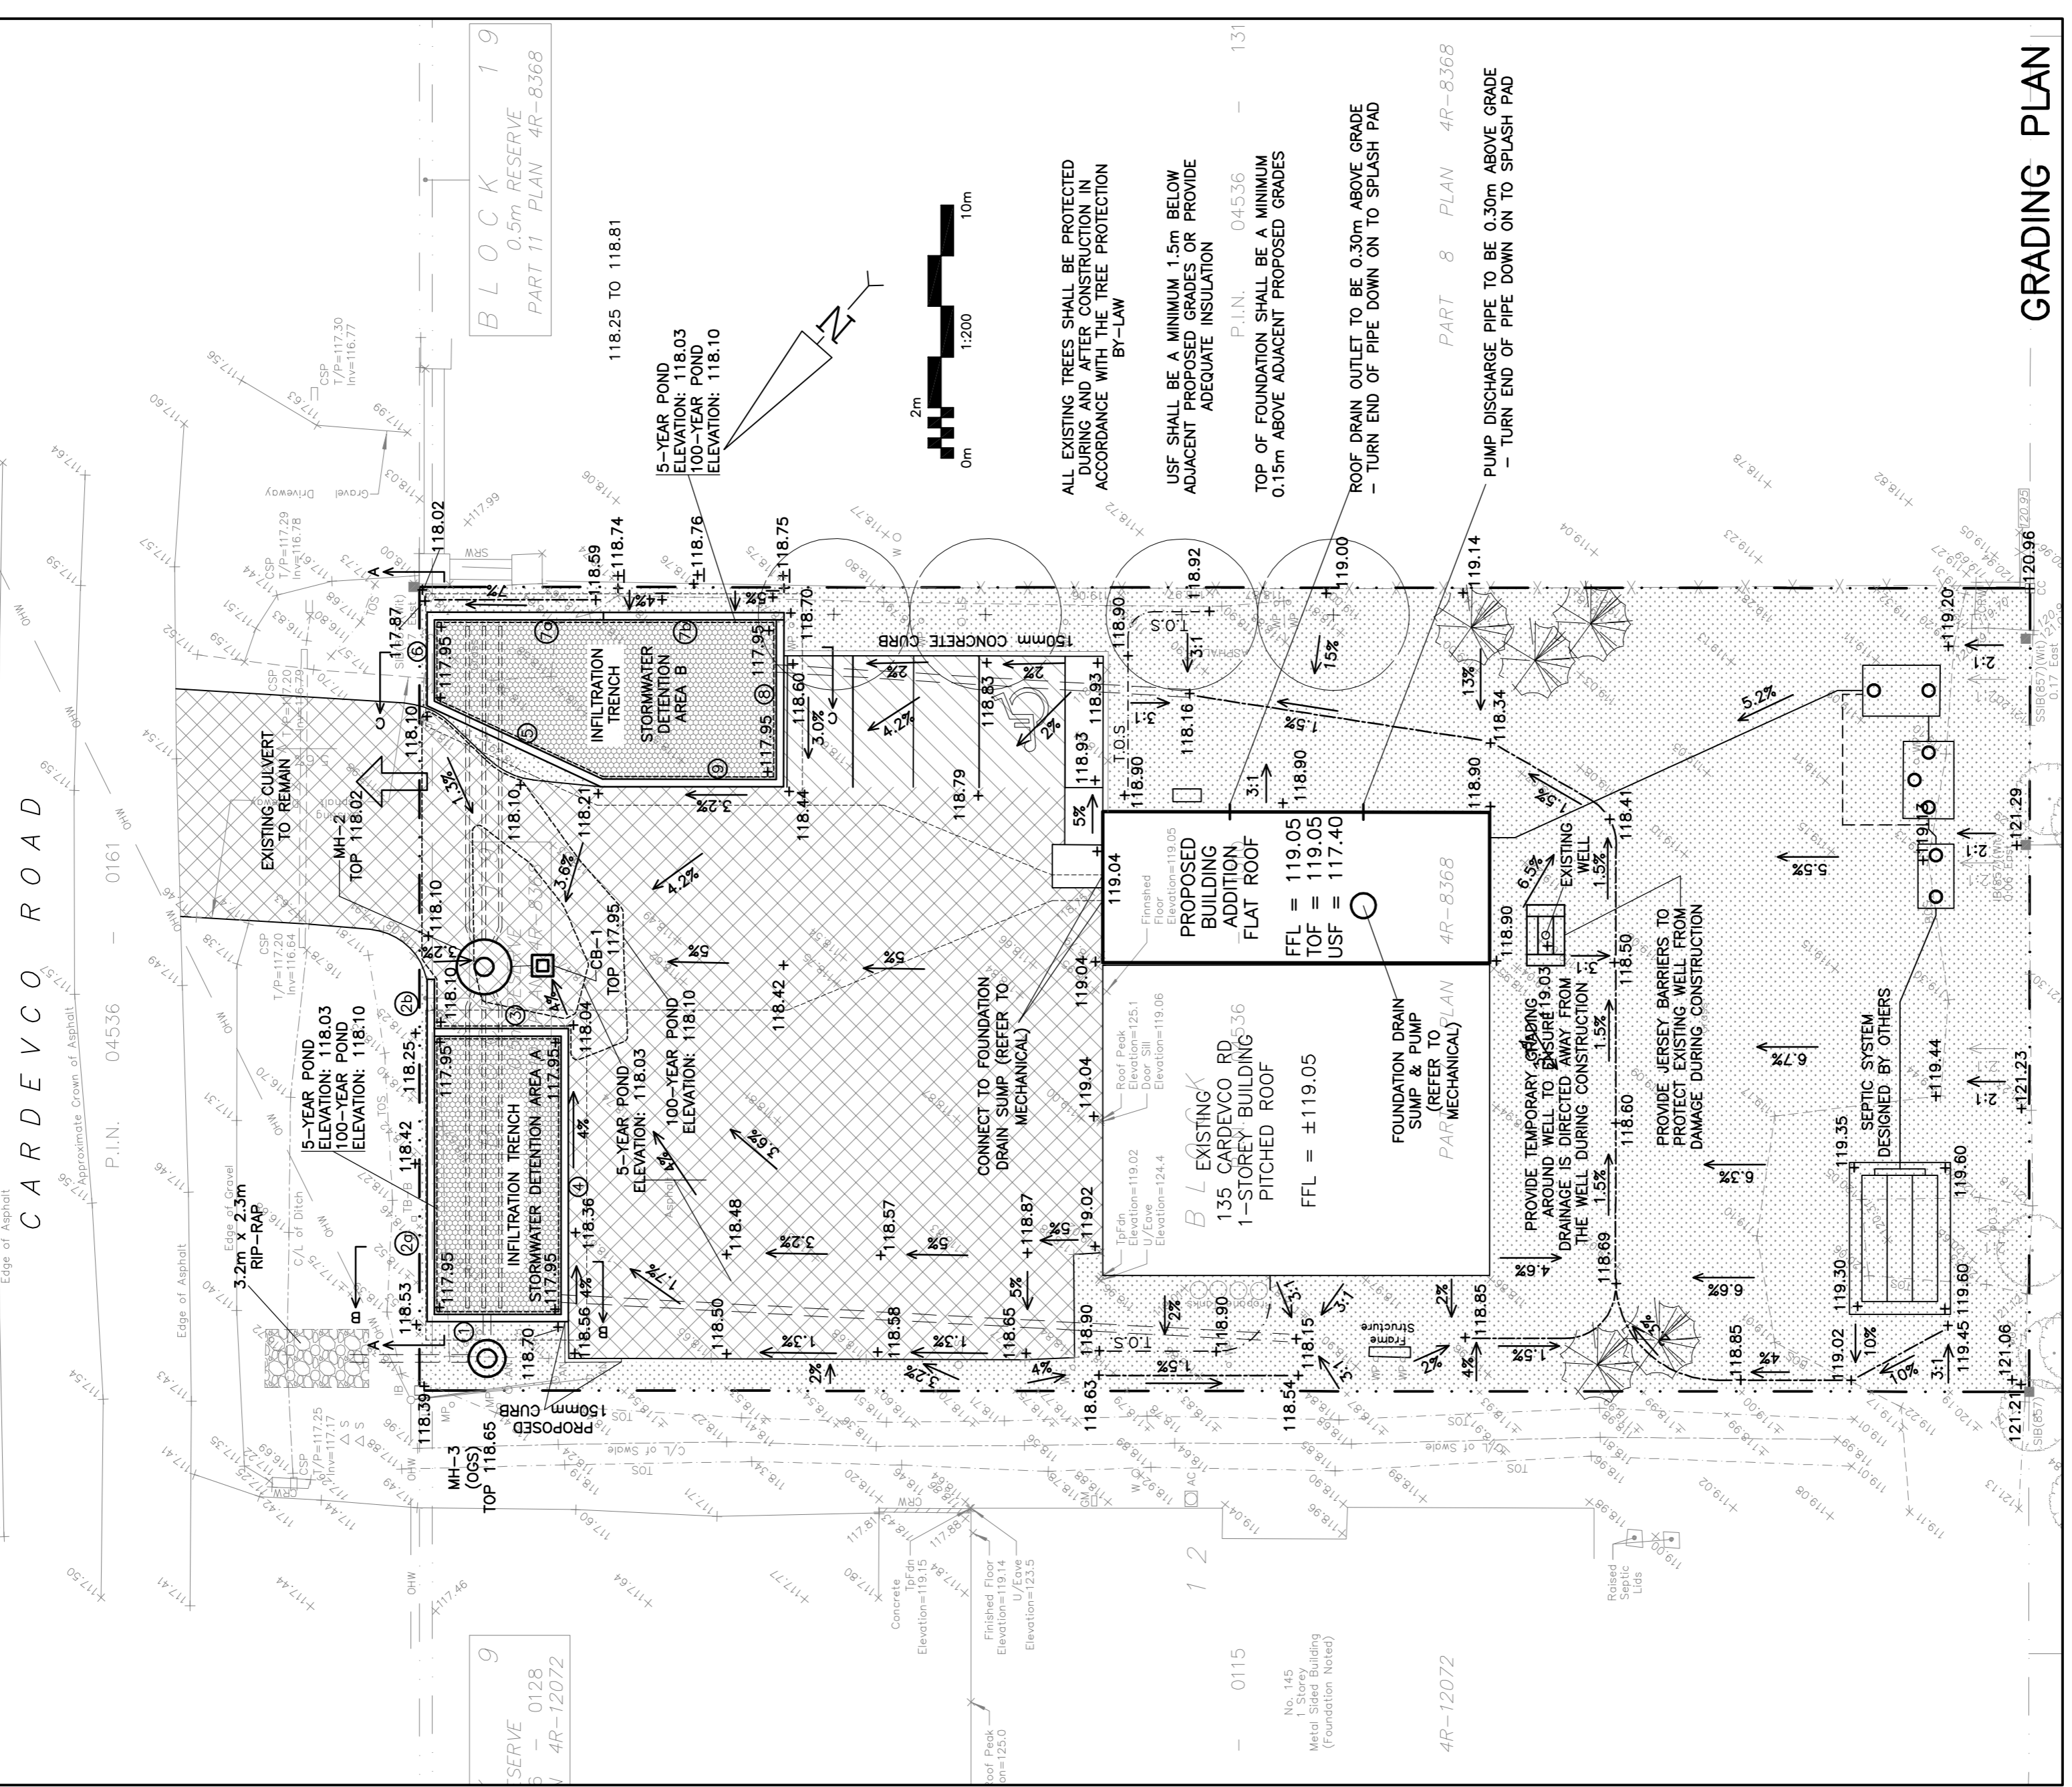


RETAINING WALL SCHEDULE

REF	TOP OF WALL	BOTTOM OF WALL	HEIGHT	NOTES
①	118.85 TO 118.68	117.95	0.90m TO 0.73m	TOP OF WALL TO BE 0.15m ABOVE PROPOSED GRADE DESIGNED BY STRUCTURAL
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LEGEND

FFL	FINISHED FLOOR ELEVATION
TOF	TOP OF FOUNDATION
USF	UNDERSIDE OF FOOTING
---	PROPERTY LINE
CB	CATCH-BASIN
MH	STORM MANHOLE
ST	STORM SEWER
INV	INVERT OF PIPE
+	EXISTING GRADE ELEVATION
+99.99	PROPOSED GRADE ELEVATION
2%	EXISTING SLOPE OF GRADE
2%	PROPOSED SLOPE OF GRADE
↑	EMERGENCY OVERLAND FLOW
T.O.S.	TOP OF SLOPE
B.O.S.	BOTTOM OF SLOPE
---	CENTELINE OF SWALE
.....	SILT FENCE BARRIER
○	ROOF DRAIN
▨	LIGHT-DUTY PAVEMENT
▩	HEAVY-DUTY PAVEMENT
.....	LANDSCAPE

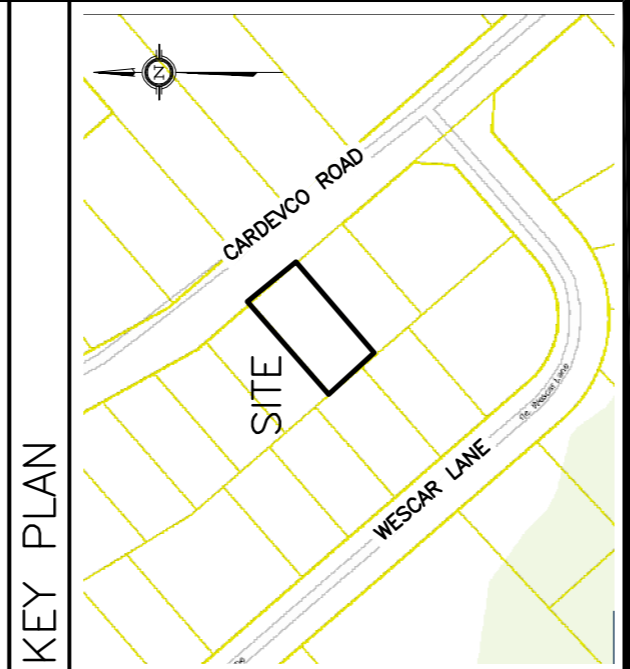

No.	DATE	REVISION
5	OCT 11-24	RE-ISSUED FOR APPROVAL
4	JUN 9-23	RE-ISSUED FOR APPROVAL
3	NOV 24-22	ISSUED FOR APPROVAL
2	NOV 15-22	ISSUED FOR COORDINATION
1	SEP 12-22	PRELIMINARY

D. B. GRAY ENGINEERING INC.
 Stormwater Management Consulting & Planning Services
 700 Long Point Circle
 Ottawa, Ontario
 d.gray@dbgrayengineering.com

PROPOSED ADDITION
 135 CARVEVO ROAD
 OTTAWA, ONTARIO

SITE SERVICING PLAN & GRADING PLAN

Engineer's Seal
 D.B.G.
 H. Scale 1:200
 V. Scale SEP 12-22
 Job No. 21081
 Drawing No. C-1 of 4
 NOT VALID UNLESS SIGNED & DATED