

Plant List					
ID	Qty	Botanical Name	Common Name	Scheduled Size	Remarks
TREES					
As	1	Acer rubrum 'Autumn Spire'	Red Maple	100mm caliper	WB, Staked
Co	1	Celtis occidentalis	Common Hackberry	60mm caliper	WB, Staked
GD	1	Gleditsia triacanthos inermis 'Draves'	Streetkeeper Honeylocust	70mm caliper	WB, Staked
Mj	1	Malus Evereste	Domestic Apple	50mm caliper	WB, Staked
MHG	1	Malus x 'Harvest Gold'	Harvest Gold Crabapple	50mm caliper	WB, Staked
PcN	1	Pinus cembra 'Nana'	Dwarf Swiss Stone Pine	100 cm ht	WB, specimen
Pc	2	Pyrus calleryana	Callery Pear	70mm caliper	WB, Staked
SHRUBS					
CaW	1	Caragana arborecens 'Walker'	Walker's Weeping Peashrub	125cm STEM	WB, specimen
PODM	17	Physocarpus opulifolius 'Donna May'	Little Devil Ninebark	2 gallon pot	Potted
Sp	8	Spiraea prunifolia	Bridal Wreath Spiraea	50 cm ht.	Bare root
SPMK	11	Syringa patula 'Miss Kim'	Miss Kim Dwarf Lilac	100cm ht.	3 gallon Pot
ToH	10	Thuja occidentalis 'Holmstrup'	Holmstrup Eastern Arborvitae	100 cm ht.	Potted
ORNAMENTAL GRASSES					
CaKF	120	Calamagrostis x acutiflora 'Karl Foerster'	Karl Foerster Feather Reed Grass	1 gallon pot	Potted
PvHM	37	Panicum virgatum 'Heavy Metal'	Heavy Metal Switch Grass	1 gallon pot	Potted
PERENNIALS					
PvA	122	Sun perennials (minimum 3 species mix)	Purple Coneflower, Shasta Daisy, Russian Sage		
PvB	41	Shade perennials (minimum 3 species mix)	Hostas, Ferns, Rodgersia		
PvC	47	Shade groundcovers (minimum 3 species mix)	Cranesbill, Spotted Dead Nettle, Woodland Stoncrop		

**CONTRACTOR TO REPORT ANY DISCREPANCIES FOUND BETWEEN PLAN & PLANT LIST PRIOR TO PLANTING**

3996 Innes				
Soil Volume Area, Tree Quantity and Size	Tree Quantity	OTTAWA TARGET SOIL VOLUME (m3)	Design Soil Volume	SOIL ADEQUACY percentage
<b>AREA A - 1 medium shade tree</b>				
plant bed (34.5 sq m x 0.7 avg metre deep)	1	25.0	24.2	96.60%
<b>AREA B - 1 small columnar evergreen (10cm DBH)*</b>				
plant bed (11 sq m x 0.6 avg metre deep)	1	6.0	6.6	110.00%
<b>AREA C - 1 small shade tree, 1 small ornamental tree (15cm DBH)*, 1 small ornamental tree (8cm DBH)*</b>				
plant bed (67 sq m x 0.4 avg metre deep)	3	21.1	26.8	127.01%
<b>AREA D - 2 large shade trees</b>				
plant bed (24 sq m x 1.2 avg metre deep)	2	36.0	28.8	80.00%
<b>AREA E - 4 large shrubs*</b>				
plant bed (14.8 sq m x 0.4 avg metre deep)	4	5.6	5.9	105.71%

\* Small ornamental trees with growth to 8-15cm DBH using 'How much soil to grow a big tree' by DeepRoot as a guide. Small ornamental, upright evergreens used close to building in accordance with geotechnical report.

4.5 metre offset – allowance for low water requirement plants such as small ornamental plants such as horticultural cedars, junipers, grafted deciduous such as caragana, small crab apples under 4.5 metre height.

4.5 to 7.5 metre offset – allowance for low water requirement trees up to 7.5 metre mature height.

**Beyond 7.5 metres – low water requirement trees 7.5 to 14 metre mature height.  
Trees over 14 metre mature height to be planted mature height away from building.**

**ALL PLANT MATERIAL SHALL BE WARRANTIED FOR TWO YEARS FROM THE DATE OF SUBSTANTIAL PERFORMANCE AS DETERMINED BY THE CITY OF OTTAWA.**


**NOTE**  
THIS PLAN IS ISSUED FOR SITE PLAN CONTROL SUBMISSION ONLY.  
ADDITIONAL DETAILING AND SPECIFICATIONS ARE REQUIRED PRIOR TO TENDERING OR  
CONSTRUCTION.

DRAWING TO BE READ IN CONJUNCTION WITH TREE CONSERVATION REPORT. REFER TO TREE CONSERVATION REPORT PREPARED BY JFS DATED 2021-11-18 FOR TREE PROTECTION MEASURES AND DETAILS. MAP REVISED 2022-07-08

## GENERAL NOTES

- 1 All general site information and conditions compiled from existing plans, surveys and consultant's field notes. Report all discrepancies prior to any work. No responsibility is borne by the Consultant for unknown subsurface conditions.
- 2 The location of the utilities is approximate only, and the exact location should be determined by consulting the municipal authorities and utility companies concerned. The Contractor shall prove the location of utilities and shall be responsible for adequate protection from damage.
- 3 All dimensions shown are to be verified on site prior to any construction. No deviations are to be made from the layouts as shown on this plan without prior consultation with the Landscape Architect and Owner.
- 4 Obtain approval of Landscape Architect for granular base and layout of all pavement areas prior to construction.
- 5 Stake planting locations and receive approval of Landscape Architect, prior to excavation of any planting pits. No substitutions of plant material shall be made without prior approval of the Landscape Architect.
- 6 Where clay is encountered proper drainage must be ensured in trees/shrub pits, prior to planting. Have method approved by Landscape Architect.
- 7 All sodded areas to receive a minimum of 150mm of topsoil over graded sub-base. If sod with mesh is used, mesh to be removed completely during sodding operations. Sod shall come from an approved source and shall be laid within 24 hours of being cut in the nursery. Only nursery sod shall be used.
- 8 Final subgrade is to be approved by the Landscape Architect prior to sod being laid.
- 9 Maintain positive surface runoff through the entire construction period.
- 10 Reinststate all areas and items damaged as a result of construction activities.

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3	Re-issued SPC submission	2023/01/09
2	Re-issued SPC submission	2022/07/08
1	Issued for SPC submission	2021/11/22
no.	issue / revision	date

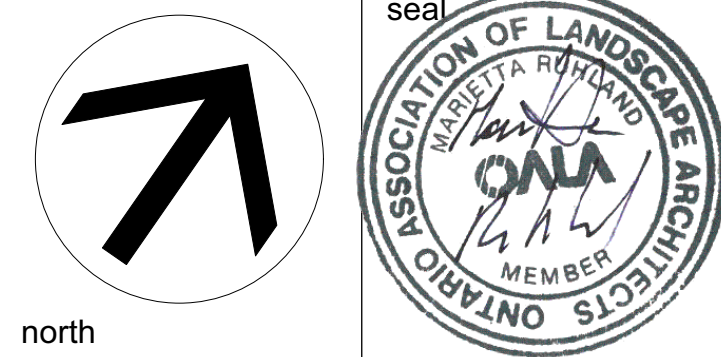

project

**3996 INNES RD,**  
OTTAWA ON

drawing title

## LANDSCAPE PLAN

scale 1:100	drawn by D.A / T. F	designed by M. Ruhland
	checked by M. Ruhland	
project number <b>21-1647</b>	drawing number <b>L - 01</b>	

Contractor to check and verify all dimensions on the job





SOIL VOLUME NOTES TO GO WITH L1

TREE SOIL VOLUME REQUIREMENTS:  
- STANDARD TREE SOIL VOLUMES  
QUANTITIES INCLUDE THE TOP 900-1000mm  
OF SOIL/EXISTING SUBSOIL LAYER TO  
CALCULATE TOTAL SOIL VOLUMES REQUIRED  
BY CITY OF OTTAWA FOR SUSTAINABLE TREE  
GROWTH. WHERE LARGER SOFT AREAS ARE  
AVAILABLE, THE TOP 400-500mm LAYER IS  
USED TO CALCULATE SOIL VOLUMES.

- WHERE EXISTING MATERIAL BELOW THE  
SPECIFIED TOPSOIL IS NOT CONDUCTIVE TO  
TREE GROWTH, AN ADDITIONAL LAYER OF  
PLANTING MEDIUM IS TO BE INSTALLED  
BELOW SPECIFIED TOPSOIL DEPTH TO OBTAIN  
THE SOIL VOLUME DEPTH REQUIRED.


- REFER TO SOIL VOLUME CHART AND PLANS  
FOR AREA WHERE TREE SOIL VOLUMES ARE  
REQUIRED.

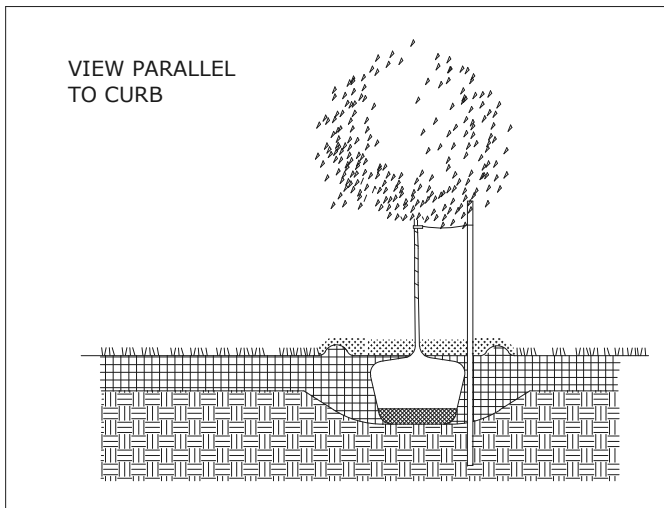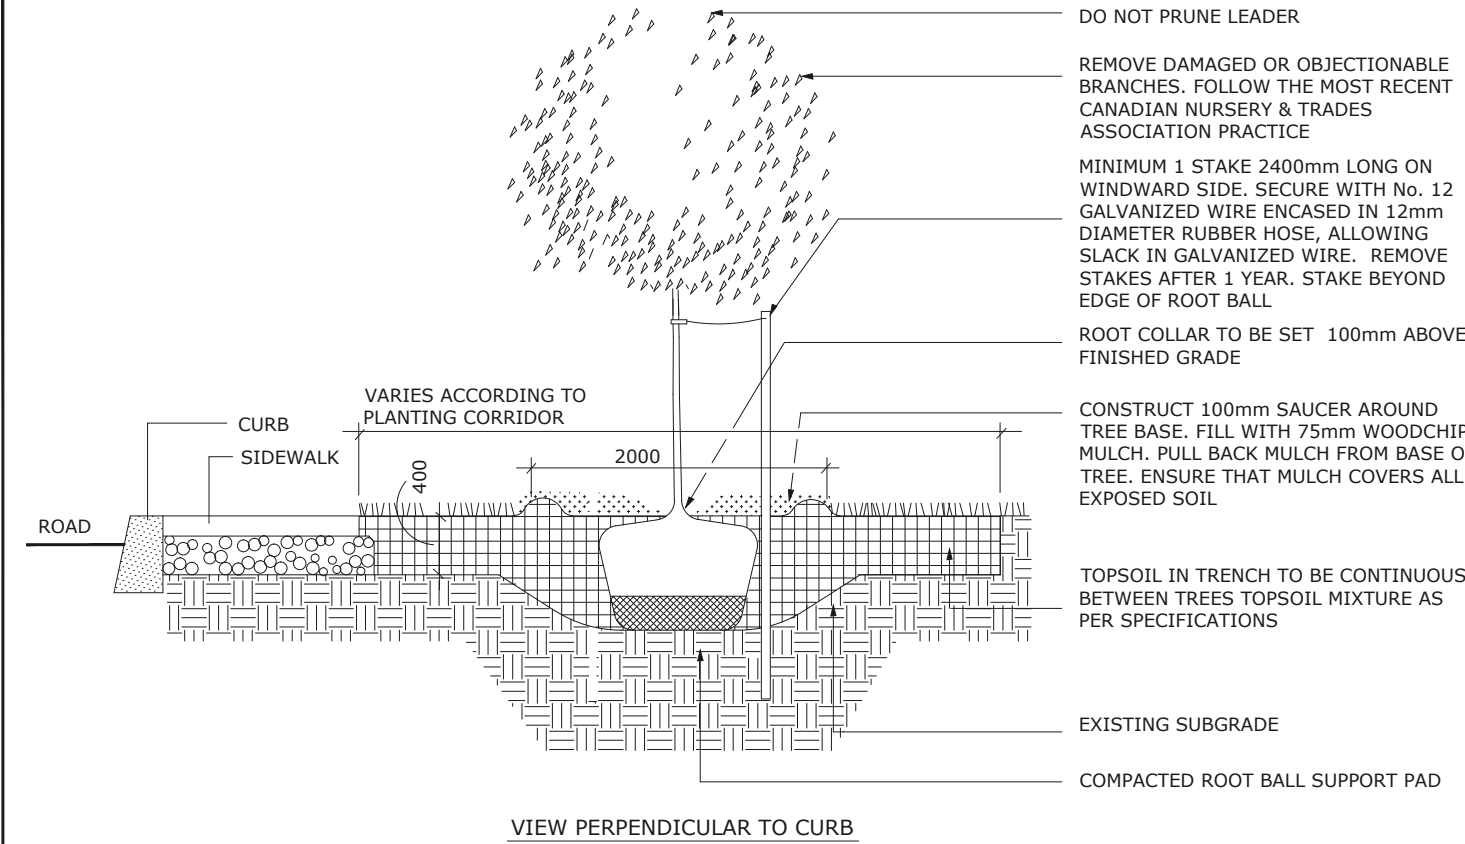

- NOTES:
1. ALL MEASUREMENTS ARE IN MILLIMETRES UNLESS OTHERWISE NOTED
  2. CUT AND REMOVE BURLAP AND WIRE BASKET FROM TOP 2/3 OF ROOT BALL WITHOUT DISTURBING ROOTS
  3. LOCATION AS SPECIFIED ON THE CONTRACT DRAWINGS




TITLE: PLANTING TRENCH WELL DRAINED SOILS  
DATE: MAY 2001  
REV: JAN 2017  
DWG No: L1

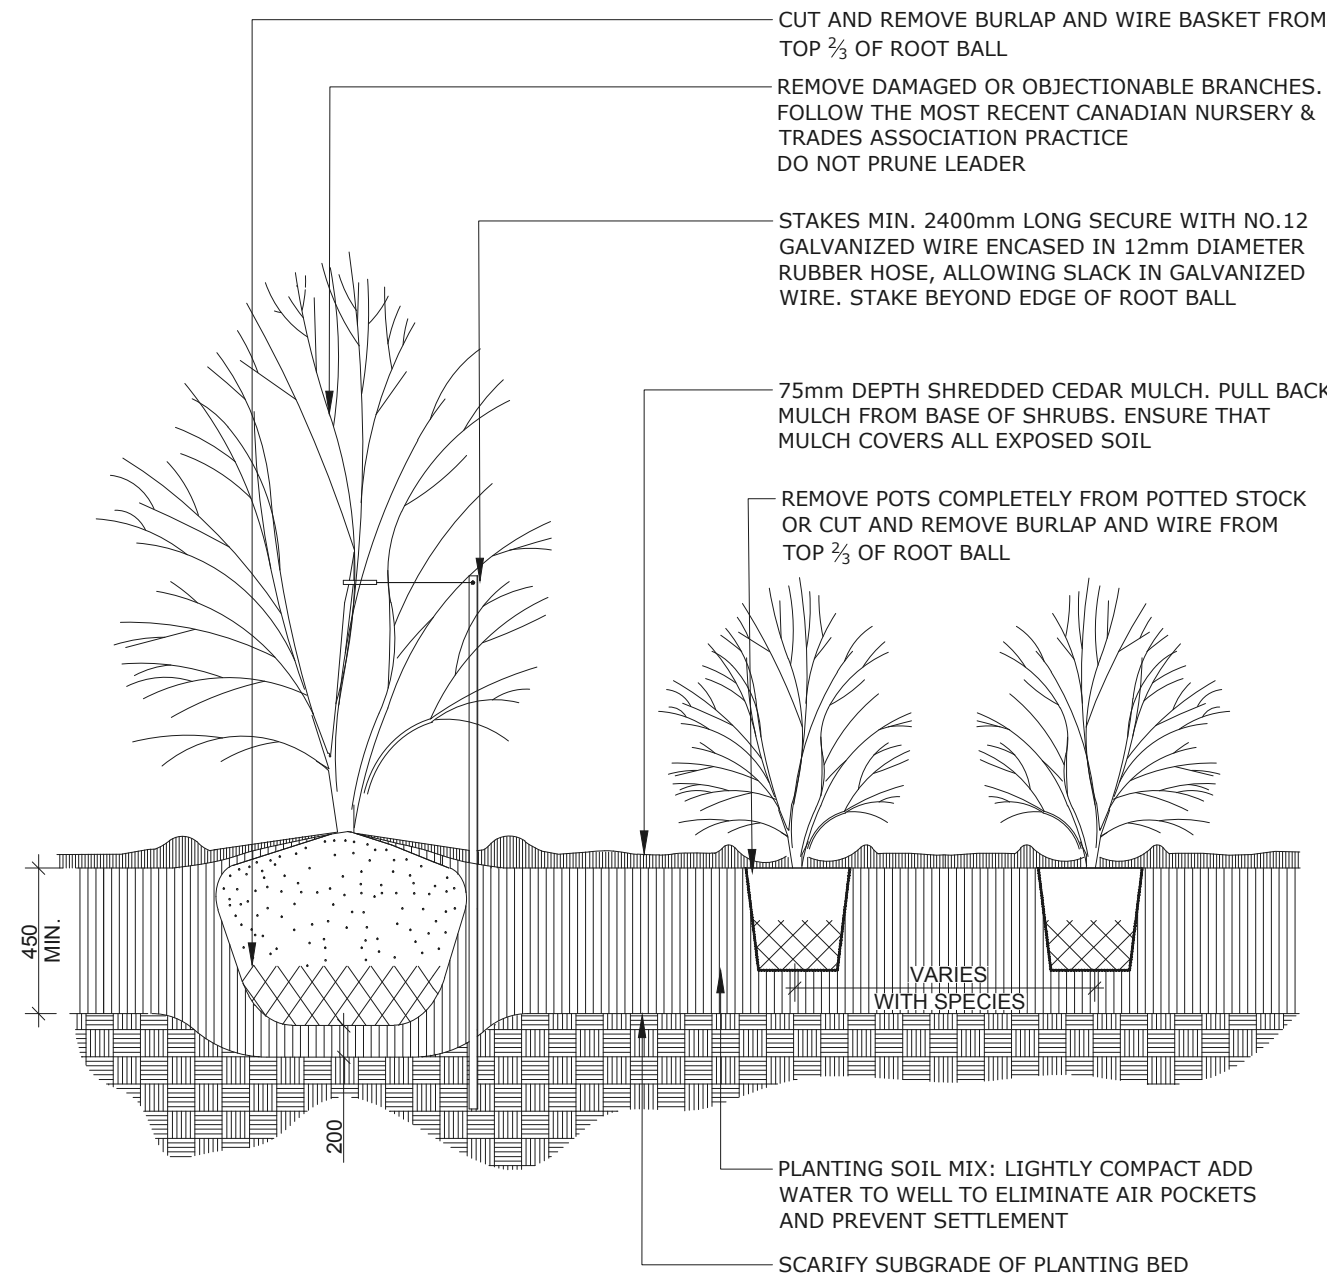

- NOTES:
1. PLANTING SOIL MIXTURE AS PER SPECIFICATION.
  2. SHRUBS SPECIFIED BARE ROOTS (B.R.) TO BE PLANTED SO THAT ROOTS ARE FULLY EXTENDED IN PLANTING HOLE WITH SOIL MIX BACKFILLED CAREFULLY TO PREVENT ROOT DAMAGE
  3. PROVIDE 100 HIGH EARTH SAUCER AROUND SHRUB BED
  4. STAKES TO BE REMOVED AT COMPLETION OF TWO YEAR WARRANTY PERIOD




TITLE: CONTINUOUS SHRUB BED PLANTING  
DATE: FEB 2013  
REV: FEB 2014  
DWG No: L17

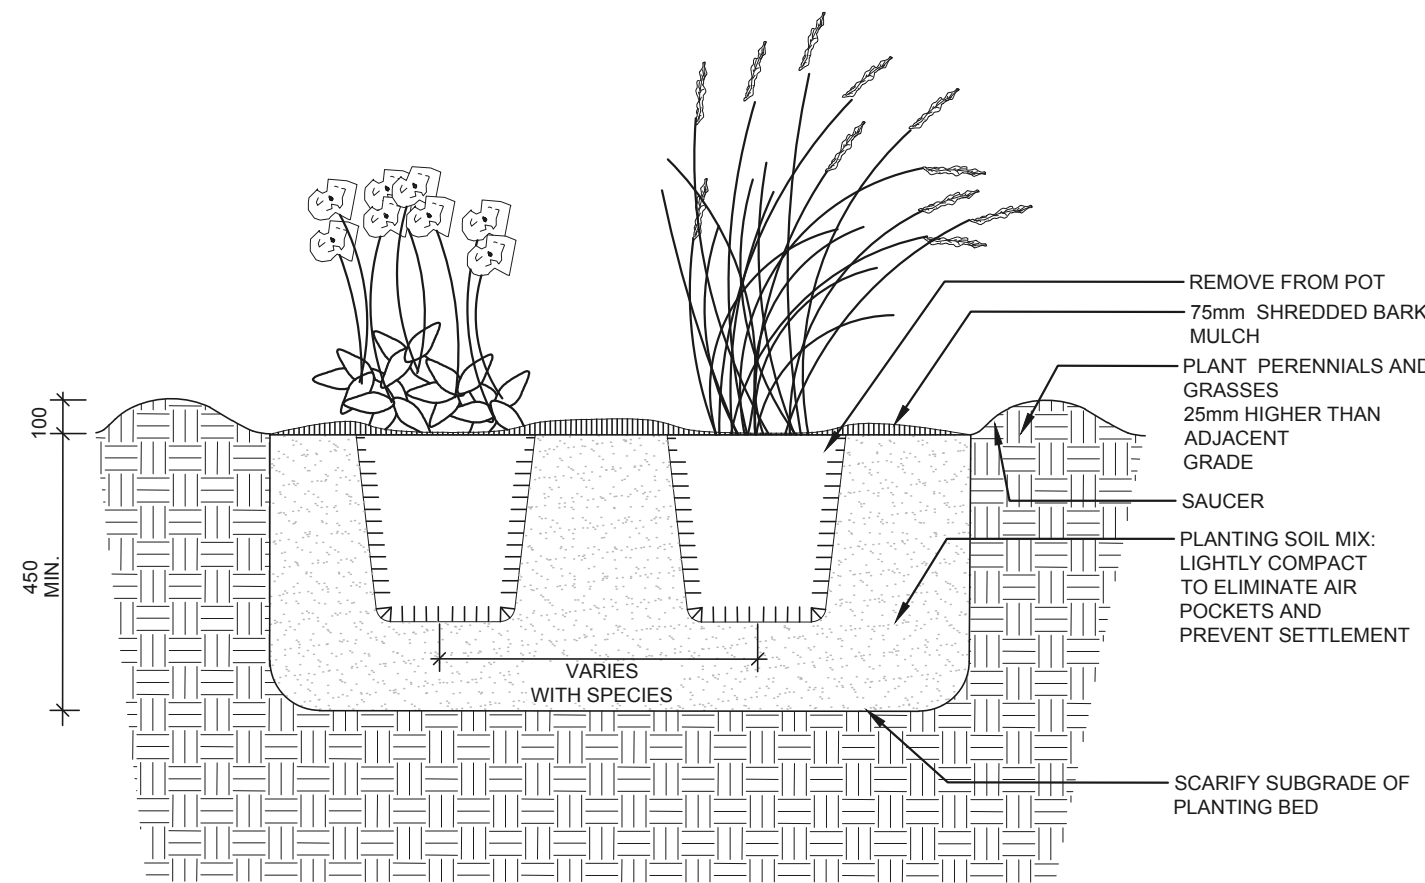


- NOTES:
1. ALL DIMENSIONS ARE IN MILLIMETRES UNLESS OTHERWISE NOTED.
  2. PLANTING SOIL MIXTURE AS PER SPECIFICATION.
  3. PROVIDE 100MM HIGH EARTH SAUCER AROUND PERENNIAL/GRASS BED.



TITLE: PERENNIAL AND ORNAMENTAL GRASS PLANTING  
DATE: JAN 2015  
REV:  
DWG No: L21

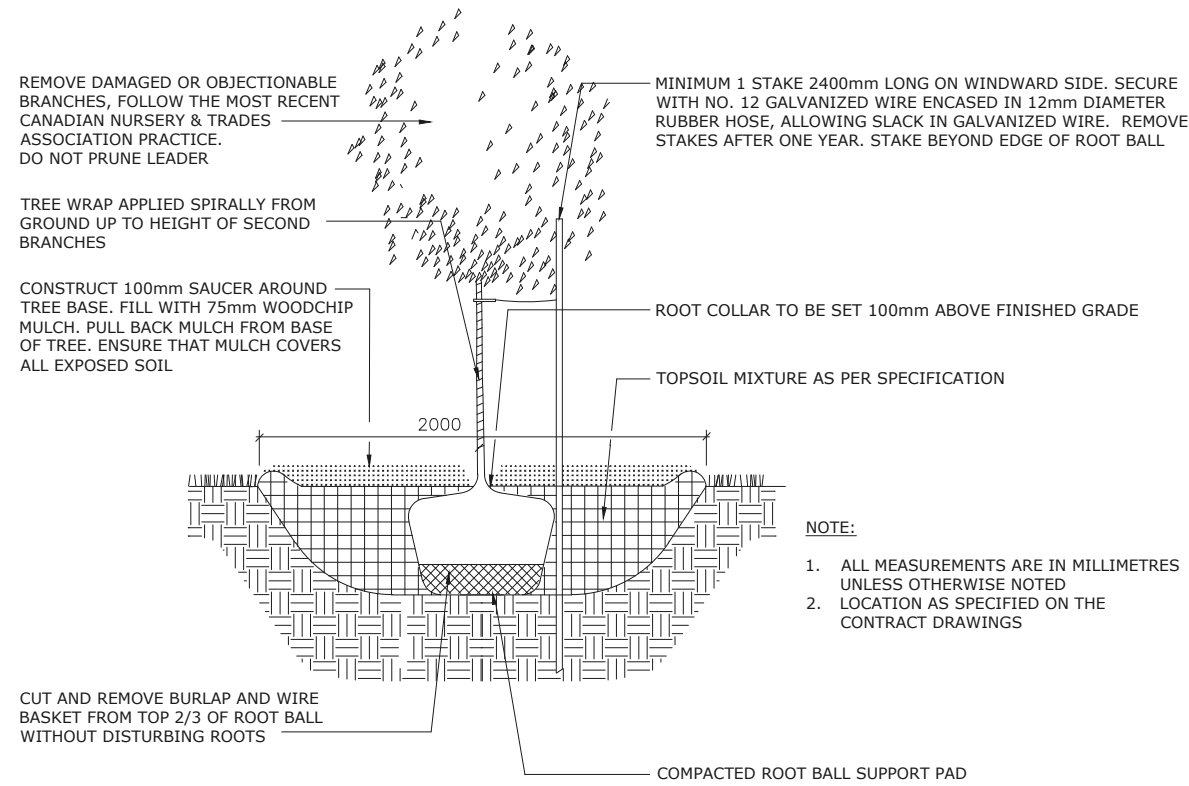


DECIDUOUS TREE PLANTING

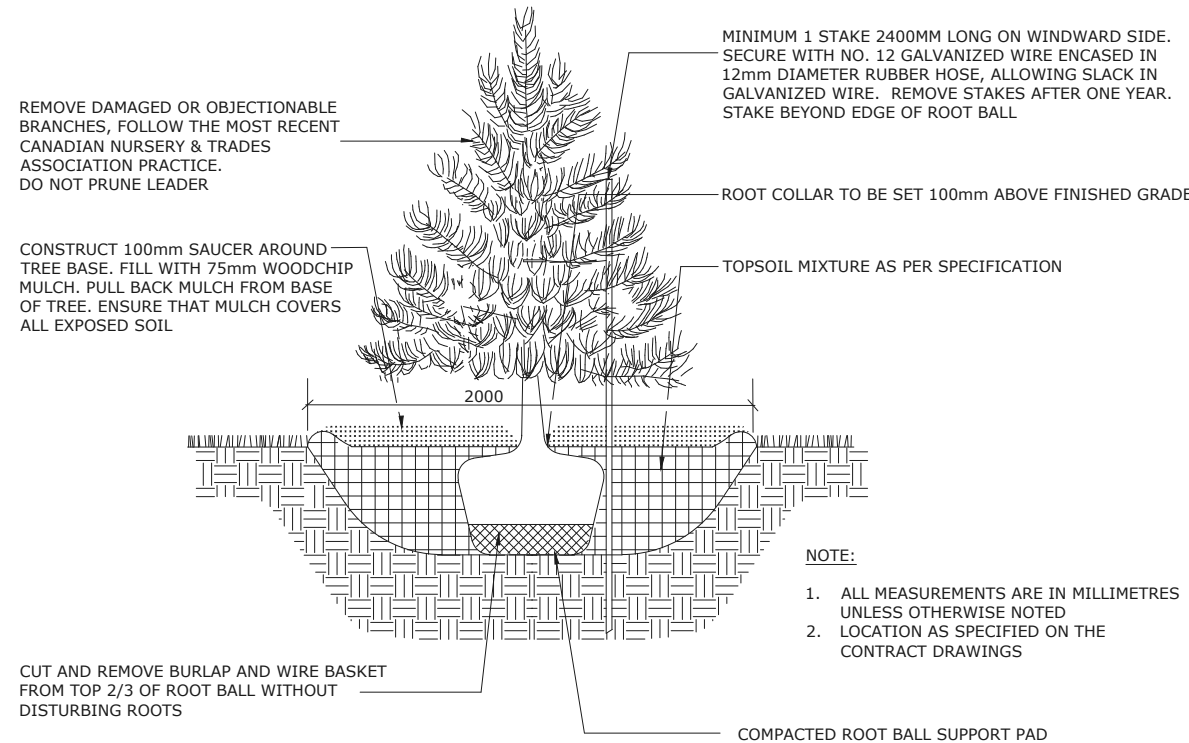

CONIFEROUS TREE PLANTING



TITLE: PLANTING PIT, WELL DRAINED SOILS (ROAD ALLOWANCE)  
DATE: MAY 2001  
REV: JAN 2017  
DWG No: L3

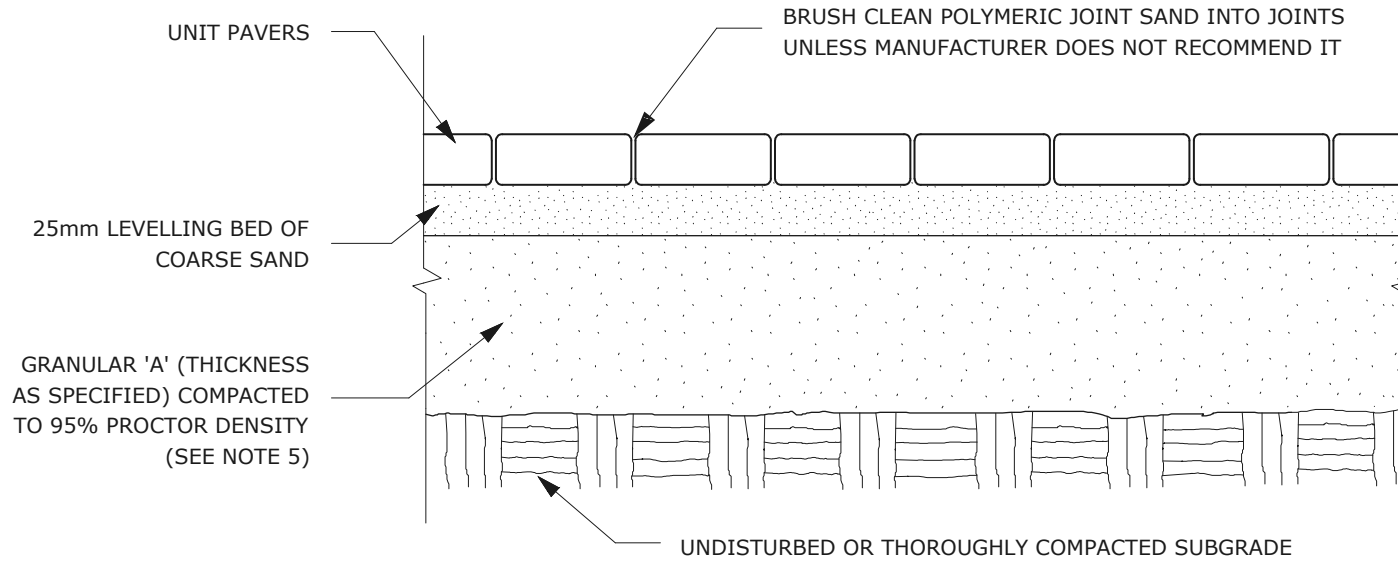

- NOTES:
1. THE LEVELING COURSE (BEDDING SAND) SHALL BE PLACED LOOSE, IN A UNIFORM LAYER AT A MAXIMUM DEPTH OF 25mm TO ACHIEVE THE FINAL COMPACTED THICKNESS AND GRADE AS SPECIFIED
  2. INSTALL SOLID EDGE RESTRAINT BETWEEN UNIT PAVERS AND ANY SOFT SURFACE (SOD, PLANTING BED, ETC.)
  3. UNIT PAVERS ARE THEN PLACED ON TOP OF THE LEVELING COURSE AND ADDITIONAL SAND SWEEPED BETWEEN THE UNIT PAVERS
  4. THE UNIT PAVERS ARE THEN VIBRATED INTO PLACE WITH A VIBRA-PLATE AND WATER IS ADDED TO ASSIST IN THE SETTLING OF THE JOINT SAND
  5. GRANULAR 'A' DEPTH TO BE 100mm FOR PEDESTRIAN AREAS AND 150mm FOR VEHICULAR ACCESSES. OR AS RECOMMENDED BY GEOTECHNICAL INVESTIGATION
  6. USE OF THIS DETAIL REQUIRES THE PRIOR APPROVAL OF THE GENERAL MANAGER



TITLE: UNIT PAVING - ON GRANULAR BASE  
DATE: MAY 2001  
REV: FEB 2016  
DWG No: SC9

ADDITIONAL NOTES FOR SC9 NUMBER 5: PRECAST PAVERS IN PEDESTRIAN AREAS WHERE NORMAL SNOW REMOVALS ARE DONE IS TO RECEIVE A MINIMUM 200mm GRANULAR 'A'. FURTHER ADJUSTMENTS TO BE SPECIFIED IN RELATION TO SITE CONDITIONS AND GEOTECHNICAL RECOMMENDATIONS.

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1	Issued for SPC submission	2021/11/22

no.	issue / revision	date
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north



project

3996 INNES RD,  
OTTAWA ON


drawing title

DETAILS

scale	drawn by D.A. / T. F.	designed by M. Ruhland
	checked by M. Ruhland	
project number <b>21-1647</b>	drawing number <b>L - 02</b>	

Contractor to check and verify all dimensions on the job



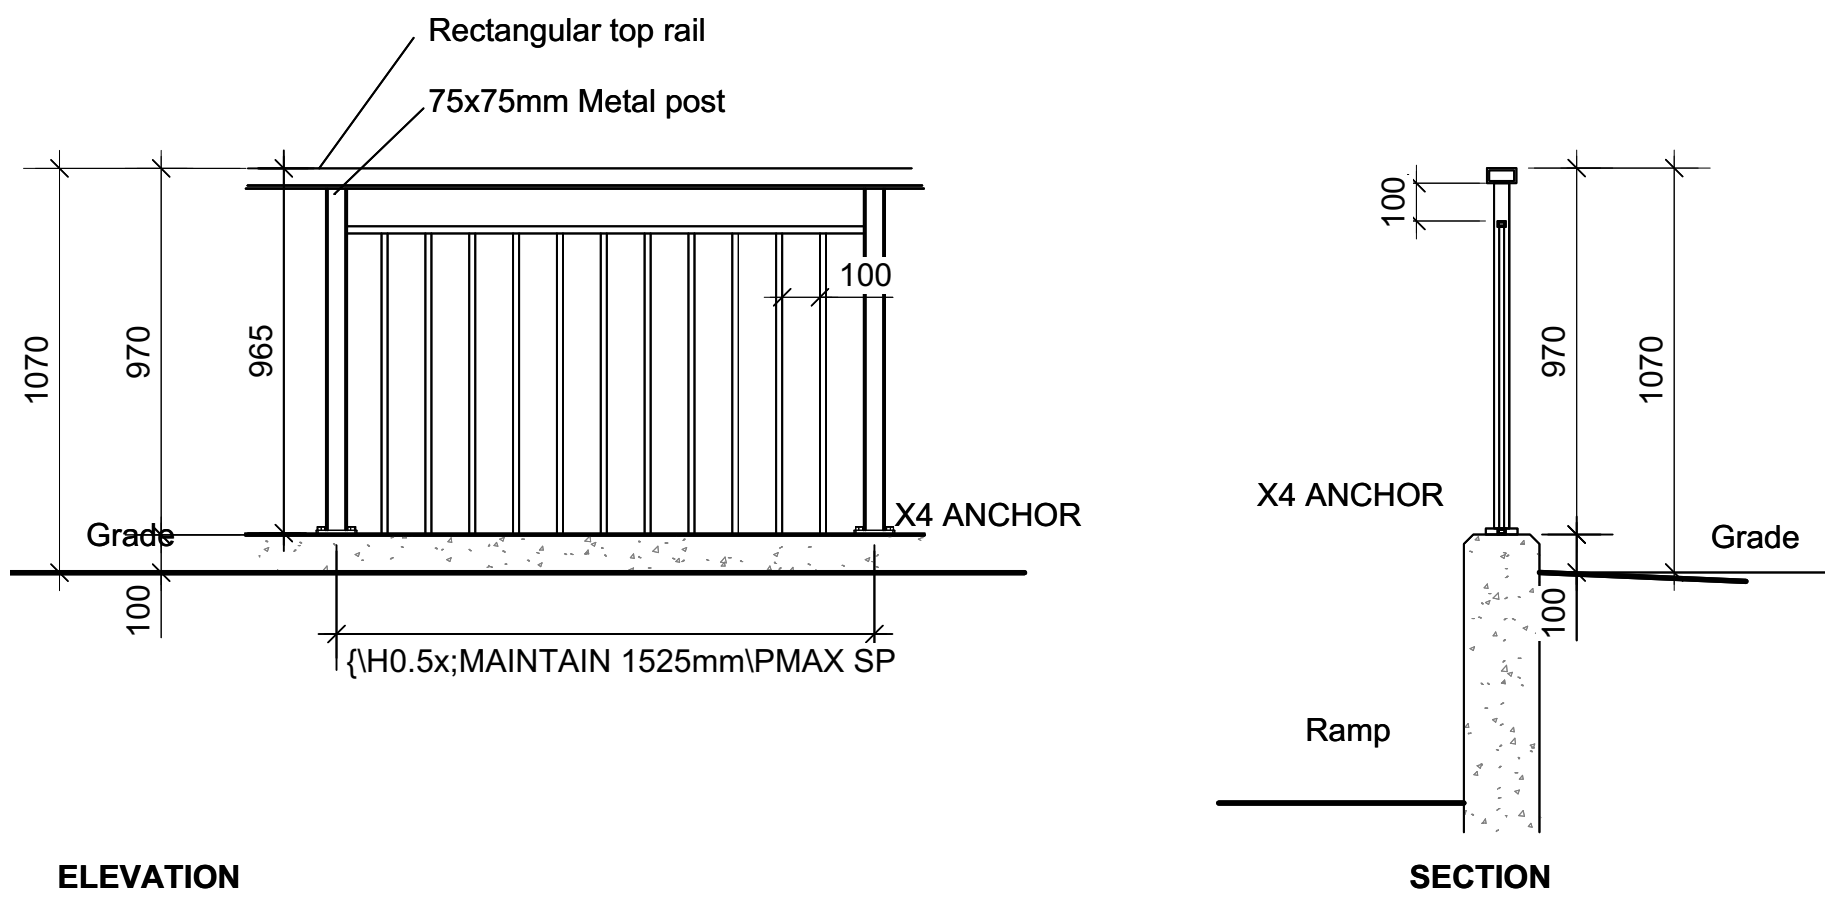

ELEVATION

SECTION


1 METALLIC GUARD RAIL  
Scale: NTS  
REFER TO SITE PLAN FOR LOCATIONS




3 SKYLINE OUTDOOR PATIO HARD-TOP GAZEBO  
Canvas, w/ Bug Net, Black 10'x12'



4 GLOBAL INDUSTRIAL 4' PARK BENCH  
Tan, w/Backrest

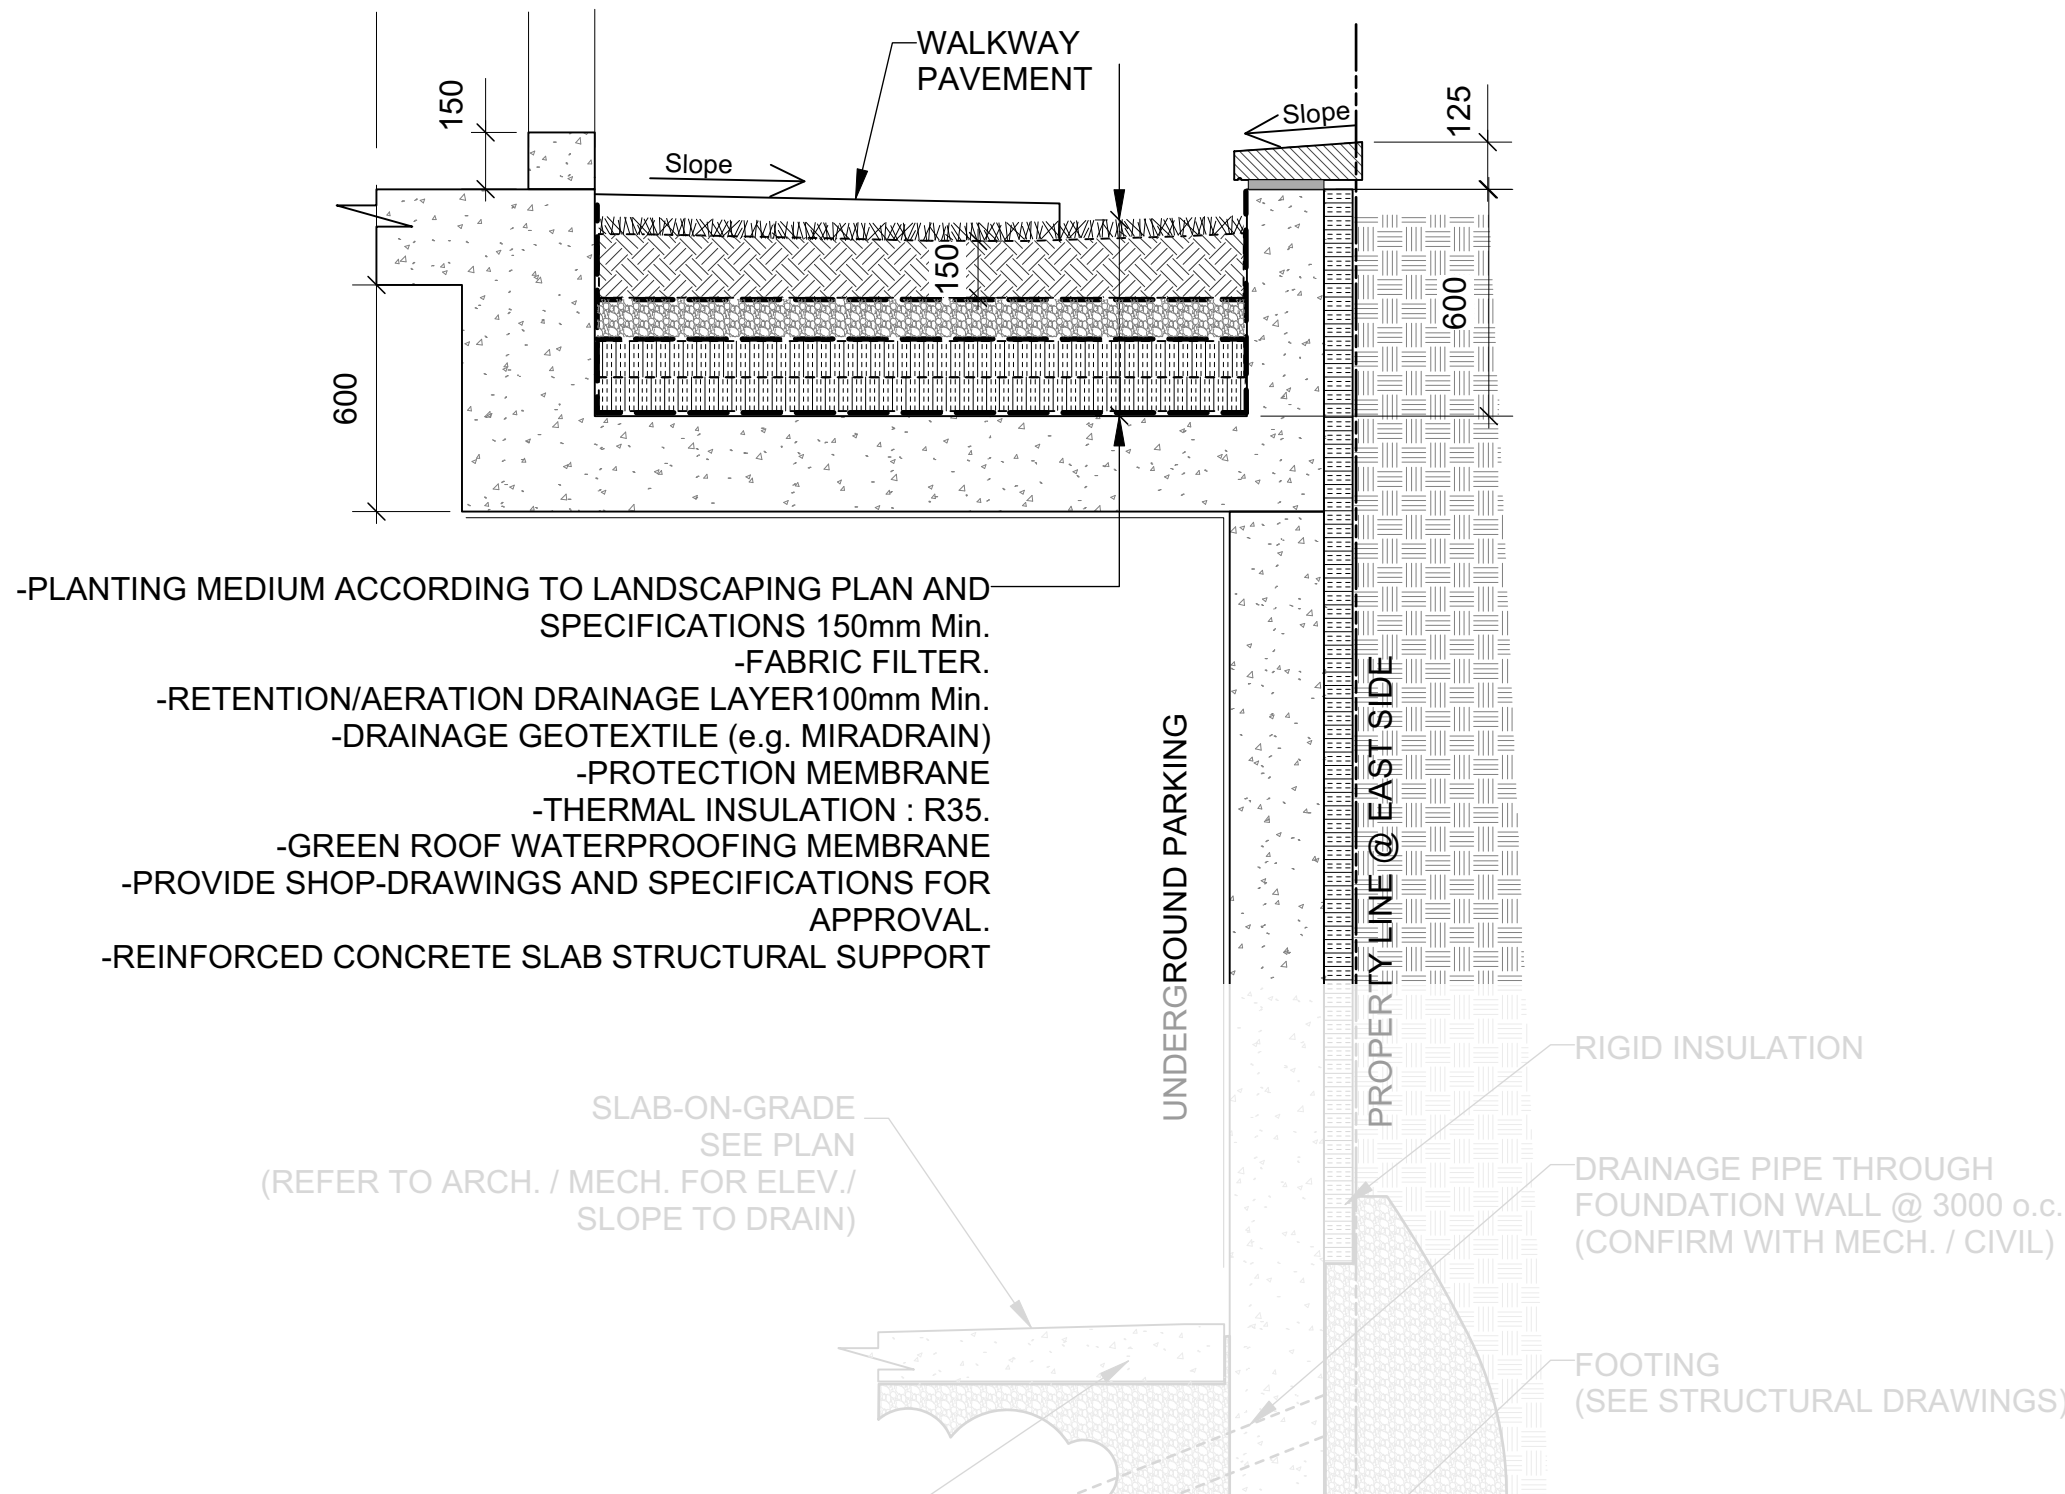

2 SECTION ALONG EAST PROPERTY LINE  
Scale: NTS

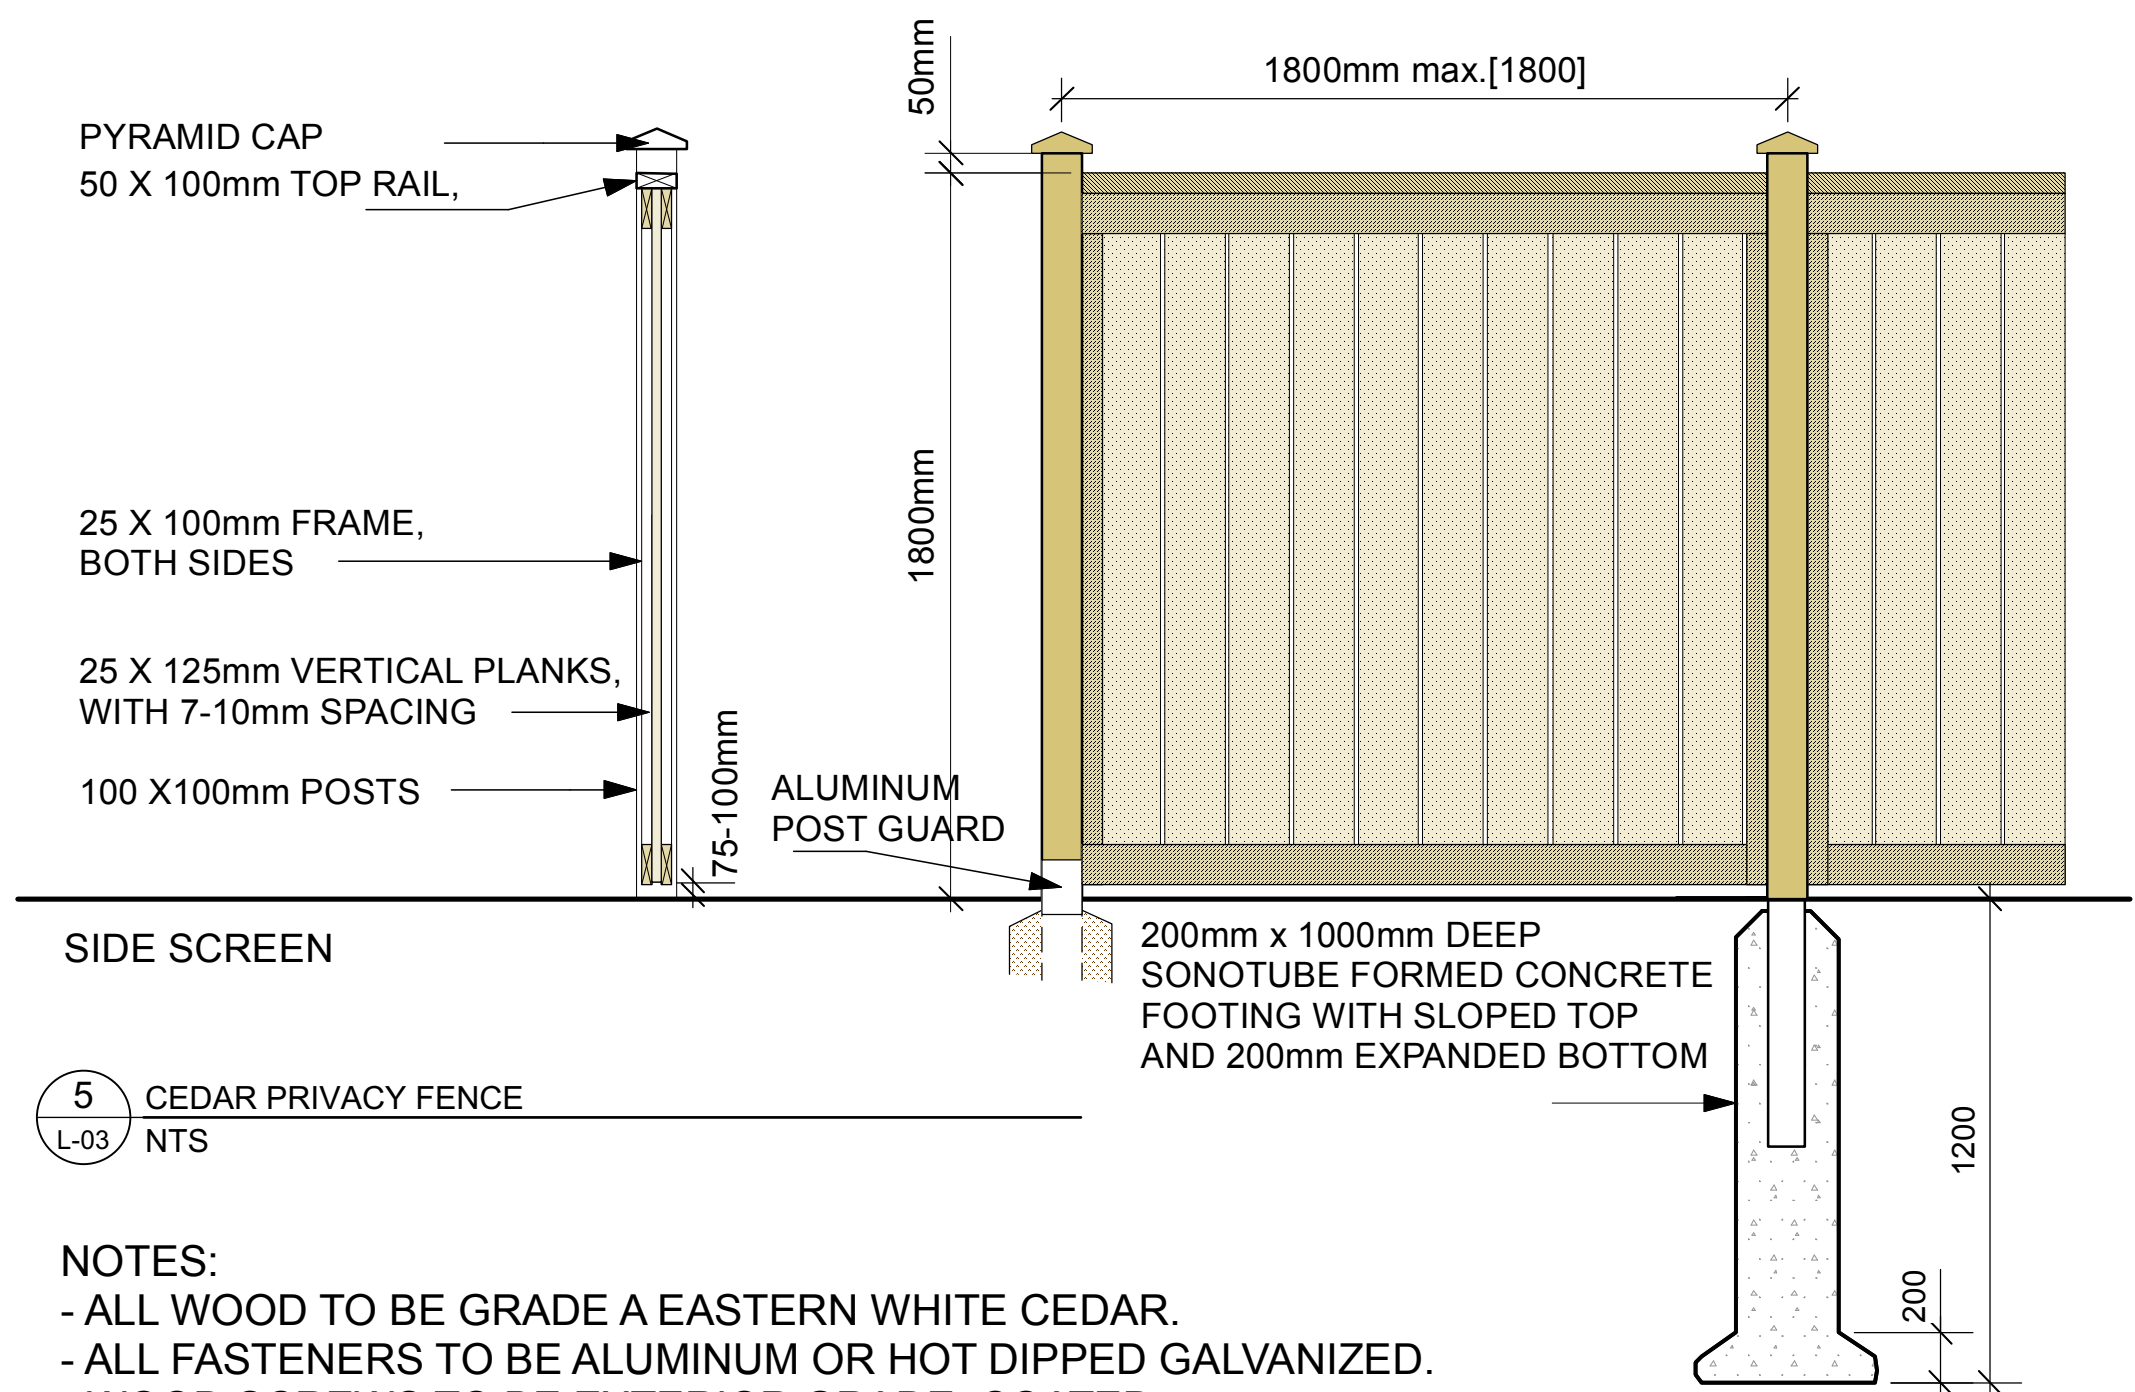

5 CEDAR PRIVACY FENCE  
NTS


NOTES:  
- ALL WOOD TO BE GRADE A EASTERN WHITE CEDAR.  
- ALL FASTENERS TO BE ALUMINUM OR HOT DIPPED GALVANIZED.  
- WOOD SCREWS TO BE EXTERIOR GRADE, COATED.  
- WOOD FENCE TO BE LEFT NATURAL.  
- PROVIDE MOCKUP SAMPLE.

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north



project

3996 INNES RD,  
OTTAWA ON

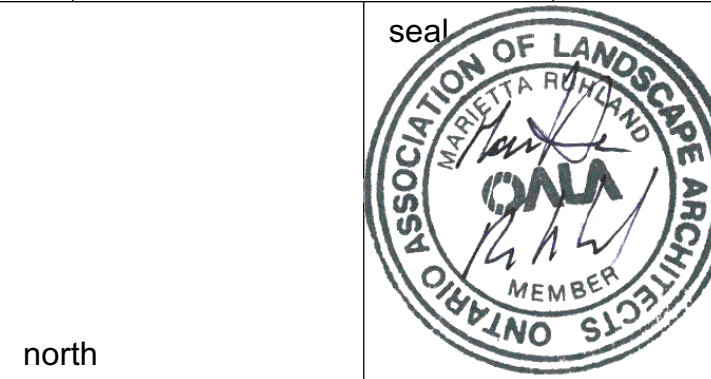drawing title

DETAILS

scale	drawn by D.A. / T.F.	designed by M. Ruhland
	checked by M. Ruhland	
project number	drawing number <b>L - 03</b>	

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