

LANDSCAPE PLAN

L.1 | SCALE 1:250

## **40 YEAR CANOPY CALCULATION:**

- -5,729 m2 site area
- -2 Large coniferous trees proposed (79m2 ea.) & 25 small trees proposed (7m2 ea)
- =333m2 canopy cover =5.8% canopy cover

(36 UNITS)

AT GRADE COMMERCIAL SPACE

promenade PALEO DRIVE

- \*Large coniferous tree calculated at 10m, small deciduous trees at 3m.
- Tree planting opportunities are limited on site due to the presence of Marine Clay Soil.

#### **GENERAL NOTES:**

construction activity.

1. It is the responsibility of the appropriate contractor or official to report any errors, omissions or discrepancies on this plan with actual site conditions to the Landscape Architect before proceeding with construction.

2. The contractor is to notify all utility companies and authorities prior to any excavation and ascertain locations of underground services. 3. The contractor is to reinstate all areas and items damaged as a result of

4. The contractor is to comply with all pertinent codes and by-laws. 5. The contractor is to maintain a positive surface run-off throughout the entire

construction period. 6. The Landscape Architect is not responsible for subsurface conditions.

7. The contractor is to identify all existing trees to remain on site with the Landscape Architect prior to construction.

8. The contractor is to stake the proposed location of all plant material in

- conjunction with the Landscape Architect prior to excavation. 9. Minimum distances for selected deciduous trees are as follows:
- Building Foundations 7.5m Sidewalks 1.5m
- Public Streets 2.5m Underground Infrastructure 1.5m
- 10. All trees within 1m of underground utility trenches are to be excavated by
- 11. Remove all protective wrapping from tree trunks after installation. 12. Staking of trees shall only be performed if necessary.
- 13. Ensure that mulch is pulled back a min. distance of 75mm from base of tree

# PROPOSED PLANT LIST (REY)

KEY QTY. BOTANICAL NAME COMMON NAME REMARKS SIZE CONDITION

#### PROPOSED TREES

<b>★</b> SB	14	Amelanchier canadensis	Shadblow Serviceberry	50mm cal.	B&I
<b>★</b> SF	11	Amelanchier laevis	Allegheny Serviceberry	50mm cal.	B&I
<b>L</b> \\/C	2	Dicoa glauca	White Spruce	2.0m ht	DΩI

### **SHRUBS**


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l	* DW	34	Cornus sericea	Red Osier Dogwood	600 mm ht.	Potted	1000 mm o.d
ı	JH	28	Juniperus horizontalis 'Bar Harbor	' Bar Harbor Juniper	600 mm spr.	Potted	1000 mm o.d
ı	* NB	9	Physocarpos opulifolius	Ninebark	600 mm ht.	Potted	1000 mm o.d
l	RR	56	Rosa rugosa	Rugosa Rose	600 mm ht.	Potted	1000 mm o.d
ı	* SS	16	Rubus odoratus	Flowering Raspberry	600 mm ht.	Potted	1000 mm o.d
١	* WC	28	Thuja occidentalis	White Cedar	2000 mm ht.	Potted	1000 mm o.d
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#### **ORNAMENTAL GRASSES**


3L	17	Leymus arenarius 'Blue Dune'	Blue Dune Grass	250mm pot	Potted	800 mm o.c
ίF	17	Calamagrostis 'Karl Foerster'	Karl Foerster Grass	250mm pot	Potted	800 mm o.c

\* NATIVE TO ONTARIO

NOTE: ALL TREES ARE PROPOSED ON PRIVATE PROPERTY WITH THE EXCEPTION OF THE EIGHT (8) TREES PROPOSED ON THE PALEO DRIVE R.O.W. AND THE FOUR (4) TREES PROPOSED ON THE ROSEDALE STREET R.O.W.

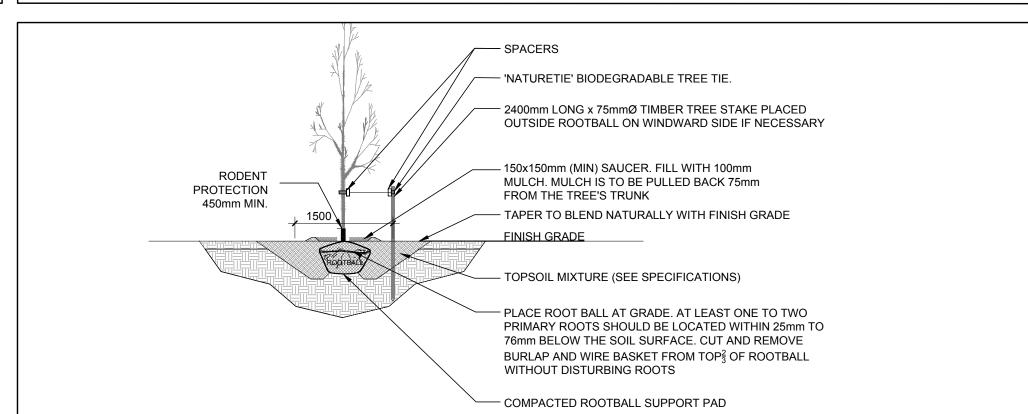


# DECIDUOUS TREE PLANTING

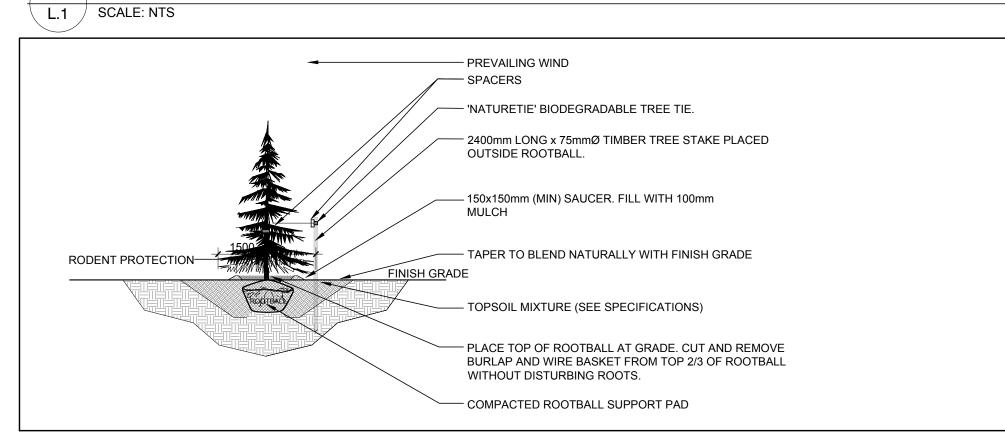


3 CONIFEROUS TREE PLANTING

L.1 SCALE: NTS

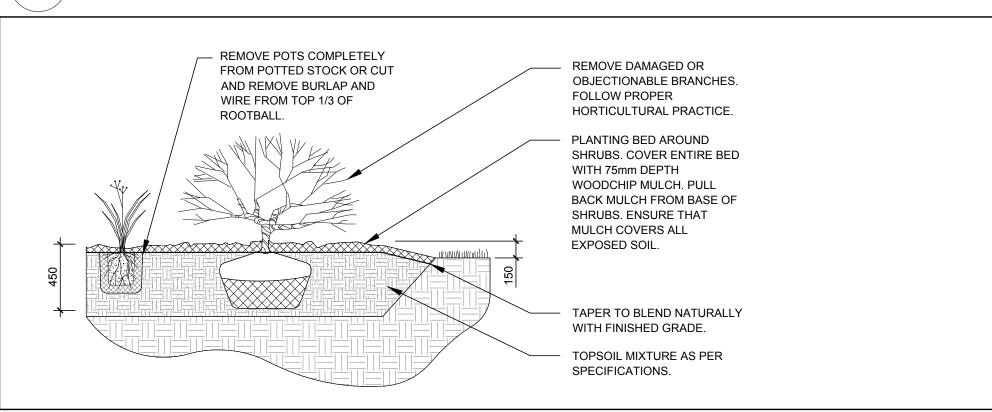

PROPOSED SHRUB / ORNAMENTAL GRASS PLANTING

L.1 / SCALE: NTS

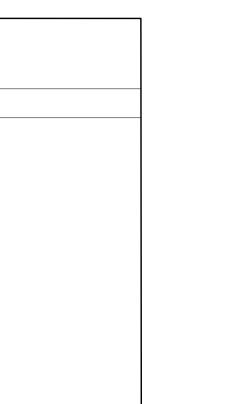



768, BOUL. SAINT-JOSEPH, SUITE 100 GATINEAU, QC J8Y 4B8

ARCHITECTURAL

53, BOUL. SAINT-RAYMOND, GATINEAU, QC J8Y 1R8

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3070, CHEMIN DES QUATRE-BOURGEOIS QUÉBEC (QC) G1W 2K4

ENGINEERS / PLANNER



1565 CARLING AVENUE, SUITE 700, OTTAWA, ON K1Z 8R1



1331 CLYDE AVENUE, SUITE 400, OTTAWA, ON K2C 3G4



 40 YEAR CANOPY PROJECTION PROPOSED DECIDUOUS TREE

- REQUIRED SOIL VOLUME (25m3)



— 40 YEAR CANOPY PROJECTION PROPOSED CONIFEROUS TREE - REQUIRED SOIL VOLUME (30m3)



PROPOSED SHRUBS / ORNAMENTAL



PROPOSED SOD



PROPOSED RIVERSTONE

4	NOTE REVISED RE: TREE PLANTING	03/04/2024	ML	JL
3	REVISED PER CITY COMMENTS	03/01/2024	ML	JL
2	REVISED PER CITY COMMENTS	02/26/2024	ML	JL
1	ISSUED FOR SITE PLAN CONTROL	12/15/2023	ML	JL
No.	Issue	Date	DR	Cł

4.5m SETBACK

JAMES B. LENNOX & ASSOCIATES INC. **ARCHITECTS** LANDSCAPE OTTAWA, ONTARIO 3332 CARLING AVE. K2H 5A8 Tel. (613) 722-5168 Fax. 1(866) 343-3942

PROJECT NAVAN ROAD DEVELOPMENT- BUILDINGS "A"

NAVAN ROAD, ORLEANS ON


LANDSCAPE PLAN



SCALE AS SHOWN TART DATE NOVEMBER 2023

PROJECT NO.

PROJECT NORTH DRAWING NO.

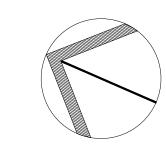

LOT SIZE ARCH-D

