

ZONING RULE	REQUIREMENT	PROVIDED
Minimum lot area	No minimum	3,109.10m²
Minimum lot width	No minimum	42.45m on George Street. 40.40 on back portion.
Minimum front yard	No minimum, 1m maximum.	0.72m on George Street
Minimum interior side yard	No minimum	0.70m on West side of build 1,94m on East side of buildi
Minimum rear yard	No minimum	6.29m to one storey volume 5.47m to 4th to 17th floor ov
Maximum building height	70m as per Schedule 307. No projections permitted beyond building height.	70m all inclusive.
Maximum floor space index	Not applicable	Not applicable
Minimum width of andscape area	No miminum except that where a yard is provided and not used for required driveways, aisles, parking, loading spaces, or outdoor commercial patio, the whole yard must be landscaped	Whole yard to be landscape
Provisions for puildings 10 storeys and higher	Minimum lot area for an interior lot: 1350m ^{2.}	Minimum lot area met.
(By-law 2019-353)	Minimum interior side and rear yard setback for a tower: 7.5m	Site Plan Approval received
	Minimum separation distance between towers on the same lot: 15m.	Not applicable.
Parking Garage permission	100% of ground floor fronting a street (excluding mechanical room, pedestrian and vehicular access) for a minimumm depth of 3m, must be occupied by permitted use	100% of ground fronting Ge minimumm depth of 3m, is o permitted Commercial use a
Ground floor use	100% of ground floor fronting a street (excluding lobby area, mechanical room and access to other floors) for a minimumm depth of 3m, must be occupied by select uses.	100% of ground fronting Ge a minimumm depth of 3m, is permitted Commercial use.
	Total gross area of lobbies, mechanical rooms and access to other floors must not exceed 50% of ground floor gross area.	Total gross area of lobbies, rooms and access to other f exceed 50% of ground floor
	Min. 50% of ground floor to be occupied by permitted use subject to a separate and direct access to abutting	Area of permitted Commerc 50% of gross floor area and direct access to George Stre

AMENITY AND PARKING REQUIREMENTS ZONING - MD2 (2031) S307

	(PARKING COMBINED WITH FUT	NG - MD2 (2031) S307 'URE 110 & 116 York S1	REET DEVELOPMENT)	
IING MECHANISM	REGULATION	ORIGINAL PROPOSAL 1 STOREY PARKING (DEC 7, 2012)	PROPOSED 5 STOREY PARKING (JUN 6, 2023)	NEWLY PROPOSED (3 STOREY) (JULY 2024)
dential Parking GEORGE & 116 YORK	None Required 6m drive aisle required.	Hotel & Condos 5 exterior 225 interior	P226 spacesP351 spacesP452 spacesP552 spaces	P26 spacesP337 spaces6.0m drive aisle provided.P341 spaces
or Parking GEORGE	Residential Area Z (By-law 2016-249); no more than 30 visitor spaces are required per building. Exception #2031; 0.083 spaces x 297 units = 25 visitor parking spaces 6m drive aisle required.		P1 2 spaces P2 23 spaces	P2 25 spaces 6.0m drive aisle provided.
mercial Parking GEORGE	None Required 6.7m drive aisle required.		P1 5 spaces.	P1 5 spaces 6.0m drive aisle provided.
I Parking GEORGE & 116 YORK	None Required 6m drive aisle required.		P1 25 spaces	P1 21 spaces P2 8 spaces 6.0m drive aisle provided.
				P1 24 spaces P2 41 spaces
		Total: 230 spaces	Total: 246 spaces	Total: 208 spaces 141 George 102 spaces 110 York 106 spaces
er-Free Parking GEORGE & 116 YORK	Requires 1 barrier-free spaces (Traffic and Parking By-Law 2017-301)		P1 to P5 2 spaces per floor Total 10 spaces	P21 spaceP31 spaceP11 spaceP21 spaceTotal:4 spaces
num Bicycle Parking GEORGE	Residential: 0.5 spaces x 297 units = 149 bicycle parking spaces Retail: 1 space per 250m² of GFA 468m² GFA / 250m² = 2 bicycle parking spaces	Condo 141 interior	Residential: 16 (P1) (Indoor) 64 (P2) 66 (P3) Retail : 5 (Exterior)	Residential: 86 (P1) 42 (P2) 46 (P3) Retail : 5 (Exterior) Total 179 spaces
& 116 YORK	Hotel: 1 per 1000m ² of GFA +/-6,800m ² GFA/1,000m ² = 7 bicycle parking spaces Minimum 50% to be horizontal racks.	Hotel 7 exterior Total: 148 spaces	Total: 151 spaces	Hotel 10 (Interior) Total: 189 spaces
mum parking	 1.5 per dwelling unit Limited to 446 space for 297 units. (combined with visitor) 1 per 100m² of Commercial gross area. Limited to 5 spaces. 		Total parking spaces is under the limit. Commercial parking spaces maximized.	75 (40%) vertical mount. Total parking spaces is under the limit. Commercial parking spaces maximized.
num driveway width	6m		6m	6m
num aisle width	6m		6m	6m
ling	Exception #2031; None Required.		NA	NA
nities Areas	Amenity Area - 6m ² per unit = 297 units x 6m ² = 1,782m ² Communal Amenity Area : Exception #2031; minimum 40% off the required total Amenity Area = 1,782m ² x 0.4 = minimum 713m ² Layout of Communal Amenity Area - aggregated into areas up to 54m ²		Total Balconies = $1,555m^2$ Ground = $35m^2$ $2nd = 59m^2$ $3rd = 89m^2$ $4th$ to $17th = 75m^2$ / floor $18th = 77m^2$ $19th = 85m^2$ $20th = 75m^2$ $21st = 85m^2$ Total Communal = $729m^2$ Ground floor = $220m^2$ $2nd = 195m^2$ $21st = 341m^2$ Total = $2,284m^2$	Total Balconies = $1,734m^2$ Ground = $7m^2$ $2^{nd} = 110m^2$ $3^{rd} = 113m^2$ $4^{th} = 95m^2$ 5^{th} to $17^{th} = 82m^2/$ floor $18^{th} = 80m^2$ $19^{th} = 97m^2$ $20^{th} = 84m^2$ $21^{st} = 82m^2$ Total Communal = $773m^2$ Ground floor = $432m^2$ $22nd = 341m^2$ Total = $2,507m^2$

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Structural Engineer **Goodeve Structural Inc.** 18-77 Auriga Drive, Ottawa ON K2E 7Z7 T 613 226 4558 goodevestructural.ca

Landscape Architect James B. Lennox & Associates 3332, Carling Avenue, Ottawa, ON, K2H 5A8 T 613 722 5168 jbla.ca


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Seal

Architect





Client

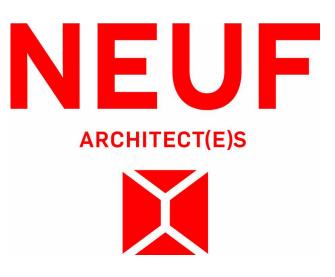

141 GEORGE STREET

Location OTTAWA No. 12810

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DD	FOR COORDINATION	2023.11.02
FF	FOR COORDINATION	2023.11.13
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LL	FOR COORDINATION	2023.12.15
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RR	FOR COORDINATION	2024.02.26
VV	RE-ISSUED FOR PERMIT	2024.04.16
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ZZ	RE-ISSUED FOR SITE PLAN APPROVAL	2024.05.16
CCC	FOR TENDER	2024.05.23
FFF	FOR REVISED FOUNDATION PERM	/IT 2024.07.03
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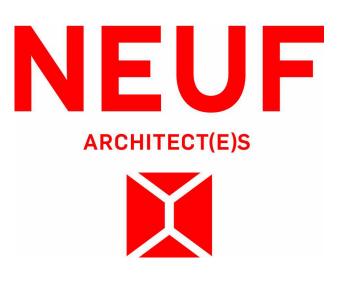
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141 GEORGE STREET

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Project

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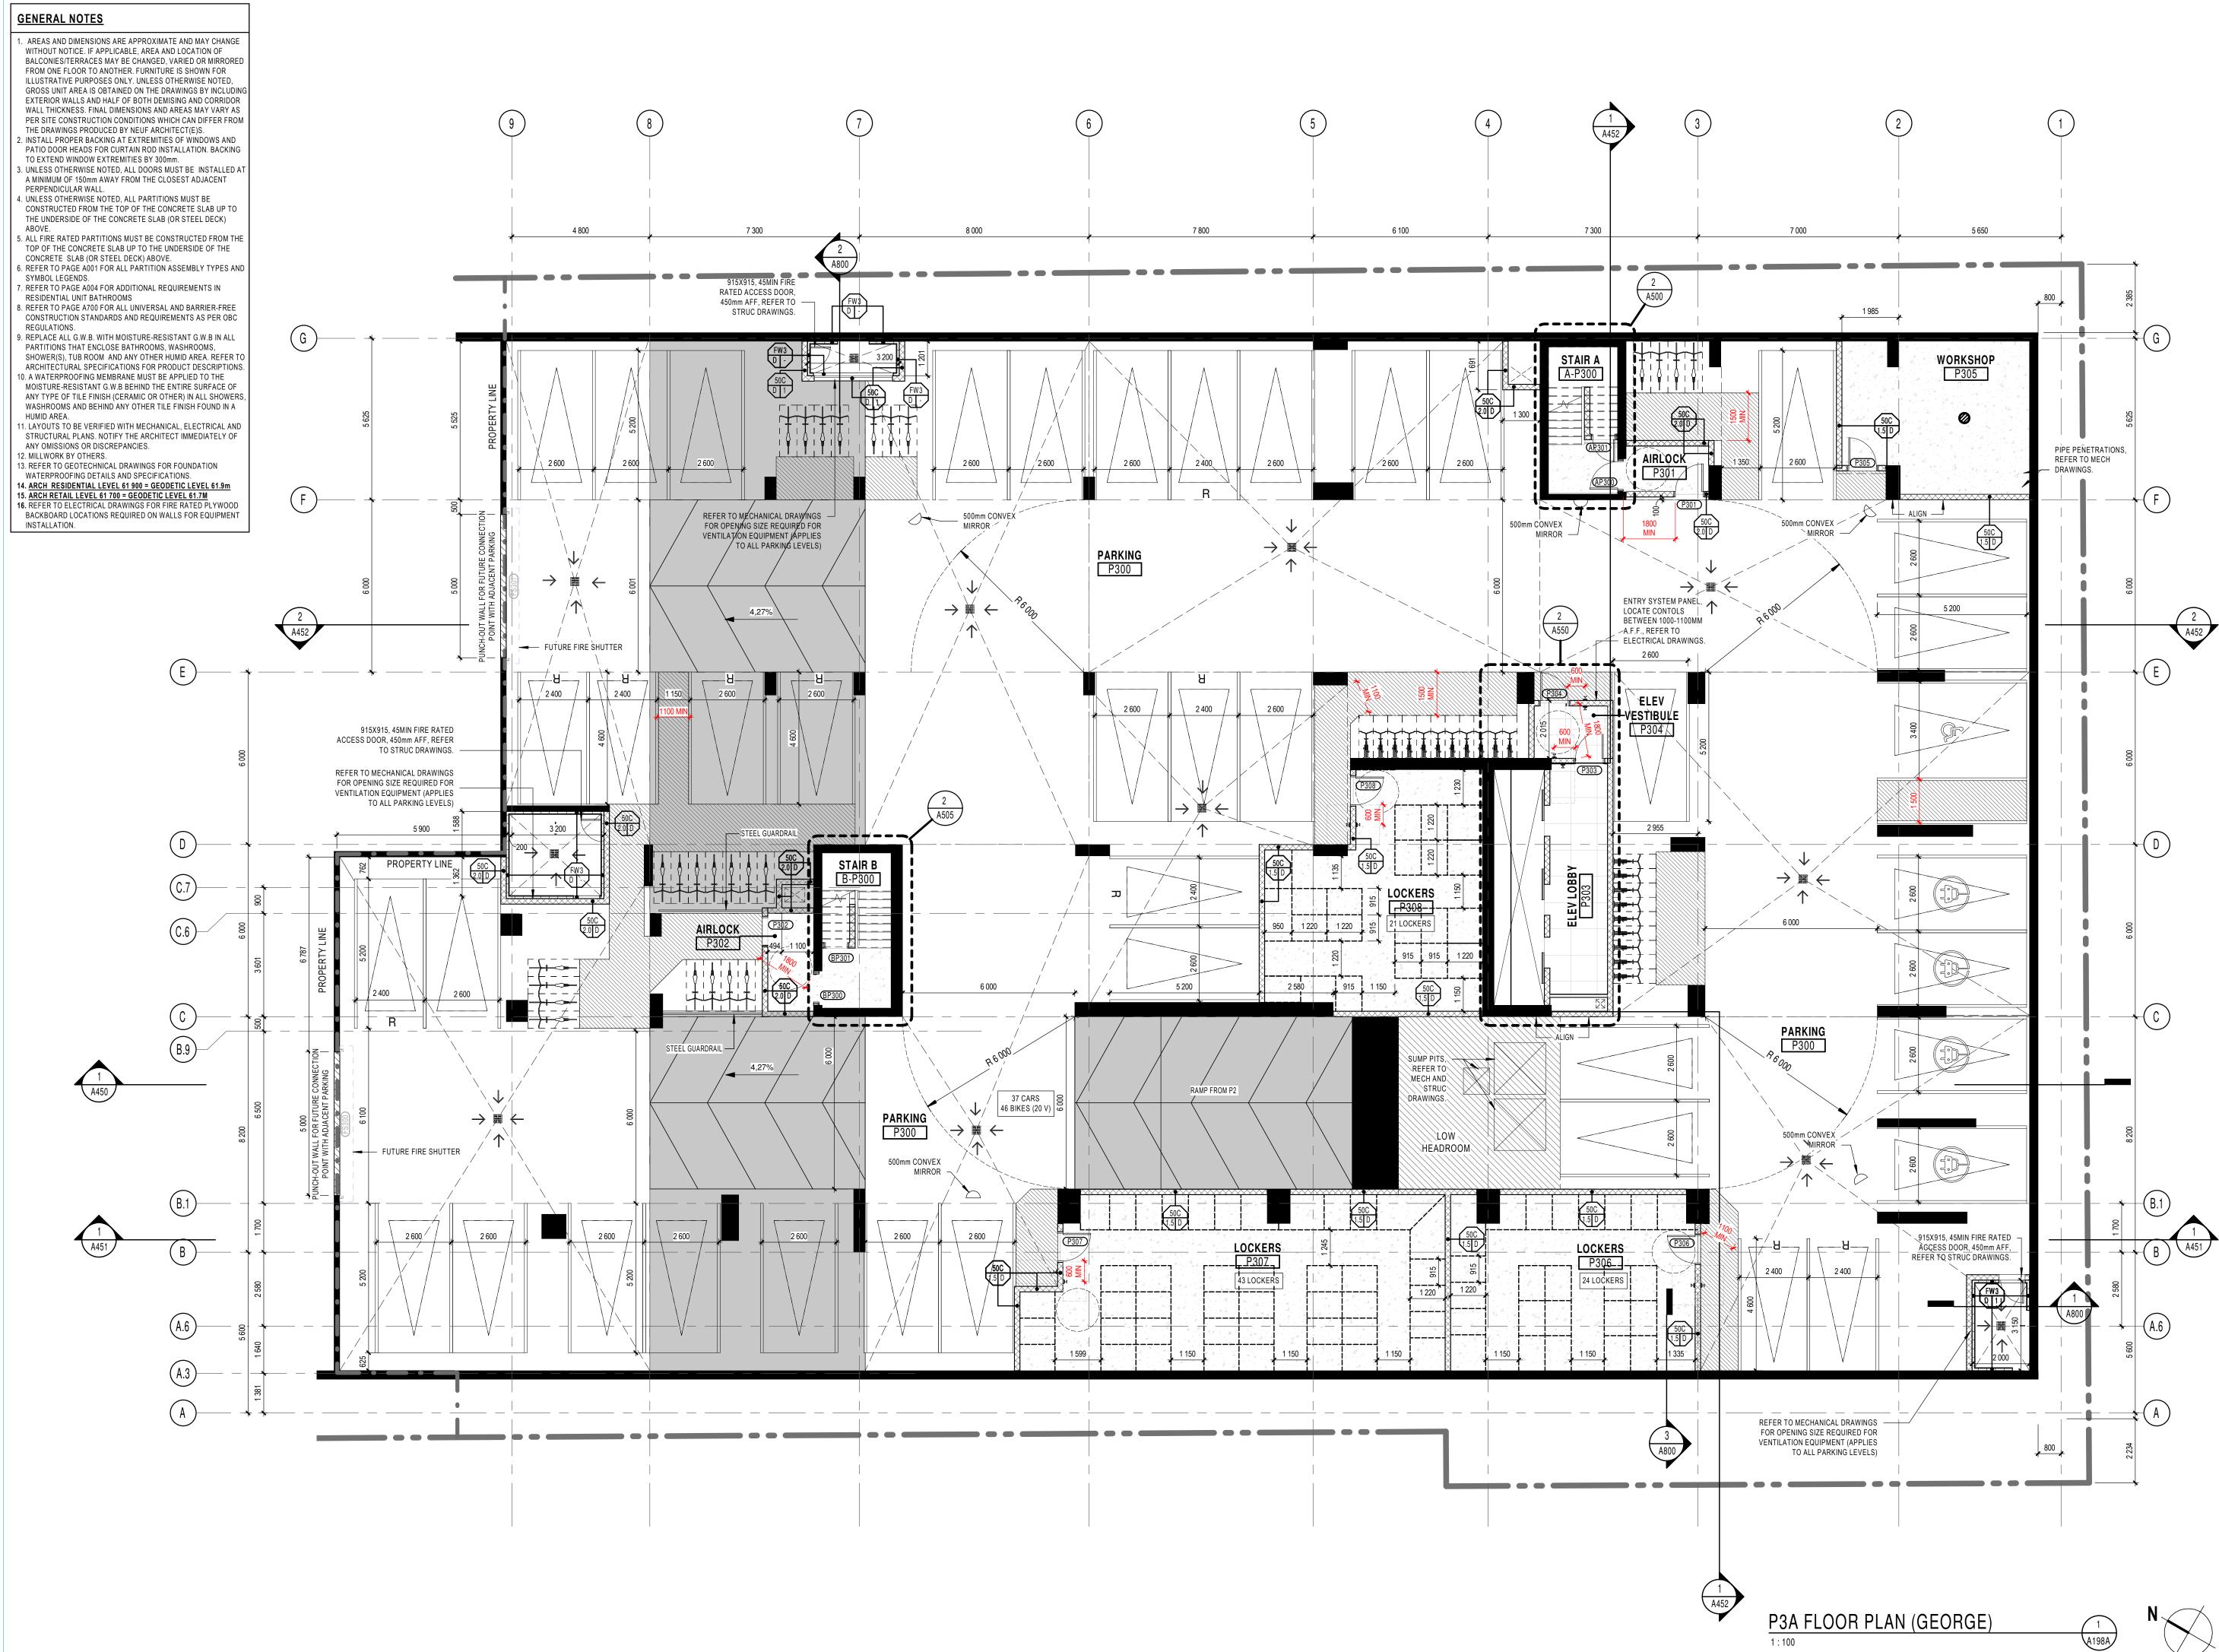
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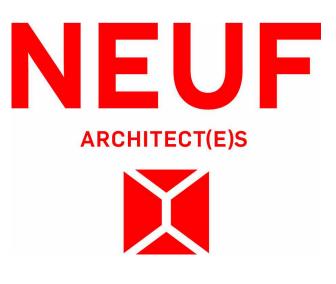
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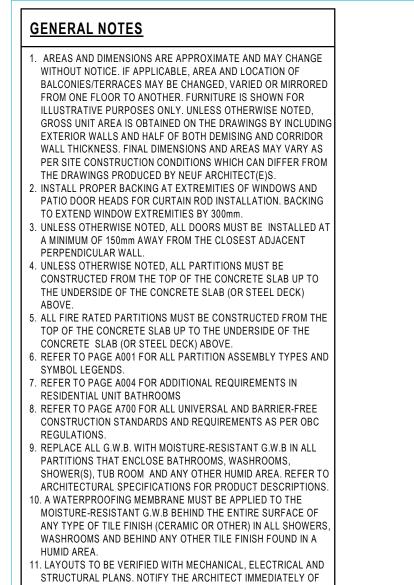
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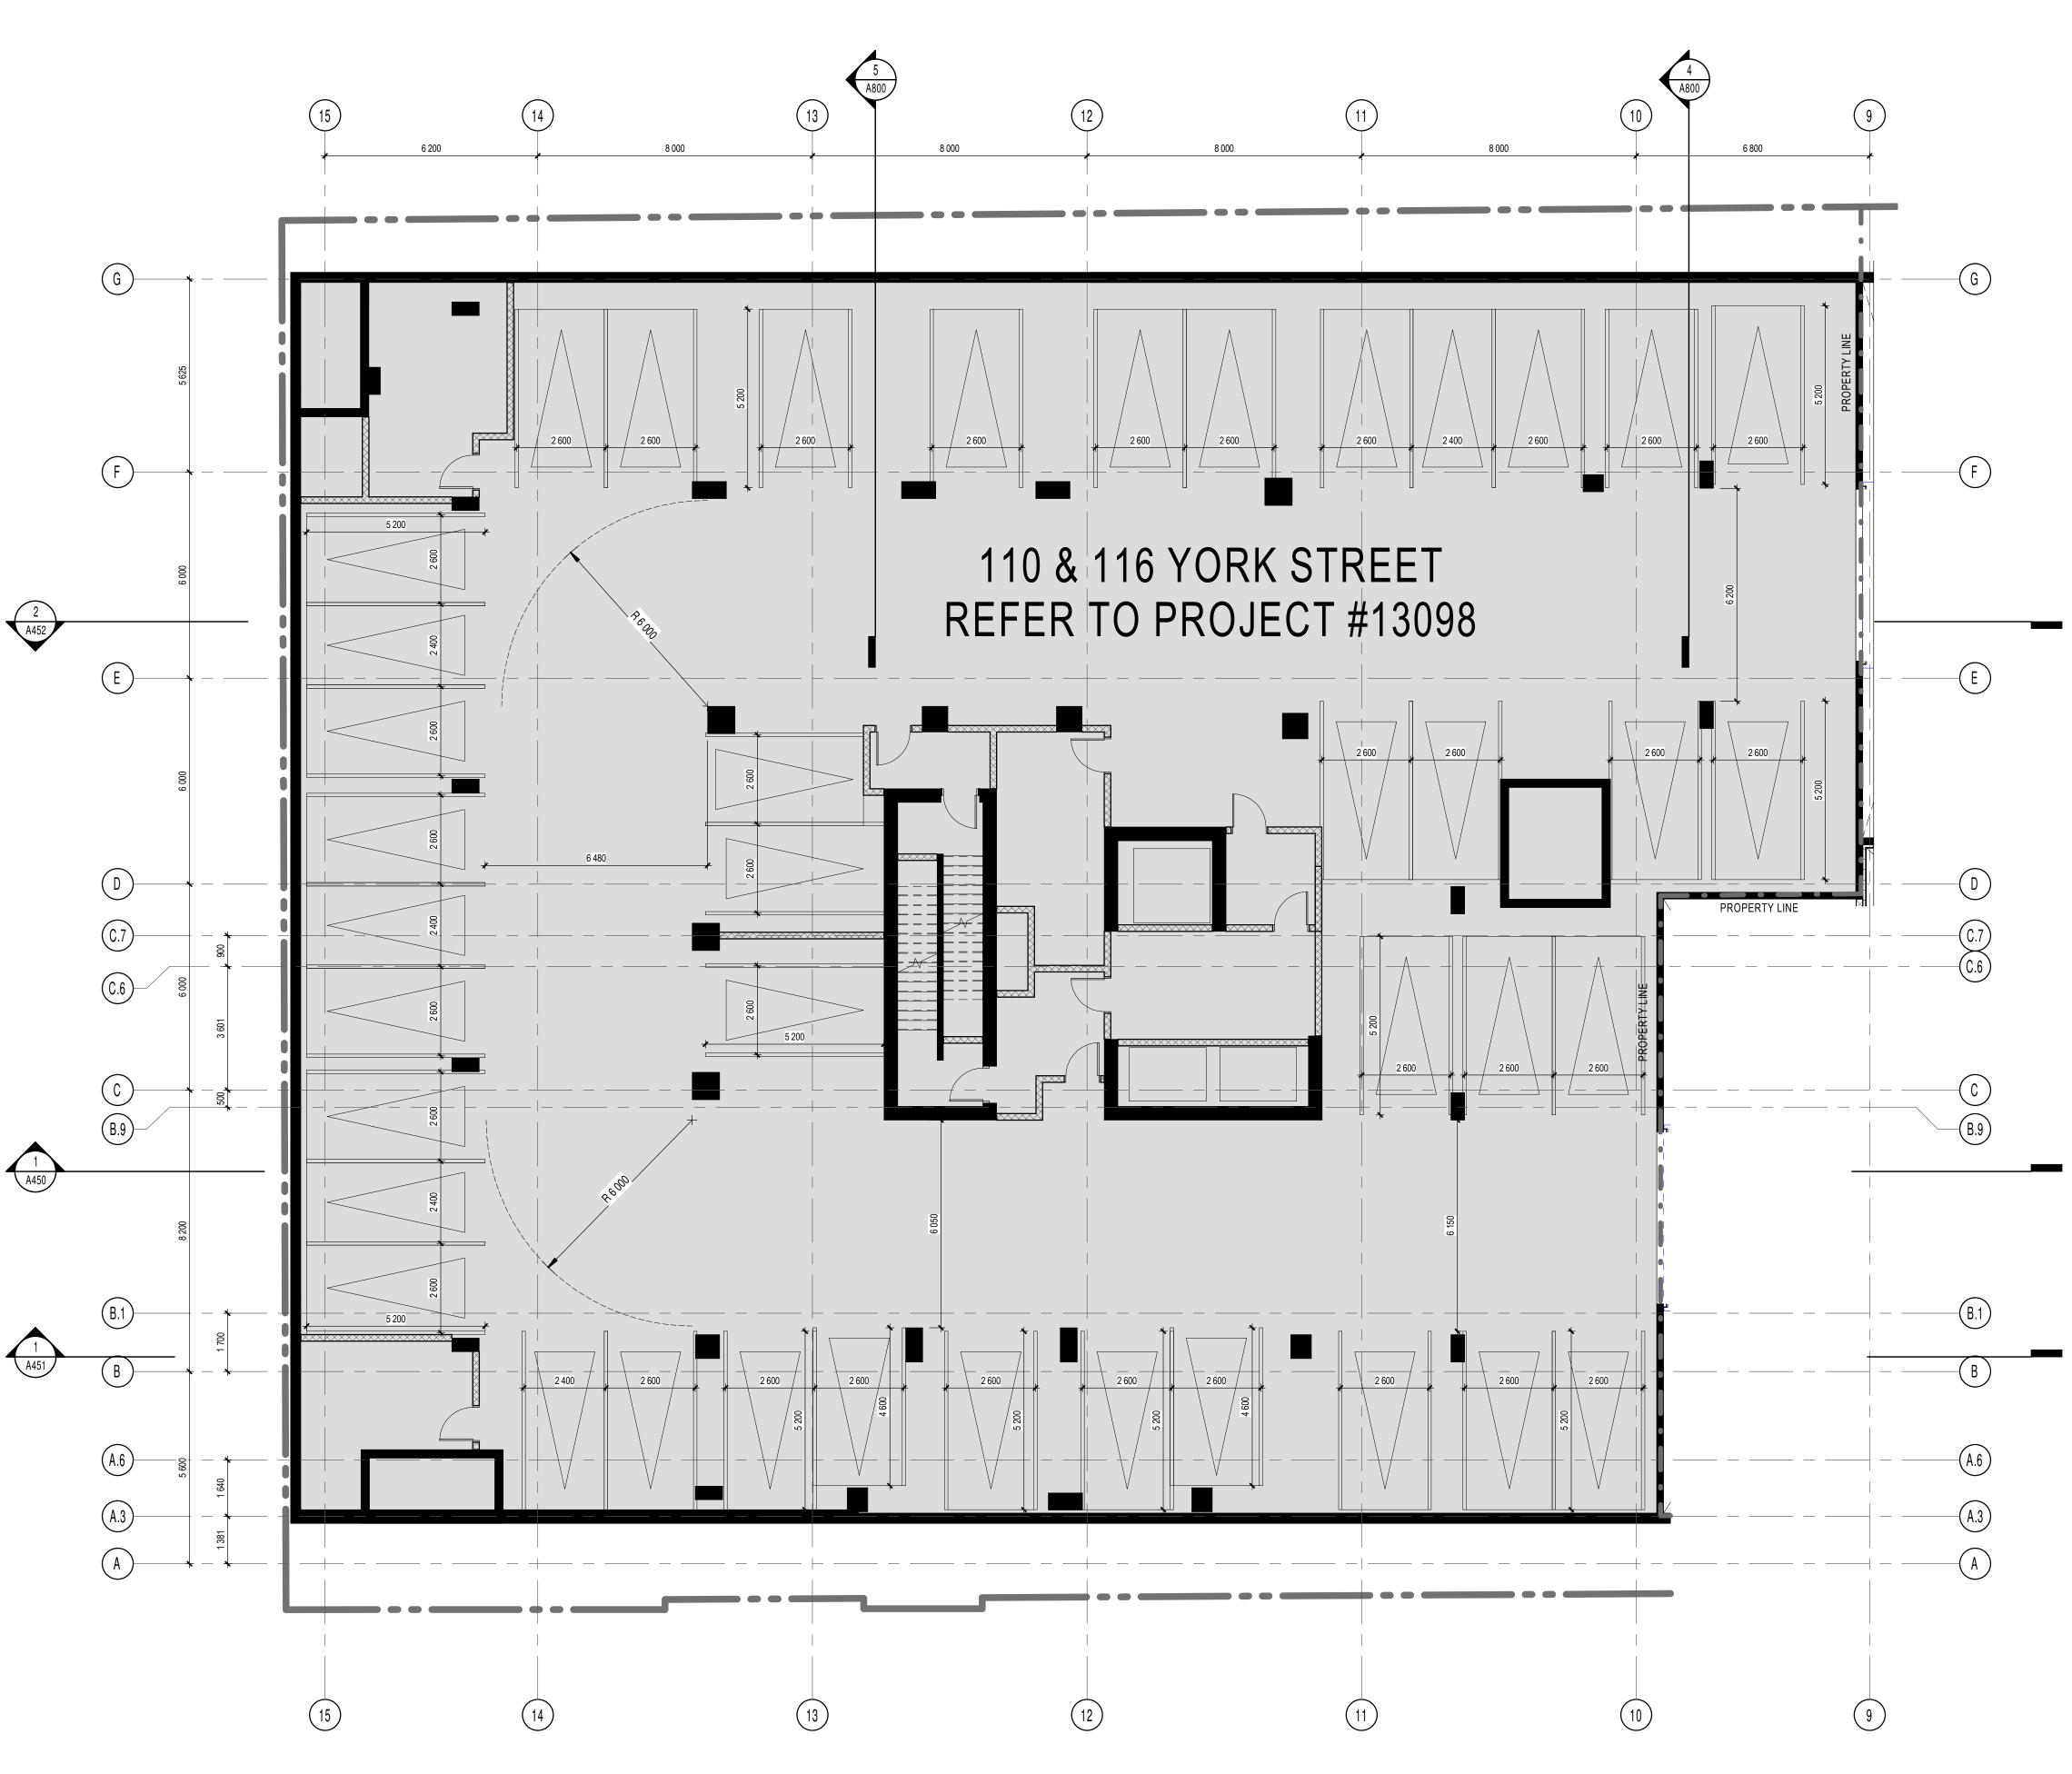
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14. ARCH RESIDENTIAL LEVEL 61 900 = GEODETIC LEVEL 61.9m 15. ARCH RETAIL LEVEL 61 700 = GEODETIC LEVEL 61.7M

16. REFER TO ELECTRICAL DRAWINGS FOR FIRE RATED PLYWOOD BACKBOARD LOCATIONS REQUIRED ON WALLS FOR EQUIPMENT

12. MILLWORK BY OTHERS.

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P3B FLOOR PLAN (YORK)





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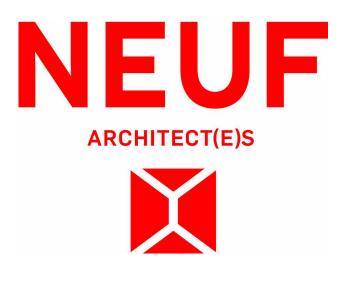
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Seal





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141 GEORGE STREET

Location OTTAWA

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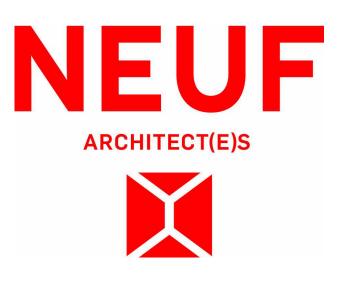
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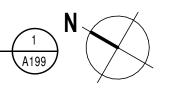
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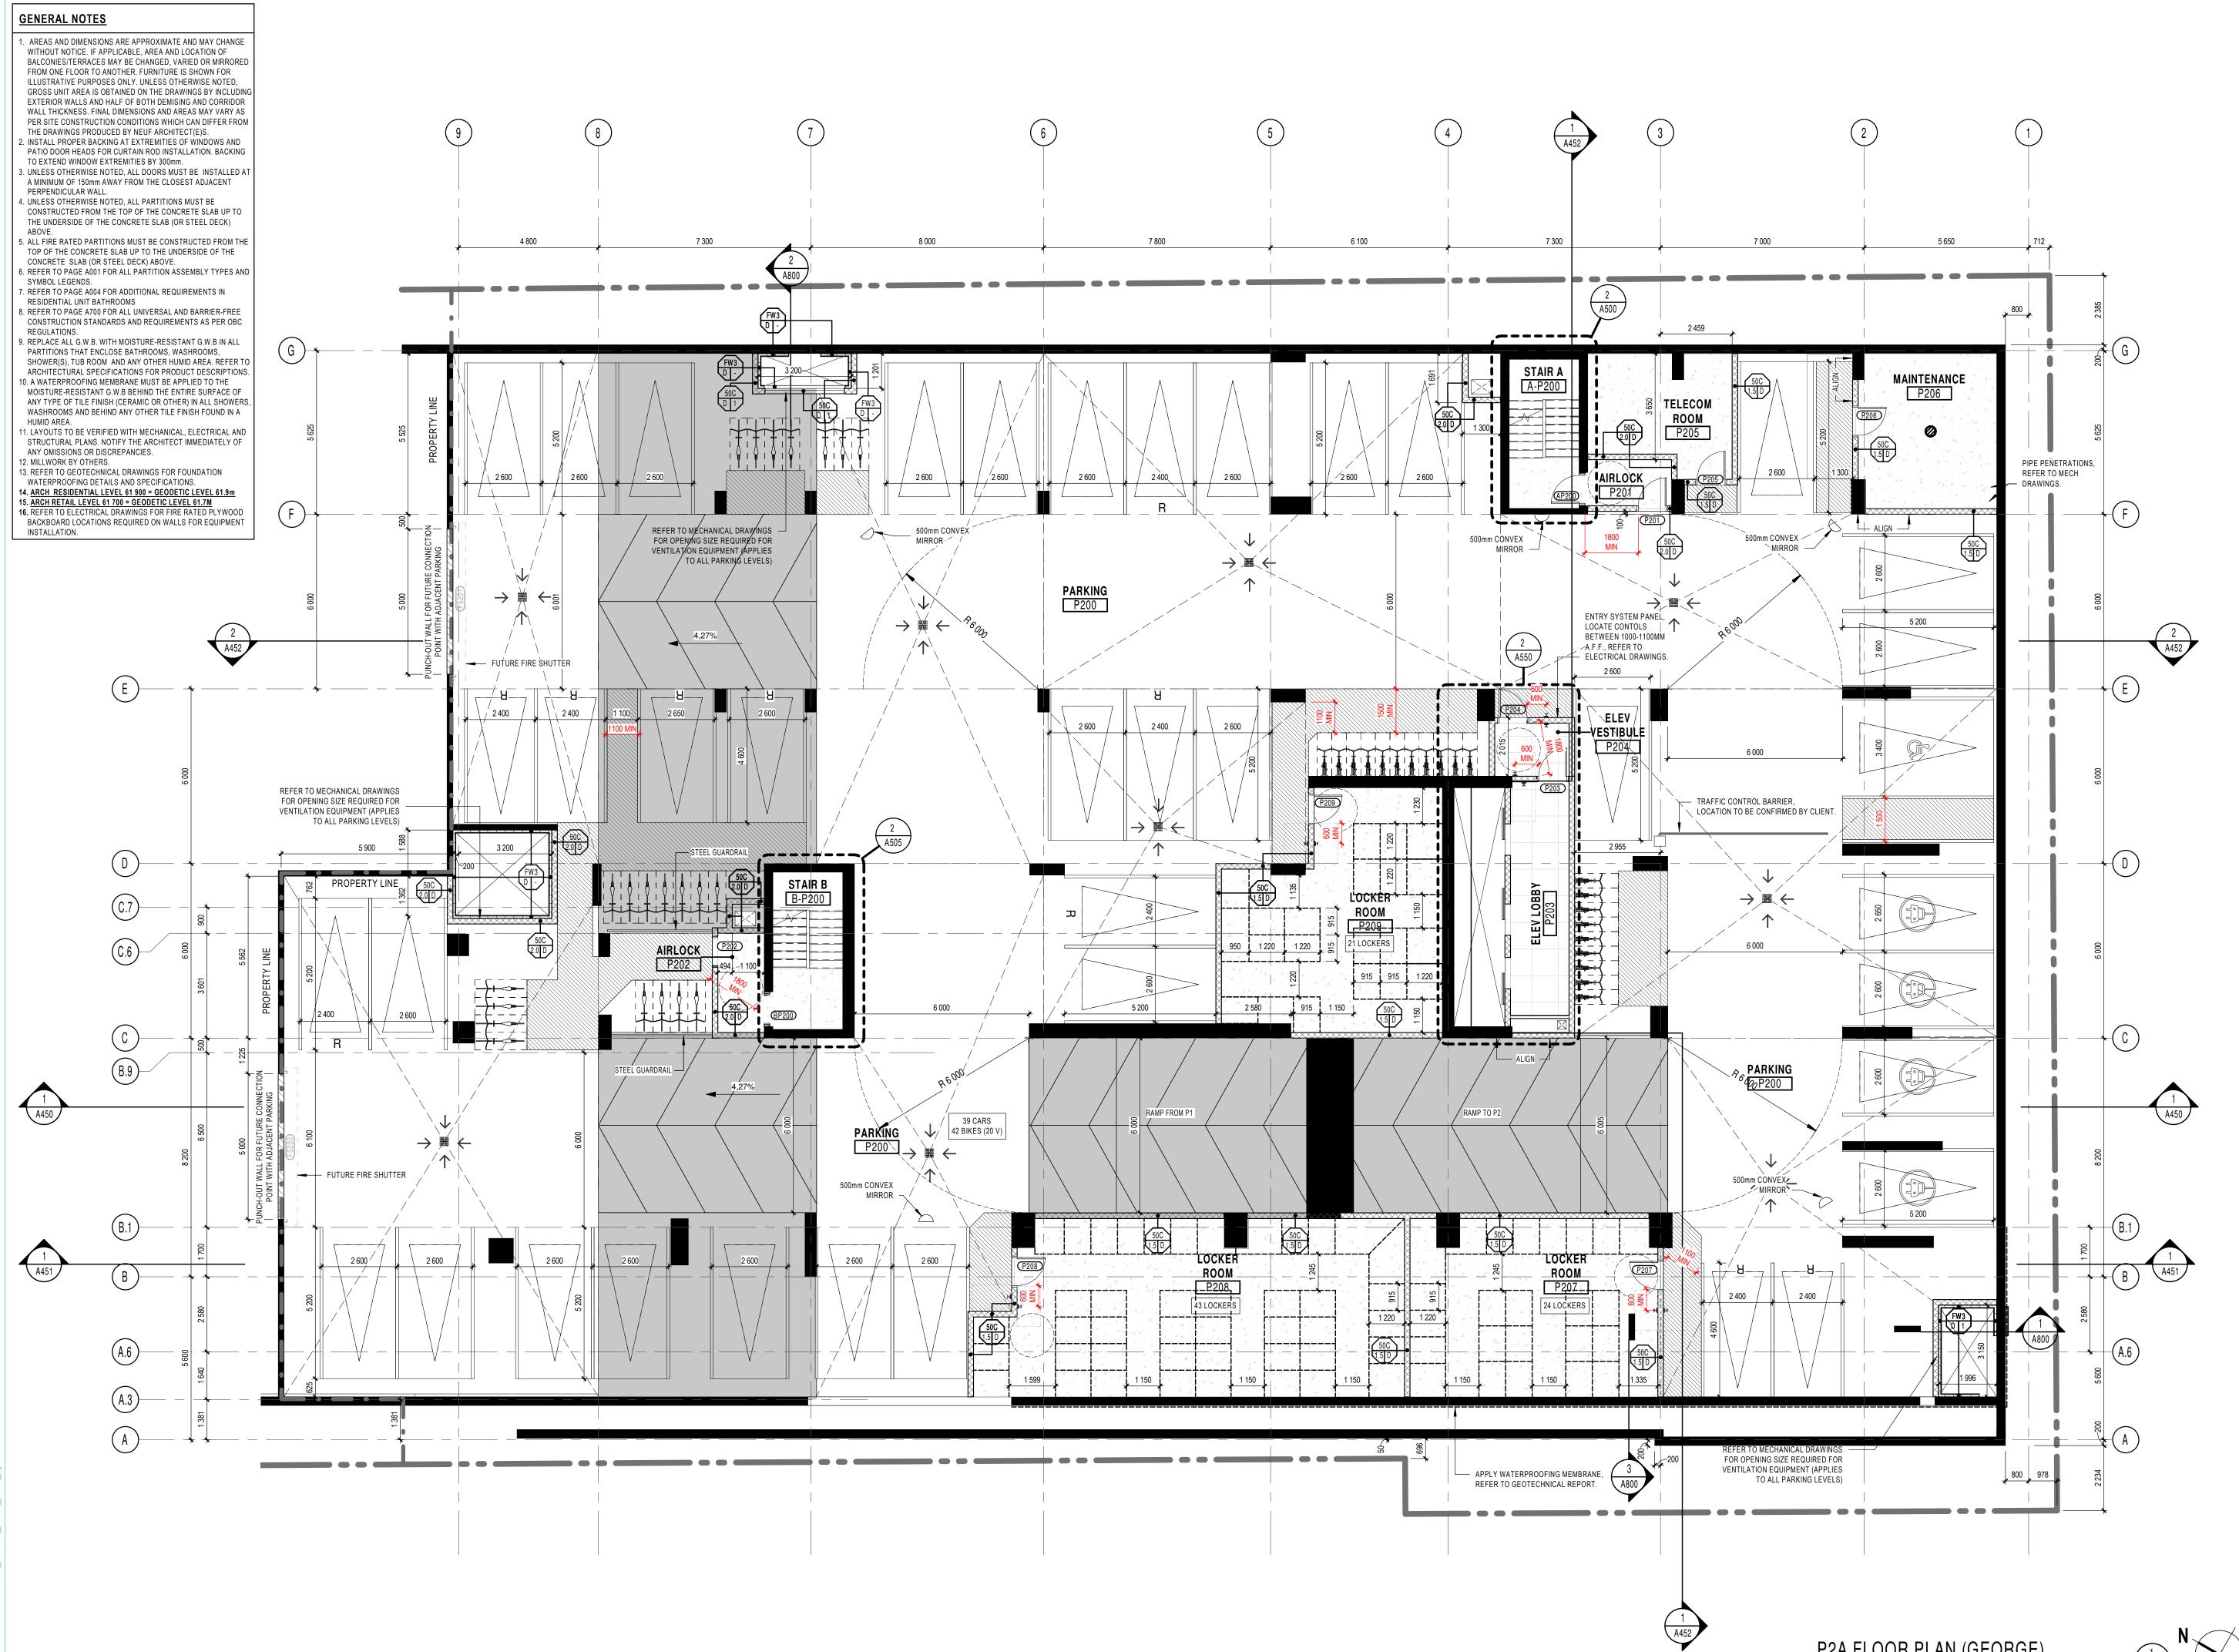
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P2A FLOOR PLAN (GEORGE)

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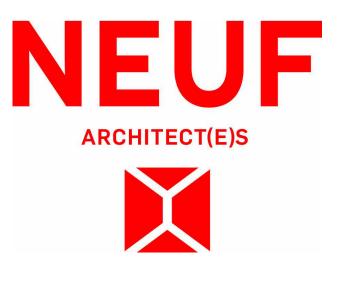
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Architect

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141 GEORGE STREET

Location OTTAWA


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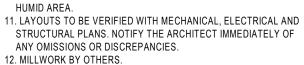
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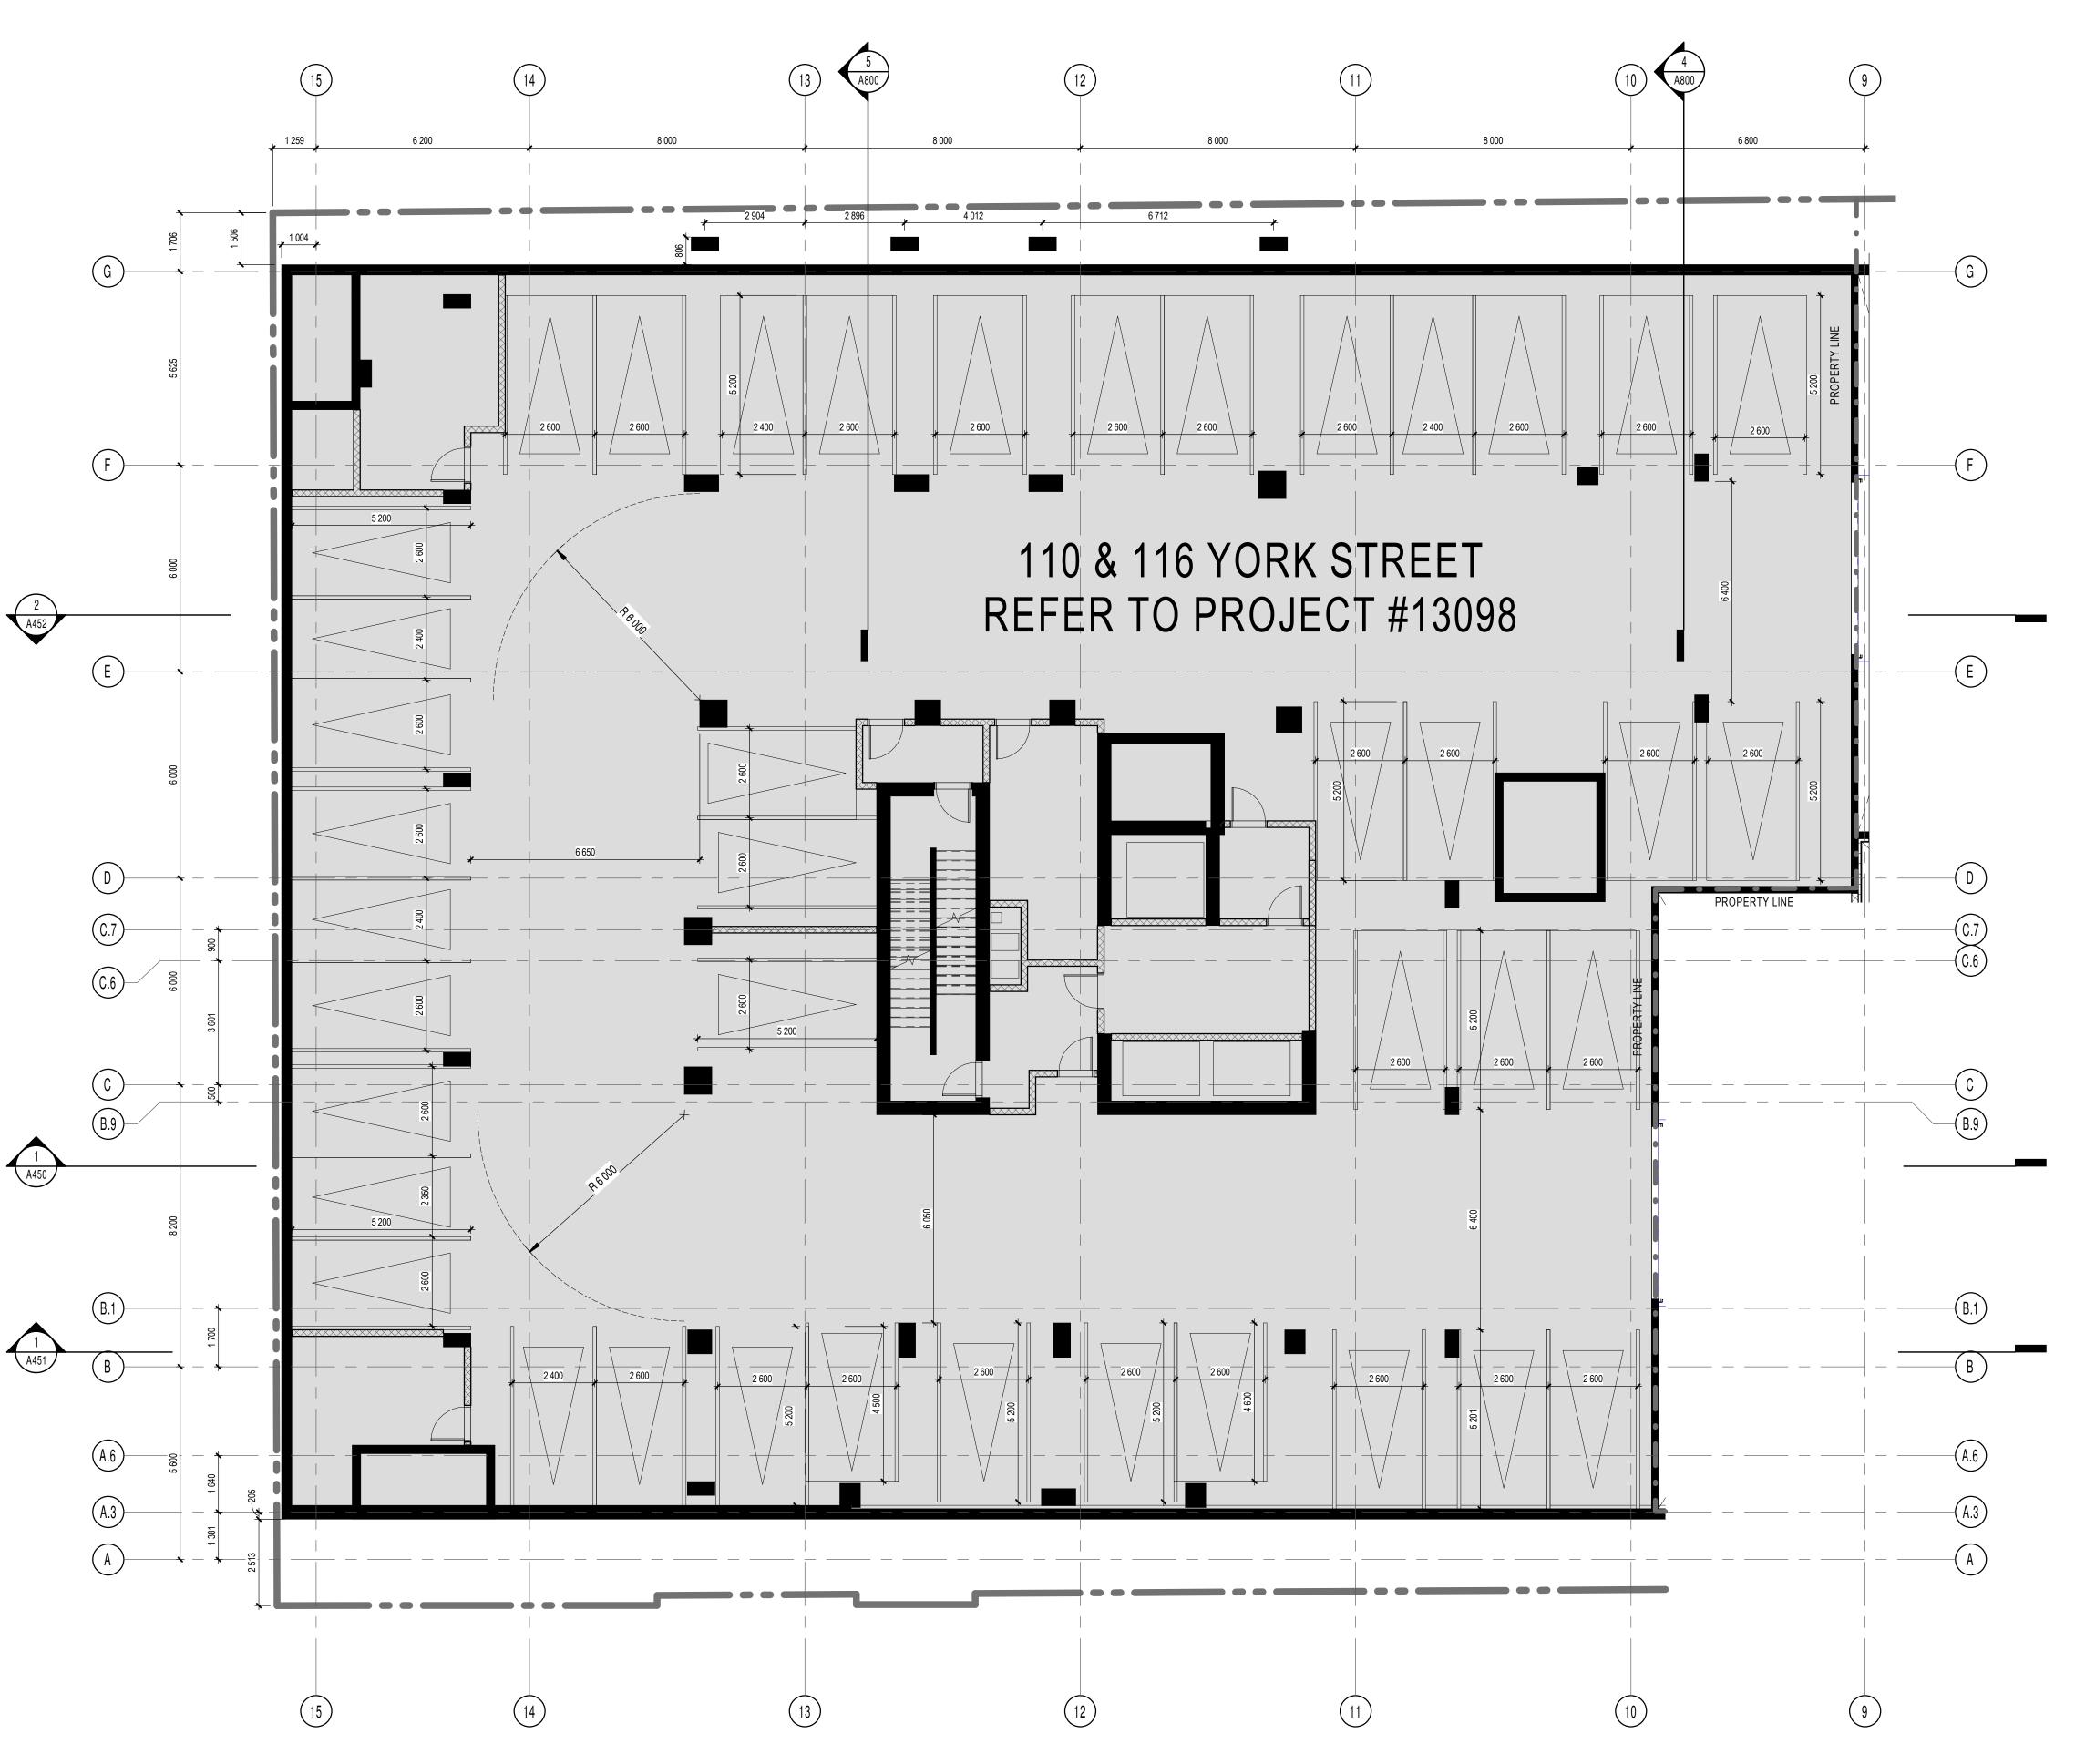
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- BACKBOARD LOCATIONS REQUIRED ON WALLS FOR EQUIPMENT INSTALLATION.



P2B FLOOR PLAN (YORK)



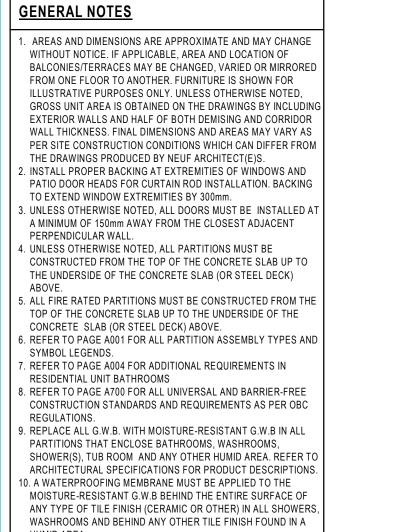

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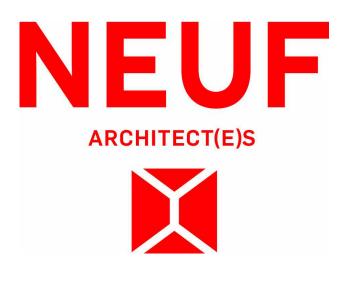
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Architect

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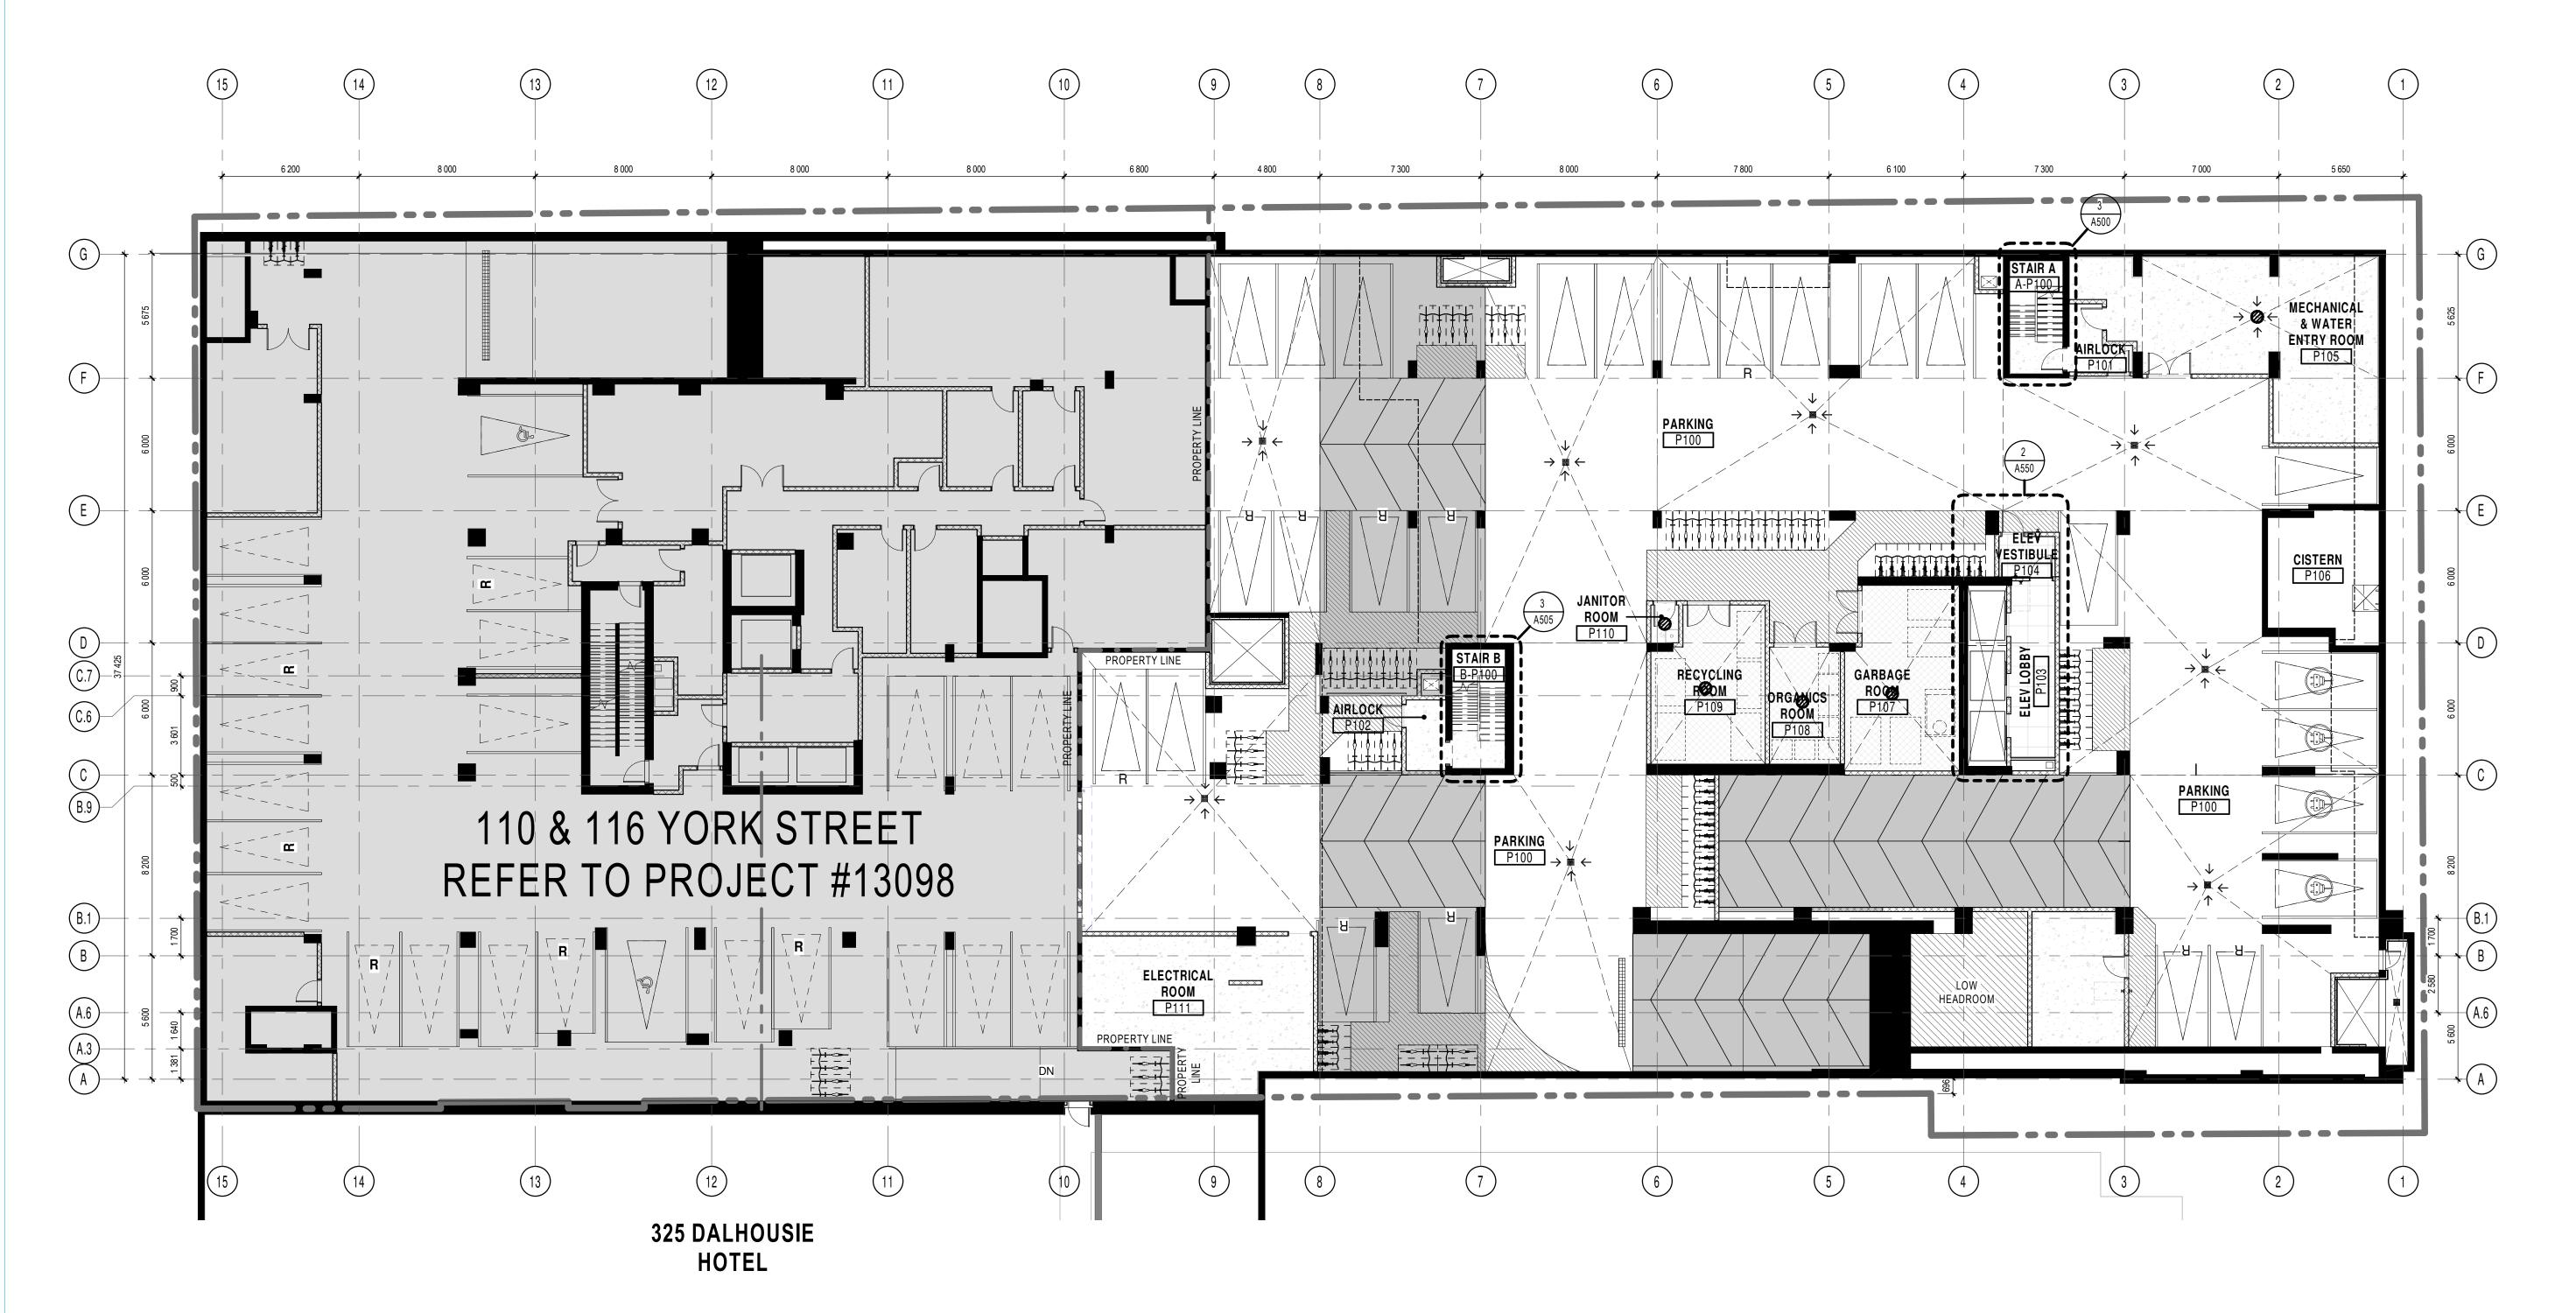


141 GEORGE STREET

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III	SITE PLAN REVISION RESPONSE	2024.08.26

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Structural Engineer **Goodeve Structural Inc.** 18-77 Auriga Drive, Ottawa ON K2E 7Z7 T 613 226 4558 goodevestructural.ca


Landscape Architect James B. Lennox & Associates 3332, Carling Avenue, Ottawa, ON, K2H 5A8 T 613 722 5168 jbla.ca

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Architect **NEUF Architectes INC.** 10 Rideau Street, 4th floor, Ottawa ON K1N 9J1 T 514 847 1117 NEUFarchitectes.com







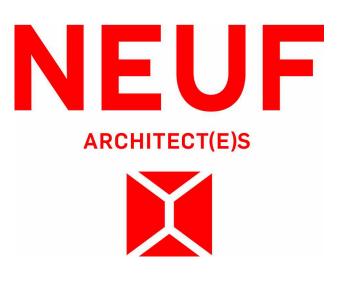

141 GEORGE STREET

Location OTTAWA

Client


No. 12810

NO	REVISION	DATE (yyyy.mm.dd)
TT	FOR COORDINATION	2024.04.04
WW	FOR COORDINATION	2024.05.02
ΧХ	FOR COORDINATION	2024.05.09
ΥY	FOR COORDINATION	2024.05.14
ZZ	RE-ISSUED FOR SITE PLAN	2024.05.16
	APPROVAL	
AAA	FOR COORDINATION	2024.05.21
CCC	FOR TENDER	2024.05.23
FFF	FOR REVISED FOUNDATION PER	MIT 2024.07.03
GGG	FOR TENDER - ADDENDUM 02	2024.07.09
III	SITE PLAN REVISION RESPONSE	2024.08.26





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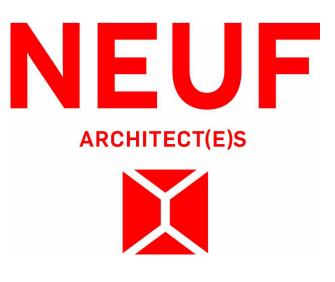
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141 GEORGE STREET

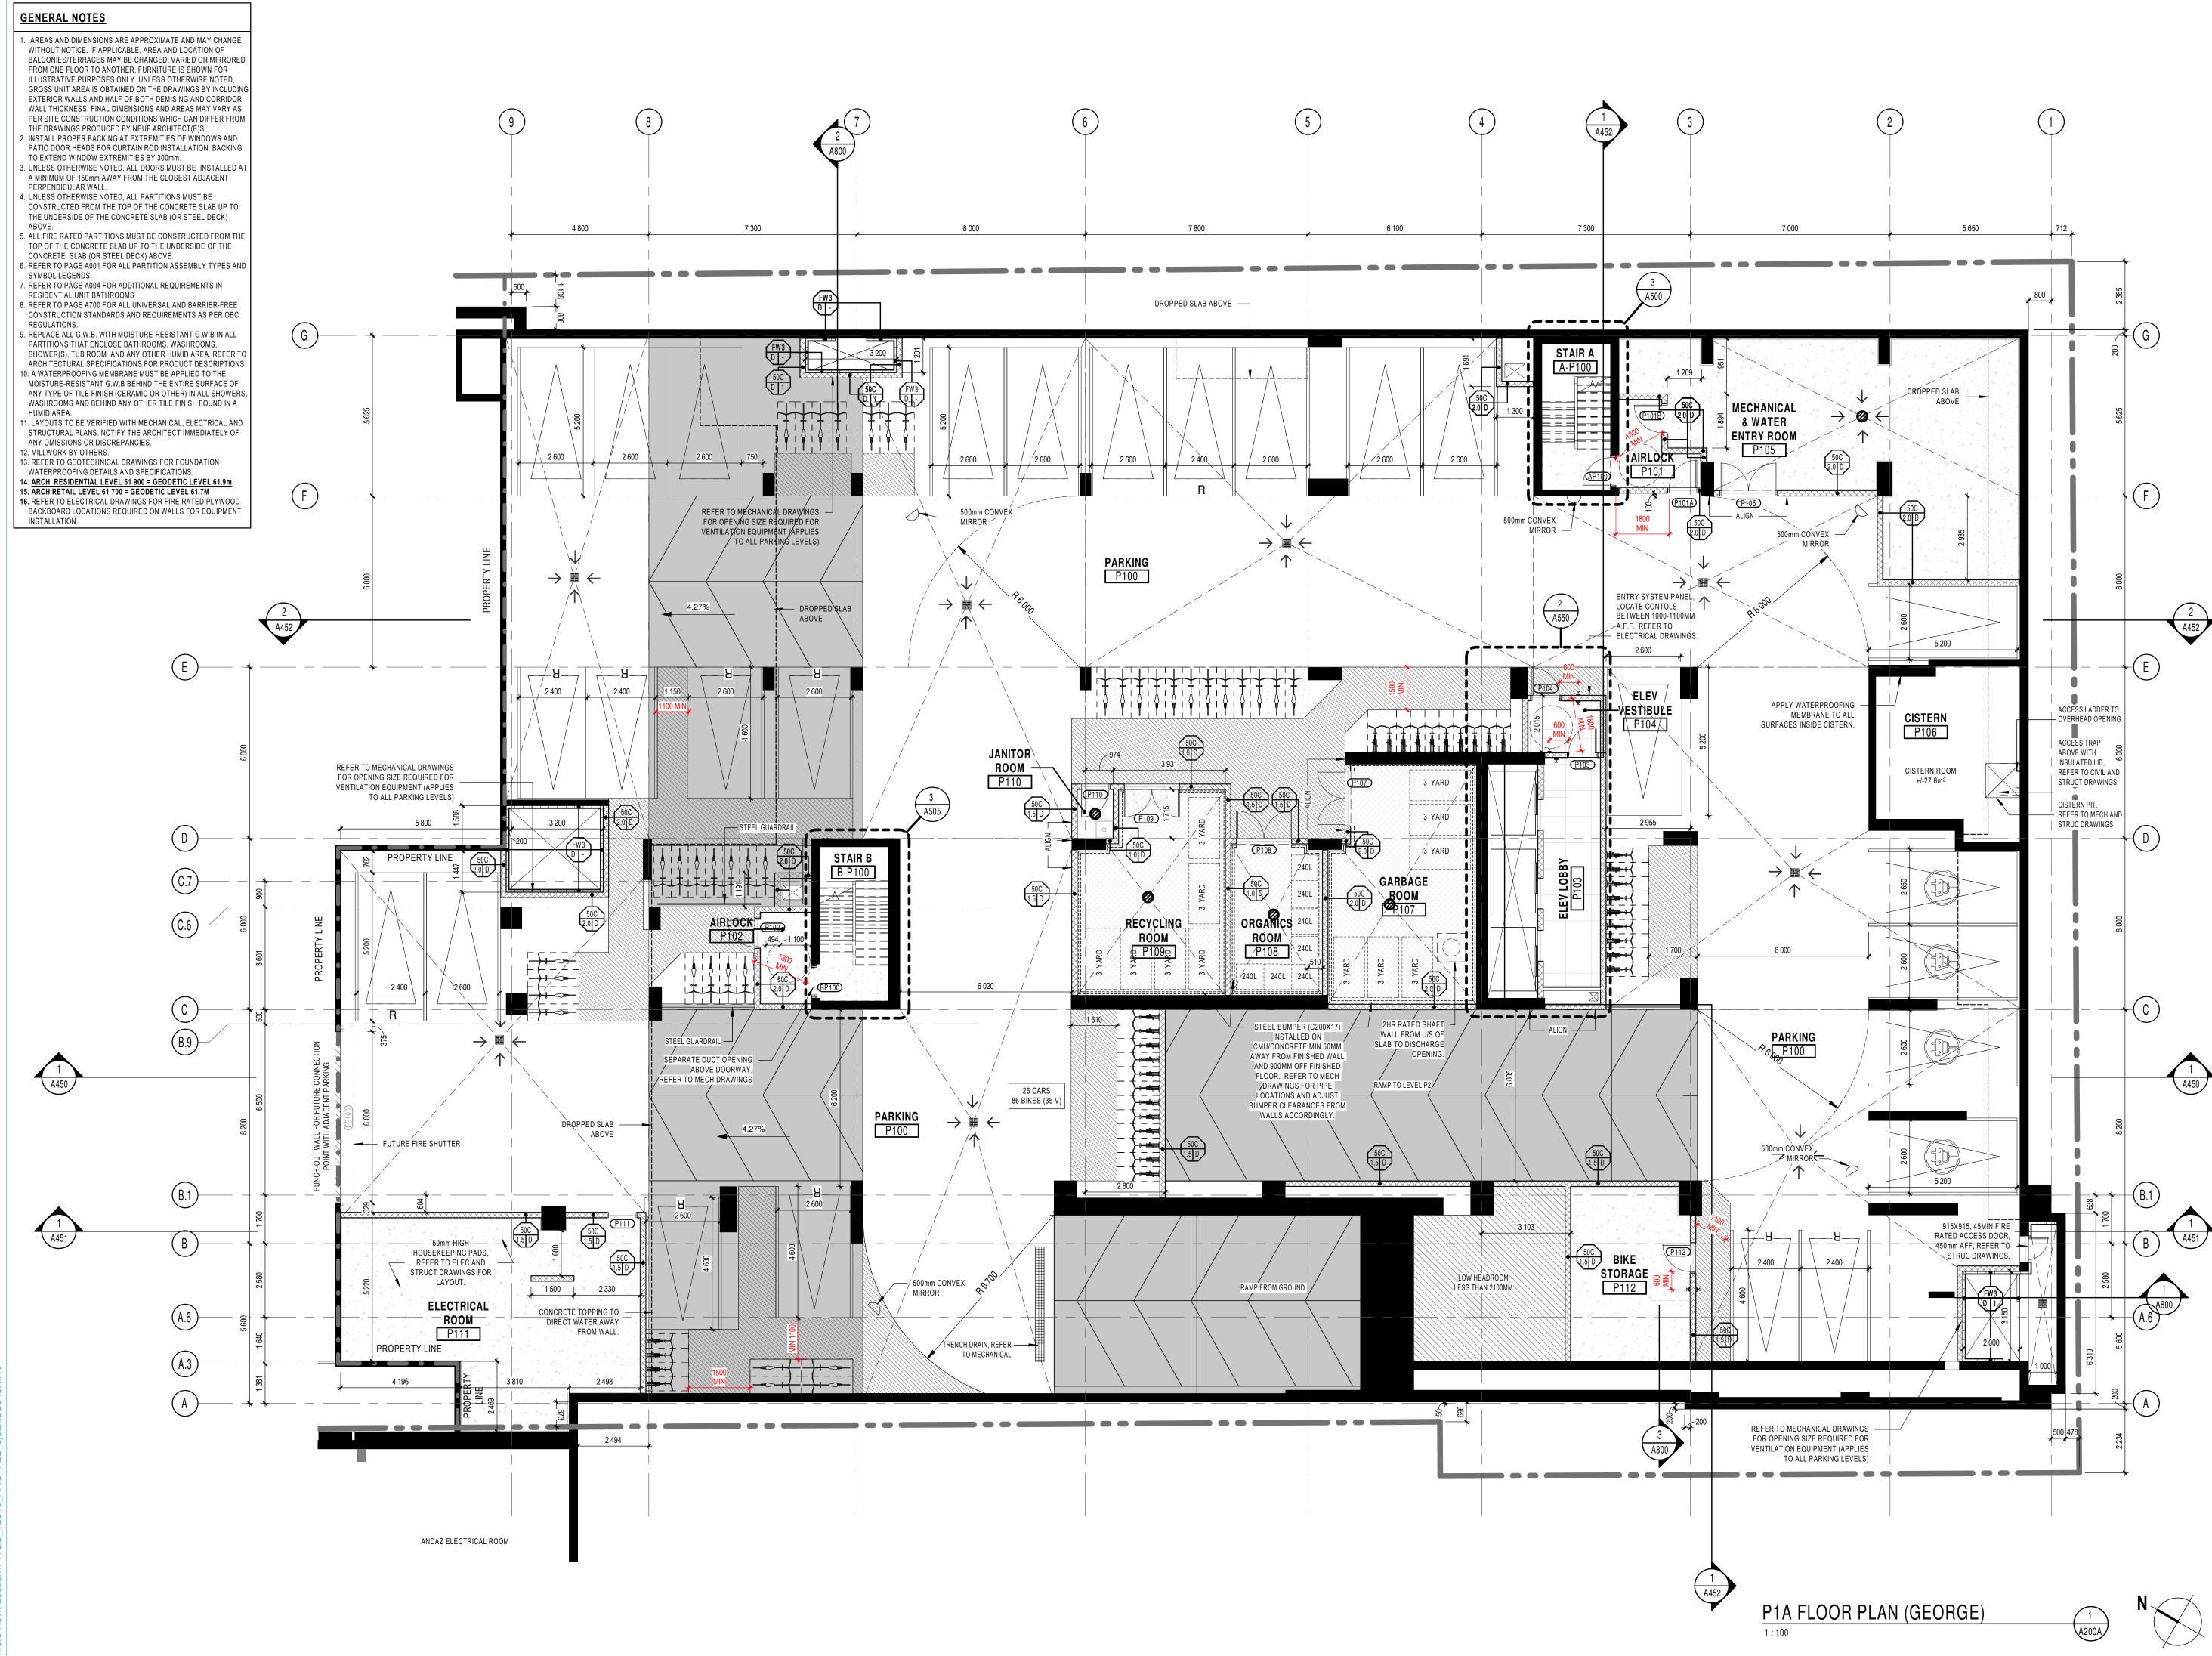Location OTTAWA


Client

No. 12810

NO	REVISION	DATE (yyyy.mm.dd)	
KK	FOR COORDINATION	2023.12.04	
LL	FOR COORDINATION	2023.12.15	
MM	FOR PERMIT	2023.12.21	
00	FOR COORDINATION	2024.01.23	
SS	FOR COORDINATION	2024.04.01	
TT	FOR COORDINATION	2024.04.04	
WW	FOR COORDINATION	2024.05.02	
XX	FOR COORDINATION	2024.05.09	
ΥY	FOR COORDINATION	2024.05.14	
ZZ	RE-ISSUED FOR SITE PLAN APPROVAL	2024.05.16	
AAA	FOR COORDINATION	2024.05.21	
CCC	FOR TENDER	2024.05.23	
DDD	FOR SHORING COORDINATION	2024.06.03	
FFF	FOR REVISED FOUNDATION PERM	IIT 2024.07.03	
GGG	FOR TENDER - ADDENDUM 02	2024.07.09	
	SITE PLAN REVISION RESPONSE	2024.08.26	
Drawn SJ	by	Checked by	
DATE (aa.mm.jj) SEP 2022		Scale As indicated	
Drawin	g Title		
		4	
PARKING LEVEL 1			
FLOOR PLAN (GEORGE)			

As indicated 660-71-71-0200 Dwg Number 0200 A200A

16814

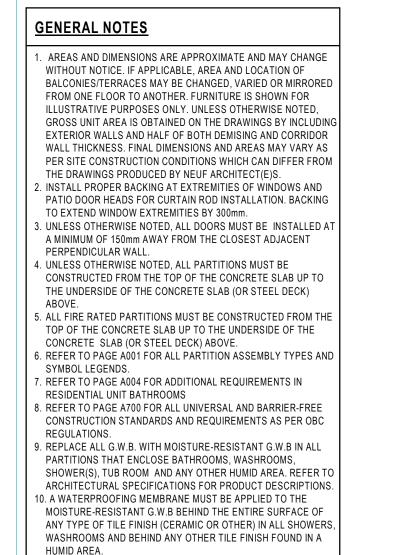

11. LAYOUTS TO BE VERIFIED WITH MECHANICAL, ELECTRICAL AND

STRUCTURAL PLANS. NOTIFY THE ARCHITECT IMMEDIATELY OF

13. REFER TO GEOTECHNICAL DRAWINGS FOR FOUNDATION

14. ARCH RESIDENTIAL LEVEL 61 900 = GEODETIC LEVEL 61.9m 15. ARCH RETAIL LEVEL 61 700 = GEODETIC LEVEL 61.7M


16. REFER TO ELECTRICAL DRAWINGS FOR FIRE RATED PLYWOOD BACKBOARD LOCATIONS REQUIRED ON WALLS FOR EQUIPMENT

WATERPROOFING DETAILS AND SPECIFICATIONS.

ANY OMISSIONS OR DISCREPANCIES.

12. MILLWORK BY OTHERS.

INSTALLATION.

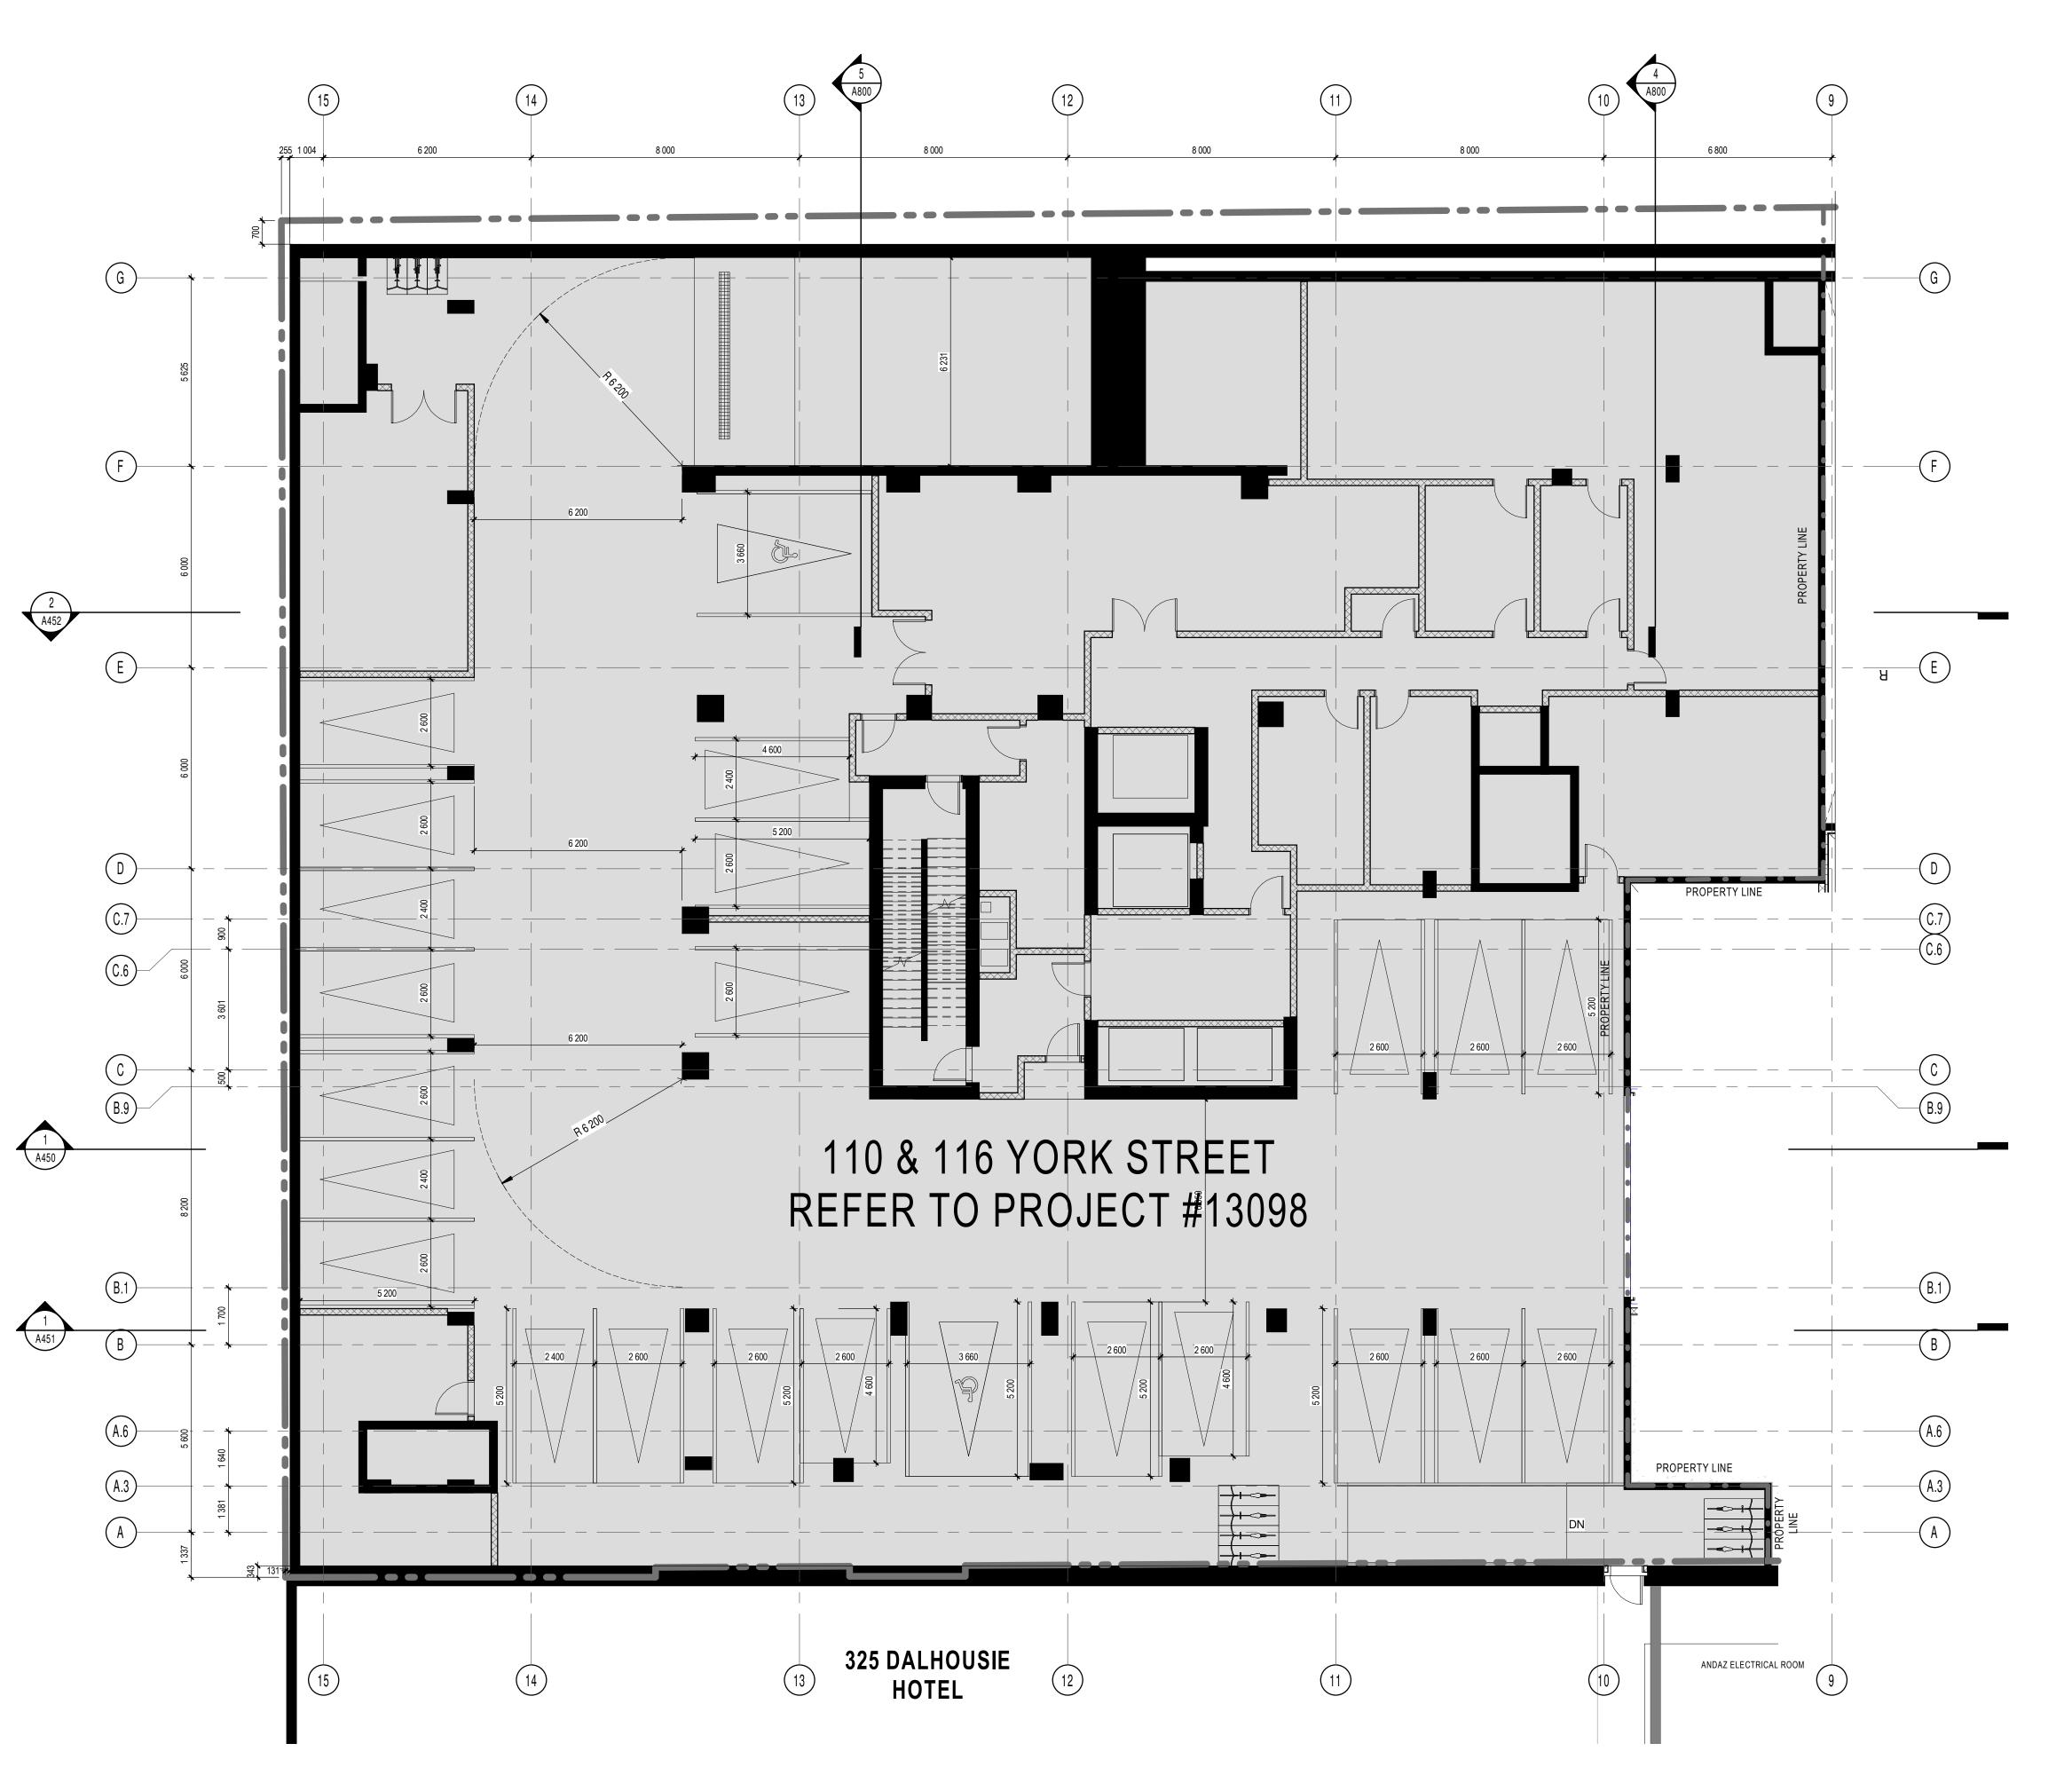

P1B FLOOR PLAN (YORK)





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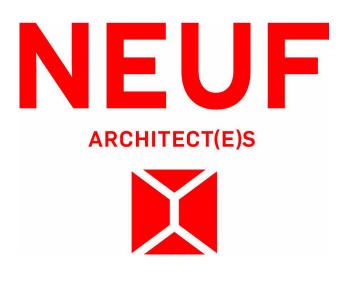
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Architect

Seal





Client




141 GEORGE STREET

Location OTTAWA ^{№.} 12810

FOR COORDINATION	2024.04.01
OR COORDINATION	2024.04.04
OR COORDINATION	2024.05.02
OR COORDINATION	2024.05.09
OR COORDINATION	2024.05.14
RE-ISSUED FOR SITE PLAN	2024.05.16
APPROVAL	
FOR COORDINATION	2024.05.21
FOR TENDER	2024.05.23
OR SHORING COORDINATION	2024.06.03
OR REVISED FOUNDATION PERM	VIT 2024.07.03
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Revision	Dwg Number
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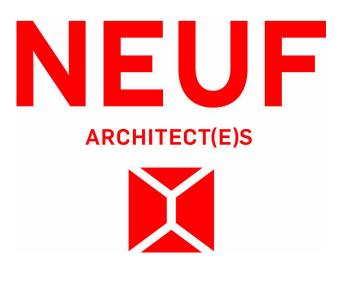
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Client

141 GEORGE STREET
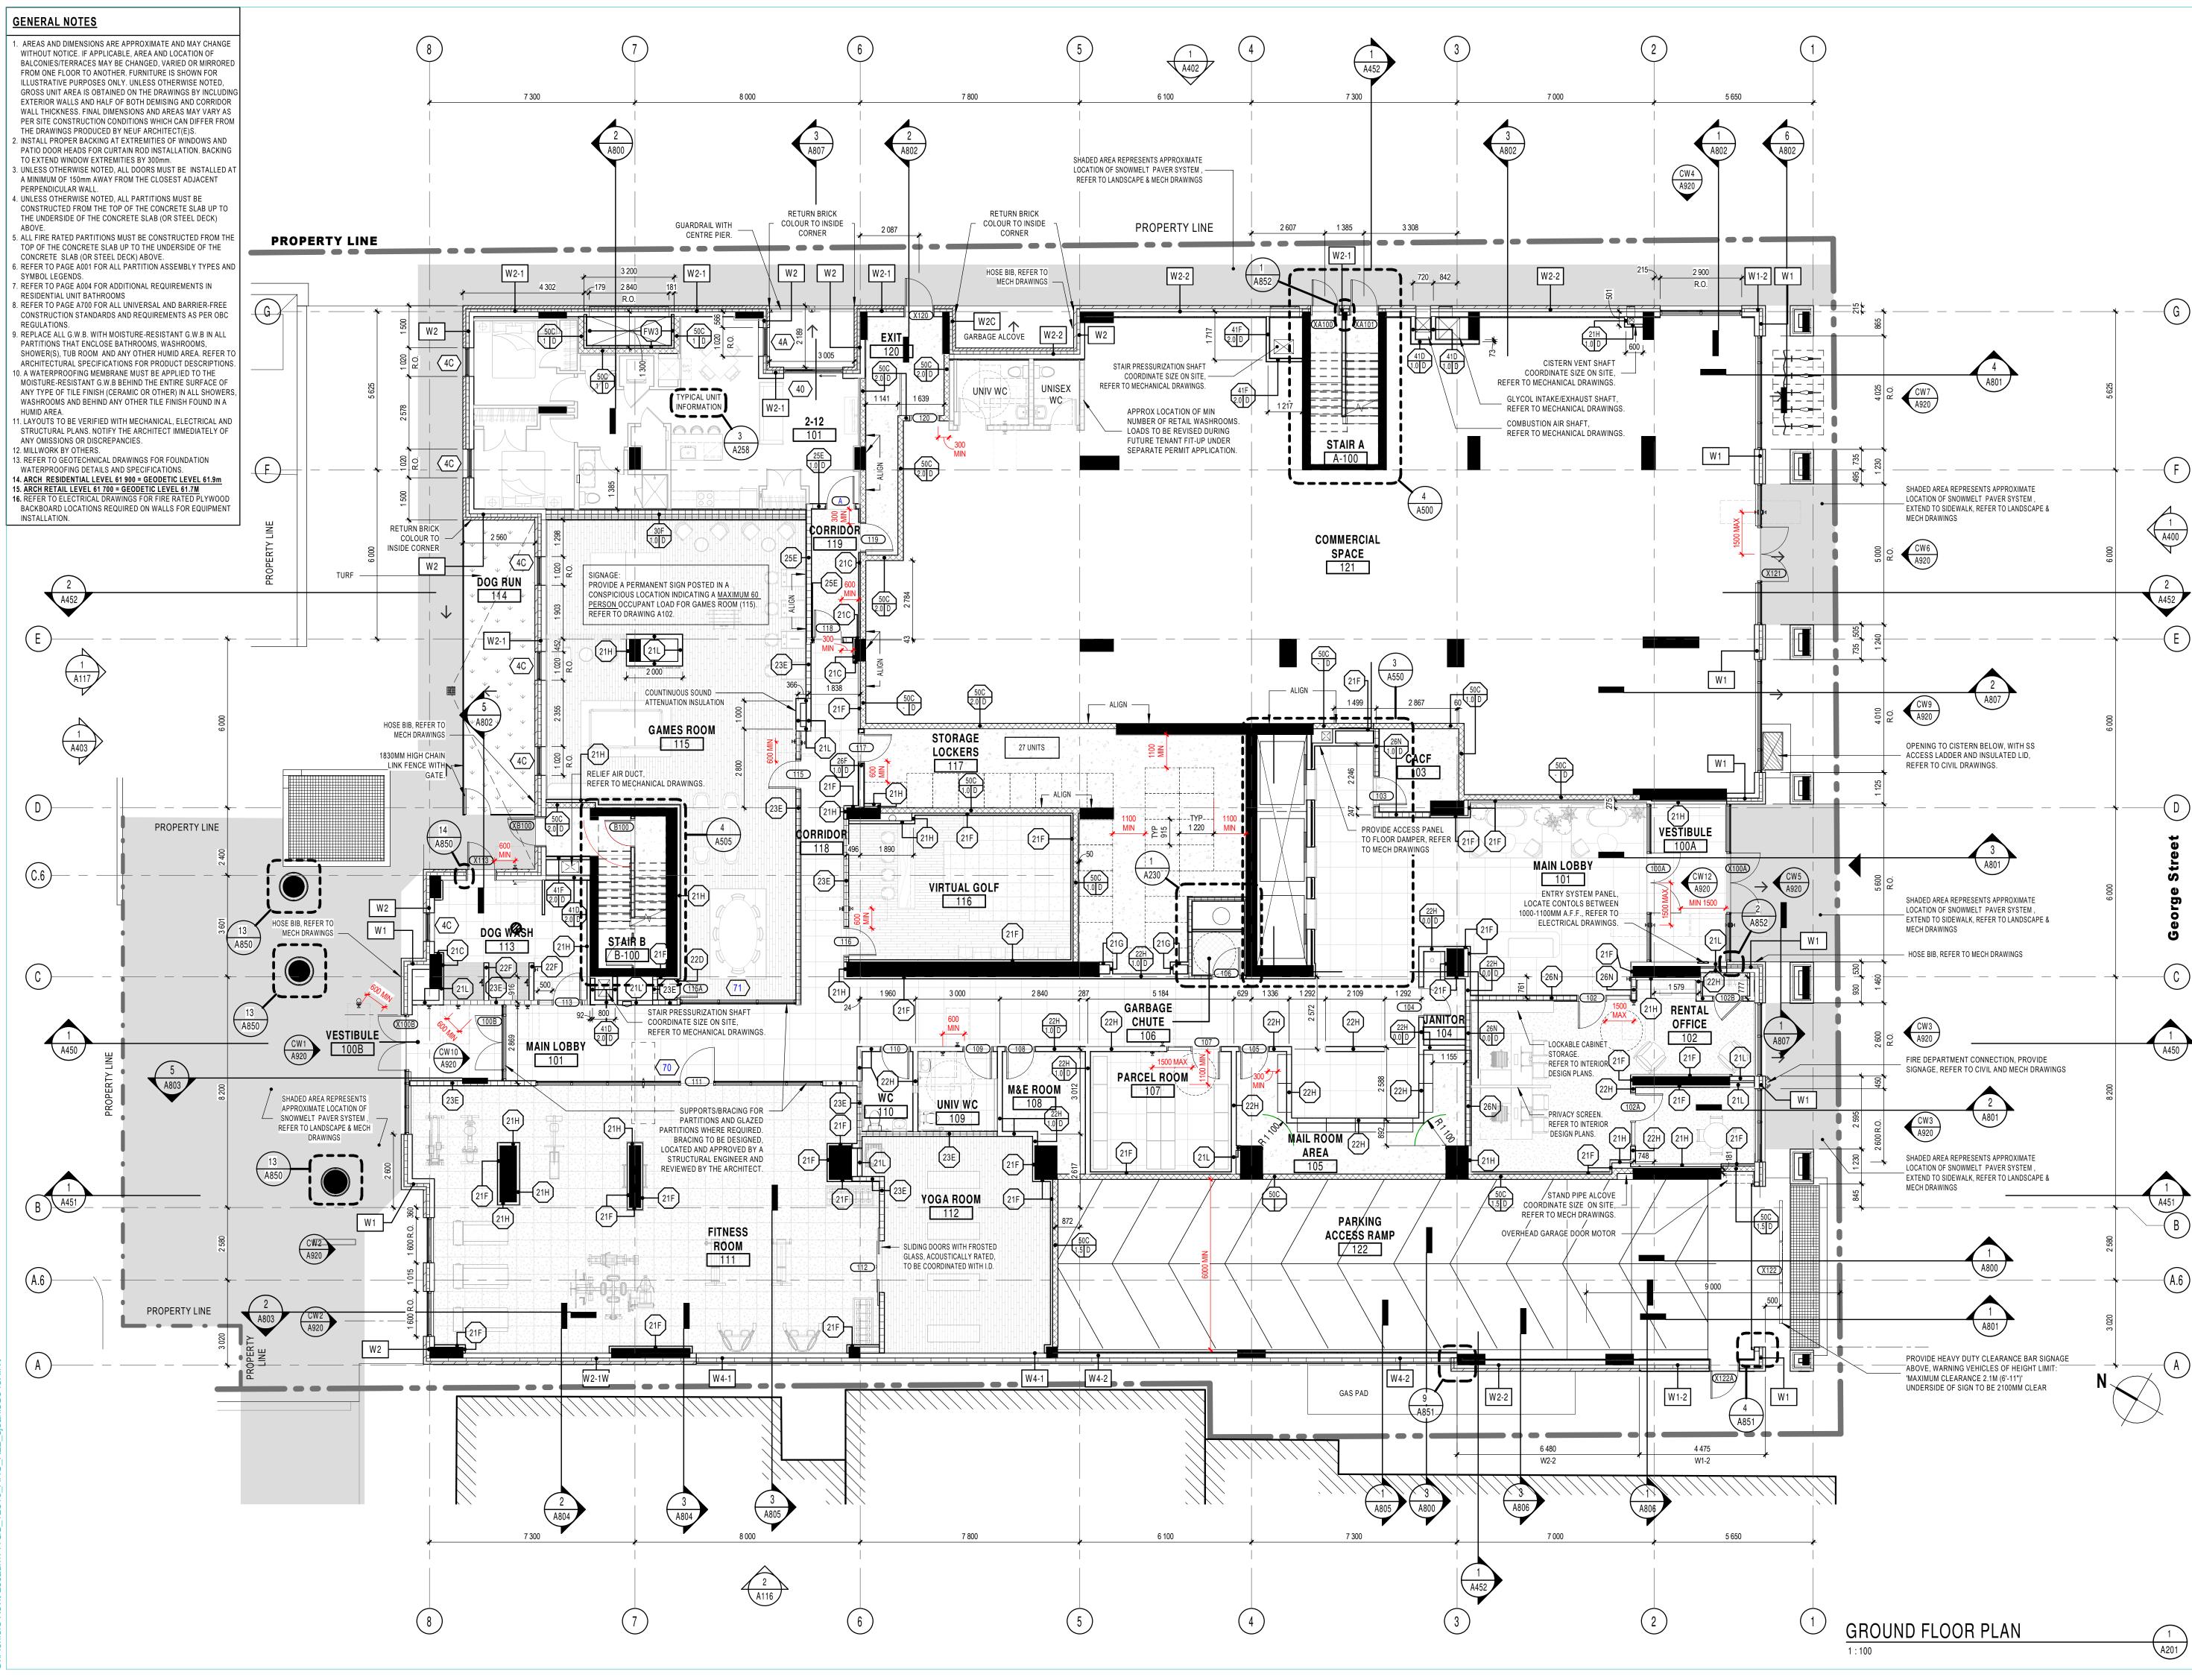
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NO	REVISION	

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Dwg Number 600

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NO	REVISION	DATE (yyyy.mm.dd)	
LL	FOR COORDINATION	2023.12.15	
MM	FOR PERMIT	2023.12.21	
00	FOR COORDINATION	2024.01.23	
RR	FOR COORDINATION	2024.02.26	
TT	FOR COORDINATION	2024.04.04	
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WW	FOR COORDINATION	2024.05.02	
XX	FOR COORDINATION	2024.05.09	
ΥY	FOR COORDINATION	2024.05.14	
ZZ	RE-ISSUED FOR SITE PLAN	2024.05.16	
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AAA	FOR COORDINATION	2024.05.21	
BBB	FOR COORDINATION	2024.05.23	
	FOR TENDER	2024.05.23	
FFF	FOR REVISED FOUNDATION PERM		
111	SITE PLAN REVISION RESPONSE	2024.08.26	
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DATE	(aa.mm.jj)	Scale	
SEF	202 ² 2	As indicated	ရ
Drawin	g Title		12-019
GROUND FLOOR PLAN			

Drawing Title