
NOTES:

THIS PLAN IS ISSUED FOR SITE PLAN CONTROL SUBMISSION ONLY. ADDITIONAL DETAILING AND SPECIFICATIONS ARE REQUIRED PRIOR TO **TENDERING OR CONSTRUCTION.**

SERVICING INFORMATION SHOWN AS REFERENCE ONLY. REFER TO CIVIL DRAWINGS.

DRAWING TO BE READ IN CONJUNCTION WITH TREE CONSERVATION **REPORT. REFER TO TREE CONSERVATION REPORT PREPRARED BY RUHLAND & ASSOCIATES LTD. DATED AUG 09, 2024 FOR TREE PROTECTION MEASURES AND DETAILS.**

ALL TREES TO BE PLANTED A MINIMUM OF 1m FROM EDGE OF SIDEWALK

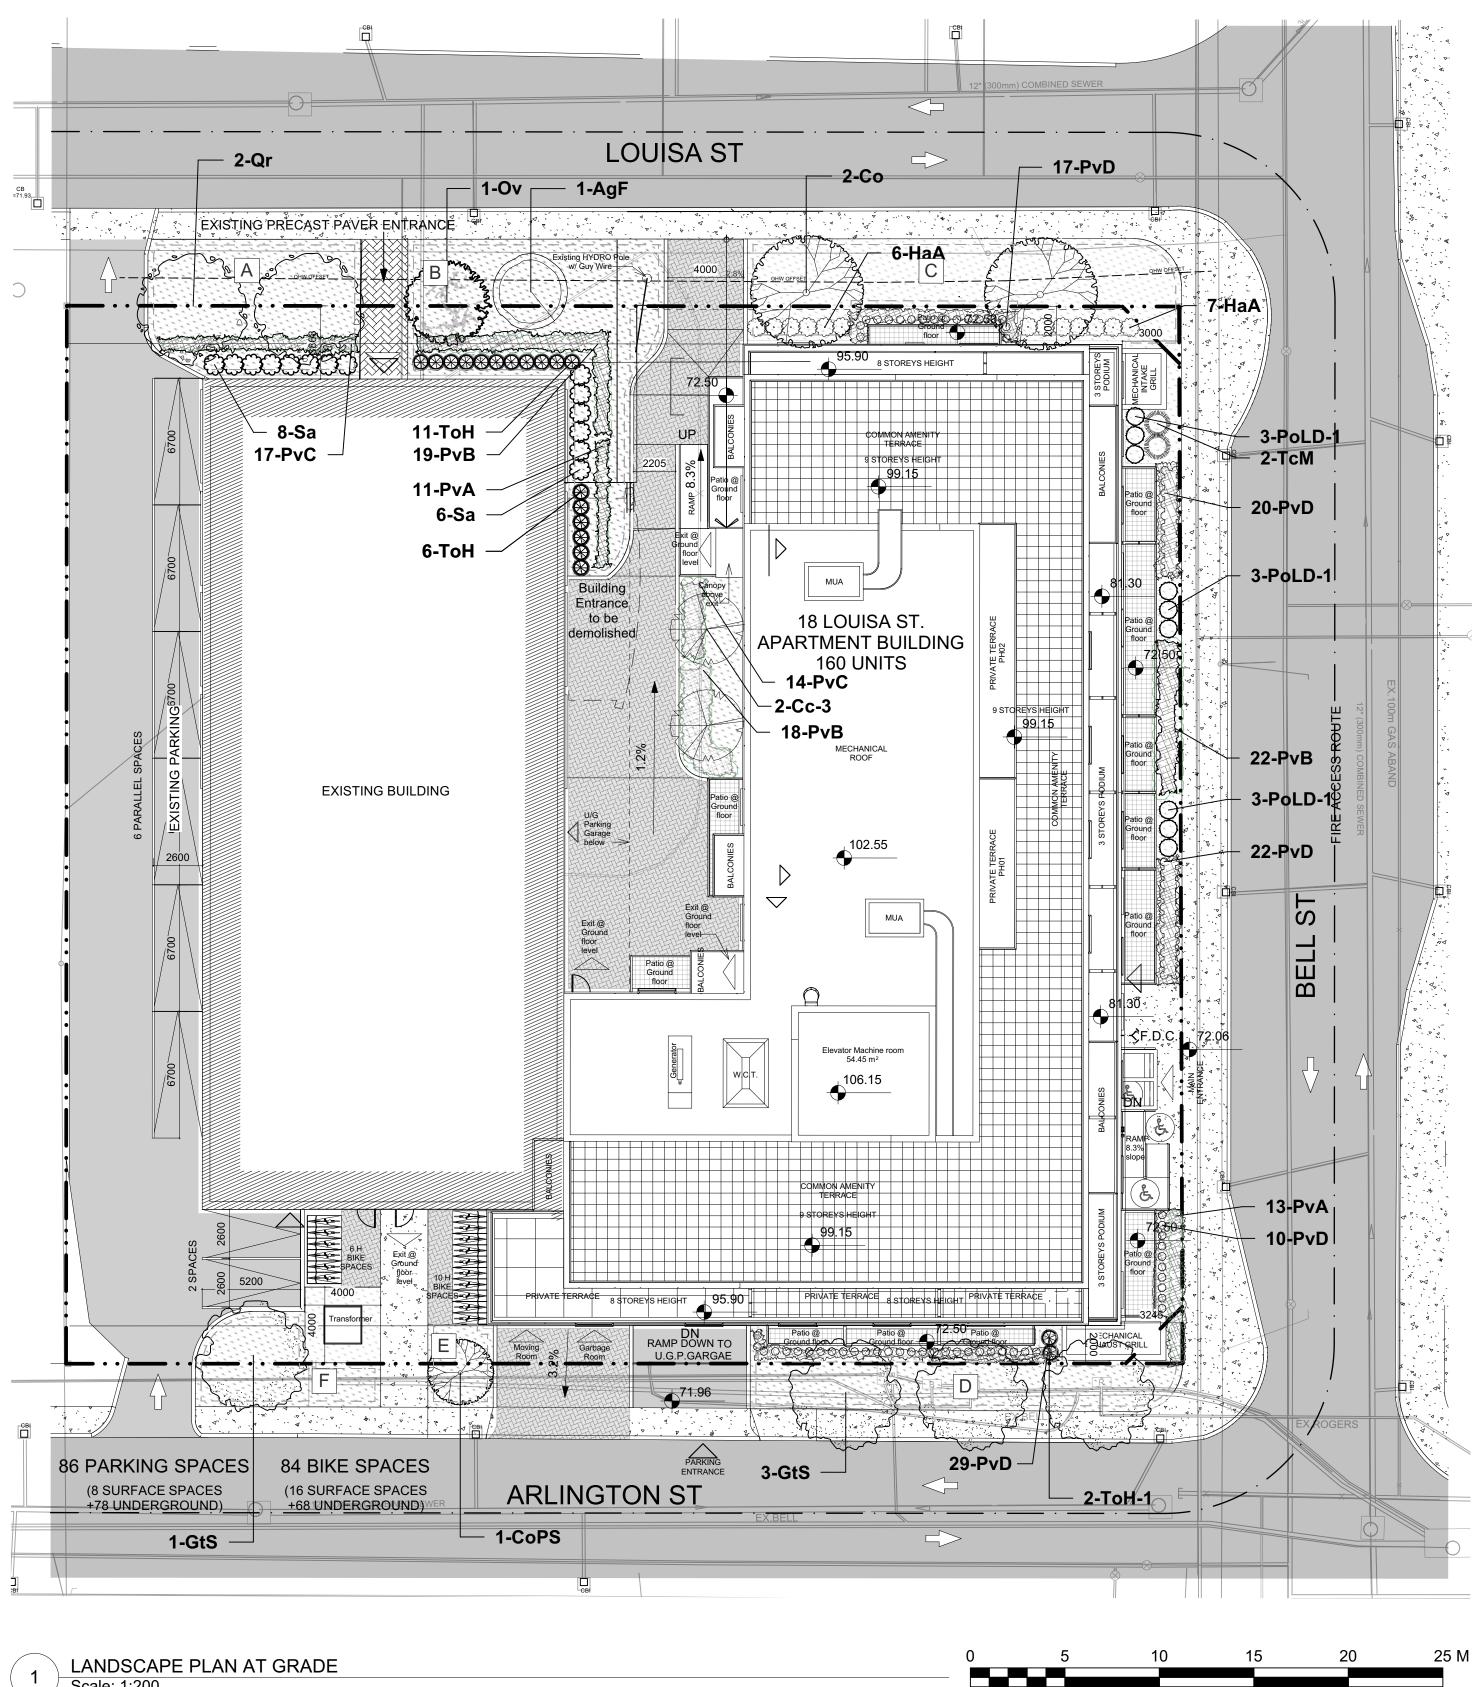

LANDSCAPE PLAN AT GRADE Scale: 1:200

LEGEND

----- PROPERTY LINE

---- EXTENT OF PROPOSED UNDERGROUND PARKING SLAB PROPOSED COURTYARD PAVERS

PROPOSED PRIVATE TERRACE PAVERS

PROPOSED PAVER PATHWAY

PROPOSED BIKE RACK ON CONCRETE PAD

PROPOSED SHRUBS

PROPOSED TREES

PROPOSED PERENNIALS AND ORNAMENTAL GRASSES

ID	Qty	Botanical Name	Common Name	Schedule
		TREES		
AgF	1	Acer ginnala 'Flame'	Flame Amur Maple	45mm calip
Cc-3	2	Carpinus caroliniana	Bluebeech, Musclewood	50mm calip
Со	2	Celtis occidentalis	Common Hackberry	60mm calip
CoPS	1	Celtis occidentalis 'Prairie Sentinel'	Prairie Sentinel Hackberry	60mm dia.
GtS	4	Gleditsia triacanthos 'Shademaster'	Shademaster Honey Locust	60mm calip
Ov	1	Ostrya virginiana	Ironwood	50mm dia.
Qr	2	Quercus rubra	Northern Red Oak	60mm calip
		SHRUBS		
HaA	13	Hydrangea arborescens 'Annabelle'	Annabelle Hydrangea	2 gallon po
PoLD-	9	Physocarpus opulifolius 'Little Devil'	Little Devil Ninebark	50cm ht.
Sa	14	Symphocarpus albus	Common Snowberry	50 cm ht.
ТсМ	2	Taxus cuspidata 'Monloo'	Emerald Spreader Japanese Yew	60cm spd
ТоН	23	Thuja occidentalis ssp.	Dwarf Cedar ssp.	100 cm ht.
ToH-1	2	Thuja occidentalis ssp.	Dwarf Cedar ssp.	100 cm ht.
		PERENNIALS		
PvA	24	Perennial Mix A - Sun-Shade	Coral Bells, Sedge, Hostas	150mm pot
PvB	59	Perennial Mix B - Sun-Shade	Ornamental Grasses-Shade	150mm pot
PvC	31	Perennial Mix C - Shade	Ferns, Hostas, Daylilies, Solomon's Seal	150mm pot
PvD	98	Sun Grasses Mix D	Sedges, Feather Reed Grasses	150mm pot

18 Louisa Street				
Soil Volume Area, Tree Quantity and Size	Tree Quantity	OTTAWA TARGET SOIL VOLUME (m3)	Design Soil Volume	SOIL ADEQUACY percentage
AREA A - 2 Large shade trees				
Plant bed (80 sq m x 0.45 metre deep)	2	36.0	30.6	85.00%
AREA B- 2 Medium shade trees				
plant bed (39 sq m x 0.6 metre deep)	2	50.0	67.2	134.40%
AREA C - 2 Large shade trees				
Plant bed (81.5 sq m x 0.45 metre deep)	2	36.0	41.2	114.38%
AREA D - 3 Medium shade trees				
plant bed (21 sq m x 0.8 metre deep)	3	45.0	39.2	87.11%
AREA E - 1 Small Ornamental tree				
plant bed (13.6 sq m x 0.6 metre deep)	1	8.0	6.6	82.50%
AREA F - 1 Medium shade tree				
plant bed (6 sq m x 0.8 metre deep)	1	25.0	22.4	89.60%

GENERAL NOTES

.1 All general site information and conditions compiled from existing plans, surveys and consultant's field notes. Report all discrepancies prior to any work. No responsibility is born by the Consultant for unknown subsurface conditions.

.2 The location of the utilities is approximate only, and the exact location should be determined by consulting the municipal authorities and utility companies concerned. The Contractor shall prove the location of utilities and shall be responsible for adequate protection from damage.

.3 All dimensions shown are to be verified on site prior to any construction. No deviations are to be made from the layouts as shown on this plan without prior consultation with the Landscape Architect and Owner.

.4 Obtain approval of Landscape Architect for granular base and layout of all pavement areas prior to construction.

.5 Stake planting locations and receive approval of Landscape Architect, prior to excavation of any planting pits. No substitutions of plant material shall be made without prior approval of the Landscape Architect.

.6 Where clay is encountered proper drainage must be ensured in tree/shrub pits, prior to planting. Have method approved by Landscape Architect.

.7 All sodded areas to receive a minimum of 150mm of topsoil over graded sub-base. If sod with mesh is used, mesh to be removed completely during sodding operations. Sod shall come from an approved source and shall be laid within 24 hours of being cut in the nursery. Only nursery sod shall be used.

.8 Final subgrade is to approved by the Landscape Architect prior to sod being laid.

.9 Maintain positive surface runoff through the entire construction period.

.10 Reinstate all areas and items damaged as a result of construction activities.

.11 Street tree species locations and numbers were selected based on soil volume calculations in accordance with the City of Ottawa's requirements for tree planting.

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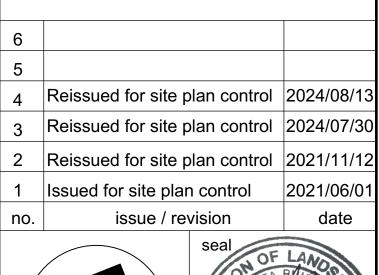
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project

18 LOUISA STREET

OTTAWA, ON

drawing title

LAN	DSCAF	PE PLAN
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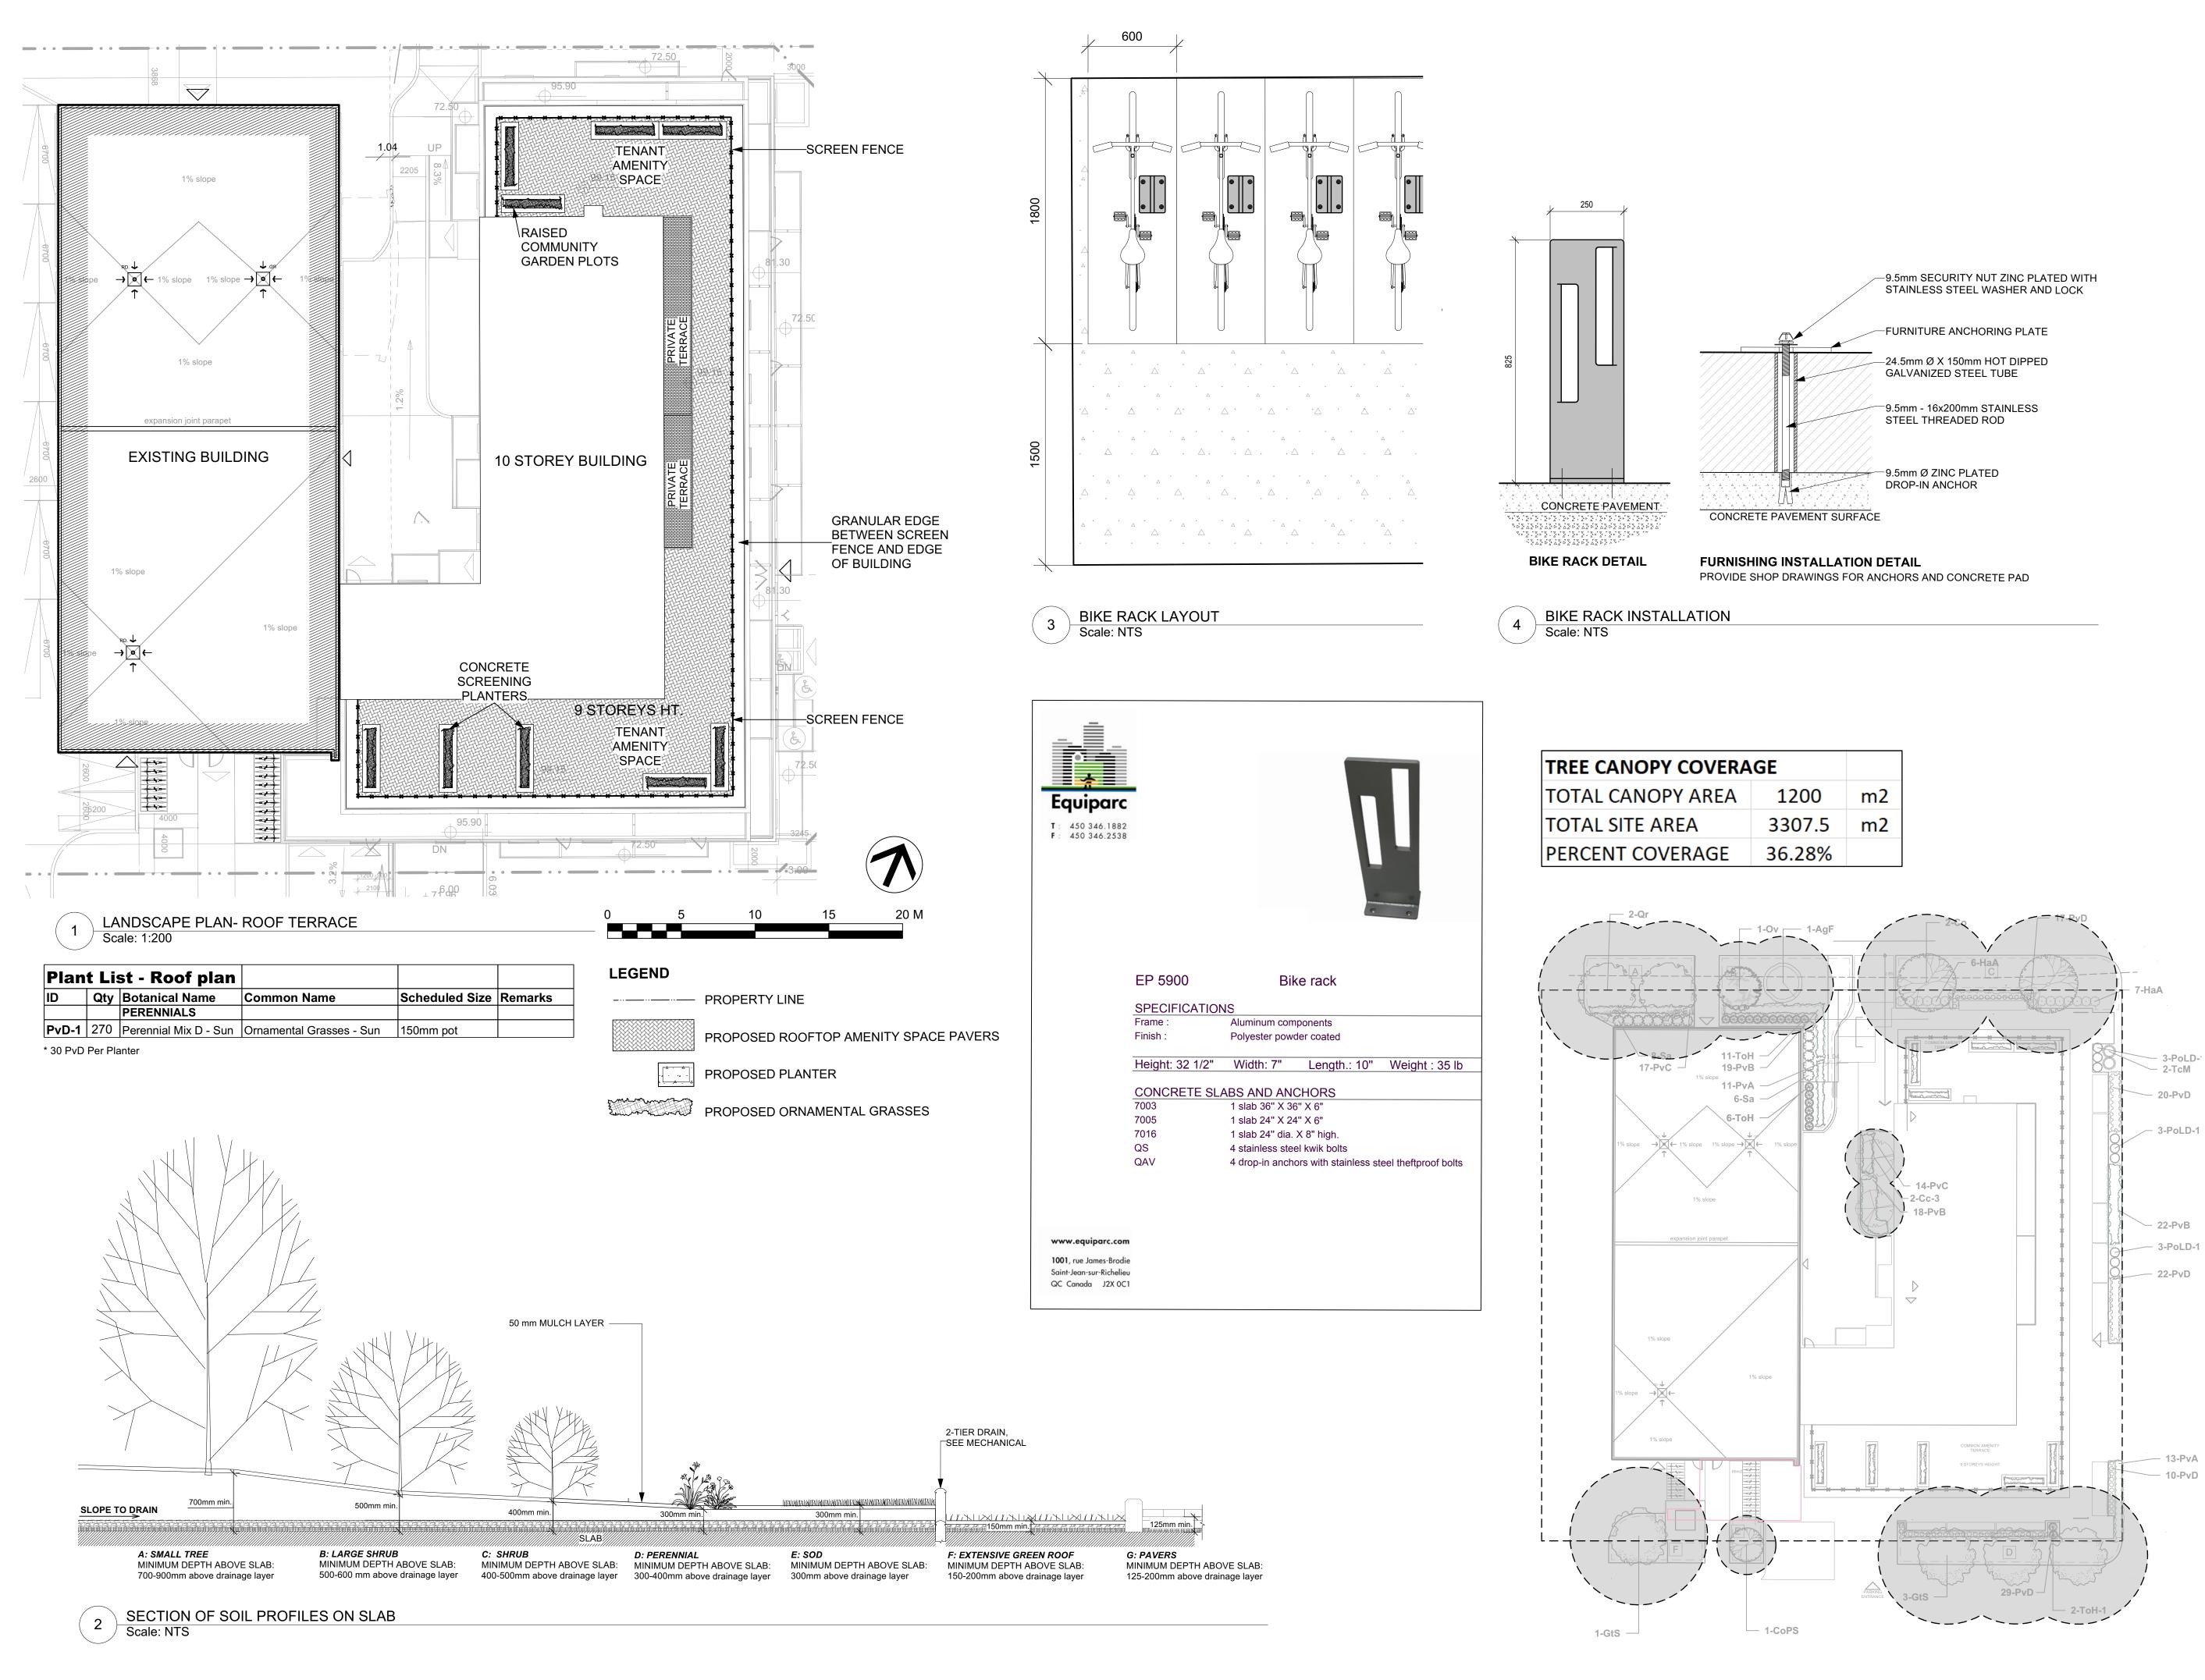
ed Size Remarks WB, Staked liper WB, Staked WB Staked liper WB Staked WB Staked WB Staked WB Staked liper 0.9m o.c. Potted Potted 0.5m o.c. Potted Potted

SOIL VOLUME REQUIREMENTS:

AREAS WHERE SITE CONSTRAINTS (such as parking lot islands, adjacent hard surface areas):0.9 TO 1.2 METRE DEPTH IMPORTED TOPSOIL (average depth of 1000mm).

AREAS WITHIN OR ADJACENT TO LARGER SOFT LANDSCAPE AREAS (such as wide boulevards, lawns, etc):

0.4 METRE AVERAGE DEPTH OF IMPORTED TOPSOIL OVER APPROVED EXISTING SUBSOIL. ADDITIONAL IMPORTED TOPSOIL OR APPROVED SUBSOIL TO BE ADDED WHERE SUBGRADE BELOW THE 400mm IMPORTED TOPSOIL IS NOT CONDUSIVE TO PLANT GROWTH TO A MAXIMUM DEPTH OF 1 METRE.



GE	
1200	m2
3307.5	m2
36.28%	

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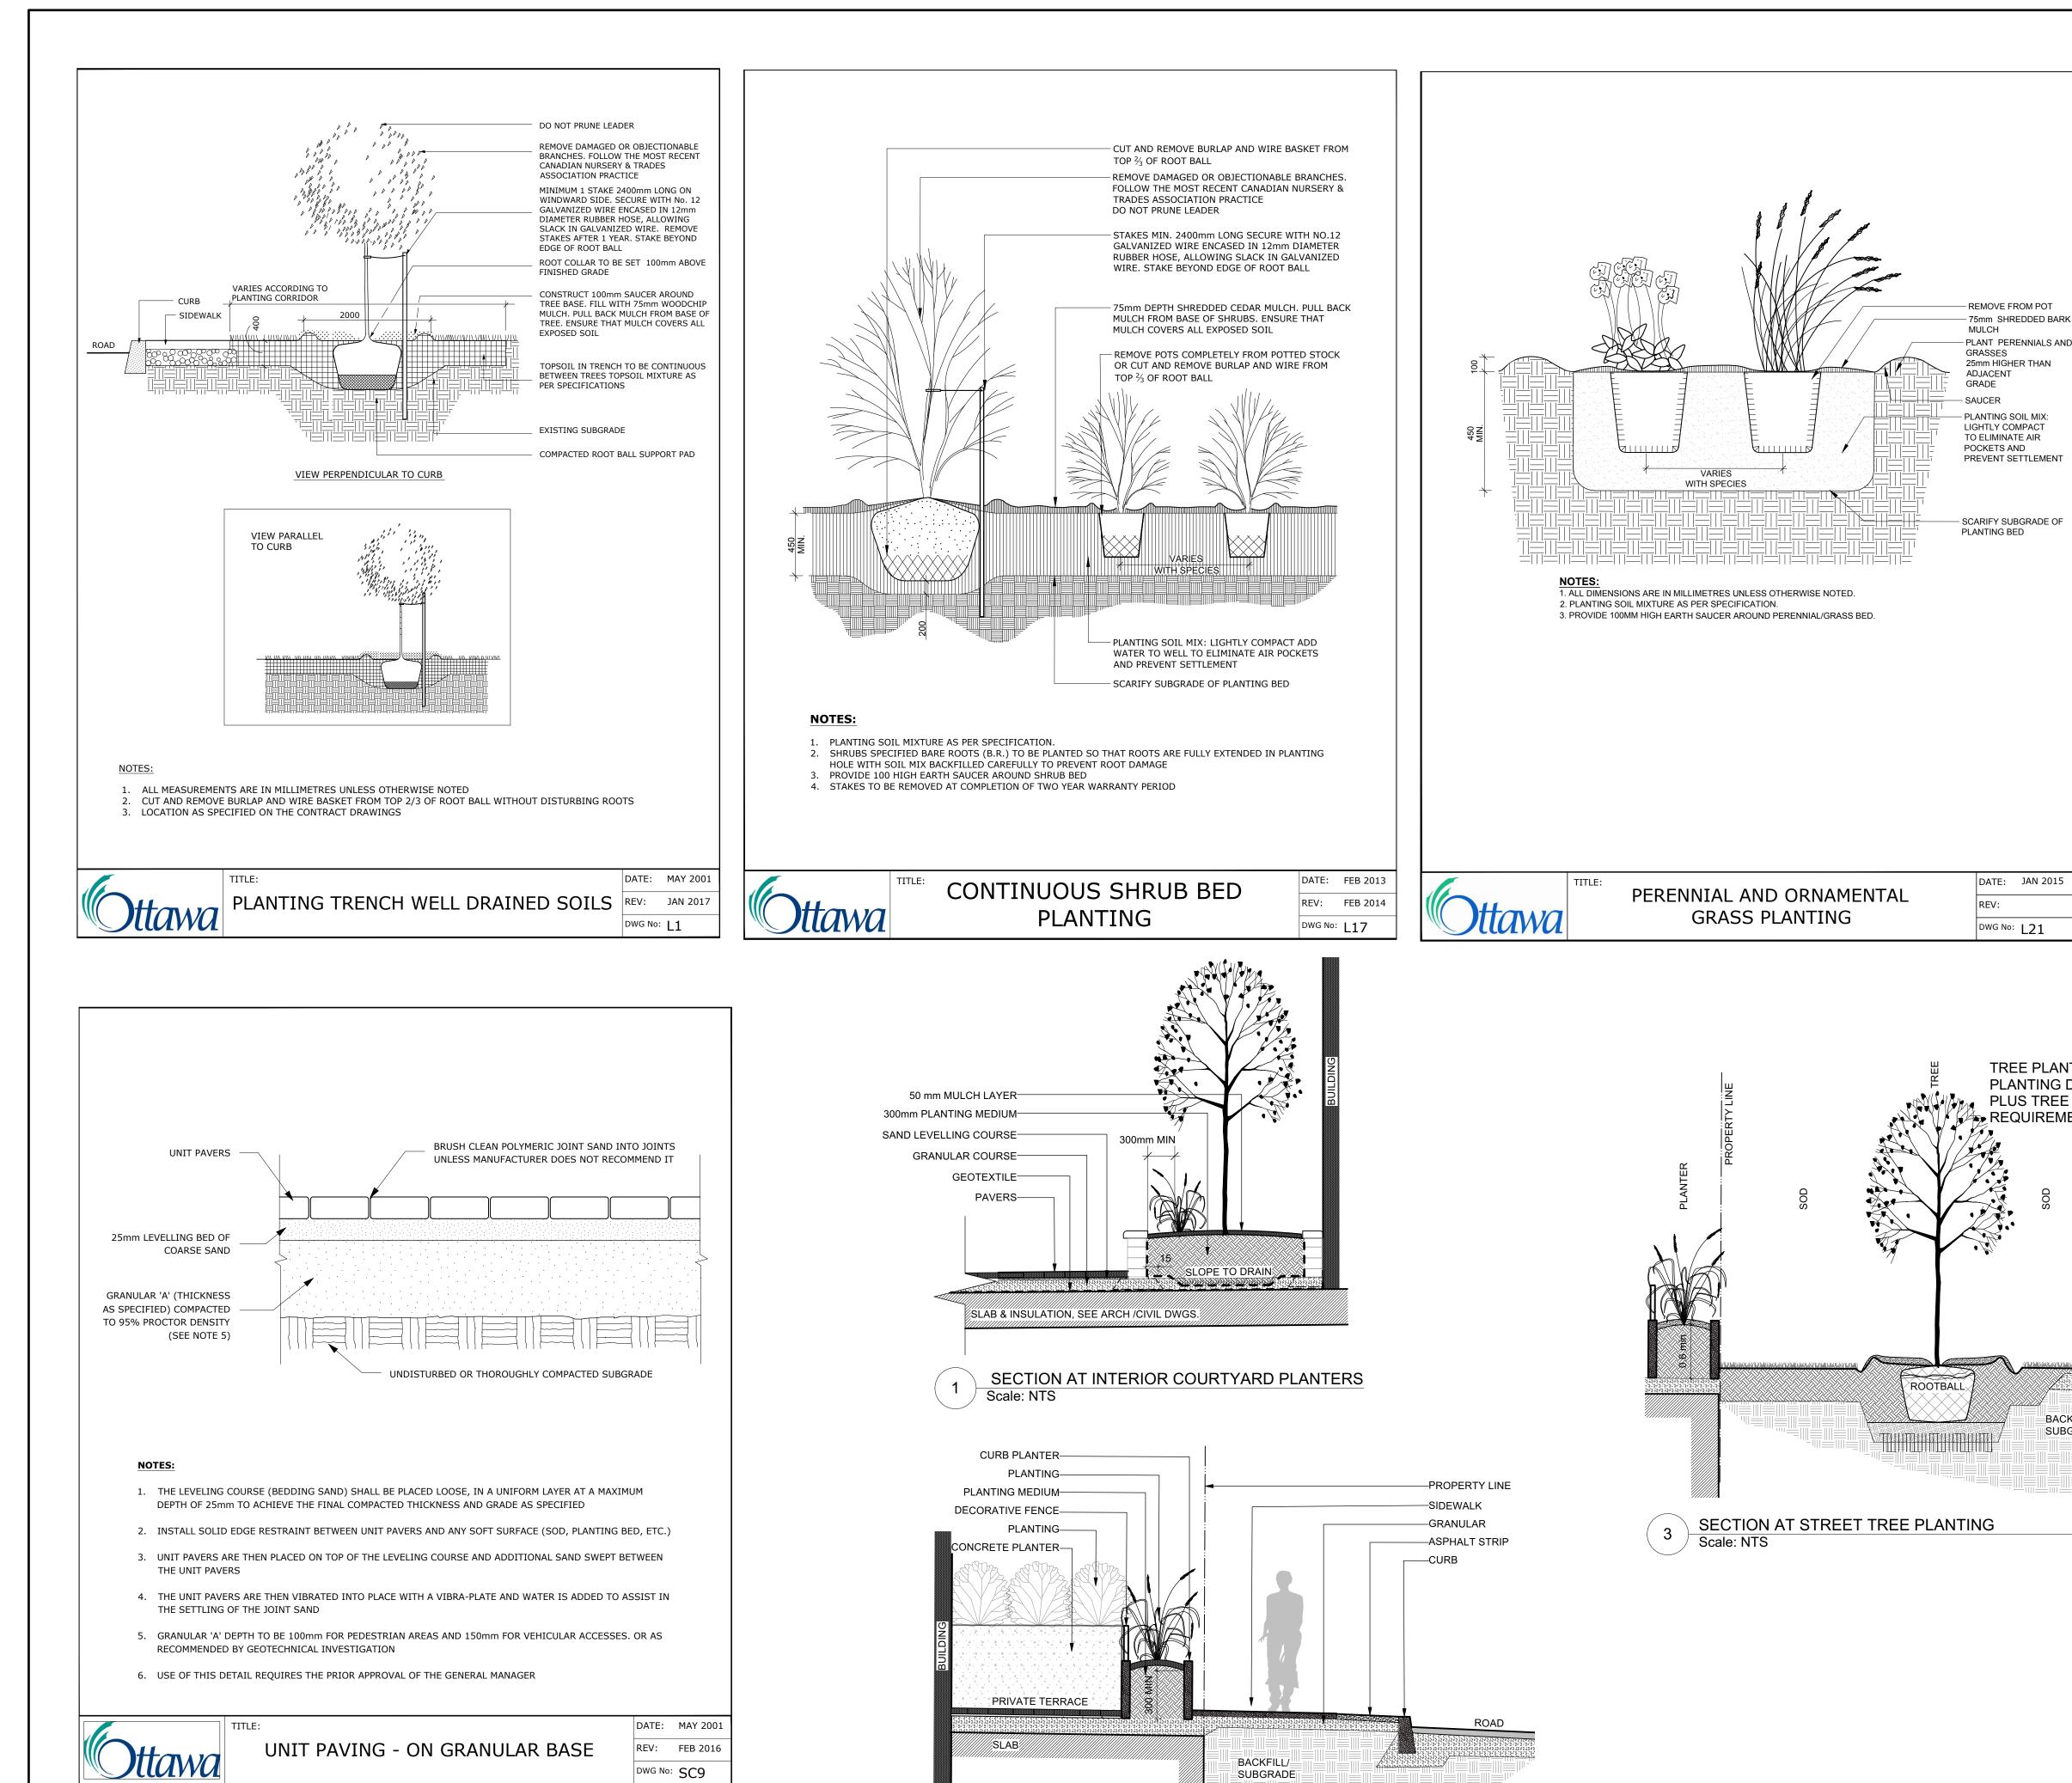
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5			
4	Reissued for site plan control		2024/08/13
3	Reissued for site plan control		2024/07/30
2	Reissued for site plan control		2021/11/12
1	Issued for site plan control		2021/06/01
no.	issue / revision		date
		seal ON OF	LANDSCHOPE

north



18 LOUISA STREET OTTAWA, ON drawing title **ROOF PLAN / BIKE RACK LAYOUT** scale drawn by designed by J. K. / T.F. J.K. / M.R. date checked by plot date JUNE 2021 M. R. 2021 06 01 project number drawing number L - 02 20-1629

Contractor to check and verify all dimensions on the job



ADDITIONAL NOTES FOR NUMBER 5: PRECAST PAVERS IN VEHICULAR AREAS TO RECEIVE SAME BASE STRUCTURES FOR GRANULAR 'A' AND 'B' AS GEOTECHNICAL RECOMMENDATIONS FOR HEAVY DUTY PAVEMENT. PEDESTRIAN AREAS ARE TO RECEIVE 200mm COMPACTED GRANULAR 'A' MINIMUM, ADJUSTMENTS TO BE SPECIFIED IN RELATION TO SITE CONDITIONS AND GEOTECHNICAL RECOMMENDATIONS.

SECTION EXTERIOR PATIO

Scale: NTS

NOTES

TREE SOIL VOLUME REQUIREMENTS: STANDARD TREE SOIL VOLUMES QUANTITIES INCLUDE THE TOP 900-1000mm OF SOIL/EXISTING SUBSOIL LAYER TO CALCULATE TOTAL SOIL VOLUMES REQUIRED BY CITY OF OTTAWA FOR SUSTAINABLE TREE GROWTH. WHERE LARGER SOFT AREAS ARE AVAILABLE, THE TOP 400-500mm LAYER IS USED TO CALCULATE SOIL VOLUMES (AS PER CITY DETAL L1).

WHERE EXISTING MATERIAL BELOW THE SPECIFIED IMPORTED TOPSOIL IS NOT CONDUCIVE TO TREE GROWTH, AN ADDITIONAL LAYER OF PLANTING MEDIUM IS TO BE INSTALLED BELOW SPECIFIED TOPSOIL DEPTH TO OBTAIN THE SOIL VOLUME DEPTH REQUIRED.

REFER TO SOIL VOLUME CHART AND PLANS FOR AREA WHERE TREE SOIL VOLUMES ARE REQUIRED.

25mm HIGHER THAN

DATE: JAN 2015

TREE PLANTING TO CITY OF OTTAWA PLANTING DETAIL L1/L-03 PLUS TREE SOIL VOLUME REQUIREMENTS BACKFILL/ SUBGRADE

PATERSONGROUP Faisal Abou-Seido (613) 226-7381 Ext. 210 David Gilbert dgilbert@patersongroup.ca (613) 226-7381 Ext. 205

Reissued for site plan control 2024/08/13 Reissued for site plan control 2024/07/30 2 Reissued for site plan control 2021/11/12 Issued for site plan control 2021/06/01 no. issue / revision date

north



project


18 LOUISA STREET

OTTAWA, ON

drawing title

SECTIONS / DETAILS

20-1629	L -	03
project number	drawing number	
JUNE 2021	M. R.	2021 06 01
date	checked by	plot date
	J. K. / T.F.	J.K. / M.R.
scale	drawn by	designed l

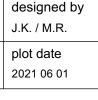

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