

parking lot

VISITOR PARKING (0.2)

DWELLING UNITS

BLOCK

3(NEW) 4

349.5m²

227m2

242m2

no minimum

Balconies:

Playground:

AMENITY BREAKDOWN

Ground Floor Amenity: 83m2

LANDSCAPED AREA

BUILDING AREA

BUILDING HEIGHT

ZONE

GROSS FLOOR AREA

975m²

3,900m²

AM10 H(40)

14.15m, 4 STOREYS

Ogilvie, from the

metres, must be

transparent glazing

resident entrance

comprised of

access doors

average grade up 4.5

and active customer or

SITE PLAN GENERAL NOTES:

- 1. ALL GENERAL SITE INFORMATION AND CONDITIONS COMPILED FROM EXISTING PLANS AND SURVEYS
- 2. DO NOT SCALE THIS DRAWING 3. REPORT ANY DISCREPANCIES PRIOR TO COMMENCING WORK. NO RESPONSIBILITY IS BORN BY THE CONSULTANT FOR UNKNOWN SUBSURFACE CONDITIONS
- 4. CONTRACTOR TO CHECK AND VERIFY ALL DIMENSIONS ON SITE AND REPORT ANY ERRORS AND/OR OMISSIONS TO THE CONSULTANT
- 5. REINSTATE ALL AREAS AND ITEMS DAMAGED AS A RESULT OF CONSTRUCTION ACTIVITIES TO THE SATISFACTION OF THE
- 6. CONTRACTOR TO LAYOUT PLANTING BEDS, PATHWAYS ETC. TO APPROVAL OF CONSULTANT PRIOR TO ANY JOB EXCAVATION
- 7. THE ACCURACY OF THE POSITION OF UTILITIES IS NOT GUARANTEED - CONTRACTOR TO VERIFY PRIOR TO EXCAVATION 8. INDIVIDUAL UTILITY COMPANY MUST BE CONTACTED FOR CONFIRMATION OF UTILITY EXISTENCE AND LOCATION PRIOR TO
 - 9. ALL DISTURBED AREAS TO BE RESTORED TO ORIGINAL CONDITION OR BETTER UNLESS OTHERWISE NOTED

SITE PLAN KEYNOTES:

- 1 OTTAWA HYDRO SETBACK / CLEARANCES
- 2 PROPOSED RETAINING WALL
- 3 EXISTING HYDRO TRANSFORMER ON CONCRETE PAD
- 4 PLAYGROUND AREA
- 5 SNOW STORAGE
- 6 NEW LANDSCAPE STAIR
- 7 EXISTING TREE TO REMAIN, REFER TO LANDSCAPE
- 8 BOLLARDS ALONG PROPOSED WOONERF, TYP.
- 9 EASEMENT
- 10 PARKING GARAGE SIGNAL
- 11 DEPRESSED CURB
- 12 EXISTING (NONCOMPLIANT) BIKE RACKS TO REMAIN. EXISTING RACKS NOT INCLUDED IN NEW BIKE PARKING
- 13 NEW HYDRO TRANSFORMER ON CONCRETE PAD

SITE PLAN LEGEND:

AREA NOT IN SCOPE
EXISTING BUILDING (NOT IN SCOPE)
EXTENT OF EASEMENT

- ASPHALT PAVING NEW
- **ASPHALT PAVING EXISTING** CONCRETE SIDEWALK - NEW
- CONCRETE SIDEWALK EXISTING

GRASS - NEW

- **GRASS EXISTING**
- PAVER TYPE 1 NEW CONCRETE PAD
- **EMERGENCY EXIT**
- SERVICE DOORS
- **BUILDING MAIN ENTRANCE**
- PROPERTY LINE -x-x- FENCE PER LANDSCAPE
- -wtr--wtr- NEW DOMESTIC WATER
- -san-san- NEW SANITARY
- —H——H— NEW ELECTRICAL SERVICE (BELOW GRADE)
- —н——н— GAS
- CATCH BASIN
- CATCH BASIN EXISTING
- LIGHT STANDARD
- LIGHT STANDARD EXISTING
- FIRE HYDRANT FIRE HYDRANT EXISTING
- \bigotimes_{MH} MANHOLE MANHOLE EXISTING
- UTILITY POLE UTILITY POLE EXISTING

total: 43

PROVIDED (m2)

TOTAL REQUIRED TOTAL AMENITY SPACE

AMENITY SPACE (m2)

- SIAMESE CONNECTION
- DROPPED CURB

CSV ARCHITECTS

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LANDSCAPE ARCHITECT James B. Lennox & Associates 3332 Carling Avenue Ottawa, Ontario K2H 5A8 613-722-5168

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CLIENT

BETTER LIVING CO-OPERATIVE OTTAWA

ONTARIO, CANADA

PROJECT

BLOCK 3 **REDEVELOPMENT**


1360 OGILVIE ROAD GLOUCESTER, ON K1J 9M6

OVERALL SITE PLAN

PROJECT NO: 2022-2040 DRAWN: KM APPROVED: PM As indicated DATE PRINTED: 2024-07-15 2:34:08 PM

DRAWING NO. REV

A100

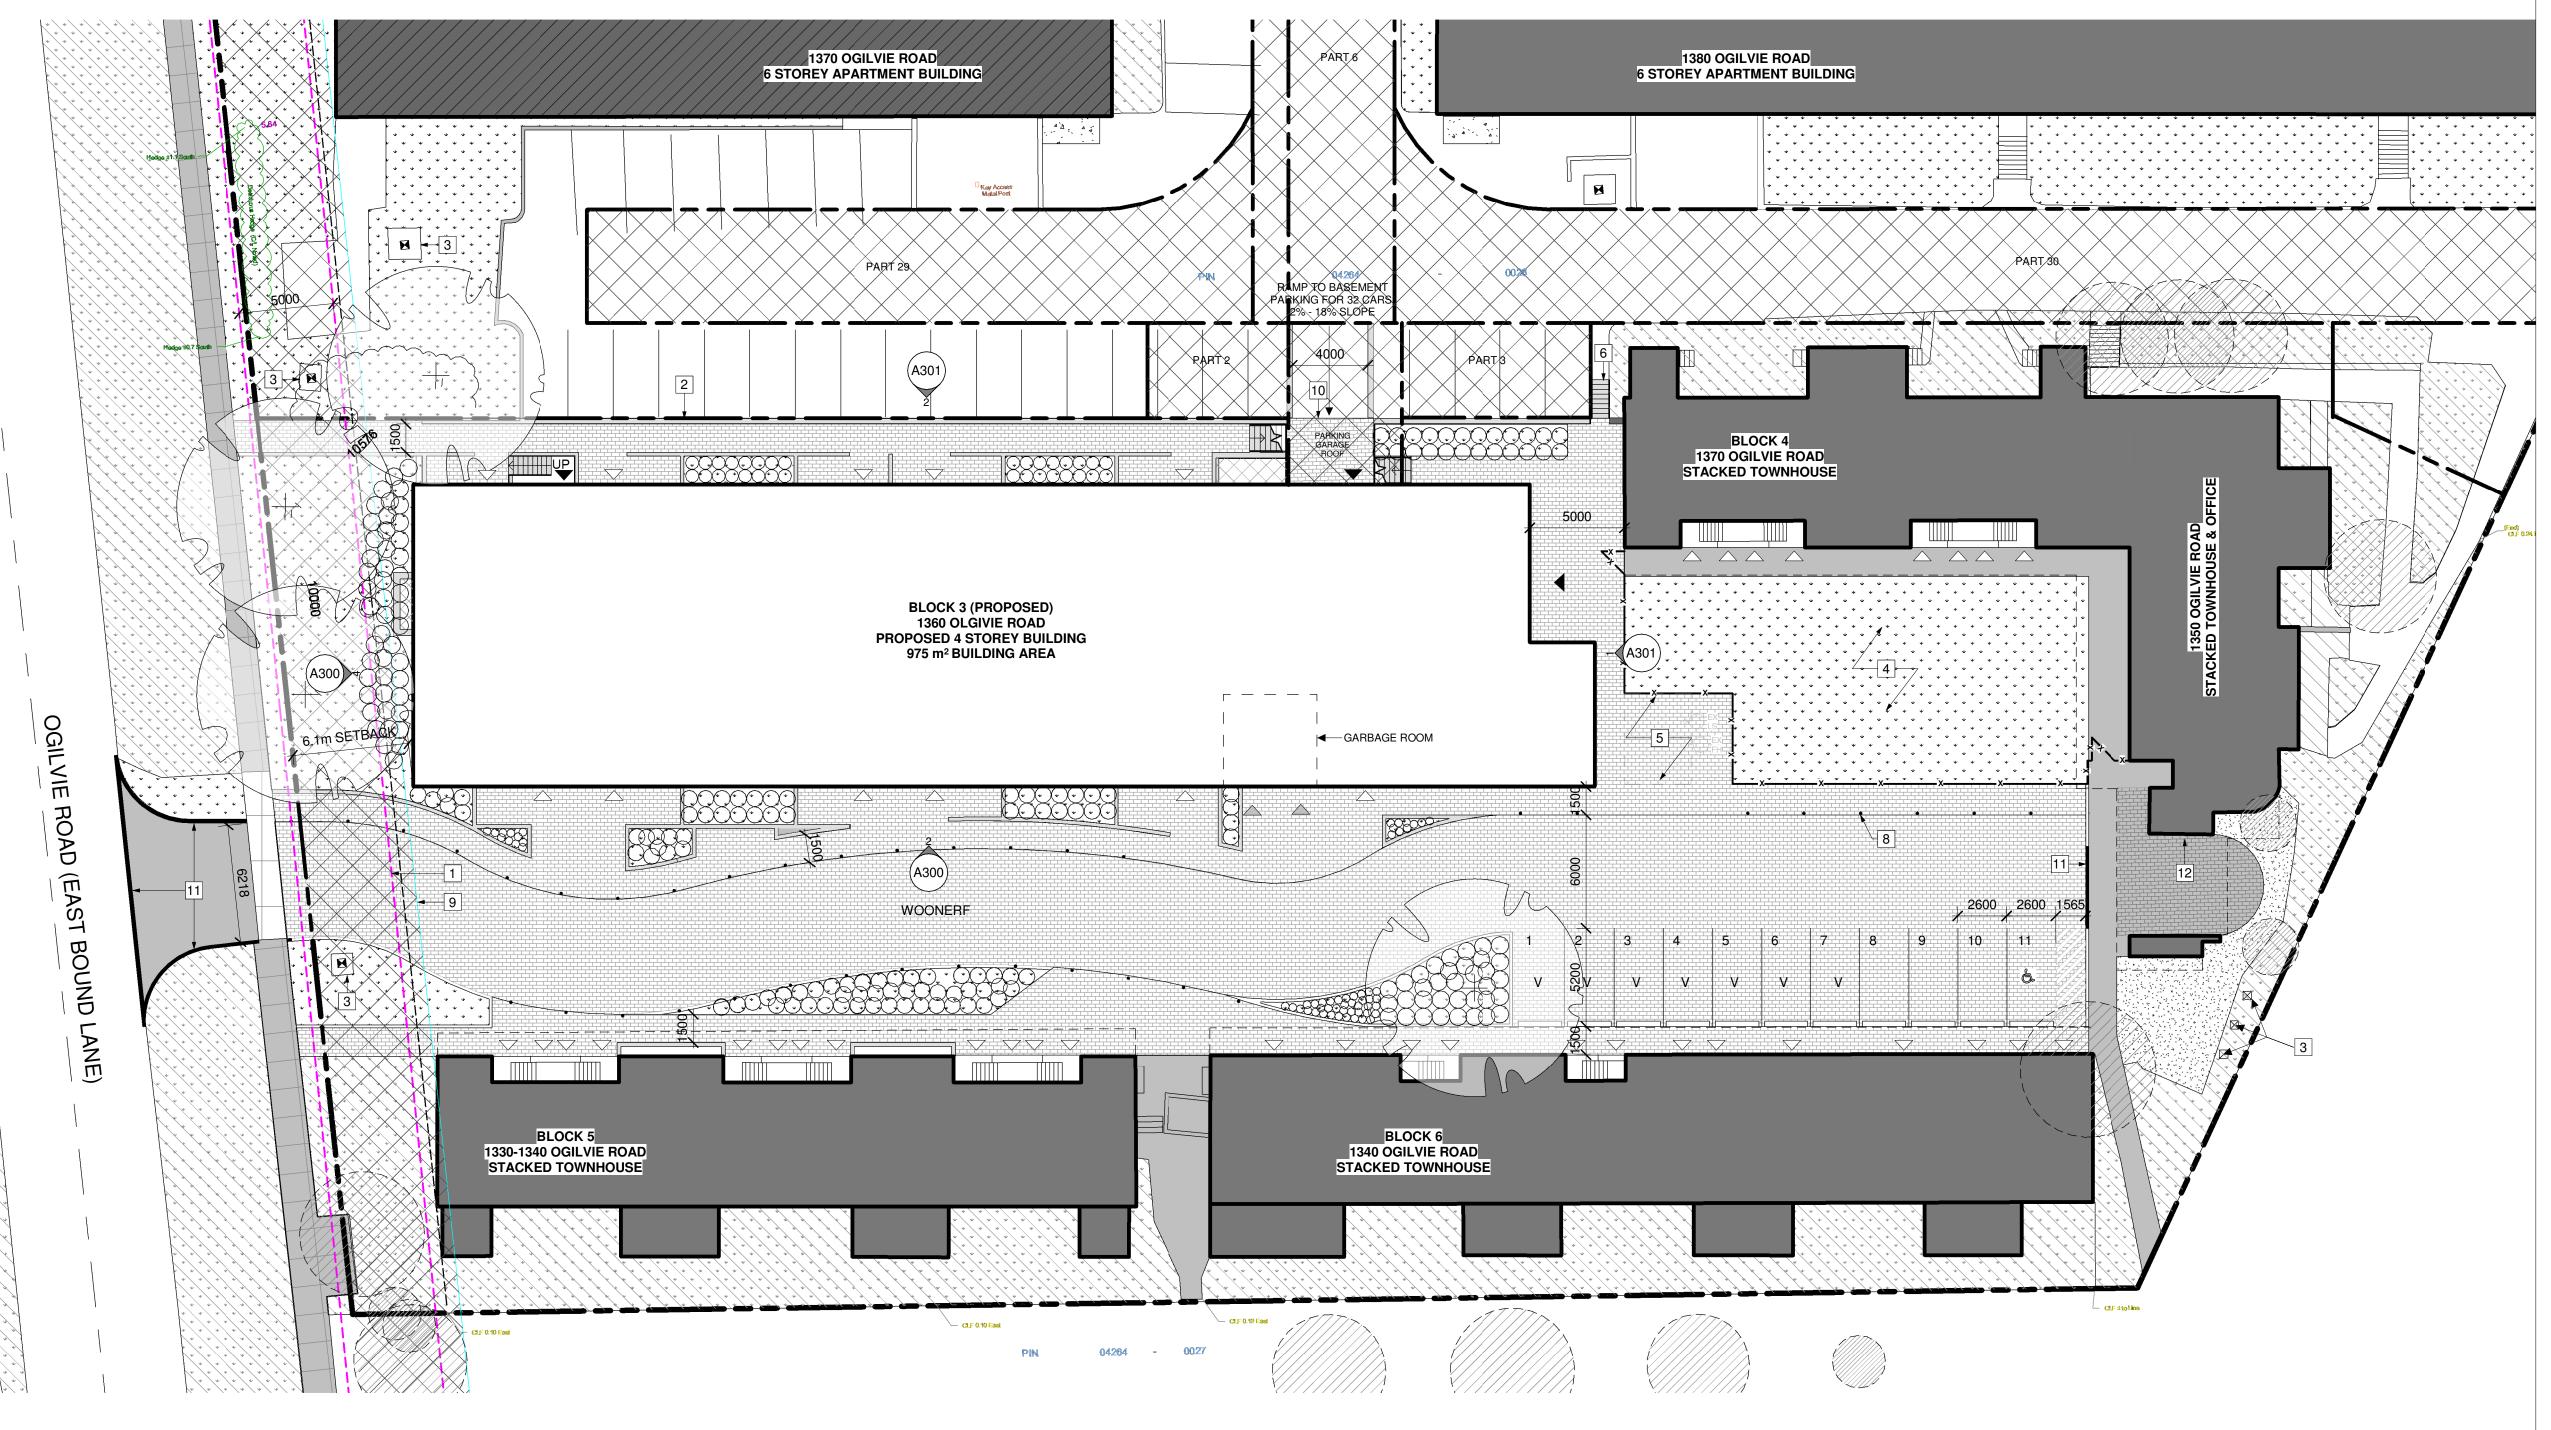

AM10 H(40)

1 PROPOSED SITE PLAN

ZONE

DEVEL OBJECT IN	uro.	7011110 11170								
DEVELOPMENT IN	<u>IFO</u>	ZONING INFO								
LEGAL DESCRIPTION		ZONING PROVISION	REQUIRED	PROVIDED	ZONING PROVISION	REQUIRED	PROVIDED	PARKING QUEING + LOADING	REQUIRED	PROVIDED
BLOCKS C, D, AND 4M-172 CITY OF OT	L REGISTERED PLAN	MIN. LOT WIDTH	No minimum	47.68m	GROUND FACADE ACTIVATION	The ground floor facade facing a public	Building is located within 6.1m of the front lot line.	RESIDENTIAL SPACES	94	43
REFERENCE SURVEY	ITAWA	MIN. LOT AREA	No minimum	5367m ²	AOTIVATION	street of a building located within 4.5 m of	No active entrances face	VISITOR SPACES	16	7
	MATION FROM A SURVEY	MIN. FRONT YARD SETBACK	Minimum: 0m	6.1m		the front lot line must include: a minimum of	ogiivio ria.	ACCESSIBLE PARKING	-	3
PREPARED BY ANN		MIN. INTERIOR SIDE YARD SETBACK	No minimum	N/A		one active entrance from each individual		BICYCLE PARKING	39	39
MUNICIPAL ADDRESS		MIN. REAR YARD SETBACK	7.5m	N/A		occupancy located immediately adjacent to the front lot line		DRIVEWAY WIDTH	3m @ single traffic lane	4m for single traffic lane, driveway to
1360 OGILVIE RD, C	OTTAWA, ON K1J 9M6	MAX. HEIGHT	40m	14.15m	A 41 N 11 M 1 M 1 M 2 M 7 M 1 M 2 M 2 M 1 M 2 M 2 M 2 M 2 M 2 M 2		7.7 0 / 70 0 10. 70 /		6m @ double traffic lane	parking garag
SITE AREA	12,912m²	AMENITY AREA	468m2	552m ²	MINIMUM GLAZING OF GROUND FLOOR FACADE	50% of the surface area of the ground floor façade facing	7.7 m2/ 72m2 = 10.7% glazing		tranic lane	6m for double traffic lane,
BUILDING AREA	975m²	LANDSCAPED AREA	no minimum	349.5m ²		Ogilvie, from the average grade up 4.5				parking lot
GROSS FLOOR AREA	3,900m²		AMENITY BREAK			metres, must be comprised of				
BUILDING HEIGHT	14.15m , 4 STOREYS		Ground Floor Ame Balconies:	227m2		transparent glazing and active customer or				
70115	4440 11/40)		Playground:	242m2		resident entrance				

access doors

DWELLING UNIT TYPE		BLC	OCK		TOTAL				
DWELLING UNIT TYPE	3(NEW)	4	5	6	TOTAL				
1-BEDROOM	26			1	27				
2-BEDROOM	4	7	6	6	23				
3-BEDROOM	9	7	6	4	26	26 1 NOTES:			
4-BEDROOM				1	1				
5-BEDROOM				1	1	4 DADIVINO FIGURE			
1-B(SENIOR)					0	1. PARKING FIGURE SITE ONLY	ES IN TABLE REFLECT BLC		
2-B(SENIOR)					0	TOTAL SITE PARKING (INCLUDING BLC S			
TOTAL	39	14	12	13	78				
	•								
			P	ARKING LEG	END				
DWELLING UNIT TYPE		BLC	OCK		TOTAL	TOTAL REQUIRED	TOTAL PARKING		
DWELLING UNIT TYPE	3(NEW)	4	5	6	TOTAL	PARKING	PROVIDED		
APARTMENT (1.2)	39				39	47			
STACKED (1.2)	0 14 12 13		39	47	36				
VISITOR PARKING (0.2)						16	7		
•					109	total: 43			
AMENITY LEGEND									
_	BLOCK			TOTAL	TOTAL REQUIRED	TOTAL AMENITY SPACE			
	3(NEW)	4	5	6	TOTAL	AMENITY SPACE (m2)	PROVIDED (m2)		
DWELLING UNITS	39	14	12	13	78	468	552		

ACCOMODATIONS LEGEND

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4 PLAYGROUND AREA

5 SNOW STORAGE 6 NEW LANDSCAPE STAIR

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8 BOLLARDS ALONG PROPOSED WOONERF, TYP.

9 EASEMENT

10 PARKING GARAGE SIGNAL

11 DEPRESSED CURB

12 EXISTING (NONCOMPLIANT) BIKE RACKS TO REMAIN. EXISTING RACKS NOT INCLUDED IN NEW BIKE PARKING

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SITE PLAN LEGEND:

AREA NOT IN SCOPE
EXISTING BUILDING (NOT IN SCOPE)
EXTENT OF EASEMENT
ASPHALT PAVING - NEW
ASPHALT PAVING - EXISTING
CONCRETE SIDEWALK - NEW
CONCRETE SIDEWALK - EXIST

GRASS - NEW GRASS - EXISTING

PAVER TYPE 1 - NEW CONCRETE PAD

EMERGENCY EXIT

SERVICE DOORS

△ BUILDING MAIN ENTRANCE

PROPERTY LINE

-x-x- FENCE PER LANDSCAPE

-wtr-wtr- NEW DOMESTIC WATER -san-san- NEW SANITARY

—st——st— NEW STORM

—H——H— NEW ELECTRICAL SERVICE (BELOW GRADE)

—н—— н— GAS

CB CATCH BASIN

CATCH BASIN EXISTING ∘ LIGHT STANDARD

• LIGHT STANDARD EXISTING

- FIRE HYDRANT

FIRE HYDRANT EXISTING

 \bigotimes_{MH} MANHOLE MANHOLE EXISTING

UTILITY POLE UTILITY POLE EXISTING

SIAMESE CONNECTION

— DROPPED CURB

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613-722-5168 CIVIL ENGINEER

email **CIVIL ENGINEERS** McIntosh Perry 115 Walgreen Road Carp, Ontario

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CLIENT

BETTER LIVING CO-OPERATIVE OTTAWA

ONTARIO, CANADA

PROJECT

BLOCK 3 **REDEVELOPMENT**

1360 OGILVIE ROAD GLOUCESTER, ON K1J 9M6


PROPOSED SITE PLAN

PROJECT NO: 2022-2040

DRAWN: KM APPROVED: PM 1:200 DATE PRINTED: 2024-07-15 2:34:10 PM

REV DRAWING NO.

A110

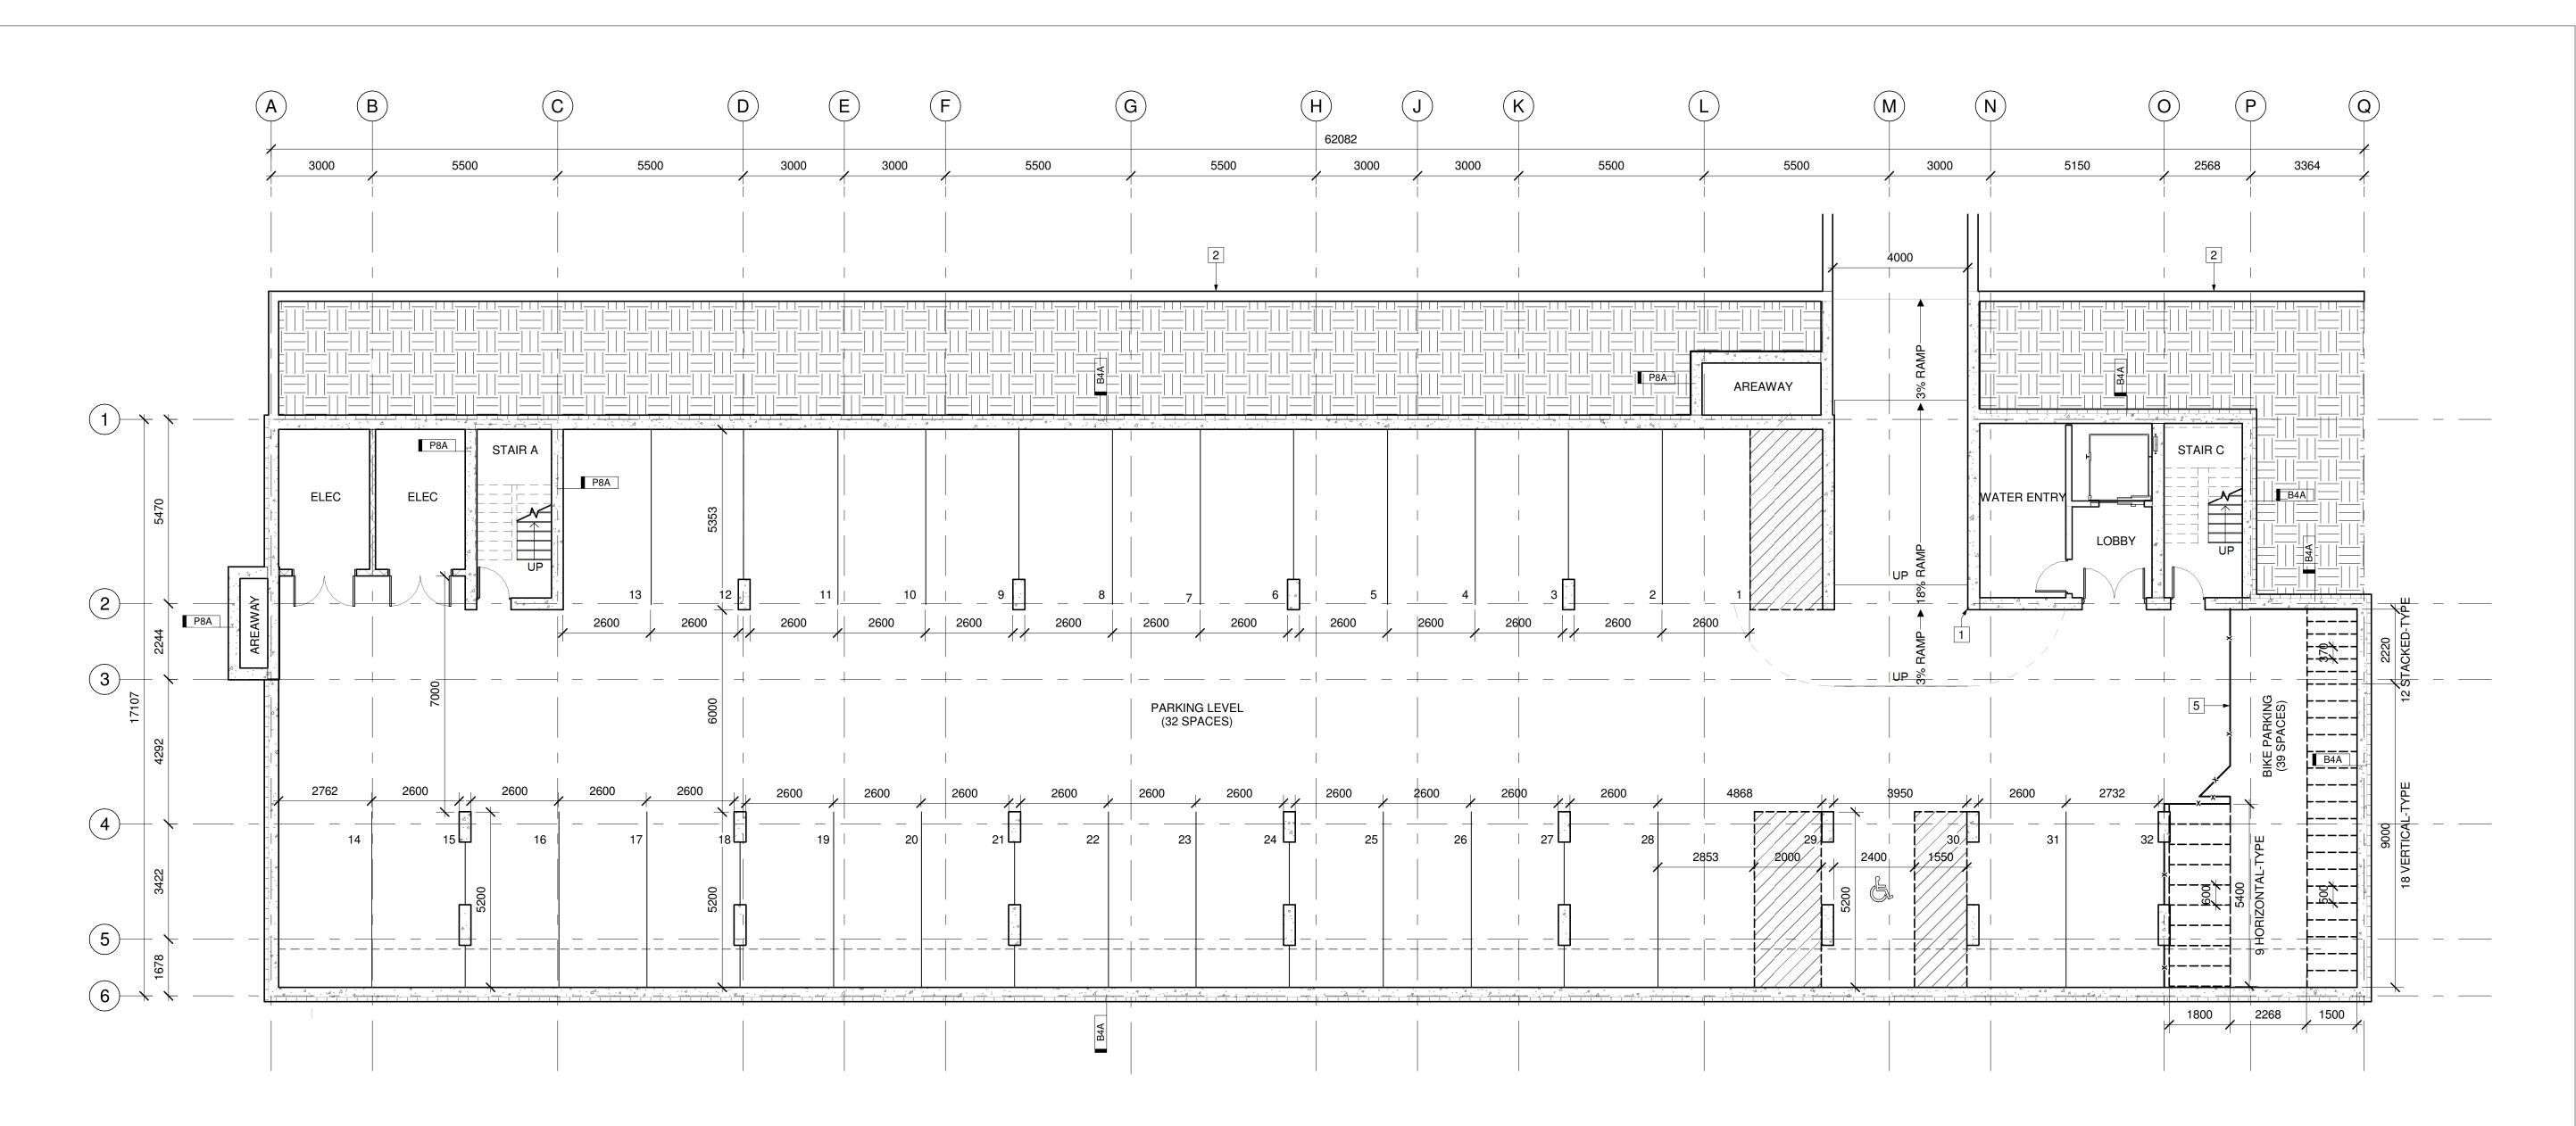

1 UNDERGROUND PARKING LEVEL

GENERAL REFERENCE PLAN NOTES:

- 1. ALL DIMENSIONS ARE TO FACE OF FRAMING UNLESS OTHERWISE NOTED.
- 2. ALL DOOR DIMENSIONS ARE TO THE CENTRE OR INSIDE OF FRAME.

- 3 NOT IN USE
- SECURE FENCE TO FLOOR SLAB AND TO U/S SLAB ABOVE

LEGEND:

3. ALL WINDOW DIMENSIONS ARE TO THE CENTER OR OUTSIDE OF FRAME.


UNDERGROUND PARKING PLAN KEYNOTES:

- 4 PIPE SLEEVE

- 1 PARKING GARAGE SIGNAL
- 2 RETAINING WALL PER STRUCTURAL DOCUMENTS

- 5 SECURE BIKE STORAGE. CHAINLINK FENCE W/ ACCESS DOOR.

NEW CONSTRUCTION

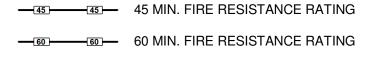

90 MIN. FIRE RESISTANCE RATING SHEAR WALL PER STRUCTURAL

LOAD-BEARING WALL PER STRUCTURAL

NOT IN CONTRACT

DOOR

DOOR OPERATOR

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STRUCTURAL ENGINEER Cunliffe & Associates 200, 1550 Carling Avenue Ottawa, Ontario K1Z 8S8 613-729-7242 cunliffe@cunliffe.ca

MECHANICAL AND ELECTRICAL **ENGINEER** Chorley + Bisset Consulting Engineers 250 City Centre Avenue Ottawa, Ontario K1R 6K7 613-241-0030 email@chorley.com

LANDSCAPE ARCHITECT James B. Lennox & Associates 3332 Carling Avenue Ottawa, Ontario K2H 5A8 613-722-5168

CIVIL ENGINEER address address phone

email

CIVIL ENGINEERS McIntosh Perry 115 Walgreen Road Carp, Ontario 613-836-2184 info@mcintoshperry.com

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CLIENT

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PROJECT


BLOCK 3 REDEVELOPMENT

1360 OGILVIE ROAD GLOUCESTER, ON K1J 9M6

UNDERGROUND PARKING PLAN

PROJECT NO: 2022-2040 DRAWN: DF APPROVED: PM

1:100 DATE PRINTED: 2024-07-15 2:34:13 PM REV DRAWING NO.

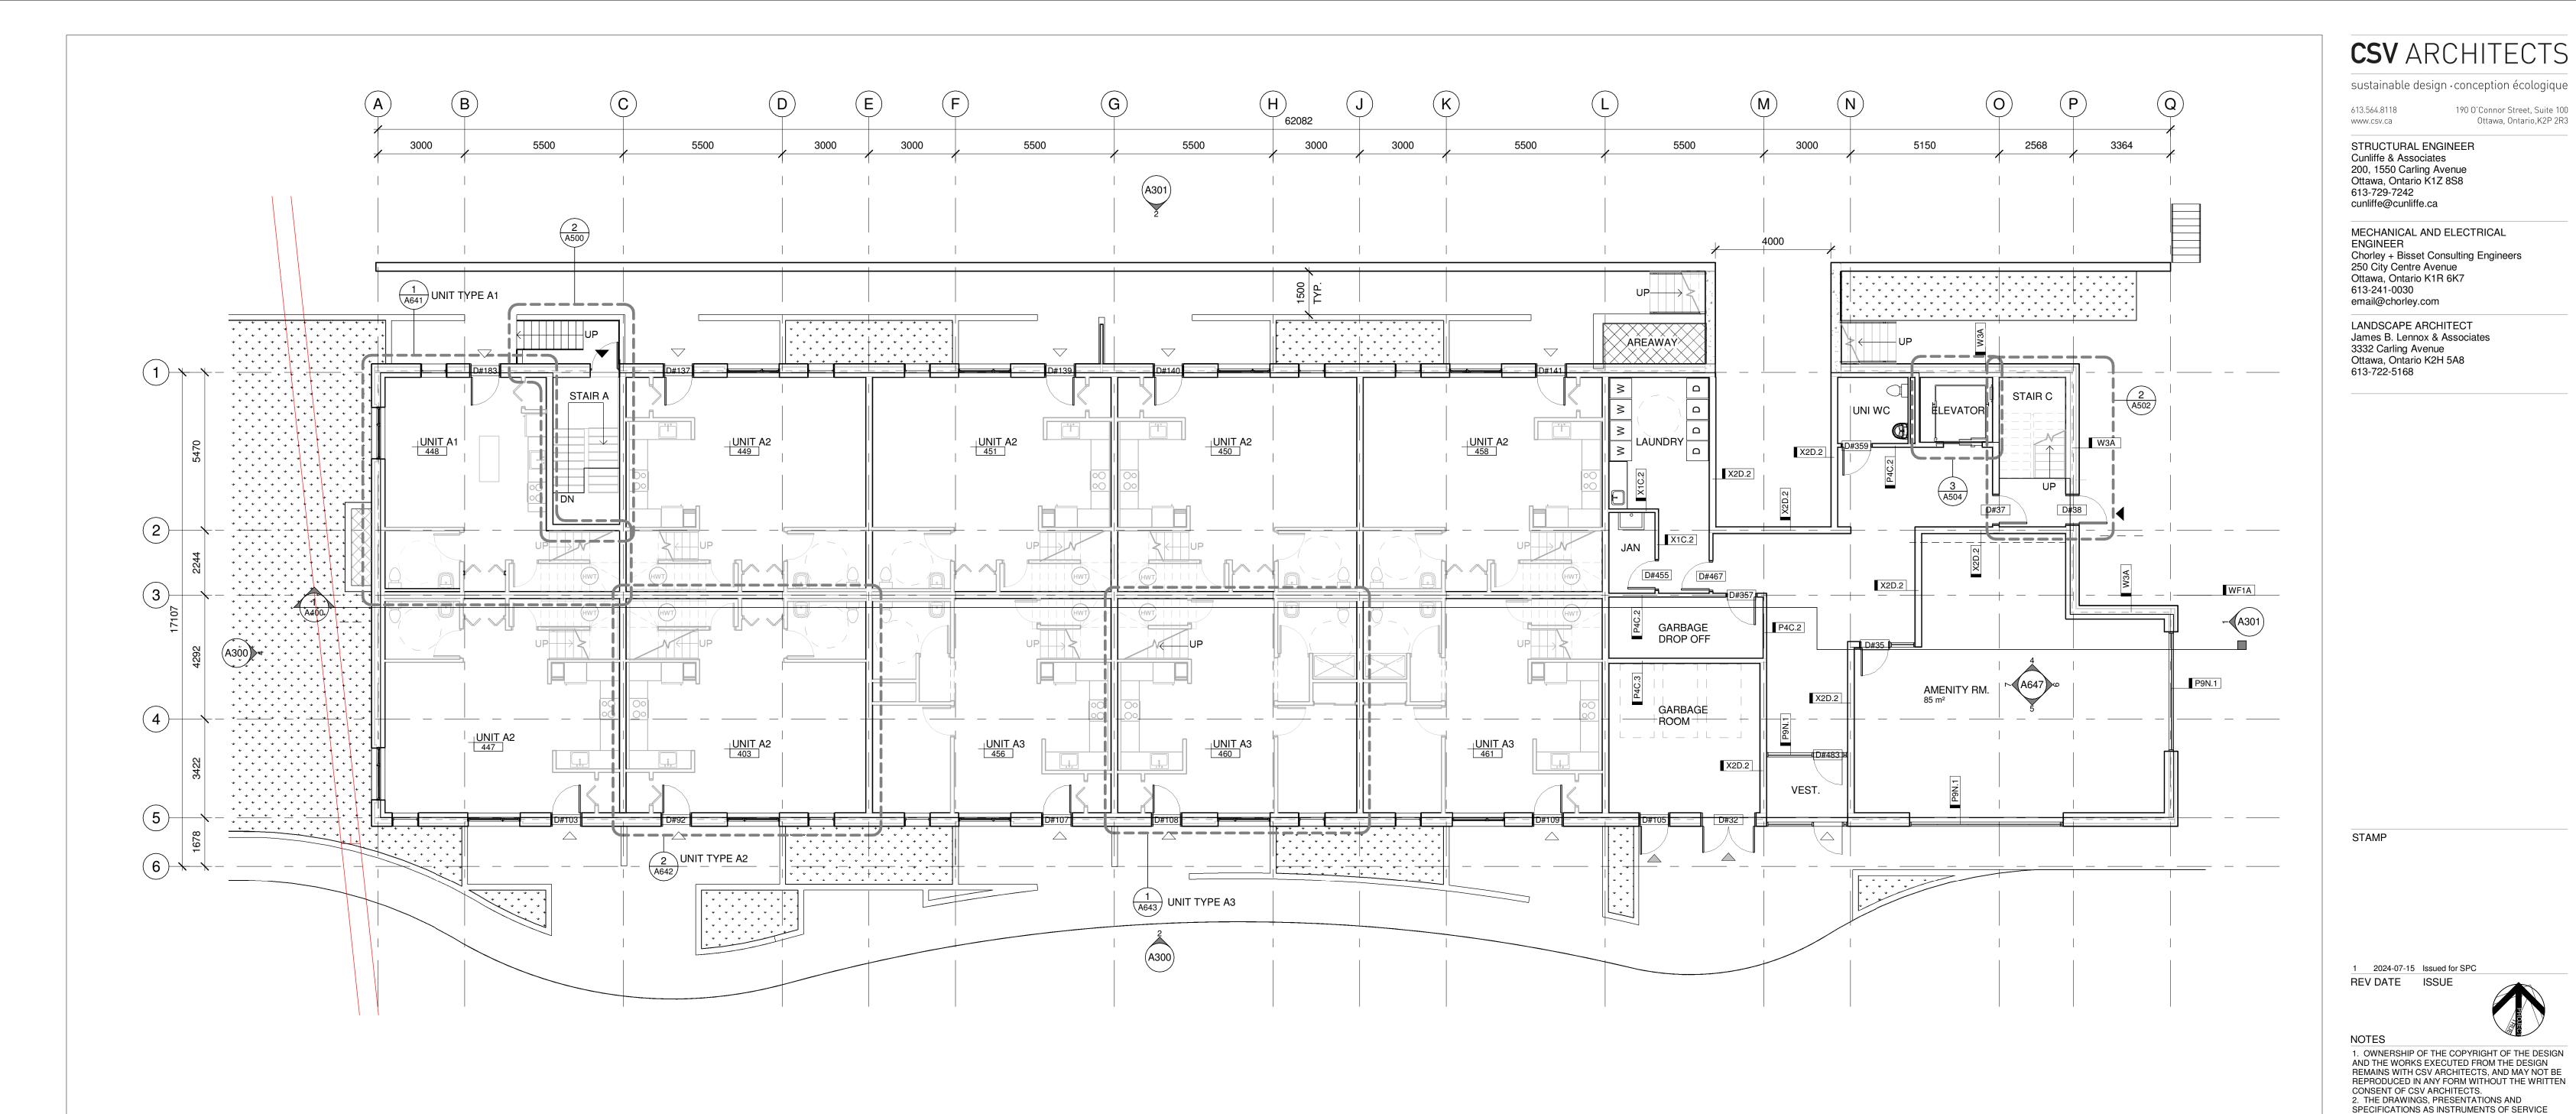

1 GROUND FLOOR KEY PLAN


GENERAL REFERENCE PLAN NOTES:

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REFERENCE PLAN KEYNOTES:

- 1 MAILBOXES
- 2 GARBAGE BINS
- 3 CANOPY ABOVE
- 4 FIRE DEPARTMENT CONNECTION
- 5 FIRE ALARM CONTROL PANEL

NOT IN CONTRACT NEW CONSTRUCTION 45 MIN. FIRE RESISTANCE RATING 60 MIN. FIRE RESISTANCE RATING 90 MIN. FIRE RESISTANCE RATING SHEAR WALL PER STRUCTURAL LOAD-BEARING WALL PER STRUCTURAL

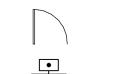

LEGEND:

DOOR OPERATOR

GROUND FLOOR PLAN PROJECT NO: 2022-2040

APPROVED: PM 1:100 DATE PRINTED: 2024-07-15 2:34:16 PM DRAWING NO.

KM, DF

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CONSENT OF CSV ARCHITECTS.

BETTER LIVING

CO-OPERATIVE

REDEVELOPMENT

GLOUCESTER, ON K1J 9M6

ONTARIO, CANADA

1360 OGILVIE ROAD

SPECIFICATIONS.

CLIENT

OTTAWA


PROJECT

DRAWN:

BLOCK 3

190 O'Connor Street, Suite 100

Ottawa, Ontario,K2P 2R3

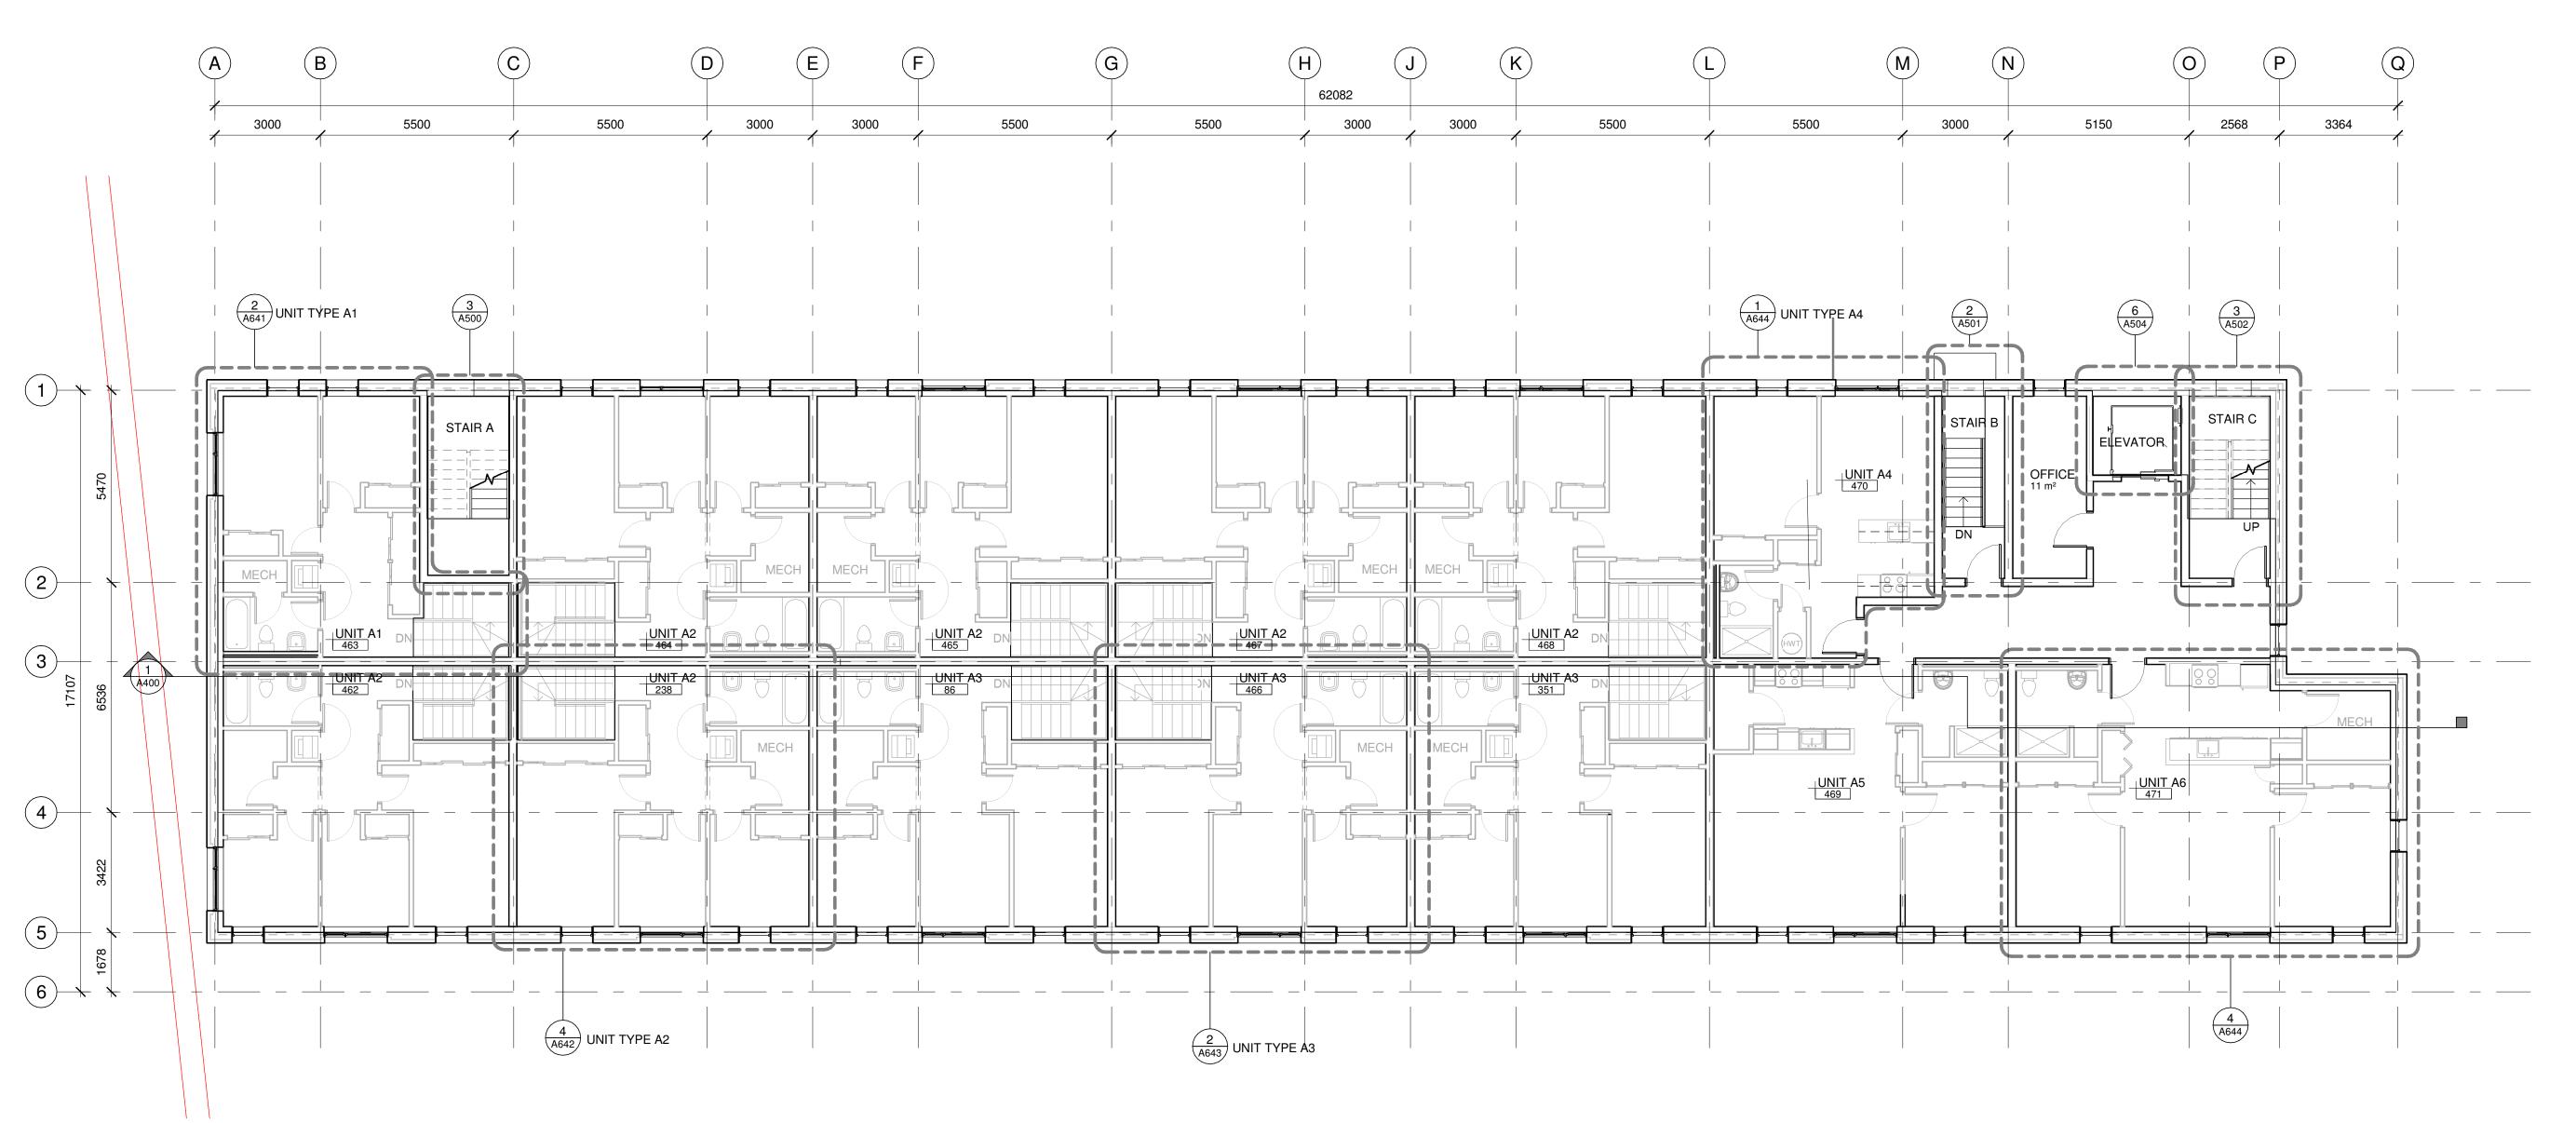

1 SECOND FLOOR KEY PLAN
A203 1:100

GENERAL REFERENCE PLAN NOTES:

- 1. ALL DIMENSIONS ARE TO FACE OF FRAMING UNLESS OTHERWISE NOTED.
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REFERENCE PLAN KEYNOTES:

- 1 MAILBOXES
- 2 GARBAGE BINS
- 3 CANOPY ABOVE
- 4 FIRE DEPARTMENT CONNECTION
- 5 FIRE ALARM CONTROL PANEL

LEGEND:

NOT IN CONTRACT

NEW CONSTRUCTION 45 MIN. FIRE RESISTANCE RATING 60 MIN. FIRE RESISTANCE RATING

90 MIN. FIRE RESISTANCE RATING SHEAR WALL PER STRUCTURAL

LOAD-BEARING WALL PER STRUCTURAL

DOOR

DOOR OPERATOR

DRAWN: KM, DF APPROVED: PM 1:100 DATE PRINTED: 2024-07-15 2:34:19 PM

DRAWING NO.

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STRUCTURAL ENGINEER

Cunliffe & Associates 200, 1550 Carling Avenue Ottawa, Ontario K1Z 8S8

MECHANICAL AND ELECTRICAL

Chorley + Bisset Consulting Engineers 250 City Centre Avenue Ottawa, Ontario K1R 6K7

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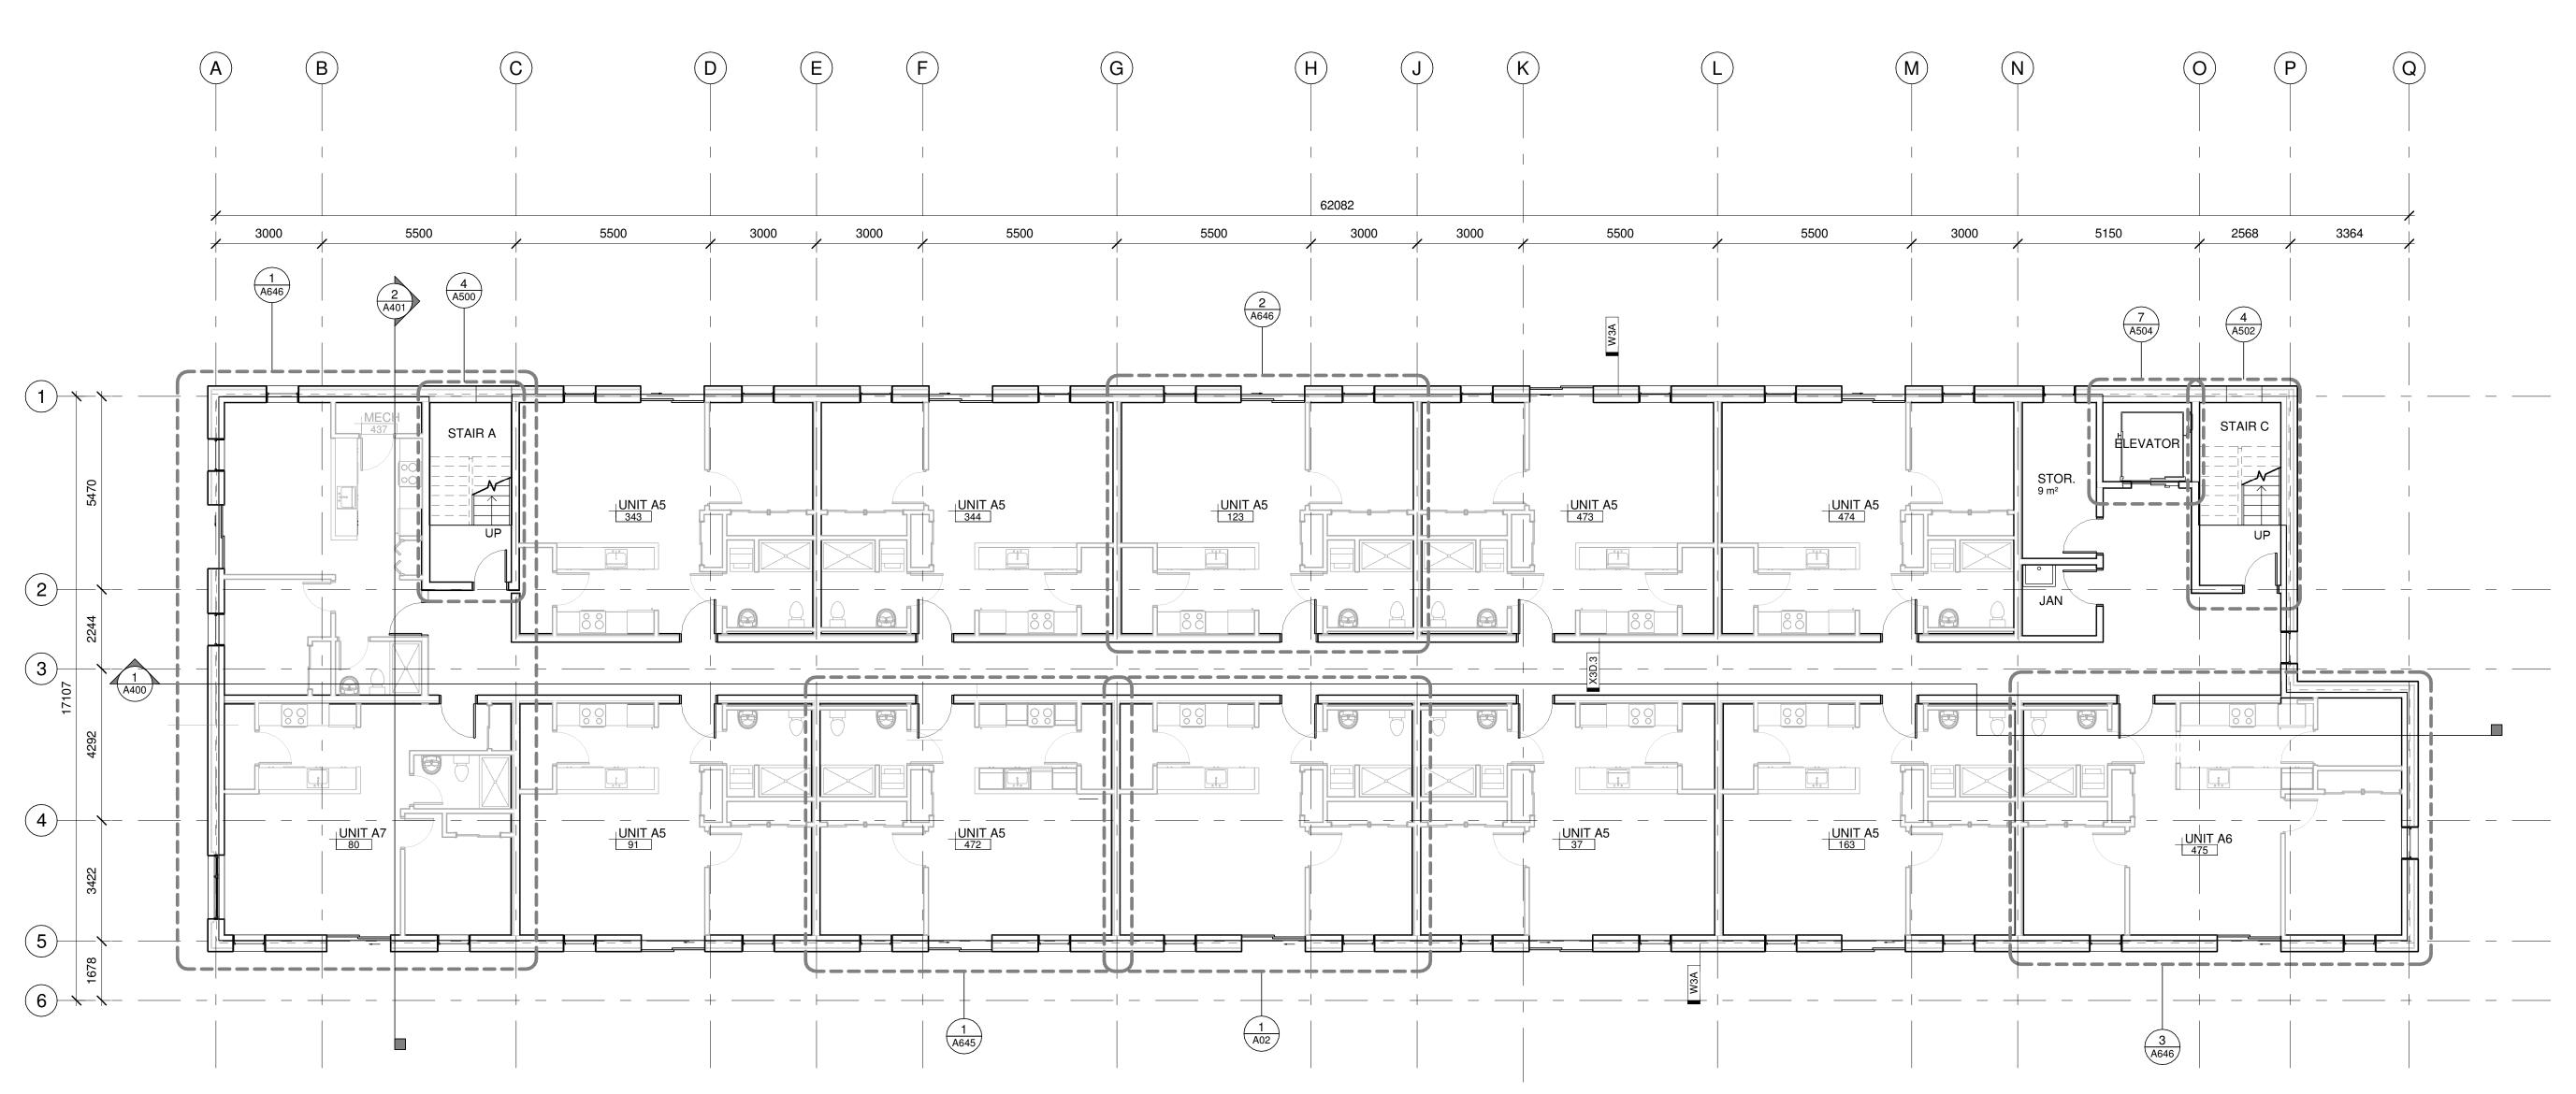
PROJECT

BLOCK 3 REDEVELOPMENT

1360 OGILVIE ROAD GLOUCESTER, ON K1J 9M6

SECOND FLOOR PLAN

PROJECT NO: 2022-2040



1 THIRD FLOOR KEY PLAN

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REFERENCE PLAN KEYNOTES:

- 1 MAILBOXES
- 2 GARBAGE BINS
- 3 CANOPY ABOVE
- 4 FIRE DEPARTMENT CONNECTION
- 5 FIRE ALARM CONTROL PANEL

LEGEND:

NOT IN CONTRACT

NEW CONSTRUCTION 45 MIN. FIRE RESISTANCE RATING

60 MIN. FIRE RESISTANCE RATING 90 MIN. FIRE RESISTANCE RATING

SHEAR WALL PER STRUCTURAL LOAD-BEARING WALL PER STRUCTURAL

DOOR OPERATOR

PROJECT NO: 2022-2040 DRAWN: KM, DF APPROVED: PM 1:100 DATE PRINTED: 2024-07-15 2:34:22 PM

REV

DRAWING NO.

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4 2024-07-15 Issued for SPC 3 2024-06-21 Issued for Coordination

2 2023-12-01 Issued for 33%

1 2023-09-13 Issued for Structural Coordination REV DATE ISSUE

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SPECIFICATIONS AS INSTRUMENTS OF SERVICE

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CLIENT

BETTER LIVING CO-OPERATIVE OTTAWA


ONTARIO, CANADA

PROJECT

BLOCK 3 REDEVELOPMENT

1360 OGILVIE ROAD GLOUCESTER, ON K1J 9M6

THIRD AND FOURTH FLOOR PLAN (TYP.)

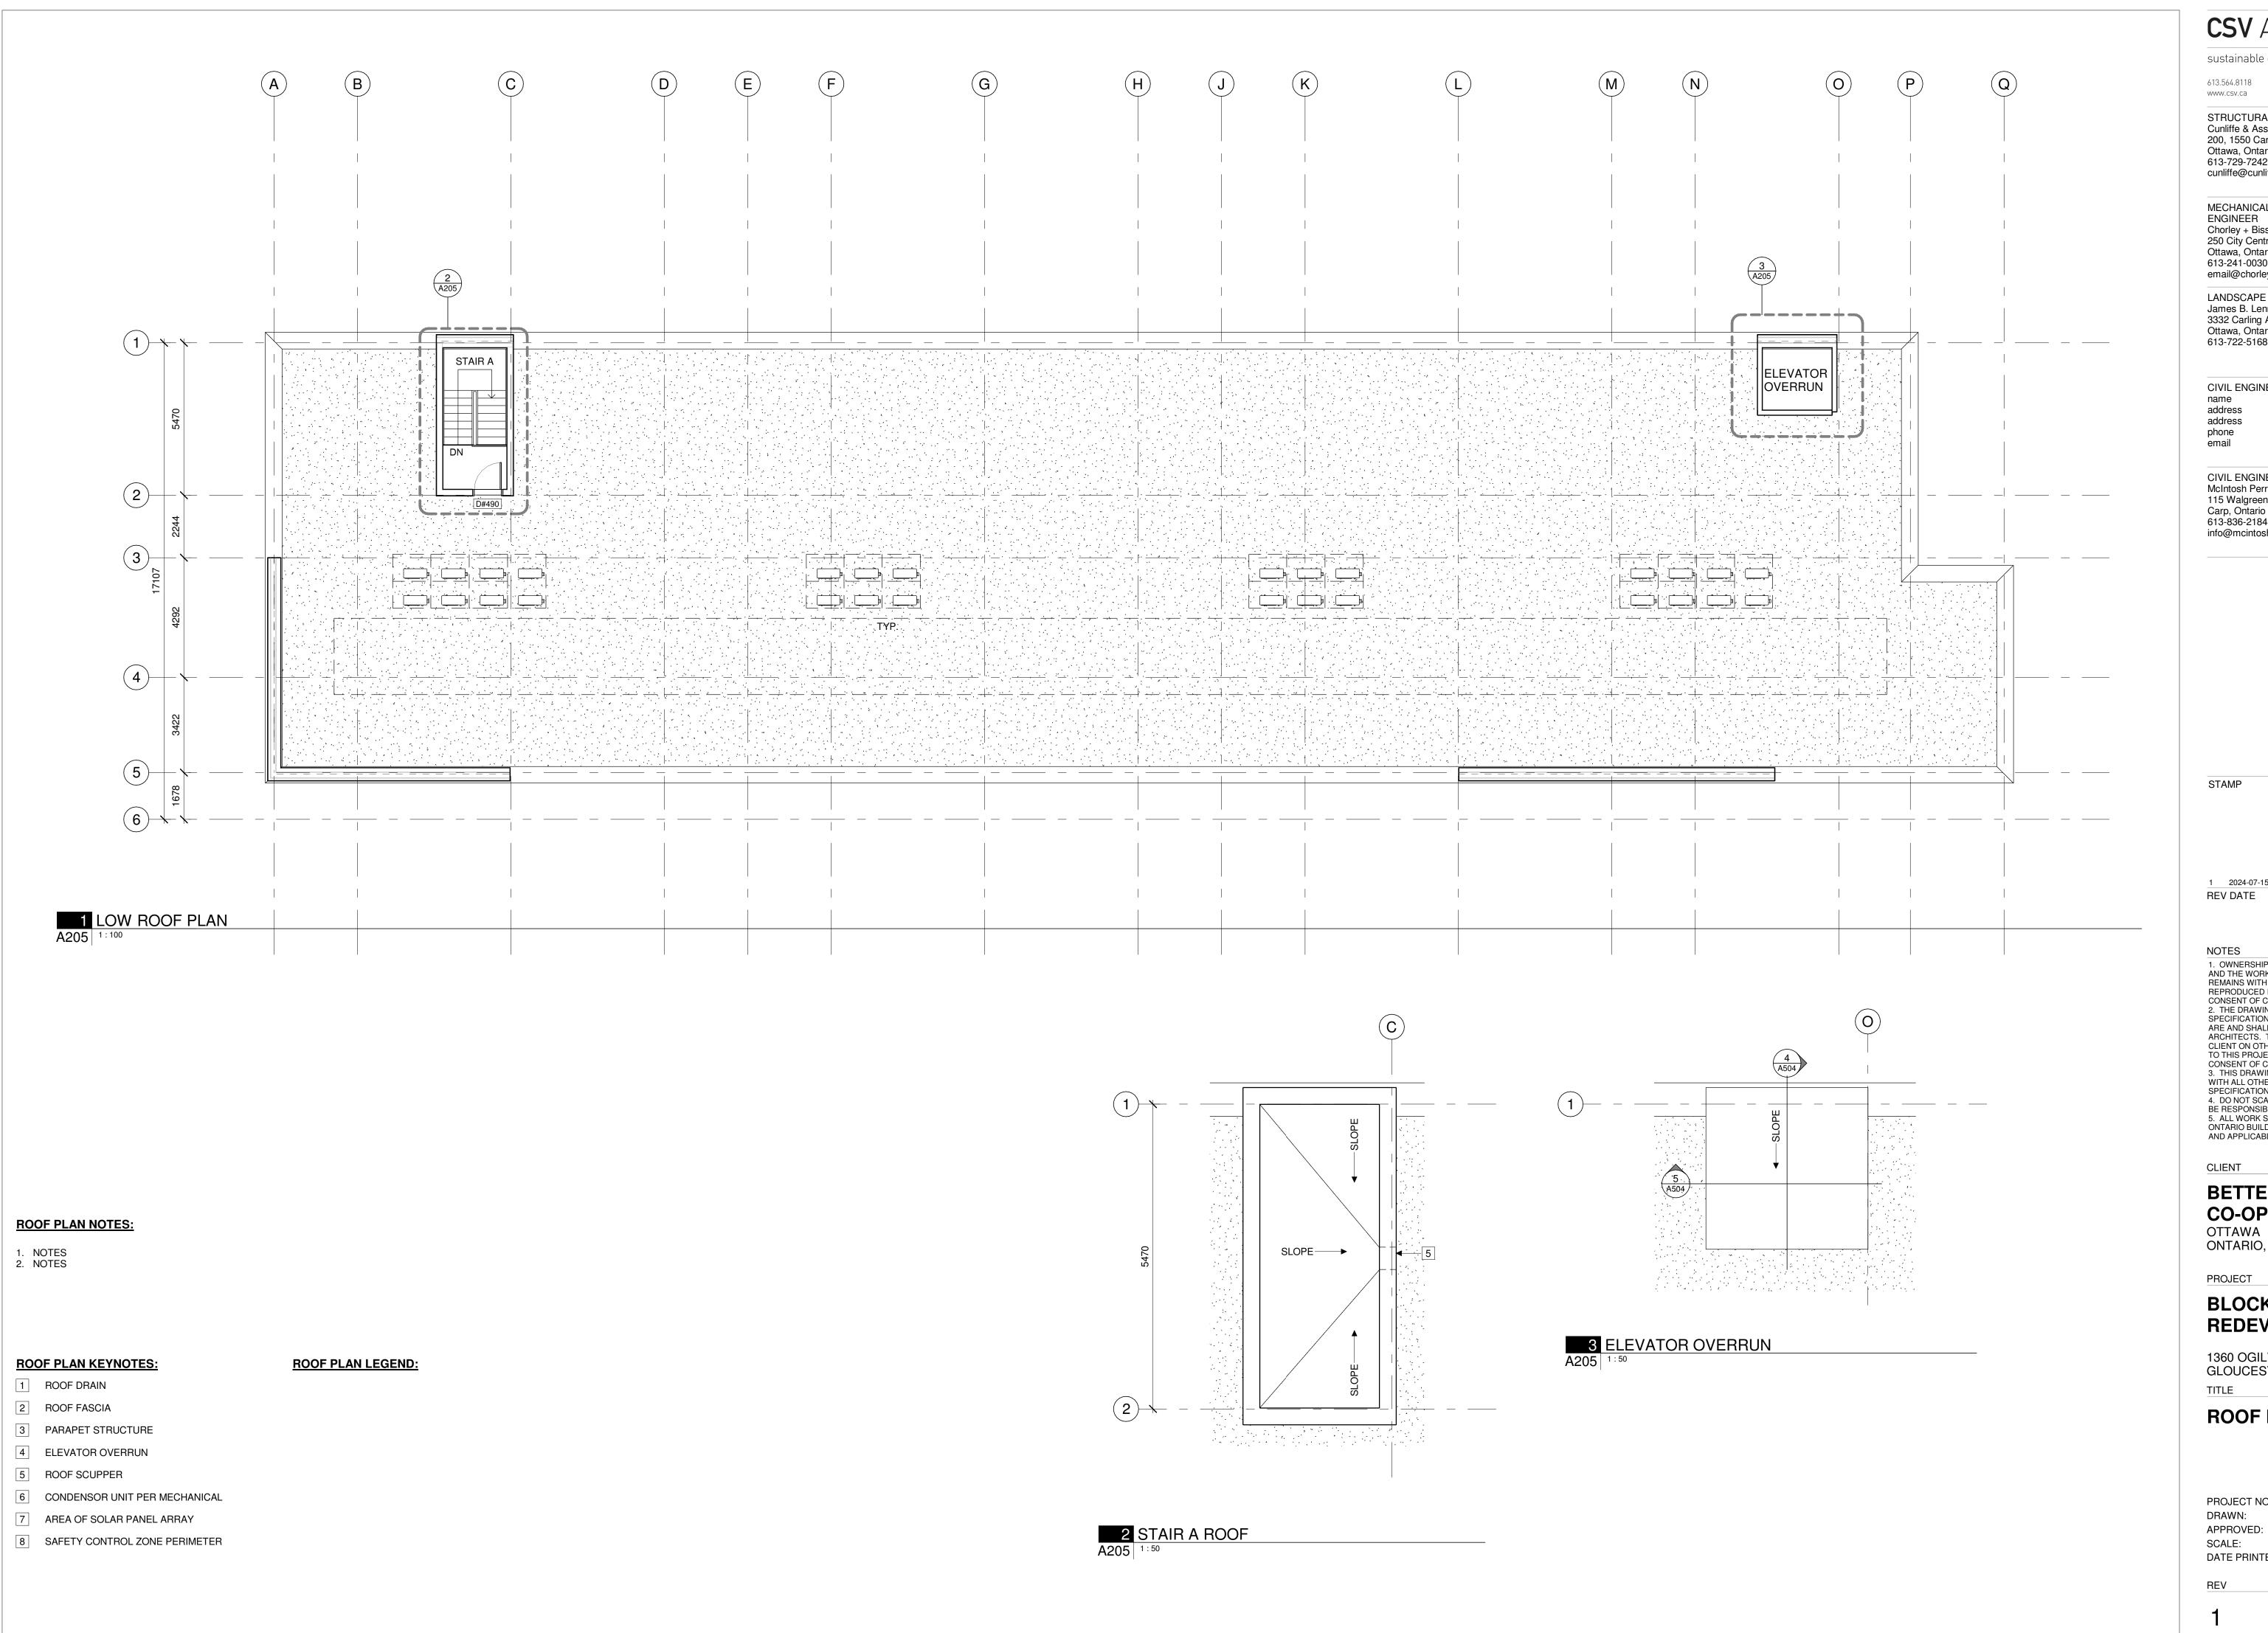

CSV ARCHITECTS

sustainable design · conception écologique

Ottawa, Ontario,K2P 2R3

190 O'Connor Street, Suite 100

STRUCTURAL ENGINEER Cunliffe & Associates 200, 1550 Carling Avenue Ottawa, Ontario K1Z 8S8 613-729-7242 cunliffe@cunliffe.ca

MECHANICAL AND ELECTRICAL ENGINEER Chorley + Bisset Consulting Engineers 250 City Centre Avenue Ottawa, Ontario K1R 6K7 613-241-0030 email@chorley.com

LANDSCAPE ARCHITECT James B. Lennox & Associates 3332 Carling Avenue Ottawa, Ontario K2H 5A8 613-722-5168

CIVIL ENGINEER name address address phone

CIVIL ENGINEERS McIntosh Perry 115 Walgreen Road Carp, Ontario 613-836-2184 info@mcintoshperry.com

1 2024-07-15 Issued for SPC REV DATE ISSUE

NOTES

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BETTER LIVING CO-OPERATIVE

ONTARIO, CANADA

BLOCK 3 **REDEVELOPMENT**

1360 OGILVIE ROAD GLOUCESTER, ON K1J 9M6

ROOF PLAN

PROJECT NO: 2022-2040 DRAWN: DF, JW APPROVED: PM


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2 WEST ELEVATION



ELEVATION NOTES:

CONTRACTOR TO COORDINATE WITH MANUFACTURER'S SPECIFICATIONS AND INSTALLATIONS GUIDELINES FOR ALL MATERIAL SEALING, TRANSITIONS, SEPARATIONS, FLASHING DETAILS, CONNECTIONS, ANCHORAGES, ETC. CONTRACTOR TO PROVIDE DETAIL DRAWINGS OR MOCK-UP FOR ARCHITECT'S REVIEW AND APPROVAL FOR ALL SPECIAL CONDITIONS NOT SHOWN IN THE CONTRACT DOCUMENTS.

ELEVATION KEYNOTES:

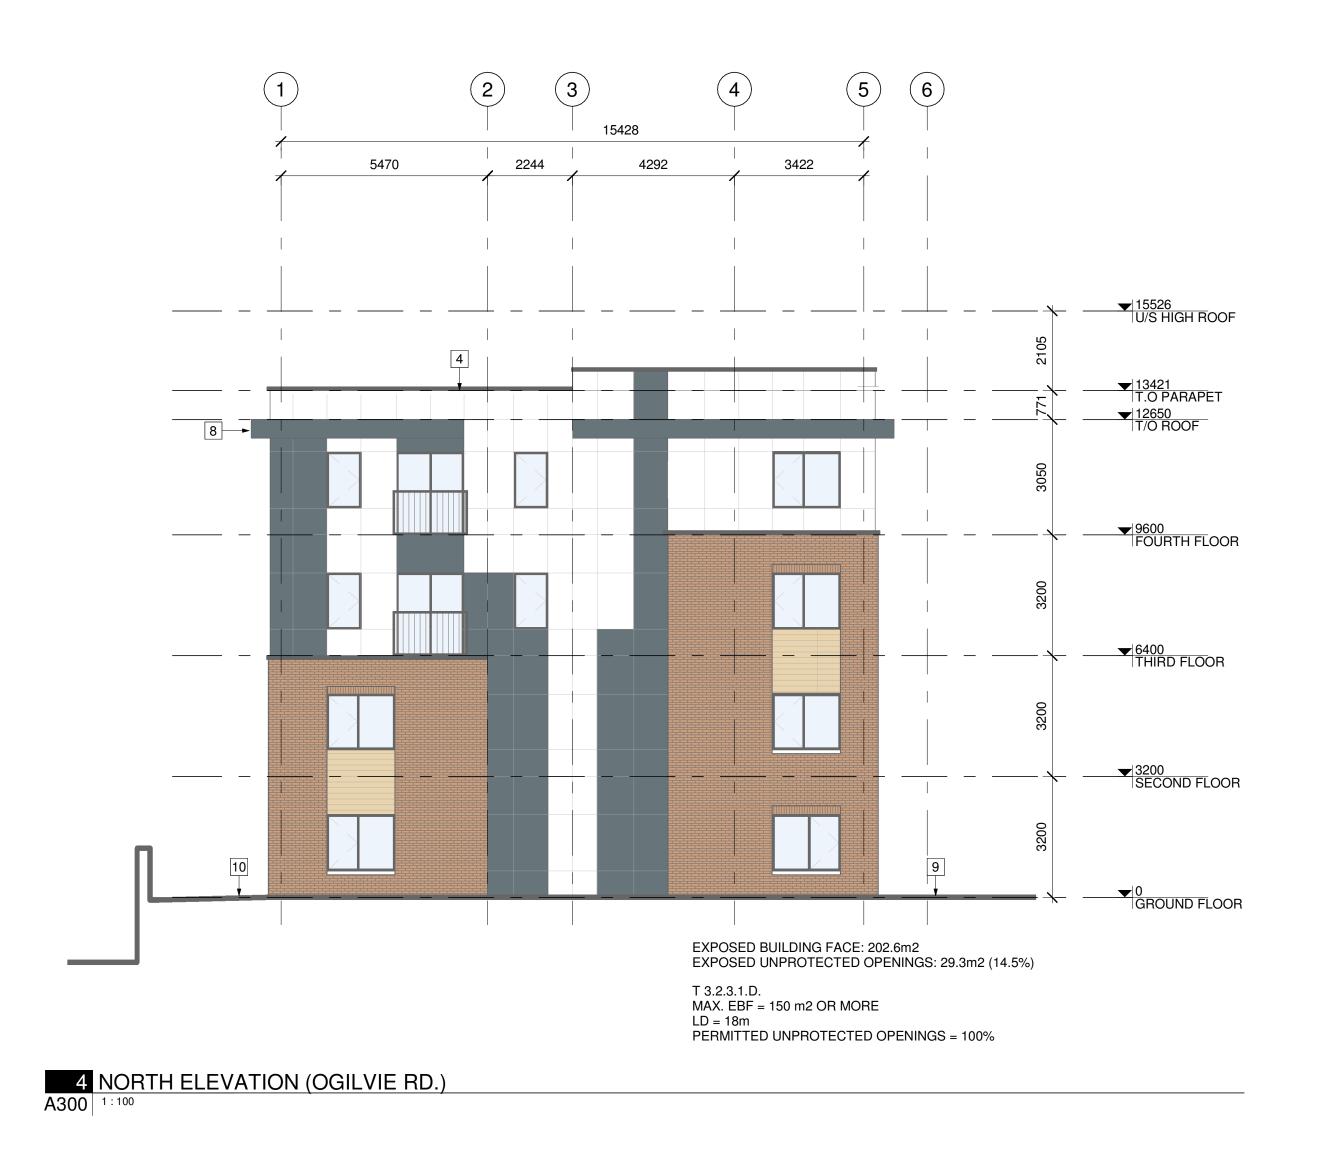- 1 CURTAIN WALL
- 2 CANOPY
- 3 JULIETTE BALCONY
- 4 PREFINISHED METAL FLASHING
- 5 CONCRETE UPSTAND
- 6 ELEVATOR OVERRUN & ROOFTOP ACCESS
- 7 GARAGE DOOR
- 8 ROOF FASCIA
- 9 FINISHED GRADE
- 10 CEMENT PAVEMENT

ELEVATION LEGEND:

HATCH PATTERNS SHOWN ARE FOR GRAPHIC PURPOSES ONLY AND SHOULD BE COORDINATED WITH ACTUAL SPECIFIED MATERIALS.

H	ATCH	SYMBOL	DESCRIPTION
			BRICK VENEER MANUFACTURER: COLOUR:
			ALUMINUM COMPOSITE PANEL MANUFACTURER: COLOUR:
			ALUMINUM COMPOSITE PANEL MANUFACTURER: COLOUR:
			WOOD SIDING MANUFACTURER: COLOUR:
			FASCIA MANUFACTURER: COLOUR:

cunliffe@cunliffe.ca MECHANICAL AND ELECTRICAL

CSV ARCHITECTS

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190 O'Connor Street, Suite 100 Ottawa, Ontario,K2P 2R3

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email@chorley.com

STRUCTURAL ENGINEER

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LANDSCAPE ARCHITECT James B. Lennox & Associates 3332 Carling Avenue Ottawa, Ontario K2H 5A8 613-722-5168

CIVIL ENGINEER address address phone email

613.564.8118

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CIVIL ENGINEERS McIntosh Perry 115 Walgreen Road Carp, Ontario 613-836-2184 info@mcintoshperry.com

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CLIENT

BETTER LIVING CO-OPERATIVE

OTTAWA ONTARIO, CANADA

PROJECT

BLOCK 3 REDEVELOPMENT

1360 OGILVIE ROAD GLOUCESTER, ON K1J 9M6

EXTERIOR ELEVATIONS

PROJECT NO: 2022-2040 DRAWN: DF APPROVED: PM As indicated

REV


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2 EAST ELEVATION



ELEVATION NOTES:

CONTRACTOR TO COORDINATE WITH MANUFACTURER'S SPECIFICATIONS AND INSTALLATIONS GUIDELINES FOR ALL MATERIAL SEALING, TRANSITIONS, SEPARATIONS, FLASHING DETAILS, CONNECTIONS, ANCHORAGES, ETC. CONTRACTOR TO PROVIDE DETAIL DRAWINGS OR MOCK-UP FOR ARCHITECT'S REVIEW AND APPROVAL FOR ALL SPECIAL CONDITIONS NOT SHOWN IN THE CONTRACT DOCUMENTS.

ELEVATION KEYNOTES:
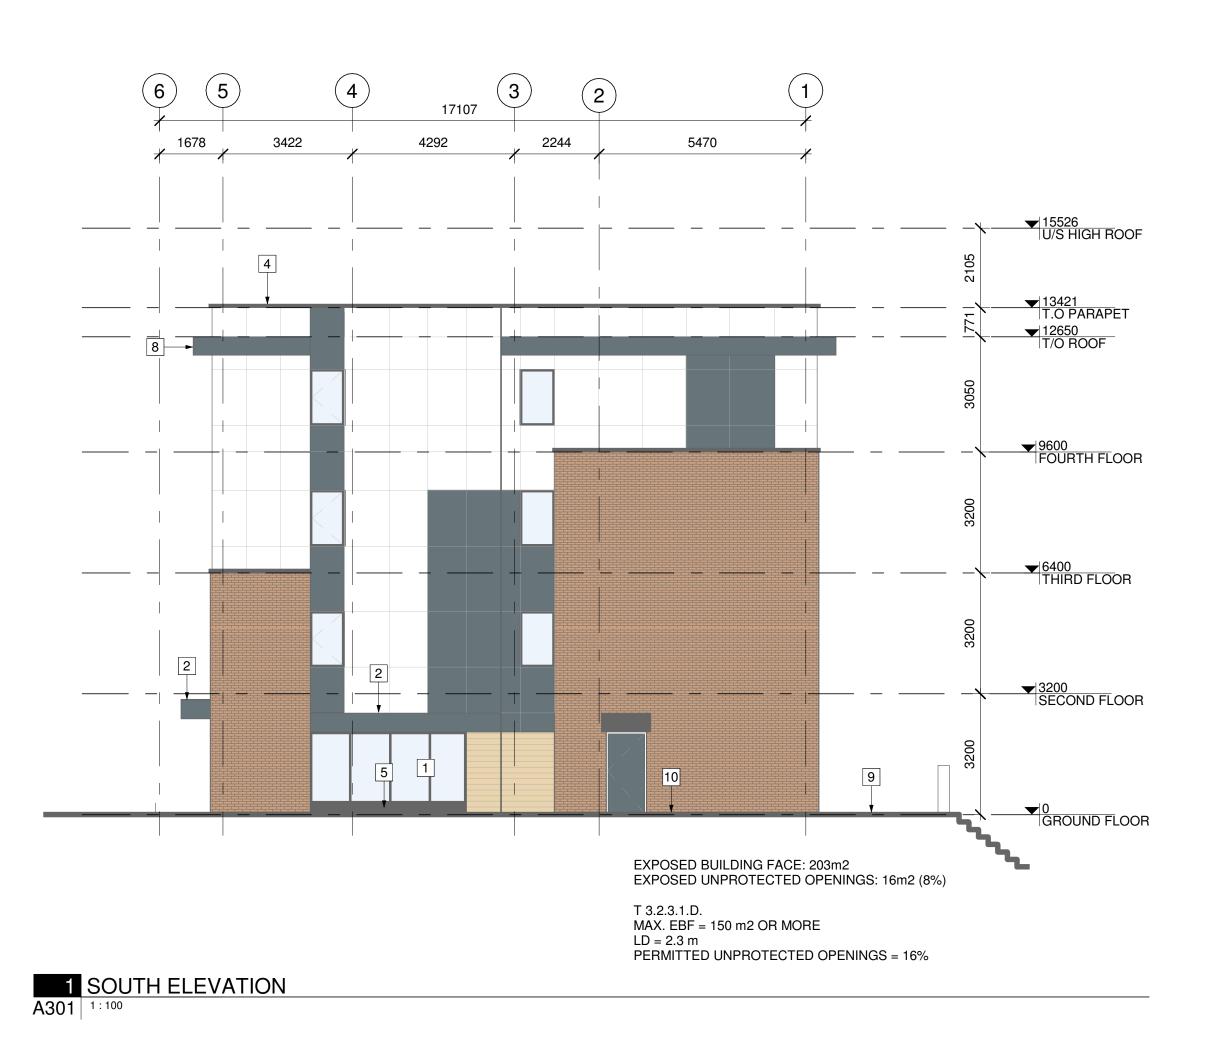
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- 8 ROOF FASCIA
- 9 FINISHED GRADE
- 10 CEMENT PAVEMENT

ELEVATION LEGEND:

HATCH SYMBOL DESCRIPTION

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	•	22001
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		ALUMINUM COMPOSITE PANEL MANUFACTURER: COLOUR:
		WOOD SIDING MANUFACTURER: COLOUR:
		FASCIA MANUFACTURER: COLOUR:

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CIVIL ENGINEER name address address phone email

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OTTAWA ONTARIO, CANADA

PROJECT

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EXTERIOR ELEVATIONS

PROJECT NO: 2022-2040
DRAWN: DF
APPROVED: PM
SCALE: As indicated

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DRAWING NO.

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